WAKELY ASSOCIATES, INC. ARCHITECTS 30500 Van Dyke Avenue Suite M7 Warren, Michigan 48093 ADDENDUM NO. ONE FARMINGTON PUBLIC SCHOOLS-NFHS 2018 RENOVATIONS Page 1 of 4 (write up only)

January 3, 2017

ADDENDUM NO. ONE to the plans and specifications for the FARMINGTON PUBLIC SCHOOLS, 2018 RENOVATIONS ELEMENTARY SCHOOLS, Farmington, MI, Architect's Project No. 171712A, dated November 21<sup>st</sup>, 2017.

The above plans and specifications are modified, supplemented or augmented as follows, and this ADDENDUM NO. ONE, is hereby made a part of the contract documents.

<u>Specification Sections 01100, 08710, Door Hardware Index Drawings and Drawings C2.0, C3.1,C3.2, S2.0, S4.0, G4.2, AS1.0BV, A1.1BV, A1.1KB, A 1.2KB A2.1BV, A2.2BV, A3.0BV, A5.1 BV, A5.1KB, A5.4K, A7.2BV, A7.2KB, A8.2BV, A8.2KB, M2.1BV, M6.2BV, E2.1BV, E2.2BV, E3.1BV and E5.1BV are being issued with this Addendum.</u>

# **CIVIL DRAWING ITEMS**

**ITEM NO. C1**: Refer to Drawing No. C2.0 (Re-issued):

a. Removed waking path alternate.

ITEM NO. C2: Refer to Drawing No. C3.1 (Re-issued):

a. Revised sidewalk layout.

**ITEM NO. C3**: Refer to Drawing No. C3.2 (Re-issued):

a. Revised playpad scope.

# STRUCTURAL DRAWING ITEMS

**ITEM NO. S1**: Refer to Drawing No. S2.0 (Re-issued):

Updated details.

**ITEM NO. S2**: Refer to Drawing No. S4.0 (Re-issued):

a. Updated details.

# **ARCHITECTURAL SPECIFICATION ITEMS:**

ITEM NO. AS1: Refer to SPECIFICATION SETION 01100 Finish Hardware

(Issued):

a. Removed alternate No. E1BV. This scope will now be base

bid.

**ITEM NO. AS2**: Refer to SPECIFICATION SETION 08710 Finish Hardware (Issued):

- a. Refer to Finish Hardware section with Door Hardware Index and Hardware Sets.
- b. NOTE: Contractor to provide ALL cores and Keying of all cores to the owners master system.

**ITEM NO. AS3**: Refer to SPECIFICATION SETION Door Hardware Index (Issued):

a. Refer to Door Hardware Index and Hardware Sets with Finish Hardware section.

# **ARCHITECTURAL DRAWING ITEMS:**

**ITEM NO. A1**: Refer to Drawing No. G4.2 (Re-issued):

a. Revised demolition note #1.b. Revised new work note #29.c. Revised new work note #46.

**ITEM NO. A2**: Refer to Drawing No. AS1.0BV (Re-issued):

Added note 15 at existing dumpster surround...

**ITEM NO. A3**: Refer to Drawing No. A1.1BV (Re-issued):

a. Revised screen wall around chiller and generator.

b. Generator is now base bid.

**ITEM NO. A4**: Refer to Drawing No. A1.1KB (Re-issued):

Revised interior elevation tags in rooms A127, A129, A133,
 A137. Contractor to verify dimension prior to fabrication.

**ITEM NO. A5**: Refer to Drawing No. A1.2KB (Re-issued):

Revised enlarged plan tag to read 1/A5.3KB.

b. Revise section tag at drinking fountain to read 7/A1.2KB.

c. Added section tags 12/5.3KB.

**ITEM NO. A6**: Refer to Drawing No. A2.2BV (Re-issued):

a. Revised new ceiling grid.

**ITEM NO. A7**: Refer to Drawing No. A3.0BV (Re-issued):

a. Added metal composite panel details, 3/A3.0BV and 4/A3.0BV.

b. Added metal composite panel notes.

**ITEM NO. A8**: Refer to Drawing No. A2.1BV (Issued):

a. See added sheet A2.1BV.

**ITEM NO. A9**: Refer to Drawing No. A5.1BV (Re-issued):

a. Updated side elevation @ new entry 4/A5.1BV

b. Updated column detail 12/A5.1BV

**ITEM NO. A10**: Refer to Drawing No. A5.1KB (Re-issued):

a. Added entry elevation 10/A5.1KB.

**ITEM NO. A11**: Refer to Drawing No. A5.4KB (Re-issued):

a. Revised details.

**ITEM NO. A12**: Refer to Drawing No. A7.2BV (Re-issued):

a. Added finish note 13 to schedule, Classrooms to receive area

rugs as indicated.

**ITEM NO. A13**: Refer to Drawing No. A7.2KB (Re-issued):

a. Added finish note 11 to schedule, Classrooms to receive area

rugs as indicated.

**ITEM NO. A14**: Refer to Drawing No. A8.2BV (Re-issued):

a. Refer to updated signage schedule.

**ITEM NO. A15**: Refer to Drawing No. A8.2KB (Re-issued):

a. Refer to updated signage schedule.

# **MECHANICAL DRAWING ITEMS:**

**ITEM NO. M1:** Refer to drawing No. M2.1BV (re-issued):

a. Revise generator scope to be base bid.

**ITEM NO. M2:** Refer to drawing No. M6.2BV (re-issued):

a. Revise natural gas piping diagram as indicated.

# **ELECTRICAL DRAWING ITEMS:**

**ITEM NO. E1:** Refer to drawing No. E2.1BV (re-issued):

a. Generator scope shall now be base bid.

b. Revised construction notes 7, 8, and 9.

**ITEM NO. E2:** Refer to drawing No. E2.2BV (re-issued):

a. Generator scope shall now be base bid.

b. Revised construction notes 7, 8, and 9.

**ITEM NO. E3:** Refer to drawing No. E3.1BV (re-issued):

a. Generator scope shall now be base bid.

b. Revised construction notes 14-20.

**ITEM NO. E4:** Refer to drawing No. E3.2BV (re-issued):

a. Generator scope shall now be base bid.

b. Revised construction notes 14-20.

c. Revised circuit for fire alarm control panel as indicated.

# **ITEM NO. E5:** Refer to drawing No. E5.1BV (re-issued):

- a. Generator scope shall now be base bid.
- b. Revised construction notes 1, 2, and 4 as indicated.
- c. Revised circuit breaker size to be 200A, 3P as indicated.

# **END OF ADDENDUM NO. 1**

Cc: Aaron Phillips, McCarthy &Smith

January 3, 2017

SECTION 01100 - ALTERNATES

PART 1 - GENERAL

#### 1.01 RELATED DOCUMENTS:

A. Attention is directed to Division 0, Bidding and Contract Requirements, and to Division 1, General Requirements, which are hereby made a part of this Section.

#### 1.02 DESCRIPTION OF WORK:

- A. This section identifies each Alternate by number, and describes the basic changes to be incorporated into the work, only when the Alternate is made a part of the work by specific provisions in the Owner-Contractor Agreement.
- B. Alternate schedule below is part of the Bidding Documents and will be considered in selection of Contractors and awarding contracts.
- C. Unless otherwise provided, Owner will accept or reject alternates within one hundred twenty (120) days of date of contract. Owner reserves the right to reject any or all alternates.

#### 1.03 ALTERNATES:

#### A. General:

- 1. The descriptions for each alternate listed in the schedule are primarily scope definitions, and do not necessarily detail the full range of materials and processes needed to complete the work as required.
- Refer to applicable specification sections (Division 2 through 16), and to applicable drawings, for specific requirements of the work, regardless of whether references are so noted in description of each alternative.
- 3. Coordinate pertinent related work and modify surrounding work as required to properly integrate the work under each Alternate, and to provide the complete construction required by Contract Documents.
- 4. Referenced sections of specifications stipulate pertinent requirements for products and methods to achieve the work stipulated under each Alternate.

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#### B. Schedule:

- 1. Alternate No. B1: Provide cost to remove and replace existing plastic laminate casework with new plastic laminate casework in Music B149 at Beechview Elementary as indicated on the drawings.
- 2. Alternate No. R1: Provide cost to provide new single ply roof system at Beechview Elementary on areas indicated on the drawing A3.0BV.
- 3. Alternate No. C1: Provide cost to perform the paving replacement at Kenbrook Elementary in the south parking lot and drive as indicated on the Civil drawings.
- 4. Alternate No. E1BV: NOT USED
- **5. Alternate No. E2BV:** Provide new sound systems in Gymnasium and Cafeteria for Beechview Elementary as indicated on the drawings.
- **6. Alternate No. E1KB:** Provide new sound systems in Gymnasium and Cafeteria for Kenbrook Elementary as indicated on the drawings.

END OF SECTION 01100

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SECTION 08710 - FINISH HARDWARE

#### PART 1 - GENERAL

1.1 Refer to "General and Special Conditions", and "Instructions to Bidders", Division 1 of Specifications. Requirements of these Sections and the project drawings shall govern work in this section.

#### 1.2 Work Included:

A. Furnish all items of Finish Hardware specified, scheduled, shown or required herein except those items specifically excluded from this section of the specification.

#### B. Related work:

- 1. Division 00 00 00 Procurement and Contracting Requirements
- 2. Division 01 00 00 General Requirements
- 3. Division 06 00 00 Wood, Plastics, and Composites
- 4. Division 08 00 00 Openings
- 5. Division 10 00 00 Specialties
- 6. Division 11 00 00 Equipment
- 7. Division 26 00 00 Electrical
- 8. Division 27 00 00 Communications
- 9. Division 28 00 00 Electronic Safety and Security
- C. Specific Omissions: Hardware for the following is specified or indicated elsewhere, unless specifically listed in the hardware sets:
  - 1. Cabinet Hardware.
  - 2. Signs, except as noted.
  - 3. Folding partitions, except cylinders where detailed.
  - 4. Sliding aluminum doors
  - 5. Chain link and wire mesh doors and gates
  - 6. Access doors and panels
  - 7. Overhead and Coiling doors

#### 1.3 Quality Assurance

# A. Requirements of Regulatory Agencies:

- 1. Furnish finish hardware to comply with the requirements of laws, codes, ordinances, and regulations of the governmental authorities having jurisdiction where such requirements exceed the requirements of the Specifications.
- 2. Furnish finish hardware to comply with the requirements of the regulations for public building accommodations for physically handicapped persons of the governmental authority having jurisdiction and to comply with Americans with Disabilities Act.
- 3. Provide hardware for fire-rated openings in compliance with NFPA 80 and state and local building code requirements. Provide only hardware that has been tested and listed by UL for types and sizes of doors required and complies with requirements of door and door frame labels.

# B. Hardware Supplier:

1. Shall be an established firm dealing in contract builders' hardware. He must have adequate inventory, qualified personnel on staff and be located within 100 miles of the project. The distributor must be a factory-authorized dealer for all materials required. The supplier shall be or have in employment an Architectural Hardware Consultant (AHC).

# C. Electrified Door Hardware Supplier:

- 1. Shall be an experienced door hardware supplier who has completed projects with electrified door hardware similar in material, design, and extent to that indicated for this project, whose work has resulted in construction with a record of successful in-service performance, and who is acceptable to manufacturer of primary materials.
- 2. Shall prepare data for electrified door hardware, including shop drawings, based on testing and engineering analysis of manufacturer's standard units in assemblies similar to those indicated for this project.

3. Shall have experience in providing consulting services for electrified door hardware installations.

### D. Pre-installation Meeting:

- 1. Before installation, hardware General Contractor/Construction Manager will request hardware installation meeting be conducted on the installation of hardware; specifically that locksets, closers, exit devices, overhead stops and coordinators. Manufacturer's representatives of the above products, in conjunction with the hardware supplier for the project, shall conduct the meeting. Meeting to be held at job site and attended by installers of hardware for aluminum, hollow metal and wood doors. Meeting to address proper coordination and installation of hardware, per finish hardware this specific schedule for project, by installation manuals, hardware schedule, templates, physical product samples and installation videos.
- When any electrical or pneumatic hardware is specified this meeting shall also include the following trades/installers: Electrical, Security, Alarm systems and Architect.
- 3. Convene one week or more prior to commencing work of this Section.
- 4. The Hardware Supplier shall include the cost of this meeting in his proposal.

# E. Manufacturer:

- Obtain each type of hardware (latch and locksets, hinges, closers, etc.) from a single manufacturer, although several may be indicated as offering products complying with requirements.
- Provide electrified door hardware from same manufacturer as mechanical door hardware, unless otherwise indicated.

#### 1.4 Submittals:

A. Hardware Schedule

- 1. Submit number of Hardware Schedules as directed in Division 1.
- 2. Follow guidelines established in Door & Hardware Institute Handbook (DHI) Sequence and Format for the Hardware Schedule unless noted otherwise.
- 3. Schedule will include the following:
  - a. Door Index including opening numbers and the assigned Finish Hardware set.
  - b. Preface sheet listing category only and manufacturer's names of items being furnished as follows:

CATEGORY	SPECIFIED	SCHEDULED
Hinges	Manufacturer A	Manufactur er B
Lock sets	Manufacturer X	Manufactur er X
Kick Plates	Open	Manufactur er Z

- c. Hardware Locations: Refer to Article 3.1 B.2 Locations.
- d. Opening Description: Single or pair, number, room locations, hand, active leaf, degree of swing, size, door material, frame material, and UL listing.
- e. Hardware Description: Quantity, category, product number, fasteners, and finish.
- f. Headings that refer to the specified Hardware Set Numbers.
- g. Scheduling Sequence shown in Hardware Sets.
- h. Product data of each hardware item, and shop drawings where required, for special conditions and specialty hardware.
- i. Electrified Hardware system operation description.
- j. "Vertical" scheduling format only. "Horizontal" schedules will be returned "Not Approved."

- k. Typed Copy.
- 1. Double-Spacing.
- m.  $8-1/2 \times 11$  inch sheets
- n. U.S. Standard Finish symbols or BHMA Finish symbols.

#### B. Product Data:

- 1. Submit, in booklet form Manufacturers Catalog cut sheets of scheduled hardware.
- 2. Submit product data with hardware schedule.

# C. Samples:

- 1. Prior to submittal of the final hardware schedule and prior to final ordering of finish hardware, submit one sample, if required, of each type of exposed hardware unit, finished as required and tagged with full description for coordination with schedule.
- 2. Samples will be returned to the supplier. Units, which are acceptable and remain undamaged through submittal, review and field comparison procedures may, after final check of operation, be used in the work, within limitations of keying coordination requirements.

# D. Key Schedule:

- 1. Submit detailed schedule indicating clearly how the Owner's final keying instructions have been followed.
- 2. Submit as a separate schedule.

## E. Electrified Hardware Drawings:

- 1. Submit elevation drawings showing relationship of all electrical hardware components to door and frame. Indicate number and gage of wires required.
  - a. Include wiring drawing showing point to point wire hook up for all components.
  - b. Include system operations descriptions for each type of opening; describe each possible condition.
- F. Submit to General Contractor/Construction Manager, the factory order acknowledgement numbers for the various hardware items to be used on the project. The factory

order acknowledgement numbers shall help to facilitate and expedite any service that may be required on a particular hardware item. General Contractor/Construction Manager shall keep these order acknowledgement numbers on file in the construction trailer.

- 1.5 Product Delivery, Storage, and Handling:
  - A. Label each item of hardware with the appropriate door number and Hardware Schedule heading number, and deliver to the installer so designated by the contractor.
- 1.6 Where existing doors, frames and/or hardware are to remain, conditions, preparations and functions shall be field verified to confirm compatibility with specified hardware. Where any incompatibility is discovered, notify the contractor or construction manager immediately and provide a suggested solution based on industry standard business practices.

#### 1.7 Warranties:

- A. Refer to Division 1 for warranty requirements.
- B. Special Warranty Periods:
  - 1. Closers shall carry manufacturer's 30-year warranty against manufacturing defects and workmanship.
  - 2. Locksets shall carry manufacturer's 3-year warranty against manufacturing defects and workmanship.
  - 3. Continuous gear hinges shall carry manufacturer's lifetime warranty to be free from defects in material and workmanship.
  - 4. Balance of items shall carry a manufacturer's 1-year warranty against manufacturing defects and workmanship.
- C. During the warranty period, replace defective work, including labor, materials and other costs incidental to the work.

## PART 2 - PRODUCT

- 2.1 Furnish each category with the products of only one manufacturer unless specified otherwise; this requirement is mandatory whether various manufacturers are listed or not.
- 2.2 Provide the products of manufacturer designated or if more than one manufacturer is listed, the comparable product of one of the other manufacturers listed. Where only one manufacturer or product is listed, it is understood that this is the owner's Building Standard and "no substitution" is allowed.

#### A. Hinges:

- 1. Furnish hinges of class and size as listed in sets.
- 2. Numbers used are Ives (IVE).
- 3. Equal products by Stanley and Hager are also acceptable.

# B. Continuous Gear Hinge:

- 1. 6063-T6 aluminum alloy, anodized finish (cap on entire hinge painted if specified). Manufacture to template, uncut hinges non-handed, pinless assembly, three interlocking extrusions, full height of door and frame, lubricated polyacetal thrust bearing, fasteners 410 stainless steel plated and hardened. All hinge profiles to be manufactured to template bearing locations, with standard duty bearing configurations at 5-1/8" spacing with a minimum of 16 bearings: and heavy duty at 2-9/16" spacing with a minimum of 32 bearings. Anodizing of material shall be done after fabrication of components so that all bearing slots are anodized.
- 2. Length: 1" less than door opening height. Fastener 12-24 x 1/2" #3 Phillips keen form stainless steel self-tapping at aluminum and hollow metal doors, 12- 1/2" #3 Philips, flathead full thread at wood doors.
- 3. Furnish fire rated hinges "FR" at labeled openings.

- 4. Numbers used are Ives.
  - a. For Wood and Hollow Metal frames;
    - 1) Ives 224HD
    - 2) Equal products by Hager & Select will also be accepted.
  - b. For Aluminum frames;
    - 1) Ives 112HD
    - 2) Equal products by Hager & Select will also be accepted.
- C. Flush Bolts:
  - 1. Constant Latching: metal doors:
    - a. Ives FB50 Series
    - b. Equal product of any B.H.M.A. member.
  - 2. Constant Latching: wood doors:
    - a. Ives FB60 Series
    - b. Equal product of any B.H.M.A. member.
  - 3. Manual wood and metal doors:
    - a. Ives FB458 Series
    - b. Equal product of any B.H.M.A. member.
  - 4. Dust Proof Strikes furnish with all flush bolts, except at openings having thresholds:
    - a. Ives DP2
    - b. Equal product of any B.H.M.A. member.
- D. Locksets and Latchsets Mortise Type:
  - Locksets shall be manufactured from heavy gauge steel, minimum lockcase thickness 1/8", containing components of steel with a zinc dichromate plating for corrosion resistance.
  - 2. Locks are to have a standard 2 %" backset with a full %" throw two-piece stainless steel mechanical antifriction latchbolt. Deadbolt shall be a full 1" throw, constructed of stainless steel.
  - 3. Lockcase shall be easily handed without chassis disassembly by removing handing screw on lockcase and installing in opposite location on reverse side. Changing of door hand bevel from standard to reverse hand shall be done by removing the lockcase scalp plate, and pulling and rotating the latchbolt 180 degrees.
  - 4. Lock trim shall be through-bolted to the door to assure correct alignment and proper operation. Lever

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trim shall have external spring cage mechanism to assist in support of the lever weight. Thumb turns shall have "EZ" thumbturn equal to Schlage L583-363.

- 5. Function numbers are Schlage.
  - a. Schlage L9000
- 6. Lockset Trim:
  - a. Schlage 06A
- 7. Provide strikes with extended lips where required to protect trim from being marred by latch bolt. Provide strike lips that do not project more than 1/8" beyond door frame trim at single doors and have 7/8" lip to center at pairs of 1-3/4" doors.
- 8. All lock functions shall be verified with the Owner prior to ordering any material. The supplier will include any related costs in their proposal.

#### E. Exit Devices:

- 1. Exit devices shall be touchpad style, fabricated of brass, bronze, stainless steel, or aluminum, plated to the standard architectural finishes to match the balance of the door hardware.
- 2. All exit devices shall incorporate a fluid damper, which decelerates the touchpad on its return stroke and eliminates noise associated with exit device operation. Touchpad shall extend a minimum of one half of the door width. All latchbolts to be deadlatching type, with a self-lubricating coating to reduce wear.
- 3. End-cap will be sloped to deflect any impact from carts and they shall be flush with the external mechanism case. End caps that overlap and project above the mechanism case are unacceptable. End cap shall utilize a two-point attachment to the mounting bracket.
- 4. Touchpad shall match exit device finish, and shall be stainless steel for US26, US26D, US28, US32, and US32D finishes. Only compression springs will be used in devices, latches, and outside trims or controls.
- 5. Plastic templates shall be included with each exit device to facilitate a quick, easy and accurate installation.

- 6. Strikes shall be roller type and come complete with a locking plate to prevent movement.
- All rim and vertical rod exit devices shall have passed a 5 million(5,000,000) cycle test based on ANSI A156.3, 1994, Grade 1 test standards and certified by an independent testing lab.
- 8. All mortise exit devices shall have passed a 10 million(10,000,000)cycle test based on ANSI A156.3, 1994, Grade 1 test standards and certified by an independent testing lab.
- 9. Provide cylinder dogging on panic exit hardware where noted in hardware sets.
- 10. Exit devices shall be UL listed panic exit hardware. All exit devices for fire rated openings shall be UL labeled fire exit hardware.
- 11. Lever trim for exit devices shall be vandal-resistant type, which will travel to a 90-degree down position when more than 35 pounds of torque are applied, and which can easily be re-set.
- 12. Von Duprin 98 Series. Series and function numbers as listed in sets.
- 13. Trim:
  - a. As specified in sets.
  - b. Levers to match lockset design where specified.

#### F. Removable Mullion:

- a. Interior/Exterior, mullion is removable only through the use of building keys.
  - 1) Von Duprin KR4954
- b. Interior Doors UL listed, Mullion is removable only through the use of building keys.
  - 1) Von Duprin KR9954

## G. Push and Pull Hardware:

- 1. Push Plates: Ives 8200 Series 4 x 16 x .050 inches.
- 2. Push Bars: Von Duprin 330/350
- 3. Push-Pull Units: One inch round rod. Push: Straight push bar, Pull: 90 degree offset, 12 inch centers. Attach top post of pull back to back with latch stile end of push bar, bottom post of pull and hinge stile end of push bar with end caps.
- 4. Pull, Offset: One inch round rod, 90 degree offset, 12 inch centers.

- 5. Pulls: One inch round rod, straight 12 inch centers.
- 6. Pull Plates: Ives 8302-8 4 x 16 x .050 inches. 8" center.
- 7. Pull, Bi-Fold: Dummy Lever Trims. Levers to match lockset lever design.
- 8. Pull, Wire: 3/4 inch diameter, 6 inch centers.
- 9. Vandal Resistant Pulls: Ives VR900 Series. Stainless steel construction 0.120 inches thick.
- 10. Manufacturer: Provide push and pull hardware from any member of B.H.M.A.

# H. Coordinator - Frame Stop Mounted:

- 1. Door coordinator shall prevent the active door from closing before inactive door. Stop mounted channel 1-5/8" x 5/8" steel tubing x length to suit door opening. Coordinator shall be UL listed. Furnish filler bars to fill gap between end of coordinator and inactive door frame. Furnish mounting brackets for all stop mounted hardware such as exit device strikes, door closer PA shoes, etc. Coordinators shall be prepared (cutout) at the factory for surface applied or concealed vertical rod panic devices if required.
- 2. Furnish with carry bar CB1 when required for proper operation.
  - a. Ives COR x length to suit.
  - b. Equal products of any BHMA manufacturer

#### I. Electric Strike:

- 1. Electric strikes shall provide remote release of latchbolts. They shall be designed for use with the type locks shown at each opening where required. Strikes will be UL Listed for Burglary-Resistant Electric Door Strike, and where required, shall be UL listed as electric strikes for Fire Doors or Frames. Faceplates shall be stainless steel with finish as specified for each opening. The locking components shall be stainless steel to resist damage and abuse.
- Solenoids shall be of the continuous duty type for the voltage specified. Plug connectors will be furnished. Strikes shall have an adjustable backbox to compensate for misalignment of door and frame.
- 3. Numbers used in sets are Von Duprin.

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- a. Von Duprin 6000 series
- J. Electric Power Transfer:
  - 1. Transfer power from door frame to edge of door, UL listed R4504.
  - 2. Von Duprin EPT

### K. Closers:

- 1. Door closers shall have fully hydraulic, full rack and pinion action with a high strength cast iron cylinder. Cylinder body shall be 1 ½" in diameter, and double heat treated pinion shall be 11/16" in diameter with double D slab drive arm connection.
- 2. Hydraulic fluid shall be of a type requiring no seasonal closer adjustment for temperatures ranging from 120 degrees F to -30 degrees F.
- 3. Spring power shall be continuously adjustable over the full range of closer sizes, and allow for reduced opening force for the physically handicapped. Hydraulic regulation shall be by tamper-proof, non-critical valves. Closers shall have separate adjustment for latch speed, general speed, and backcheck.
- 4. All closers shall have solid forged steel main arms (and forged forearms for parallel arm closers).
- 5. All surface mounted mechanical closers shall be certified to exceed ten million (10,000,000) full load cycles by a recognized independent testing laboratory.
- 6. Closers will have Powder coating finish certified to exceed 100 hours salt spray testing by ETL, an independent testing laboratory used by BHMA for ANSI certification.
- 7. Refer to door and frame details and furnish accessories such as drop plates, panel adapters, spacers and supports as required to correctly install door closers. State degree of door swing in the hardware schedule.
- 8. LCN Series as listed in sets.
- L. ADA Special Closers:

- 1. Where "Low Energy Power Operated Door" as defined by ANSI Standard A156.19 is indicated for doors required to be accessible to the disabled, provide electrically powered operators complying with the ADA requirements for opening force and time to close standards.
- 2. Full closing force shall be provided when the power or assist cycle ends.
- 3. Modular design, adjustments easily accessible from the front, UL listed for use on labeled doors.
- 4. Shall have "Second Chance" function to accommodate momentary resistance, "Breakaway" function in the electronically controlled clutch, "Soft Start" motor control function and "Maintain Hold-Open Switch" to hold the door open at 90 degree.
- 5. Shall have built in 12V and 24V power supply for actuators, card readers, electric strikes and magnetic door locks, inputs for both swing and stop side sensors and available to accept either 120VAC or 220VAC input power. All wiring connections between operator modules made by easy-to-handle electrical connectors. Shall comply with both UL and NEC requirements for Class 1 and Class 2 wiring by providing separate conduits for each.
- 6. Shall have seven independent electronic adjustments to tailor the operator for specific site conditions. Opening speed, holding force at 90 deg., sequential trigger and time delay, hold-open time at 90 deg., opening force, clutch "breakaway" force setting, electric strike trigger and time delay.
- 7. Shall have separate and independent adjustments for back check, main speed and latch speed.
- 8. LCN Series as listed in sets.
- 9. Furnish actuators and other controls as shown in Hardware Sets.

#### M. Overhead Holders and Stops:

1. Type, function and fasteners must be same as Glynn-Johnson specified. Size per manufacturer's selector chart. Plastic end caps, hold open mechanisms and shock blocks are not allowed. End caps must be finished same as balance of unit.

- Manufacture products using base material of Brass/Bronze for US3, US4, & US10B finished products and 300 Stainless Steel for US32 & US32D finished products.
- Type, function, and fasteners must be the same as Glynn-Johnson specified. Size per manufacturer's selector chart.
  - a. Glynn-Johnson

#### N. Kick Plates:

- 1. Furnish .050 inches thick, beveled four sides, countersunk fasteners, 10" high x door width less 2" at single doors and less 1" at pairs. Where glass or louvers prevent this height, supply with height equal to height of bottom rail less 2".
- 2. Any BHMA manufacturing product meeting above is acceptable.

#### O. Armor Plates:

1. Provide .050 inches thick, B4E, 36" x door width less 2" at single doors and 1" less door width at pairs. At exit devices provide height to bottom of exit device cases. At locksets, latchsets, or push pull latches, cut for rose or escutcheon. Bevel top edges of all plates.

## P. Wall Stops:

- 1. Length to exceed projection of all other hardware. Provide with threaded studs and expansion shields for masonry wall construction. Install with slope at top.
  - a. Ives WS33(X)
  - b. BHMA L12011 or L12021

# Q. Wall Holders:

- 1. Products specified by series only; furnish strike length to exceed projection of all other hardware.
  - a. Ives WS40
  - b. Equal products of any BHMA manufacturer

## R. Door Holding Magnets:

- 1. Electrically controlled, fail-safe, holds door open until current is interrupted.
- 2. Units will have 35 lbs of holding force.
- 3. Units will be "tri-voltage", 12VDC, 24VAC/DC & 120VAC.
- 4. Furnish model to hold door away from wall to allow for any trim or levers on pull side of door.
  - a. LCN SEM 7800 series

#### S. Thresholds:

- 1. 1/2" high 7.5" wide. Cope at jambs.
- 2. Furnish full wall opening width when frames are recessed.
- 3. Cope in front of mullions if thresholds project beyond door faces.
- 4. Furnish with non-ferrous Stainless Steel Screws and Lead Anchors.
  - a. National Guard as listed in sets
  - b. Equal of Zero or Reese

## T. Door Sweeps:

- 1. Surface Sweeps:
  - a. National Guard as listed in sets
  - b. Equal by Zero or Reese

# U. Weather-stripping:

- 1. Apply to head and jamb stops.
- 2. Solid Bar stock all sides
  - a. National Guard as listed in sets
  - b. Equal by Zero or Reese

### V. Meeting Stile Weather-stripping:

- 1. 2 Pc. Nylon brush type to seal gap between pairs of doors.
  - a. National Guard as listed in sets
  - b. Equal by Zero or Reese

#### W. Astragal:

1. Stainless steel, type 304, Finish 2B. 12 gauge 1-5/8 inch wide. #10 x 3/4" st. sheet metal screws.

- a. National Guard as listed in sets
- b. Equal by Zero or Reese

## X. Astragal, Sound:

- 1. Overlapping type.
  - a. National Guard as listed in sets
  - b. Equal by Zero or Reese
- 2. Meeting stile type.
  - a. National Guard as listed in sets
  - b. Equal by Zero or Reese

#### Y. Sound Seal:

- 1. Adjustable type perimeter seal.
  - a. National Guard as listed in sets
  - b. Equal by Zero by Reese

#### Z. Lock Protector:

- 1. Lock protector shall eliminate gap between door and frame. No exposed fasteners on face of unit.
  - a. Ives LG series

# AA. Automatic Door Bottoms:

- 1. Surface: Provide UL approved at all fire doors.
  - a. National Guard as listed in sets.
  - b. Equal by Zero by Reese

#### BB. Miscellaneous:

1. Furnish items not categorized in the above descriptions but specified by manufacturer's names in Hardware Sets.

#### CC. Fasteners:

1. Furnish fasteners of the proper type, size, quantity and finish. Use machine screws and expansion shields for attaching hardware to concrete or masonry, and wall grip inserts at hollow wall construction. Furnish machine screws for attachment to reinforced hollow metal doors and frames and reinforced aluminum doors and frames. Furnish full thread wood screws for attachment to solid wood doors and frames. "TEK" type screws are not acceptable.

2. Sex bolts will not be permitted on reinforced metal doors or wood doors where blocking is specified.

#### 2.3 Finishes:

- A. Generally, Dull Chrome, US26D / BHMA 626. Provide finish for each item as indicated in sets.
- 2.4 Templates and Hardware Location:
  - A. Furnish hardware made to template. Supply required templates and hardware locations to the door and frame manufacturers.
  - B. Furnish metal template to frame/door supplier for continuous hinge.
  - C. Refer to Article 3.1 B.2, Locations, and coordinate with templates.

## 2.5 Cylinders and Keying:

- A. All cylinders for this project will be supplied by one supplier regardless of door type and location.
- B. Provide a cylinder for all hardware components capable of being locked.
- C. Provide cylinder cores and keys "0" bitted for Owners keying. Provide keys and cores to match the existing Schlage Restricted system according to Owner's instructions. Provide minimum of two (2) keys per cylinder or as otherwise required by Owner.
- D. Provide cylinders with construction cores or keying for use during the construction period. The Owner's security department or representative will convert construction cores or keying to the final system.

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PART 3 - EXECUTION

#### 3.1 Installation

#### A. General:

- Install hardware according to manufacturers installations and template dimensions. Attach all items of finish hardware to doors, frames, walls, etc. with fasteners furnished and required by the manufacture of the item.
- 2. Provide blocking/reinforcement for all wall mounted Hardware.
- 3. Reinforced hollow metal doors and frames and reinforced aluminum door and frames will be drilled and tapped for machine screws.
- 4. Solid wood doors and frames: full thread wood screws. Drill pilot holes before inserting screws.
- 5. Continuous gear hinges attached to hollow metal doors and frames and aluminum doors and frames:  $12-24 \times 1/2$ " #3 Phillips Keenform self-tapping. Use #13 or 3/16 drill for pilot.
- 6. Continuous Gear Hinges require continuous mortar guards of foam or cardboard 1/2" thick x frame height, applied with construction adhesive.
- 7. Install weather-strip gasket prior to parallel arm closer bracket, rim exit device or any stop mounted hardware. Gasket to provide a continuous seal around perimeter of door opening. Allow for gasket when installing finish hardware. Door closers will require special templating. Exit devices will require adjustment in backset.

## B. Locations:

- 1. Dimensions are from finish floor to center line of items.
- 2. Include this list in Hardware Schedule.

#### CATEGORY

## DIMENSION

# FARMINGTON PUBLIC SCHOOLS 2018 RENOVATIONS-BID PACK #9

ELEMENTARY SCHOOLS 171712A NOVEMBER 21, 2017

Hinges Door Manufacturer's

Standard

Flush Bolt Levers 72" and 12"

Levers Door Manufacturer's

Standard

Exit Device Touchbar Per Template

Deadlatch Cylinder 43" unless conflicting

with push-pull.

Deadlock MS Cylinder 43" unless conflicting

with push-pull.

Hospital Push-Pull Manufacturer's Template

Roller Latch At Head

Push-Pull Units 42" to centerline of

Pull

Offset Pulls Suitable for Exit

Devices

Pulls - Flush Cup 46"

Pulls (BTB) 46"

Push-Pulls 46"

Push Plates 52"

Pull Plates 42"

Wire Pulls 42"

Wall Stops/Holders At Head

Astragals Pull side of active leaf

Trim Protector Bars Push side of door below

lever handle

NOVEMBER 21, 2017

Lock Protectors

Pull side of door

## C. Field Quality Inspection:

- 1. Inspect material furnished, its installation and adjustment, and instruct the Owner's personnel in adjustment, care and maintenance of hardware.
- Locksets and exit devices shall be inspected after installation and after the HVAC system is in operation and balanced, to insure correct installation and proper operation.
- 3. Closers shall be inspected and adjusted after the HVAC system is in operation and balanced, to insure correct installation and proper operation.
- 4. A written report stating compliance, and also locations and kinds of noncompliance shall be forwarded to the Architect with copies to the Contractor, hardware distributor, hardware installer and building owner.

# D. Technical and Warranty Information:

- 1. At the completion of the project, the technical and warranty information coalesced and kept on file by the General Contractor/Construction Manager shall be given to the Owner or Owner's Agent. In addition to both the technical and warranty information, all factory order acknowledgement numbers supplied to the General Contractor/Construction Manager during the construction period shall be given to the Owner or Owner's Agent. The warranty information and factory order acknowledgement numbers shall serve to both expedite and properly execute any warranty work that may be required on the various hardware items supplied on the project.
- 2. Submit to General Contractor/Construction Manager, two copies each of parts and service manuals and two each of any special installation or adjustment tools. Include for locksets, exit devices, door closers and any electrical products.

### 3.2 Hardware Sets:

# FARMINGTON PUBLIC SCHOOLS 2018 RENOVATIONS-BID PACK #9

ELEMENTARY SCHOOLS 171712A NOVEMBER 21, 2017

## HARDWARE SET NO. 01

# EACH TO HAVE:

3	EA	HINGE	5BB1 4.5 X 4.5	652	IVE
1	EΑ	STOREROOM LOCK	L9080BDC 06A	626	SCH
1	EΑ	FINAL CORE	(OWNER PROVIDED)		
1	EA	WALL STOP	WS404	626	IVE

COORDINATE STOP REQUIREMENT WITH ADJACENT CONDITIONS.

# HARDWARE SET NO. 02

# EACH TO HAVE:

3	EA	HINGE	5BB1 4.5 X 4.5	652	IVE
1	EΑ	OFFICE/ENTRY	L9050BDC 06A L583-363	626	SCH
		LOCK			
1	EΑ	FINAL CORE	(OWNER PROVIDED)		
1	EA	SURFACE CLOSER	4011	689	LCN
1	EΑ	PROTECTION PLATE	8400 10" X 2" LDW B-CS	630	IVE
1	EA	WALL STOP	WS33	626	IVE

# HARDWARE SET NO. 03

## EACH TO HAVE:

	EA EA	HINGE OFFICE/ENTRY LOCK	5BB1 4.5 X 4.5 L9050BDC 06A L583-363	652 626	IVE SCH
1	EΑ	FINAL CORE	(OWNER PROVIDED)		
1	EΑ	WALL STOP	WS33	626	IVE

# HARDWARE SET NO. 04

# FARMINGTON PUBLIC SCHOOLS

2018	NGTON PUBLIC SCHOOLS RENOVATIONS-BID PACK NTARY SCHOOLS	#9 171712A	NOVEMBER 21,	2017
EACH	TO HAVE:			
3 E	A HINGE	5BB1 4.5 X 4.5	652	IVE
1 E		L9444 06A L583-363 L2	283- 626	SCH
1 F.	TURN A WALL STOP	722 WS33	626	IVE
1 1			020	112
HARDW	ARE SET NO. 05			
EACH	TO HAVE:			
3 E	A HINGE	5BB1 4.5 X 4.5	652	IVE
1 E	A STOREROOM LOCK	L9080BDC 06A	626	SCH
	A SURFACE CLOSER		689	LCN
	A PROTECTION PLATE  A WALL STOP	8400 10" X 2" LDW B-C WS33	CS 630 626	IVE IVE
HARDW.	ARE SET NO. 06			
EACH	TO HAVE:			
	A HINGE	5BB1 4.5 X 4.5	652	IVE
	A CLASSROOM LOCK		626	SCH
	A FINAL CORE A SURFACE CLOSER	(OWNER PROVIDED) 4011	689	LCN
		8400 10" X 2" LDW B-C		IVE
	A WALL STOP	WS33	626	IVE
	ARE SET NO. 07			
	TO HAVE:	5DD1 4 5 33 4 5	650	<b></b>
3 E 1 E	_	5BB1 4.5 X 4.5 L9050BDC 06A L583-363	652 626	IVE SCH
T F.	LOCK	TANDURDC NOW T202-303	020	SCH
1 E	A OH STOP	450S	652	GLY
	A SURFACE CLOSER		689	LCN
1 E	A PROTECTION PLATE	8400 10" X 2" LDW B-C	CS 630	IVE
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# FARMINGTON PUBLIC SCHOOLS 2018 RENOVATIONS-BID PACK #9

ELEMENTARY SCHOOLS

171712A NOVEMBER 21, 2017

HARDWARE	SET	MO	ΛQ
	וים כי	14().	U/O

HAR!	DWARE	SET NO. 08			
EAC	н то	HAVE:			
3	EA	HINGE	5BB1 4.5 X 4.5	652	IVE
1	EA	CLASSROOM LOCK	L9070BDC 06A	626	SCH
1	EA	FINAL CORE	(OWNER PROVIDED)		
1	EA	SURFACE CLOSER		689	LCN
1	EA		8400 10" X 2" LDW B-CS	630	IVE
1	EA	WALL STOP	WS33	626	IVE
HAR	DWARE	SET NO. 09			
EAC	н то	HAVE:			
3	EA	HINGE	5BB1 4.5 X 4.5	652	IVE
1	EA		L9456BDC 06A L583-363	626	SCH
		IND	L283-722		
1	EA	SURFACE CLOSER		689	LCN
1	EA		8400 10" X 2" LDW B-CS	630	IVE
1	EA	WALL STOP	WS33	626	IVE
HAR	DWARE	SET NO. 10			
EAC:	н то	HAVE:			
2	EA	CONT. HINGE	112HD	710	IVE
1	EA	KEYED REMOVABLE		695	VON
		MULLION			
1	EA	PANIC HARDWARE	HDSI-98-EO	313	VON
1	EA	PANIC HARDWARE	HDSI-98-NL-OP-110MD	313	VON
1	EA	SFIC MORTISE	80-102	613	SCH
		CYL.			
1	EA	SFIC RIM HOUSING	80-129	613	SCH

2 EA FINAL CORE (OWNER PROVIDED) 2 EA CONCEALED PULL (BY DOOR MFR)

# FARMINGTON PUBLIC SCHOOLS 2018 RENOVATIONS-BID PACK #9

		OVATIONS-BID PACK RY SCHOOLS		BER 21,	2017
2 1		SURFACE CLOSER WEATHER SEAL	4111 SCUSH (PROVIDED BY THE DOOR & FRAME MFR)	695	LCN
1	EA	MULLION SEAL	5100	BLK	NGP
2		DOOR SWEEP		DKB	NGP
1	EA	THRESHOLD	425HD	DKB	NGP
HARI	OWARE	SET NO. 11			
EACI	TO E	HAVE:			
				652	
1	EA		(OWNER PROVIDED)	626	SCH
		SURFACE CLOSER		689	LCN
1 1		PROTECTION PLATE WALL STOP	8400 10" X 2" LDW B-CS	630 626	IVE IVE
		SET NO. 12			
	OT E				
2	T: 7\	TITNICE		652	T 7 7 77
			5BB1 4.5 X 4.5	652 626	
1	EA	CLASSROOM LOCK	L9070BDC 06A	652 626	IVE SCH
1	EA EA	CLASSROOM LOCK	L9070BDC 06A (OWNER PROVIDED)		
1 1 1 1	EA EA EA	CLASSROOM LOCK FINAL CORE SURFACE CLOSER PROTECTION PLATE	L9070BDC 06A (OWNER PROVIDED) 4111 EDA 8400 10" X 2" LDW B-CS	626 689 630	SCH LCN IVE
1 1 1	EA EA EA	CLASSROOM LOCK FINAL CORE SURFACE CLOSER	L9070BDC 06A (OWNER PROVIDED) 4111 EDA	626 689	SCH LCN
1 1 1 1	EA EA EA EA	CLASSROOM LOCK FINAL CORE SURFACE CLOSER PROTECTION PLATE	L9070BDC 06A (OWNER PROVIDED) 4111 EDA 8400 10" X 2" LDW B-CS	626 689 630	SCH LCN IVE
1 1 1 1 1 HARI	EA EA EA EA OWARE	CLASSROOM LOCK FINAL CORE SURFACE CLOSER PROTECTION PLATE WALL STOP  SET NO. 13  HAVE:	L9070BDC 06A (OWNER PROVIDED) 4111 EDA 8400 10" X 2" LDW B-CS WS33	626 689 630 626	SCH LCN IVE IVE
1 1 1 1 1 HARI	EA EA EA EA OWARE H TO	CLASSROOM LOCK FINAL CORE SURFACE CLOSER PROTECTION PLATE WALL STOP  SET NO. 13  HAVE: CONT. HINGE	L9070BDC 06A (OWNER PROVIDED) 4111 EDA 8400 10" X 2" LDW B-CS WS33	626 689 630 626	SCH LCN IVE IVE
1 1 1 1 1 HARI EACH	EA EA EA EA OWARE H TO EA EA	CLASSROOM LOCK FINAL CORE SURFACE CLOSER PROTECTION PLATE WALL STOP  SET NO. 13  HAVE: CONT. HINGE STOREROOM LOCK	L9070BDC 06A (OWNER PROVIDED) 4111 EDA 8400 10" X 2" LDW B-CS WS33	626 689 630 626	SCH LCN IVE IVE
1 1 1 1 1 HARI	EA EA EA EA OWARE H TO EA EA	CLASSROOM LOCK FINAL CORE SURFACE CLOSER PROTECTION PLATE WALL STOP  SET NO. 13  HAVE: CONT. HINGE STOREROOM LOCK	L9070BDC 06A (OWNER PROVIDED) 4111 EDA 8400 10" X 2" LDW B-CS WS33  112HD L9080BDC LLL 06A L283-150 (OWNER PROVIDED)	626 689 630 626	SCH LCN IVE IVE

# FARMINGTON PUBLIC SCHOOLS 2018 RENOVATIONS-BID PACK #9

		OVATIONS-BID PACK RY SCHOOLS	#9 171712A	NOVEMBER	21,	2017
1 1			4111 SHCUSH SRI (PROVIDED BY THE DOOR FRAME MFR)		95	LCN
		DOOR SWEEP			KB	NGP
1	ĽА	THRESHOLD	425HD	Dr	KB	NGP
HARI	OWARE	SET NO. 14				
EACI	TO I	HAVE:				
3	EΑ	HINGE	5BB1 4.5 X 4.5	65	52	IVE
		CLASSROOM LOCK		62	26	SCH
1			(OWNER PROVIDED)	<i></i>	2.0	~
		OH STOP			30	GLY
		SURFACE CLOSER	4011 8400 10" X 2" LDW B-C		89 30	LCN IVE
HARI	OWARE	SET NO. 15				
F.A.C.F	I TO 1	HAVE:				
		CONT. HINGE	112HD	7 -	10	IVE
			HDSI-98-NL-OP-110MD	31		VON
1		SFIC RIM HOUSING			13	SCH
1			(OWNER PROVIDED)			
1	EA			69	95	LCN
1	EA	WALL STOP	WS11X	6.3	13	IVE
1	SET	WEATHER SEAL	(PROVIDED BY THE DOOF FRAME MFR)	& 5		
1	SET	WEATHER SEAL	(PROVIDED BY THE DOOF FRAME MFR)	& 5		
1	EA	DOOR SWEEP	600A	DF	KB	NGP
1	EA	THRESHOLD	425HD	DF	KB	NGP

HARDWARE SET NO. 16

EACH TO HAVE:

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		OVATIONS-BID PACK RY SCHOOLS	#9 171712A	NOVEMBER 21,	2017
3	EA	HINGE	5BB1 4.5 X 4.5	652	IVE
			L9070BDC 06A	626	SCH
⊥ 1	EA EA	FINAL CORE WALL STOP	(OWNER PROVIDED)	626	IVE
_				020	1,1
HAR	DWARE	SET NO. 17			
	H TO				
			5BB1 4.5 X 4.5		
		HARDWARE	9827-L-F-LBR-06-499F-		VON
		SFIC RIM HOUSING		626	SCH
		SURFACE CLOSER		689	LCN
2		WALL STOP	8400 10" X 1" LDW B-C	626	IVE IVE
HAR	DWARE	SET NO. 18			
E 7 (1)		11 7 7 7TT •			
	H TO :		5BB1 4.5 X 4.5	652	IVE
		CLASSROOM LOCK		626	SCH
			(OWNER PROVIDED)	020	5011
1	EA	SURFACE CLOSER	4111 SCUSH	689	LCN
1	EA	PROTECTION PLATE	8400 10" X 2" LDW B-C	CS 630	IVE
1	EA	WALL STOP	WS33	626	IVE
HAR	DWARE	SET NO. 19			
EAC	H TO	HAVE:			
	EA		5BB1 4.5 X 4.5		IVE
1	EA	OFFICE/ENTRY LOCK	L9050BDC 06A L583-363	626	SCH
1		FINAL CORE			
1	EA	SURFACE CLOSER	4111 EDA	689	LCN
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# FARMINGTON PUBLIC SCHOOLS 2018 RENOVATIONS-BID PACK #9

		RY SCHOOLS	#9 171712A	NOVEMBER	21, 2017
		PROTECTION PLATE	8400 10" X 2" LDW B-0 WS33		0 IVE 6 IVE
HAR:	DWARE	SET NO. 20			
EAC:	н то	HAVE:			
2	EA	CONT. HINGE	112HD	71	0 IVE
1	EA	KEYED REMOVABLE MULLION	KR4954-STAB	69	5 VON
2		PANIC HARDWARE		31	3 VON
1	EA	SFIC MORTISE CYL.		61	3 SCH
	EA	FINAL CORE			
		CONCEALED PULL		60	F
		SURFACE CLOSER	(PROVIDED BY THE DOOR		5 LCN
	SEI		FRAME MFR)	ν α	
1	EΑ	MULLION SEAL	•	BL	K NGP
2		DOOR SWEEP		DK	B NGP
1	EA	THRESHOLD	425HD	DK	B NGP
HAR	DWARE	SET NO. 21			
EAC:	н то	HAVE:			
		CONT. HINGE			0 IVE
1	EA	PANIC HARDWARE		31	
1	EA	SURFACE CLOSER			5 LCN
1	SET	WEATHER SEAL	(PROVIDED BY THE DOOF FRAME MFR)	< &	
1	SET	WEATHER SEAL	(PROVIDED BY THE DOOF FRAME MFR)	₹ &	
1	EΑ	DOOR SWEEP	600A	DK	B NGP
1	EA	THRESHOLD	425HD	DK	B NGP

2018	REN	ON PUBLIC SCHOOLS OVATIONS-BID PACK RY SCHOOLS		BER 21,	2017
HARI	WARE	SET NO. 22			
3	EA EA	CLASSROOM LOCK	5BB1 4.5 X 4.5 L9070BDC 06A 450S	652 626 652	
HARI	OWARE	SET NO. 23			
EACH	TO I	HAVE:			
3 1	EA EA	HINGE DBL CYL STORE W/DB	5BB1 4.5 X 4.5 L9466BDC 06A	652 626	IVE SCH
1 1 1	EΑ	OH STOP SURFACE CLOSER		652 689 630	GLY LCN IVE
		SET NO. 24			
	EA	HAVE: HINGE	5BB1 4.5 X 4.5	652	IVE
1	EA	PRIV W/DB COIN TURN	L9444 06A L583-363 L283- 722	626	SCH
1	EA	OH STOP	450S	652	GLY
HARI	OWARE	SET NO. 25			
		HAVE:		650	T7777
3 1	EA EA	HINGE PUSH PLATE	5BB1 4.5 X 4.5 8200 4" X 16"	652 630	IVE IVE
1	EA	PULL PLATE	8302 8" 4" X 16"	630	IVE
1 1	EA EA	SURFACE CLOSER PROTECTION PLATE	4111 EDA 8400 10" X 2" LDW B-CS	689 630	LCN IVE
1	EA	WALL STOP	WS33	626	IVE

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HAR	DWARE	SET NO. 26			
EAC	н то	HAVE:			
3	EA	HINGE	5BB1 4.5 X 4.5	652	IVE
1	EA	DBL CYL STORE	L9466BDC 06A	626	SCH
		W/DB			
		FINAL CORE			
1	EA	WALL STOP	WS33	626	IVE
HAR	DWARE	SET NO. 27			
E 3 C					
	H TO		EDD1 4 E W 4 E	650	TT 777
3 1		HINGE STOREROOM LOCK	5BB1 4.5 X 4.5	652 626	IVE SCH
1		OH STOP	450S	652	GLY
1		SURFACE CLOSER		689	LCN
1			8400 10" X 2" LDW B-CS		IVE
HAR	DWARE	SET NO. 28			
F.A.C.	н то :	HAVE:			
	EA		5BB1 4.5 X 4.5	652	IVE
1		CONST LATCHING		630	IVE
		BOLT			
1	EA	CLASSROOM LOCK	L9070BDC 06A	626	SCH
1	EA	COORDINATOR	COR X FL	628	IVE
2	EA	MOUNTING BRACKET		689	IVE
1	EA	OH STOP	90S	630	GLY
2	EA	SURFACE CLOSER		689	LCN
2 1	EA EA	PROTECTION PLATE WALL STOP	8400 10" X 1" LDW B-CS WS33	630 626	IVE IVE
Т	ĽА	MATH DIOL	Wass	020	TAR

# FARMINGTON PUBLIC SCHOOLS 2018 RENOVATIONS-BID PACK #9

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HARDWARE	マデエ	NIO	29
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HARI	JWARE	SET NO. 29			
EACI	H TO I	HAVE:			
1	EΑ	CONT. HINGE	112HD	710	IVE
1	EΑ	PANIC HARDWARE	HDSI-98-NL-OP-110MDWH	313	VON
1	EA	SFIC RIM HOUSING	80-129	613	SCH
1	EA	FINAL CORE	(OWNER PROVIDED)		
1	EA	CONCEALED PULL	(BY DOOR MFR)		
1	EΑ	SURFACE CLOSER	4011T	695	LCN
1	SET	WEATHER SEAL	(PROVIDED BY THE DOOR & FRAME MFR)	x	
1	EA	DOOR SWEEP	600A	DKB	NGP
1			425HD	DKB	NGP
HARI	OWARE	SET NO. 30			
EACI	H TO I	HAVE:			
2	EΑ	CONT. HINGE	224HD	628	IVE
2	EΑ	DUMMY PUSH BAR	350	626	VON
2	EΑ	CONCEALED PULL	(BY DOOR MFR)		
2	EΑ			695	LCN
2	EA	WALL STOP	WS33	626	IVE
HARI	OWARE	SET NO. 31			
EACI	H TO I	HAVE:			
2	EΑ	CONT. HINGE	112HD	710	IVE
1	EΑ	KEYED REMOVABLE	KR4854-B-STAB	695	VON
		MULLION			
1	EΑ	PANIC HARDWARE	HDSI-98-EO	313	VON
1	EΑ	PANIC HARDWARE	HDSI-98-NL-OP-110MD	313	VON
1	EA	SFIC MORTISE	80-102	613	SCH
		CYL.			
1	EΑ	SFIC RIM HOUSING		613	SCH
1	EA	ELECTRIC STRIKE	9600 LBSM FSE	613	HES

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### FARMINGTON PUBLIC SCHOOLS 2018 RENOVATIONS-BID PACK #9

ELEMENTARY SCHOOLS		RY SCHOOLS	171712A	NOVEMBER 21,	2017
2	EA	DOOR PULL, 1" ROUND	8103HD 12" O	613	IVE
1	EA	OH STOP	100S	613	GLY
1	EA	OH STOP	100SE	613	GLY
1	EA	SURFACE CLOSER	4021	695	LCN
1	EA	SURF. AUTO OPERATOR	4642 WMS	695	LCN
1	EΑ	MOUNTING PLATE	4020-18G	695	LCN
1	EA	WEATHER RING	8310-801	PLA	LCN
2	EA	ACTUATOR, WALL MOUNT	8310-853T	630	LCN
1	SET	WEATHER SEAL	(PROVIDED BY THE DOOR FRAME MFR)	2 &	
1	EA	MULLION SEAL	5100	BLK	NGP
2	EΑ	DOOR SWEEP	600A	DKB	NGP
1	EΑ	THRESHOLD	425HD	DKB	NGP
1	EA	ACCESS CONTROL	(PROVIDED BY SECURITY CONTRACTOR)	7	

PRESENTING AN AUTHORIZED CREDENTIAL WILL ENERGIZE THE ELECTRIC STRIKE AND ALLOW ACCESS. FREE EGRESS IS ALWAYS ALLOWED. THE OUTSIDE AUTOMATIC OPERATOR ACTUATOR IS ENABLED ONLY WHEN THE ELECTRIC STRIKE IS ENERGIZED. THE INSIDE AUTOMATIC OPERATOR ACTUATOR IS ALWAYS ENABLED.

COORDINATE SYSTEM OPERATION AND COMPONENT LOCATIONS WITH THE OWNER, THE ARCHITECT AND ALL RELATED TRADES.

#### HARDWARE SET NO. 32

#### EACH TO HAVE:

6	EΑ	HINGE	5BB1 4.5 X 4.5	652	IVE
2	EΑ	FIRE EXIT	98-L-F-06-SNB	626	VON
		HARDWARE			
2	EΑ	SFIC RIM HOUSING	80-129	626	SCH
1	EA	SURFACE CLOSER	4111 EDA	689	LCN
1	EA	SURFACE CLOSER	4111 SCUSH	689	LCN
2	EA	PROTECTION PLATE	8400 10" X 2" LDW B-CS	630	IVE
1	EA	WALL STOP	WS33	626	IVE

### FARMINGTON PUBLIC SCHOOLS 2018 RENOVATIONS-BID PACK #9

ELEMENTARY SCHOOLS 171712A NOVEMBER 21, 2017

#### HARDWARE SET NO. 33

#### EACH TO HAVE:

_					
6	EA	HINGE	5BB1 4.5 X 4.5	652	IVE
2	EA	FIRE EXIT	98-L-F-06-SNB	626	VON
		HARDWARE			
2	EΑ	SFIC RIM HOUSING	80-129	626	SCH
2	EΑ	SURFACE CLOSER	4111 EDA	689	LCN
2	EΑ	PROTECTION PLATE	8400 10" X 2" LDW B-CS	630	IVE
2	EΑ	WALL STOP	WS33	626	IVE

#### HARDWARE SET NO. 34

#### EACH TO HAVE:

3	EΑ	HINGE	5BB1 4.5 X 4.5	652	IVE
1	EA	FIRE EXIT	98-L-BE-F-06-SNB	626	VON
		HARDWARE			
1	EA	SFIC RIM HOUSING	80-129	626	SCH
1	EA	SURFACE CLOSER	4011	689	LCN
1	EΑ	PROTECTION PLATE	8400 10" X 2" LDW B-CS	630	IVE
1	EΑ	WALL STOP	WS33	626	TVE

#### HARDWARE SET NO. 35

#### EACH TO HAVE:

3	EA	HINGE	5BB1 4.5 X 4.5	652	IVE
1	EΑ	PRIVACY W/DB &	L9456BDC 06A L583-363	626	SCH
		IND	L283-722		
1	EA	SURFACE CLOSER	4111 EDA	689	LCN
1	EΑ	PROTECTION PLATE	8400 10" X 2" LDW B-CS	630	IVE
1	EΑ	WALL STOP	WS33	626	IVE
1	SET	SEALS	2525C 17'	CLR	NGP

# FARMINGTON PUBLIC SCHOOLS

201	8 REN	ON PUBLIC SCHOOLS OVATIONS-BID PACK RY SCHOOLS	#9 171712A	NOVEMBER	21,	2017
HAR	DWARE	SET NO. 36				
EAC	н то	HAVE:				
	EA		5BB1 4.5 X 4.5			IVE
Τ	ĽА	OFFICE/ENTRY LOCK	L9050BDC 06A L583-363	6 2	26	SCH
1	EA		450S	65	52	GLY
HAR	DWARE	SET NO. 37				
		HAVE:				
		CONT. HINGE			LO	IVE
		PANIC HARDWARE			L3	VON
1		SFIC MORTISE	HDSI-98-NL-OP-110MD		L3 L3	VON SCH
	ĽА	CYL.	00-102	01	1.3	SCH
1	EΑ			61	L3	SCH
	EA	FINAL CORE				
		CONCEALED PULL			\ <b>-</b>	T CNT
2	EA	SURFACE CLOSER			95	LCN
۷	SET	WEATHER SEAL	(PROVIDED BY THE DOOR FRAME MFR)	C &		
2	EΑ	DOOR SWEEP	600A	DF	ζB	NGP
2	EA	THRESHOLD	425HD	Dł	ζB	NGP
HAR	DWARE	SET NO. 38				
EAC	н то	HAVE:				
2	EΑ	CONT. HINGE	112HD	71	L O	IVE
		PANIC HARDWARE		31	L3	VON
			HDSI-98-NL-OP-110MD		L3	VON
1	EA	SFIC MORTISE CYL.	80-102	61	L3	SCH
1	EΑ	SFIC RIM HOUSING	80-129	61	L3	SCH
_	EΑ	FINAL CORE				
		CONCEALED PULL				
1	EA	SURFACE CLOSER	4111 EDA	69	95	LCN

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### FARMINGTON PUBLIC SCHOOLS 2018 RENOVATIONS-BID PACK #9

INDEX OF DRAWINGS

		OVATIONS-BID PACK RY SCHOOLS	#9 171712A	NOVEMBE	R 21,	2017
1	EA			6	595 513	LCN IVE
2 2		DOOR SWEEP	•			NGP NGP
HARI	OWARE	SET NO. 39				
2 2	EA	HAVE: CONT. HINGE DUMMY PUSH BAR CONCEALED PULL	350		528 526	IVE VON
1 1	EA EA	SURFACE CLOSER SURFACE CLOSER WALL STOP	4111 EDA 4111 SCUSH	6		LCN LCN IVE
HARI	OWARE	SET NO. 40				
EACI	H TO I	HAVE:				
2	EA	HINGE CLASSROOM LOCK FINAL CORE			552 526	IVE SCH
2		OH STOP	90S	6	530	GLY
2 2	EA EA	SURFACE CLOSER	4011 8400 10" X 2" LDW B-0		589 530	LCN IVE
HARI		SET NO. 41			, , , ,	
6	EA	HINGE	5BB1 4.5 X 4.5		552	IVE
2		DUMMY PUSH BAR DOOR PULL, 1"			526	VON
∠	EA	ROUND	0103HD 17. O	6	530	IVE

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### FARMINGTON PUBLIC SCHOOLS 2018 RENOVATIONS-BID PACK #9

INDEX OF DRAWINGS

		OVATIONS-BID PACK RY SCHOOLS	#9 171712A NOVEMBER	21, 2017
		SURFACE CLOSER PROTECTION PLATE	4111 SCUSH 68 8400 10" X 2" LDW B-CS 68	89 LCN 30 IVE
	OWARE	SET NO. 42		
6	EA EA		350 6.	52 IVE 26 VON 30 IVE
1	EA EA EA	ROUND SURFACE CLOSER SURFACE CLOSER	4111 EDA 63 4111 SCUSH 63 8400 10" X 2" LDW B-CS 63	89 LCN 89 LCN
		SET NO. 43		
6 2 2 2 2	EA EA	HINGE DUMMY PUSH BAR DOOR PULL, 1" ROUND SURFACE CLOSER	8103HD 12" O 6: 4111 EDA 6: 8400 10" X 2" LDW B-CS 6:	26 VON 30 IVE 89 LCN
		SET NO. 44		
EACH 2 1 1	H TO EAEAEAEAEA	HAVE: CONT. HINGE PANIC HARDWARE PANIC HARDWARE SFIC MORTISE CYL.	HDSI-98-EO 3: HDSI-98-NL-OP-110MD 3:	10 IVE 13 VON 13 VON 13 SCH

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### FARMINGTON PUBLIC SCHOOLS

		OVATIONS-BID PACK RY SCHOOLS	#9 171712A NOVEM	IBER 21,	2017
2	EA	SFIC RIM HOUSING FINAL CORE CONCEALED PULL	(OWNER PROVIDED)	613	SCH
2	EA	SURFACE CLOSER	4111 EDA	695	
		WALL STOP		613	IVE
2			(PROVIDED BY THE DOOR & FRAME MFR)		
		DOOR SWEEP		DKB	
2	ĽА	THRESHOLD	425HD	DKB	NGP
HARI	OWARE	SET NO. 45			
EACI	H TO	HAVE:			
			5BB1 4.5 X 4.5		
1	EA	PRIV W/DB COIN TURN	L9444 06A L583-363 L283- 722	626	SCH
		SURFACE CLOSER		689	
		PROTECTION PLATE WALL STOP	8400 10" X 2" LDW B-CS	630 626	
HARI	OWARE	SET NO. 46			
	H TO	HAVE: CONT. HINGE	11200	710	T 7 7 727
	EA EA	KEYED REMOVABLE		710 695	IVE VON
_	ш.	MULLION	RR 1031 B BIMB	0,7,5	VOIV
1	EA	PANIC HARDWARE	HDSI-98-EO	313	VON
1	EA		HDSI-98-NL-OP-110MD	313	VON
1	EA	SFIC MORTISE CYL.	80-102	613	SCH
1	EΑ	SFIC RIM HOUSING		613	SCH
1	EA	ELECTRIC STRIKE		613	HES
2	EA 	DOOR PULL, 1" ROUND		613	IVE
1	EA	OH STOP	100S	613	GLY
1 1	EA EA	OH STOP SURFACE CLOSER	100SE 4021	613 695	GLY LCN
Т	ĽΑ	DOLLACE CHOSEK	1021	093	TICTA
	IND	EX OF DRAWINGS		08710	- 36

### FARMINGTON PUBLIC SCHOOLS 2018 RENOVATIONS-BID PACK #9

ELEMENTARY SCHOOLS			171712A	NOVEMBER 21,	2017
1	EA	SURF. AUTO OPERATOR	4642 WMS	695	LCN
1	EA	MOUNTING PLATE	4020-18G	695	LCN
2	EA	ACTUATOR, WALL MOUNT	8310-853T	630	LCN
1	EA	ACCESS CONTROL	(PROVIDED BY SECURITY CONTRACTOR)	Z .	

PRESENTING AN AUTHORIZED CREDENTIAL WILL ENERGIZE THE ELECTRIC STRIKE AND ALLOW ACCESS. FREE EGRESS IS ALWAYS ALLOWED. THE OUTSIDE AUTOMATIC OPERATOR ACTUATOR IS ENABLED ONLY WHEN THE ELECTRIC STRIKE IS ENERGIZED. THE INSIDE AUTOMATIC OPERATOR ACTUATOR IS ALWAYS ENABLED.

COORDINATE SYSTEM OPERATION AND COMPONENT LOCATIONS WITH THE OWNER, THE ARCHITECT AND ALL RELATED TRADES.

#### HARDWARE SET NO. 47

#### EACH TO HAVE:

6	EΑ	HINGE	5BB1 4.5 X 4.5	652	IVE
1	SET	CONST LATCHING	FB62	630	IVE
		BOLT			
1	EA	CLASSROOM LOCK	L9070BDC 06A	626	SCH
1	EA	COORDINATOR	COR X FL	628	IVE
2	EA	MOUNTING BRACKET	MB	689	IVE
2	EA	SURFACE CLOSER	4111 SCUSH	689	LCN
2	EA	PROTECTION PLATE	8400 10" X 1" LDW B-CS	630	IVE

#### HARDWARE SET NO. 48

#### EACH TO HAVE:

3	EA	HINGE	5BB1 4.5 X 4.5	652	IVE
1	EΑ	PRIVACY W/DB &	L9456BDC 06A L583-363	626	SCH
		IND	L283-722		
1	EA	OH STOP	450S	652	GLY
1	EA	SURFACE CLOSER	4011	689	LCN
1	EA	PROTECTION PLATE	8400 10" X 2" LDW B-CS	630	IVE

# FARMINGTON PUBLIC SCHOOLS 2018 RENOVATIONS-BID PACK #9

ELEMENTARY SCHOOLS 171712

171712A NOVEMBER 21, 2017

#### HARDWARE SET NO. 49

#### EACH TO HAVE:

3	EA	HINGE	5BB1 4.5 X 4.5	652	IVE
1	EA	PRIV W/DB COIN	L9444 06A L583-363 L283-	626	SCH
		TURN	722		
	EA	SURFACE CLOSER	4111 EDA	689	LCN
1	EΑ	PROTECTION PLATE	8400 10" X 2" LDW B-CS	630	IVE
1	EΑ	WALL STOP	WS33	626	TVE

FARMINGTON PUBLIC SCHOOLS 2018 RENOVATIONS-BID PACK #9 ELEMENTARY SCHOOLS

171712A NOVEMBER 21, 2017

END OF SECTION 08 71 00

#### Door/Hardware Index

#### BEECHVIEW ELEM

BEECHVIEW ELEM			
Mark#	HWSet #		
B-A100A	-		
B-A100B	13		
B-A101A	13		
B-A102A	03		
B-A103A	-		
B-A105A	08		
B-A105B	26		
B-A106A	24		
B-A107A	04		
B-A108A	16		
B-A109A	08		
B-A110A	22		
B-A111A	02		
B-A112A	08		
B-A112B	21		
B-A114A	08		
B-A115A	04		
B-A116A	24		
B-A117A	16		
B-A118A	08		
B-A119A	22		
B-A120A	16		
B-A121A	24		
B-A122A	04		
B-A123A	08		
B-A124A	08		
B-A125A	22		
B-A126A	08		
B-A127A	22		
B-A128A	04		
B-A129A	22		
B-A130A	08		
B-A131A	22		
B-A132A	04		
B-A133A	22		
B-A134A	10		
B-A137A	20		
B-A145B	22		
B-A146A	33		
B-A146B	33		
Droject: Fari	animatan Dulalia Cal		

Project: Farmington Public Schools - 2018	Control #: 379880	Print Date: Dec 18	
Projects		2017 3:46PM EST	
Company: Allegion PLC	Version #: 1	Ver Date: Dec 18 2017	Page <b>1</b> of <b>5</b>
		6:15AM EST	

Mark #	HWSet #
B-A147A	
	05
B-A148A	03
B-A149A	36
B-A150A	10
B-A150B	29
B-A151A	35
B-A152A	35
B-A153A	19
B-A154A	37
B-A154B	30
B-A154C	05
B-B101A	-
B-B102A	02
B-B103A	07
B-B104A	38
B-B104B	42
B-B106A	08
B-B107A	16
B-B108A	08
B-B109A	16
B-B110A	08
B-B110B	08
B-B111A	16
B-B112A	08
B-B113A	16
B-B114A	08
B-B115A	16
B-B116A	08
B-B117A	16
B-B118A	08
B-B119A	16
B-B121A	16
B-B122A	08
B-B123A	22
B-B125A	16
B-B127A	08
B-B128A	12
B-B129A	11
B-B130A	12
B-B131A	08
B-B132A	16
B-B132A	31
B-B134A	46
D-D134W	T-U

Project: Farmington Public Schools - 2018	Control #: 379880	Print Date: Dec 18	
Projects		2017 3:46PM EST	
Company: Allegion PLC	Version #: 1	Ver Date: Dec 18 2017	Page <b>2</b> of <b>5</b>
		6:15AM EST	

Mark #	HWSet #
B-B135A	02
B-B135B	02
B-B136A	03
B-B137A	03
B-B138A	04
B-B139A	03
B-B140A	01
B-B142A	47
B-B143A	05
B-B144A	17
B-B144B	17
B-B145A	48
B-B146A	48
B-B147A	08
B-B148B	22
B-B149A	08
B-B151A	13
B-B154A	08
B-B155A	08
B-B156A	16

#### KENBROOK ELEM

Mark #	HWSet #
K-A101A	08
K-A102A	08
K-A103A	08
K-A104A	08
K-A106A	18
K-A107A	08
K-A110A	18
K-A111A	08
K-A114A	25
K-A115A	18
K-A116A	25
K-A119A	18
K-A122A	27
K-A123A	-
K-A123B	-
K-A125A	38
K-A125B	39
K-A127A	08
K-A128A	06
K-A129A	08


Project: Farmington Public Schools - 2018	Control #: 379880	Print Date: Dec 18	
Projects		2017 3:46PM EST	
Company: Allegion PLC	Version #: 1	Ver Date: Dec 18 2017	Page <b>3</b> of <b>5</b>
		6:15AM EST	

Mark #	HWSet #
K-A130A	08
K-A130B	08
K-A132B	07
K-A133A	08
K-A136A	37
K-A137A	08
K-A139B	-
K-A140A	25
K-A141A	12
K-A141B	12
K-A142A	27
K-A143A	40
K-A143B	32
K-A143C	32
K-A144A	25
K-A145A	41
K-A146A	08
K-A147A	37
K-A149A	08
K-A150A	08
K-A151A	24
K-A154A	08
K-A155A	24
K-A155B	04
K-A157A	08
K-A158A	04
K-A158B	24
K-A161A	04
K-A161B	04
K-A162A	08
K-A163A	08
K-A166A	04
K-A166B	04
K-A167A	24
K-A167B	04
K-A168A	08
K-A168B	23
K-A169A	08
K-A172A	24
K-A173A	24
K-A174A	08
K-A174B	-

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Projects		2017 3:46PM EST	
Company: Allegion PLC	Version #: 1	Ver Date: Dec 18 2017	Page <b>4</b> of <b>5</b>
		6:15AM EST	


Mark #	HWSet #
K-A176A	04
K-A177A	37
K-A177B	42
K-A178A	12
K-B100A	03
K-B101A	07
K-B101B	02
K-B102A	19
K-B103B	03
K-B104B	24
K-B105A	22
K-B106A	31
K-B106B	46
K-B108A	09
K-B109A	16
K-B110A	33
K-B110B	43
K-B111A	14
K-B113B	44
K-B114A	12
K-B115A	45
K-B116A	34
K-B116B	15
K-B118A	28
K-B119A	05
K-B121A	02
K-B122A	36
K-B123A	03
K-B124A	49
K-B129A	16

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Projects		2017 3:46PM EST	
Company: Allegion PLC	Version #: 1	Ver Date: Dec 18 2017	Page <b>5</b> of <b>5</b>
		6:15AM EST	

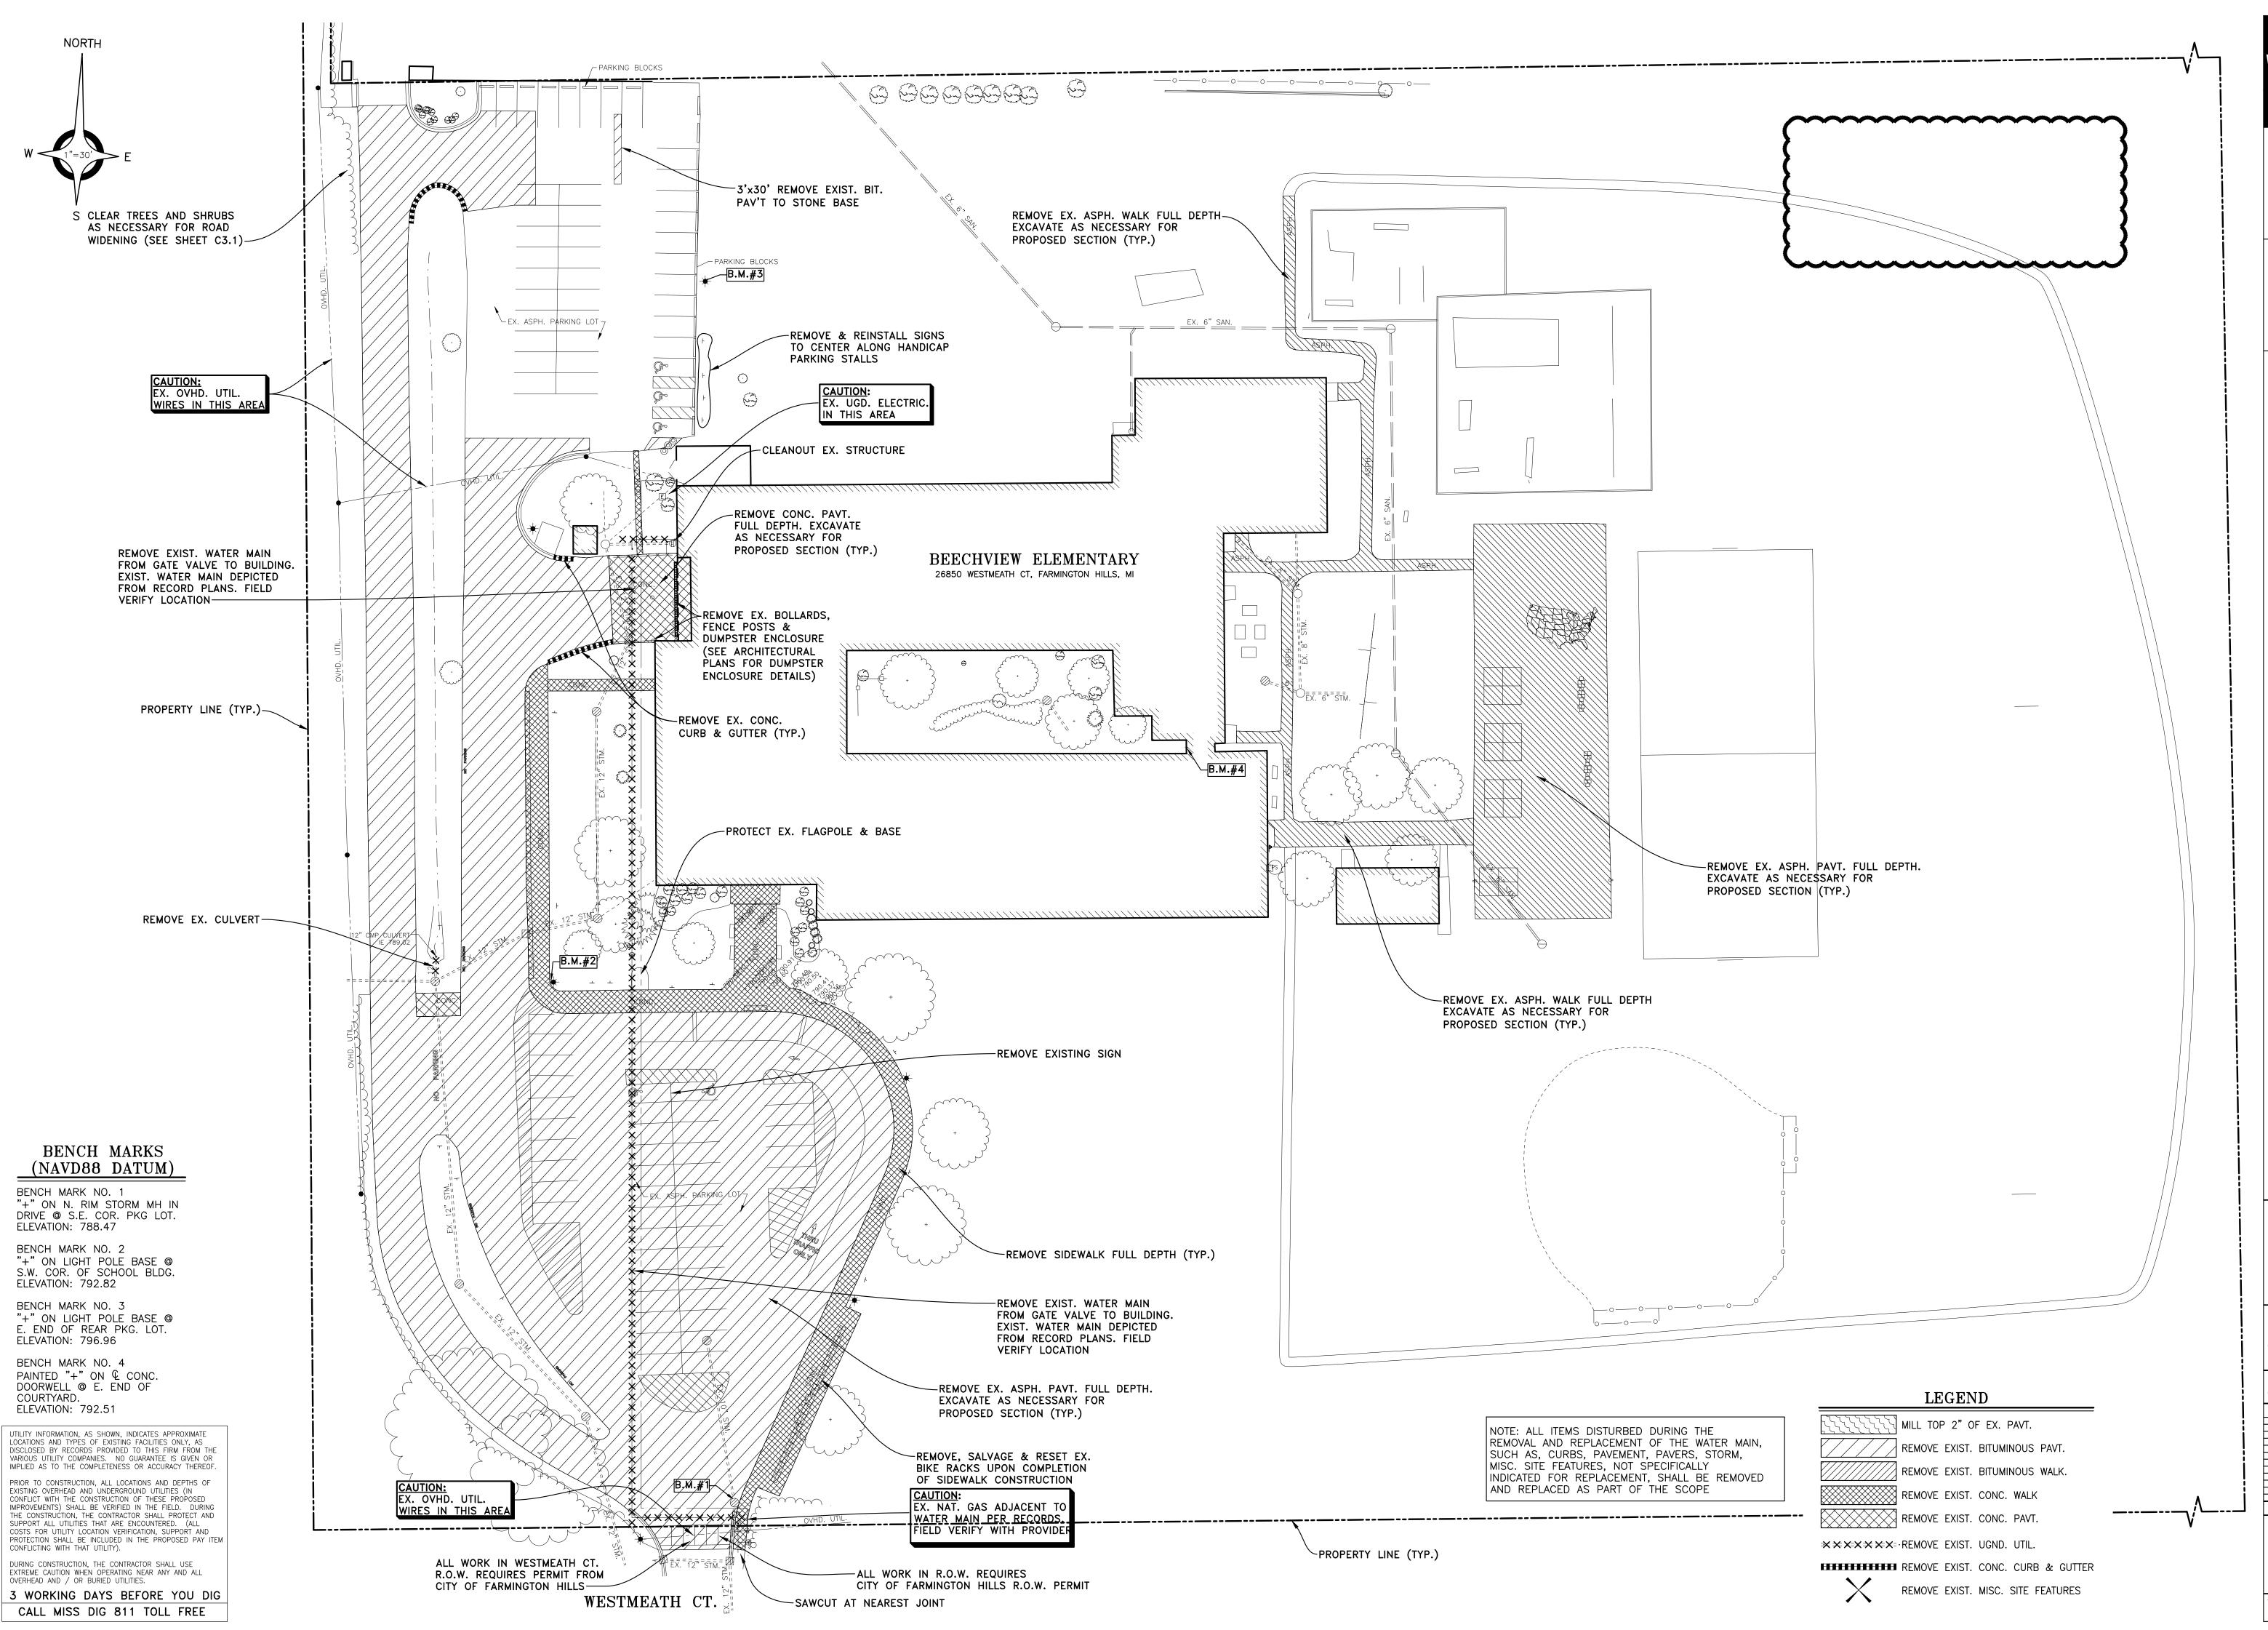

WAKELY ASSOCIATES, INC. ARCHITECTS

30500 VAN DYKE AVENUE SUITE M-7 WARREN, MICHIGAN 48093 PH: 586.573.4100 FX: 586.573.0822

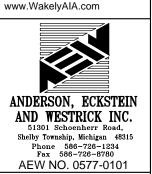

BLI Ü

REMOVAL PLAN

PRELIMINARY DESIGN DEVELOPMENT CONSTRUCTION FINAL RECORD

DRAWN BY KJP

CHECKED BY\_JS\_ REVISIONS

DATE: OCTOBER 25, 2017



WAKELY ASSOCIATES, INC. ARCHITECTS

30500 VAN DYKE AVENUE SUITE M-7 WARREN, MICHIGAN 48093 PH: 586.573.4100 FX: 586.573.0822 www.WakelyAIA.com

EX. STM. C.B.

EX. 4" GAS MAIN (FROM REC.)

NEW 4" BIT. PAV'T ON

Capacity

EXIST. STONE BASE

12" IE 854.05 (NW)



**PUBLI** NO O Ü ARMIN 0

CONSTRUCTION

PLAN

PRELIMINARY

DESIGN DEVELOPMENT CONSTRUCTION FINAL RECORD DRAWN BY KJP CHECKED BY JS

DATE: OCTOBER 25, 2017

4" CONCRETE SIDEWALK 6" HIGH CURB FACED WALK REVISIONS

PROPOSED GRADE FLOW ARROW

PAVING LEGEND

8" CONC. PAVT.

EXIST. GRADE

TOP ASPHALT

TOP CONC. CURB TOP CONC. WALK

TOP CONC. GUTTER

PAVEMENT ELEVATION SEALCOAT LIMITS

BENCH MARK NO. 1 "+" ON N. RIM SAN. MH ON N.E. SIDE BONNET HILL, ±110' N. OF S. DRIVE TO S. PKG. LOT. ELEVATION: 859.50

BENCH MARKS

(NAVD88 DATUM)

BENCH MARK NO. 2 PAINTED" " ON S. LIGHT POLE BASE OF N. MOST POLE IN S. PKG. LOT. ELEVATION: 862.18

BENCH MARK NO. 3 T/HYDRANT ON E. SIDE ARANEL, ±65' S. OF NOTTINGWOOD. ELEVATION: 862.98

BENCH MARK NO. 4 CST NAIL IN S.W. FACE UTIL. POLE, ±30' S. OF BALL FIELD FENCE ON E. PROP. LINE. ELEVATION: 855.80

BENCH MARK NO. 5 CST NAIL IN W. FACE UTIL. POLE NEAR E. PROP. LINE, ±50' S. OF N.E. COR. SCHOOL. ELEVATION: 859.04


BENCH MARK NO. 6 CST NAIL IN W. FACE UTIL POLE ON E. SIDE SCHOOL NEAR DOOR #6. ELEVATION: 860.97

BENCH MARK NO. 7 PAINTED" " ON E. LIGHT POLE BASE OF MIDDLE POLE IN S. PKG. LOT. ELEVATION: 862.87

UTILITY INFORMATION, AS SHOWN, INDICATES APPROXIMATE LOCATIONS AND TYPES OF EXISTING FACILITIES ONLY, AS DISCLOSED BY RECORDS PROVIDED TO THIS FIRM FROM THE VARIOUS UTILITY COMPANIES. NO GUARANTEE IS GIVEN OR IMPLIED AS TO THE COMPLETENESS OR ACCURACY THEREOF. PRIOR TO CONSTRUCTION, ALL LOCATIONS AND DEPTHS OF EXISTING OVERHEAD AND UNDERGROUND UTILITIES (IN CONFLICT WITH THE CONSTRUCTION OF THESE PROPOSED IMPROVEMENTS) SHALL BE VERIFIED IN THE FIELD. DURING THE CONSTRUCTION, THE CONTRACTOR SHALL PROTECT AND SUPPORT ALL UTILITIES THAT ARE ENCOUNTERED. (ALL COSTS FOR UTILITY LOCATION VERIFICATION, SUPPORT AND PROTECTION SHALL BE INCLUDED IN THE PROPOSED PAY ITEM CONFLICTING WITH THAT UTILITY).

DURING CONSTRUCTION, THE CONTRACTOR SHALL USE EXTREME CAUTION WHEN OPERATING NEAR ANY AND ALL OVERHEAD AND / OR BURIED UTILITIES.

3 WORKING DAYS BEFORE YOU DIG CALL MISS DIG 811 TOLL FREE

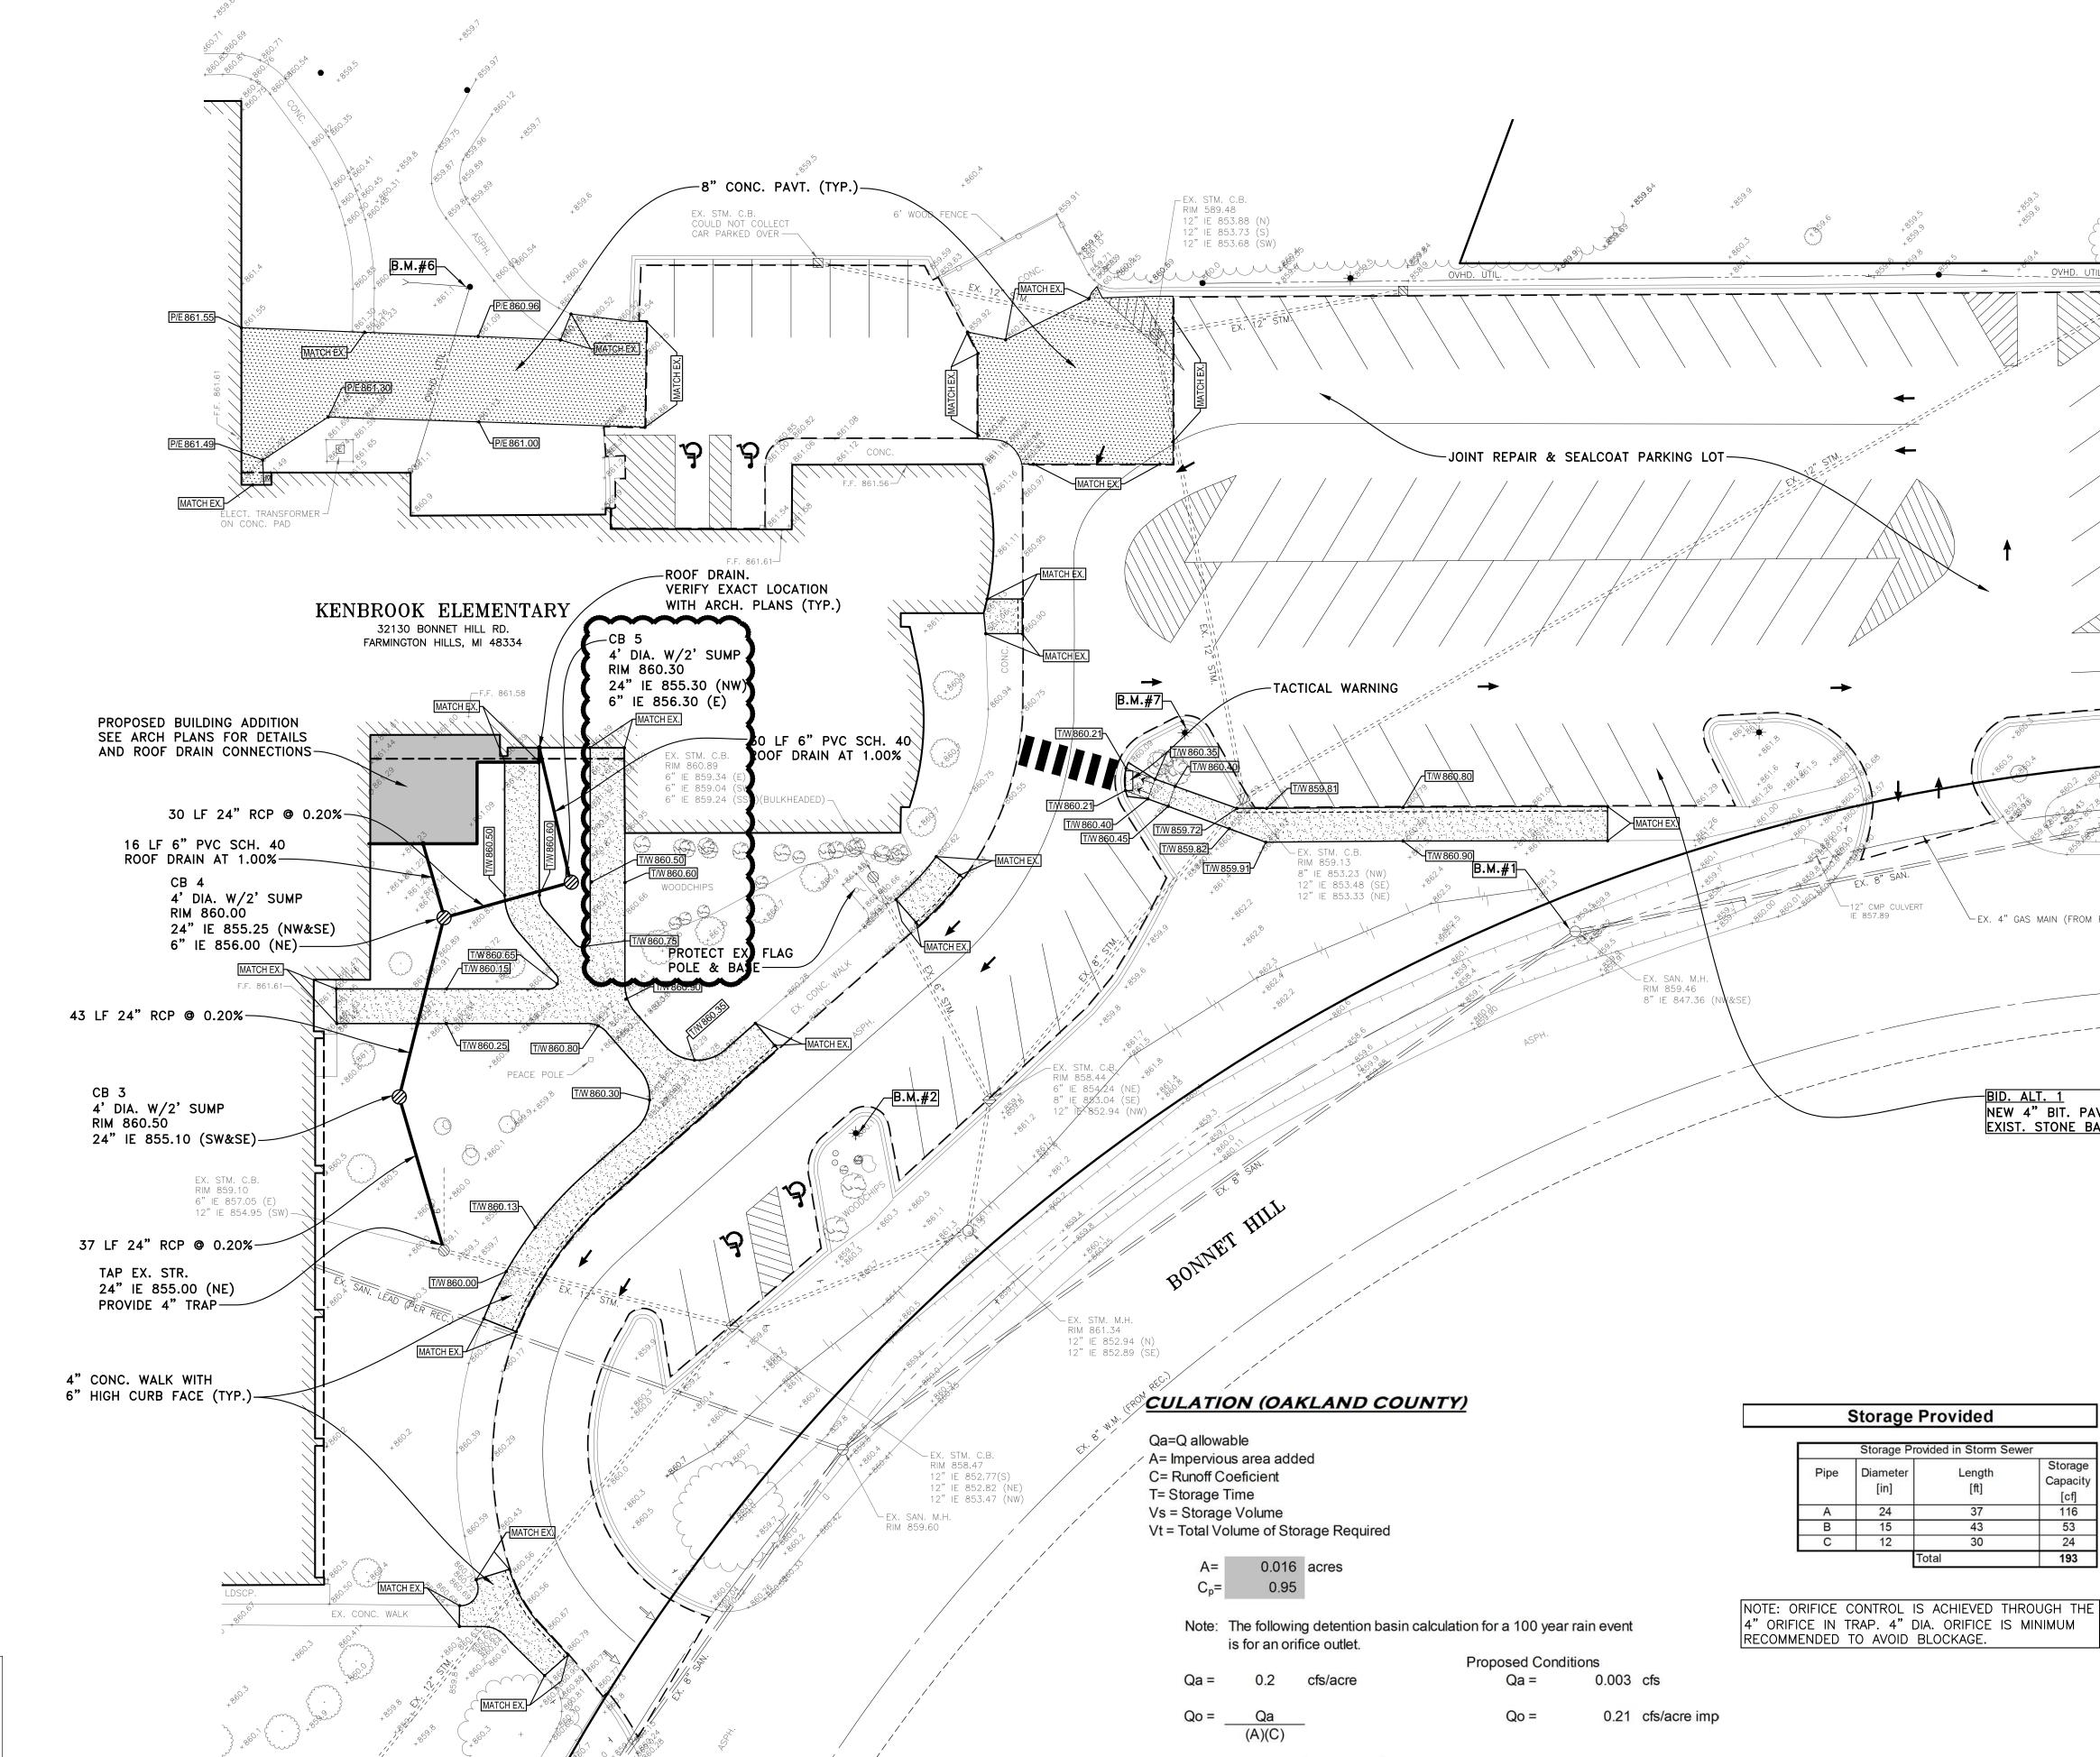

T = -25 +

Vt = (Vs)(A)(C)

Vs = (16500)(T) - (40)(Qo)(T)

(T + 25)

10312.5

Qo

196.32 minutes

12,983 cubic feet


193 cubic feet

Vt =



30500 VAN DYKE AVENUE SUITE M-7 WARREN, MICHIGAN 48093 PH: 586.573.4100

FX: 586.573.0822

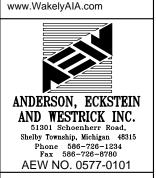

**PUBLIC ARMINGT** 

PAVING & GRADING

PAVING LEGEND

STANDARD DUTY BITUMINOUS PAVT.

HEAVY DUTY BITUMINOUS PAVT.

BITUMINOUS WALK/PLAY PAD

4" CONCRETE SIDEWALK

8" CONC. PAVT.

6" HIGH CURB FACED WALK

PROPOSED GRADE

FLOW ARROW

EXIST. GRADE

TOP ASPHALT

SEALCOAT LIMITS

TOP CONC. CURB

TOP CONC. WALK

TOP CONC. GUTTER


PAVEMENT ELEVATION

MOUNTABLE CONC. CURB & GUTTER

PRELIMINARY DESIGN DEVELOPMENT CONSTRUCTION FINAL RECORD

DRAWN BY KJP CHECKED BY JS REVISIONS

DATE: OCTOBER 25, 2017

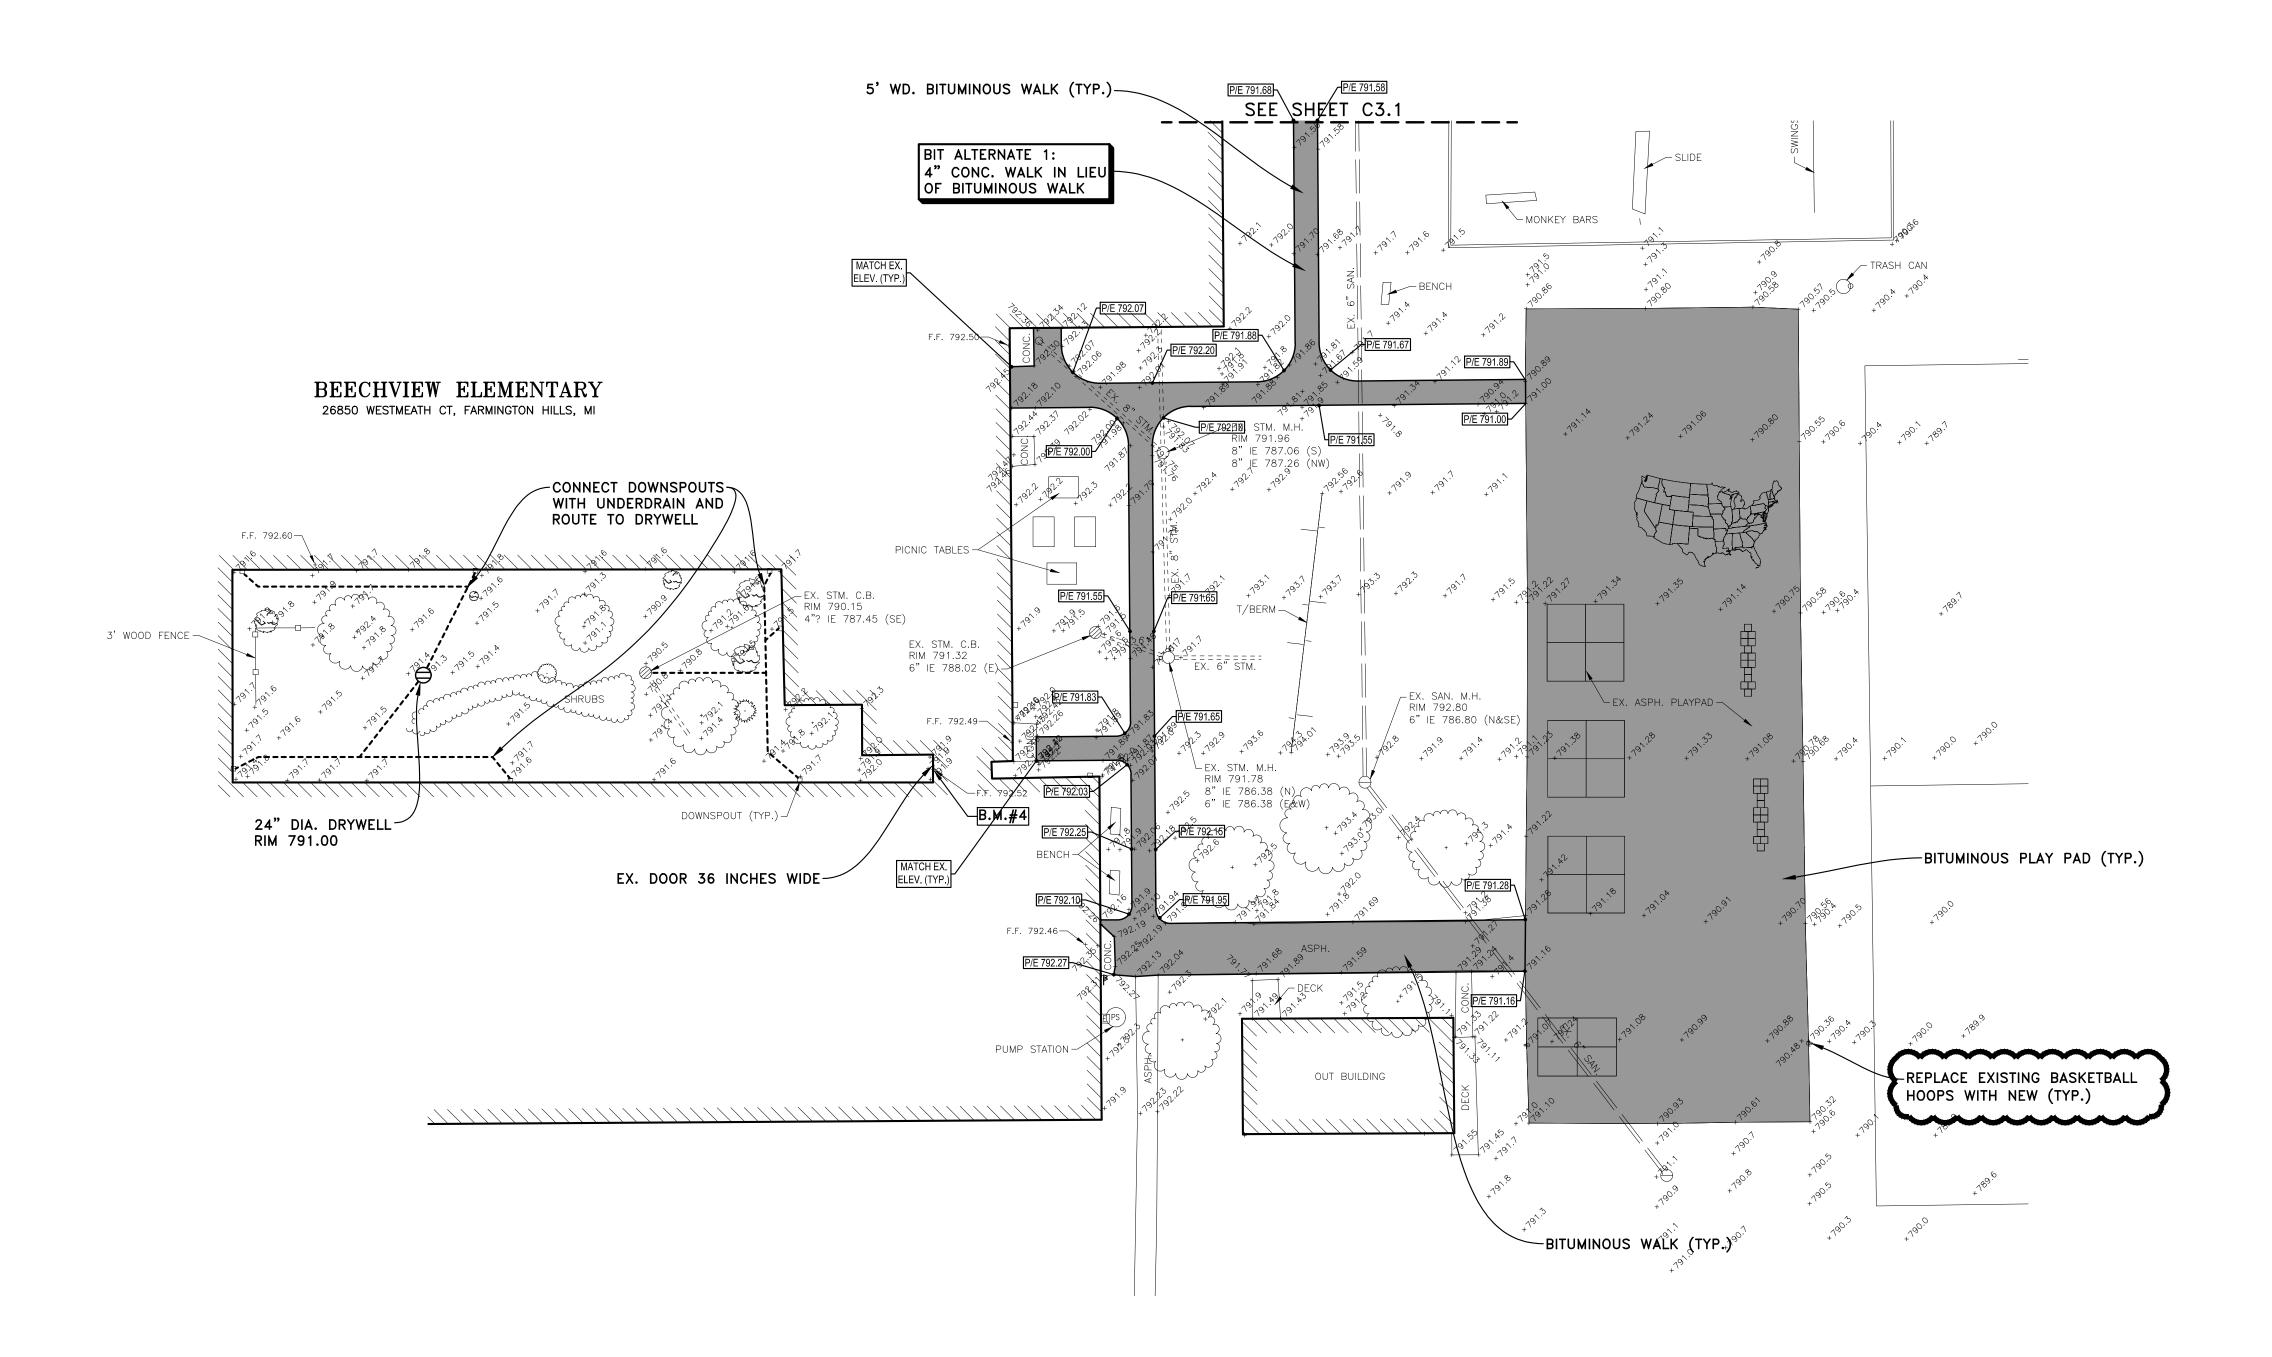

# BENCH MARKS

BENCH MARK NO. 3 "+" ON LIGHT POLE BASE @ E. END OF REAR PKG. LOT.

COURTYARD. ELEVATION: 792.51

UTILITY INFORMATION, AS SHOWN, INDICATES APPROXIMATE LOCATIONS AND TYPES OF EXISTING FACILITIES ONLY, AS DISCLOSED BY RECORDS PROVIDED TO THIS FIRM FROM THE VARIOUS UTILITY COMPANIES. NO GUARANTEE IS GIVEN OR IMPLIED AS TO THE COMPLETENESS OR ACCURACY THEREOF. PRIOR TO CONSTRUCTION, ALL LOCATIONS AND DEPTHS OF EXISTING OVERHEAD AND UNDERGROUND UTILITIES (IN CONFLICT WITH THE CONSTRUCTION OF THESE PROPOSED IMPROVEMENTS) SHALL BE VERIFIED IN THE FIELD. DURING DURING CONSTRUCTION, THE CONTRACTOR SHALL USE

EXTREME CAUTION WHEN OPERATING NEAR ANY AND ALL OVERHEAD AND / OR BURIED UTILITIES. 3 WORKING DAYS BEFORE YOU DIG CALL MISS DIG 811 TOLL FREE


(NAVD88 DATUM)


BENCH MARK NO. 1 "+" ON N. RIM STORM MH IN DRIVE @ S.E. COR. PKG LOT. ELEVATION: 788.47

BENCH MARK NO. 2 "+" ON LIGHT POLE BASE @ S.W. COR. OF SCHOOL BLDG. ELEVATION: 792.82

ELEVATION: 796.96 BENCH MARK NO. 4 PAINTED "+" ON € CONC. DOORWELL @ E. END OF

THE CONSTRUCTION, THE CONTRACTOR SHALL PROTECT AND SUPPORT ALL UTILITIES THAT ARE ENCOUNTERED. (ALL COSTS FOR UTILITY LOCATION VERIFICATION, SUPPORT AND PROTECTION SHALL BE INCLUDED IN THE PROPOSED PAY ITEM CONFLICTING WITH THAT UTILITY).

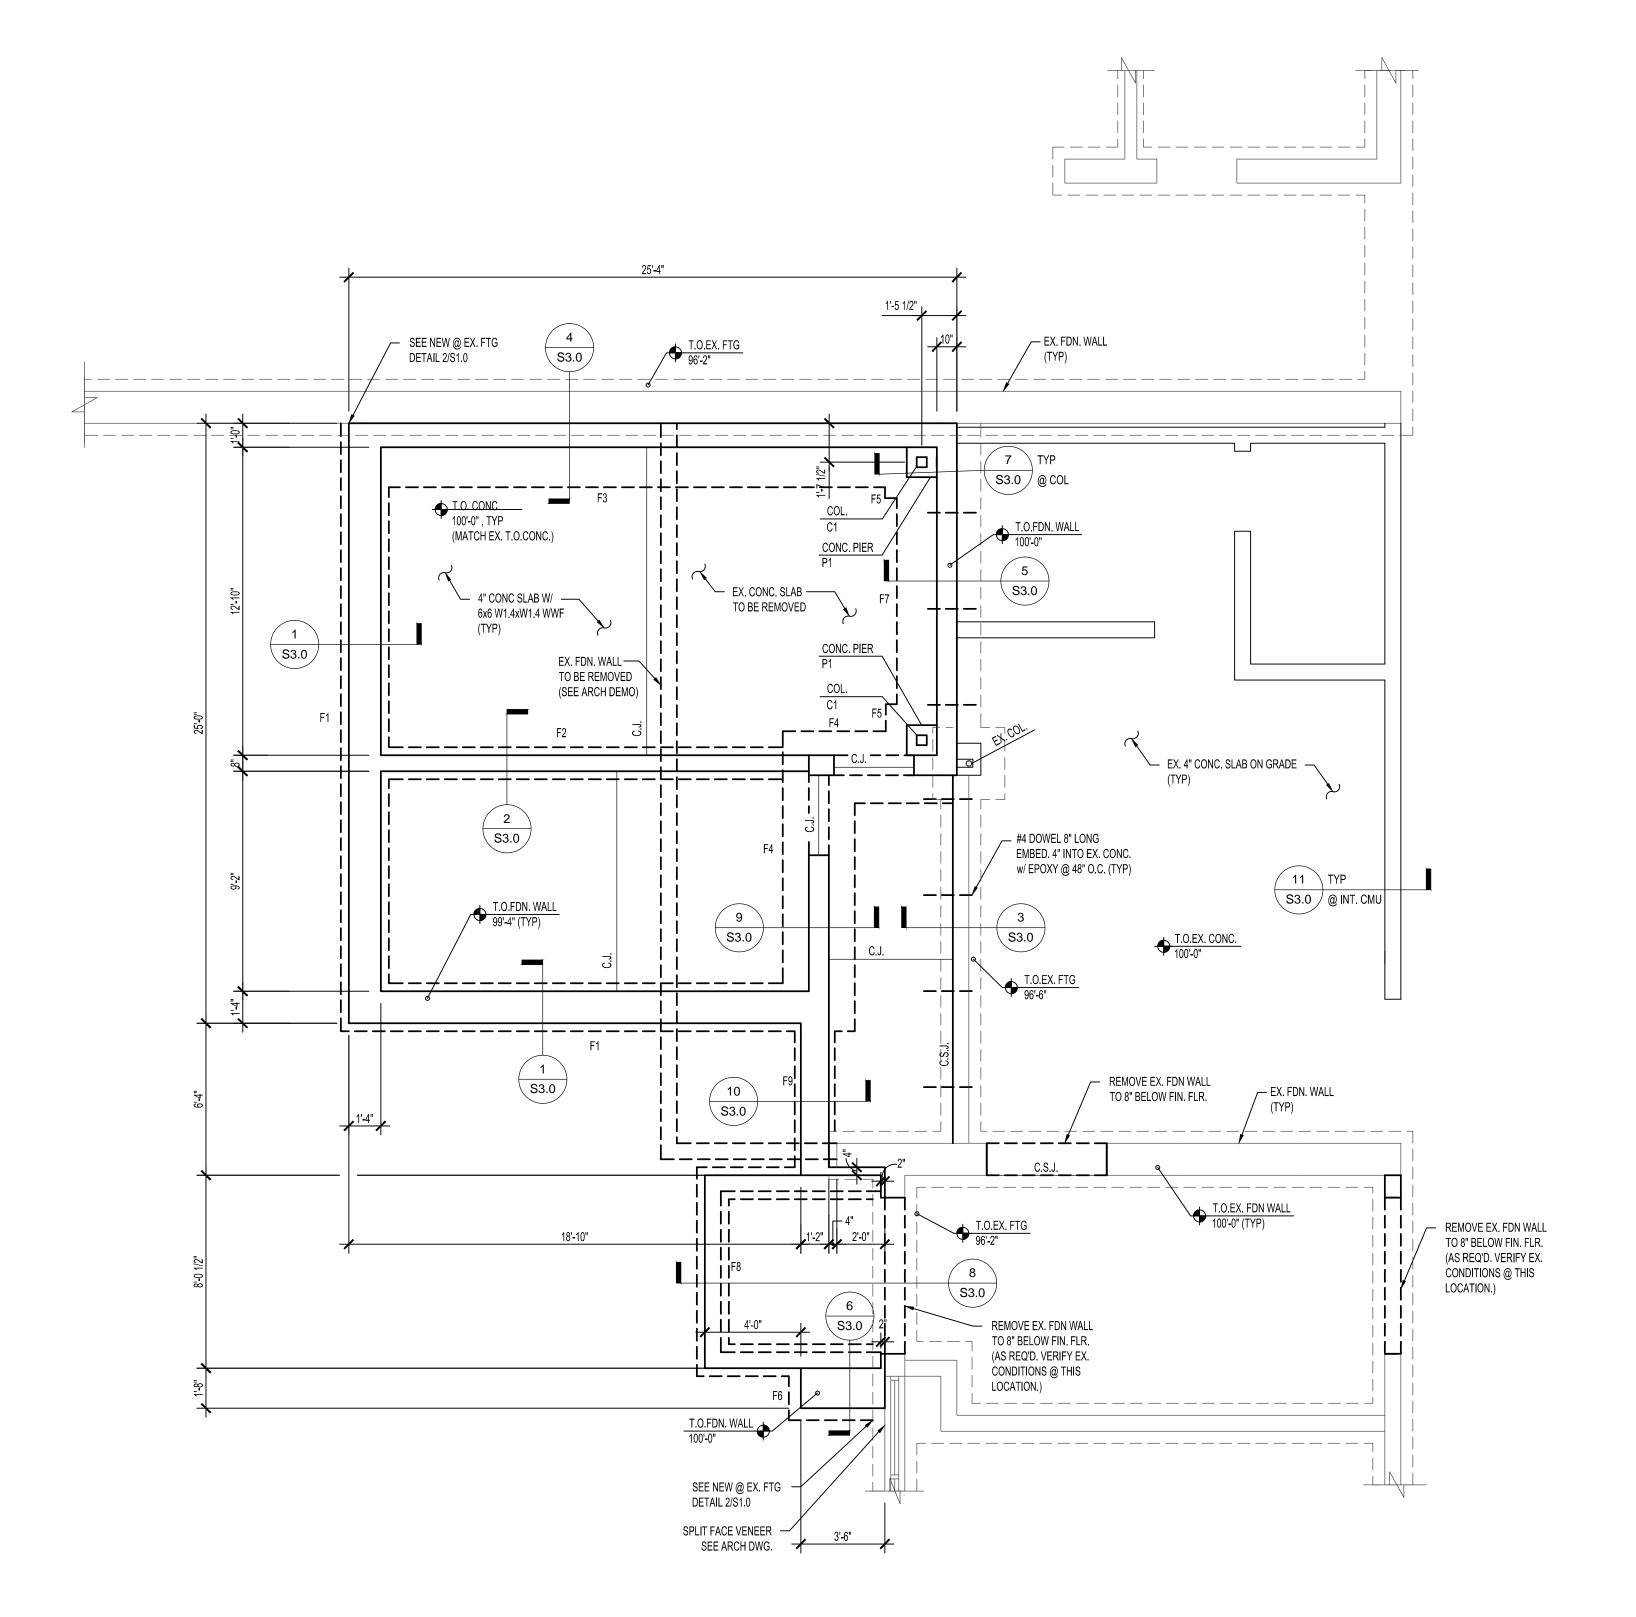


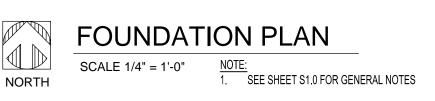

	FOOTING SCHEDULE									
FOOTING MARK	FOOTING SIZE WIDTH x THICKNESS x LENGTH	REINFORCEMENT	TOP OF FTG. ELEV	REMARKS						
F1	2'-0"x1'-0"xCONT.	(2) #5 BARS CONT.	96'-2"±	MATCH EX. T.O.FTG. ELEVATION						
F2	1'-4"x1'-0"xCONT.	(2) #5 BARS CONT.	96'-2"±	MATCH EX. T.O.FTG. ELEVATION						
F3	2'-6"x1'-8"xCONT.	(3) #5 BARS CONT.+ #5's @ 12" O.C.	96'-10"±	OVERPOUR EX. FTG.						
F4	3'-0"x1'-0"xCONT.	(3) #5 BARS CONT.+ #5's @ 12" O.C.	96'-6"±							
F5	3'-0"x1'-8"x3'-0"	(3) #5 BARS EA. WAY	97'-2"±	OVERPOUR EX. FTG.						
F6	2'-6"x1'-0"xCONT.	(3) #5 BARS CONT.	96'-2"±							
F7	2'-6"x1'-8"xCONT.	(3) #5 BARS CONT.+ #5's @ 12" O.C.	97'-2"±	OVERPOUR EX. FTG.						
F8	1'-4"x1'-0"xCONT.	(2) #4 BARS CONT.	96'-2"±	STOOP						
F9	1'-8"x1'-0"xCONT.	(2) #5 BARS CONT.	96'-6"±							

	PIER SCHEDULE										
FOOTING MARK	PIER SIZE WIDTH x LENGTH	REINFORCEMENT	TOP OF PIER. ELEV	REMARKS							
P1	1'-3"x1'-3"	(4) #6 VERT. BARS & #3 TIES @ 12" O.C. (U.N.O)	99'-4"								

	COLUMN SCHEDULE									
MARK	SIZE	BASE PLATE	ANCHORS	CAP PLATE	REMARKS					
C1	HSS5x5x1/4	1/2"x11"x11"	(4) 3/4"Ø A36 ANCHORS EMBEDDED 14" w/ NUT+WASHER	1/2"x11"xBM. FLANGE						

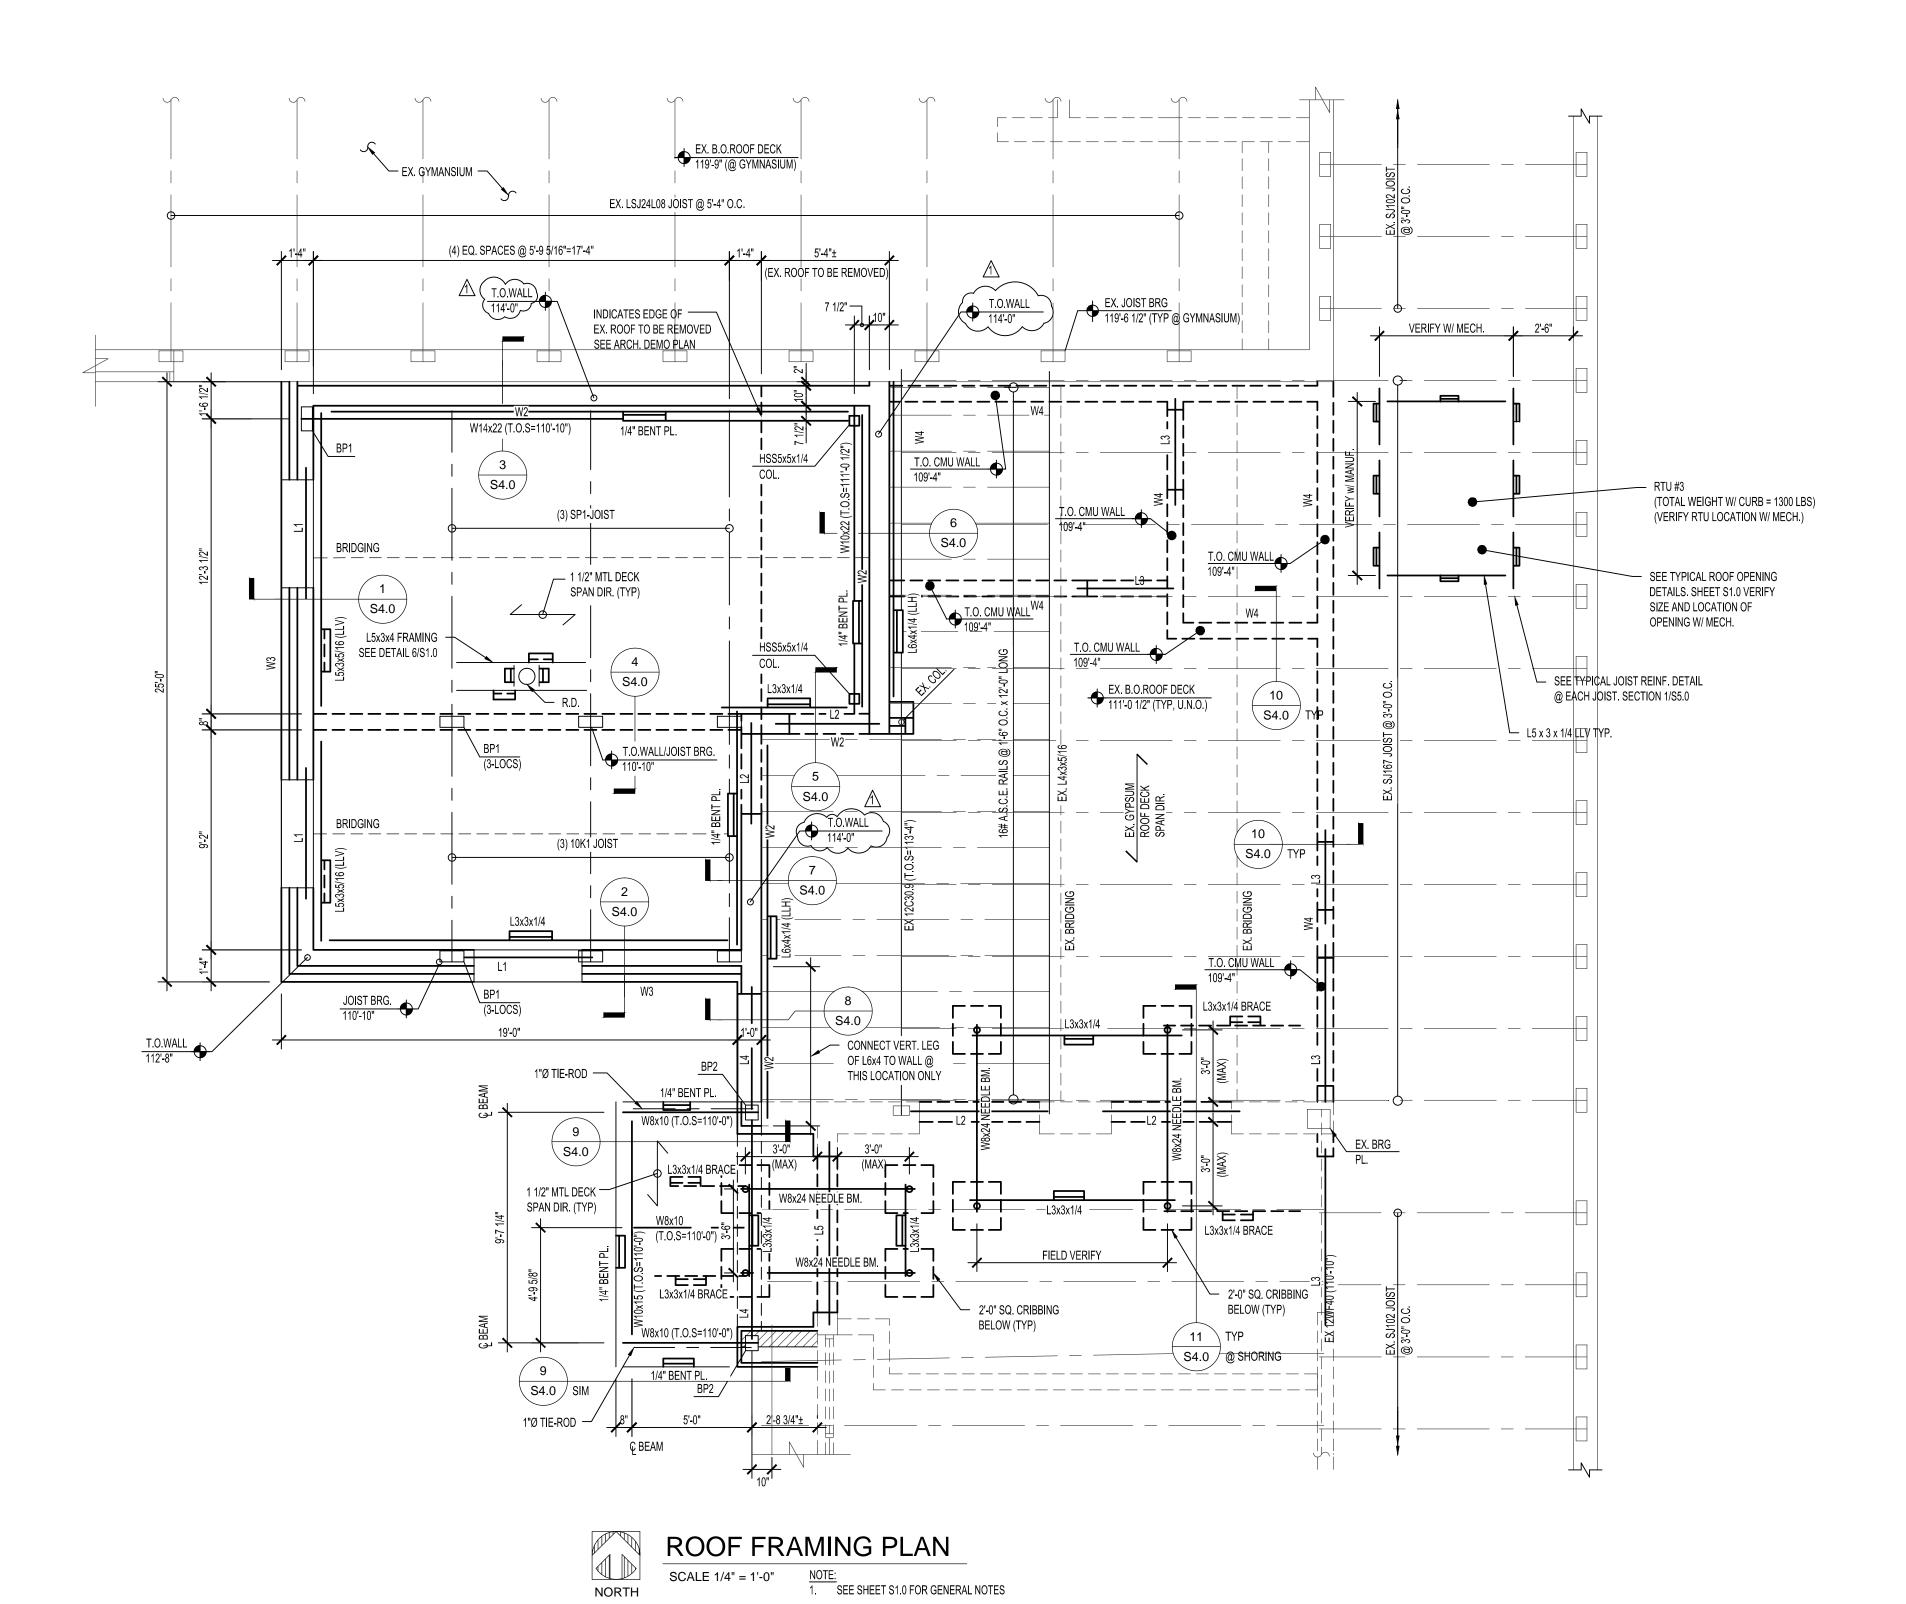

	LINTEL SCHEDULE								
MARK	LINTEL SIZE	PLATE SIZE	REMARKS						
L1	W8x10	3/8" x 1'-3 1/2" x OPENING	GALV. LINTEL @ EXTERIOR						
L2	W8x10	3/8" x 9 1/8" x OPENING	_						
L3	W8x10	3/8" x 7 1/8" x OPENING	_						
L4	W8x18	3/8" x 11 1/8" x OPENING	GALV. LINTEL @ EXTERIOR						
L5	W8x18	3/8" x 11 1/8" x OPENING	GALV. LINTEL @ EXTERIOR						


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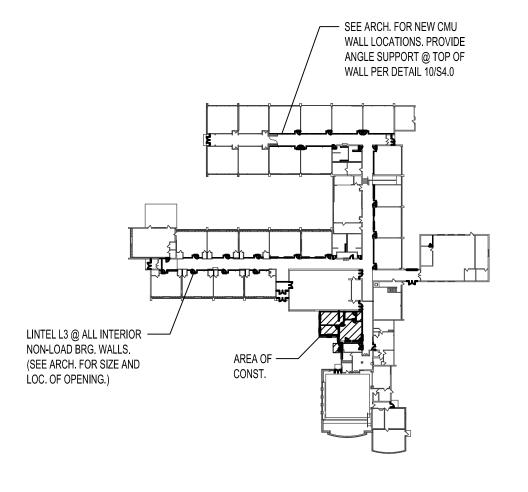
1. PROVIDE 3/8"x5 1/2"x5 1/2" BRG PLATE EACH END. GOUT EX. WALL SOLID @ BEARING AFTER INSTALLATION

2. SHORE OPENING AS REQD (NEEDLE BEAM)
PRIOR TO REMOVING EXISTING WALL FOR
NEW LINTEL

	BEARING PLATE SCHEDULE							
MARK	SIZE	ANCHORS	REMARKS					
BP1	3/8" x 5 1/2" x 12"	(2) 1/2"Ø x 6" LG. HD. STUDS						
BP2	3/8" x 5 1/2" x 6"	(1) 1/2"Ø x 6" LG. HD. STUDS						

MASONRY WALL REINFORCEMENT SCHEDULE									
MARK	WALL SIZE	VERT. REINF.	REMARKS						
W1	10" CMU	#6 BARS @ 16" O.C.	GROUT WALL SOLID EA. CELL FULL HEIGHT						
W2	10" CMU	#6 BARS @ 48" O.C.	GROUT WALL SOLID EA. VERT. BAR						
W3	8" CMU	#5 BARS @ 48" O.C.	GROUT WALL SOLID EA. VERT. BAR						
W4	8" CMU	#5 BARS @ 48" O.C.	GROUT WALL SOLID EA. VERT. BAR						



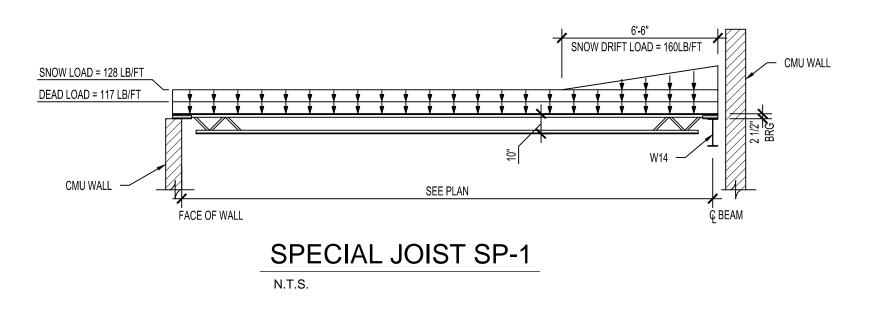






PH: (989) 797-1710 FX: (989) 797-1715

PROJECT NO. 17-828-251

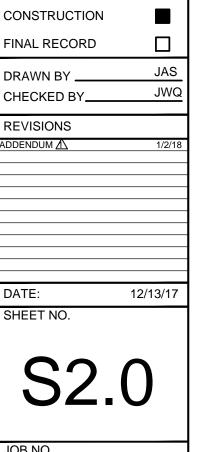

~171712A

Hills,

UBL

KENBI FARMING

PRELIMINARY

DESIGN DEVELOPMENT

WAKELY ASSOCIATES, INC.


30500 VAN DYKE AVENUE

SUITE M-7 WARREN, MICHIGAN 48093

PH: 586.573.4100 FX: 586.573.0822

www.WakelyAIA.com

ARCHITECTS

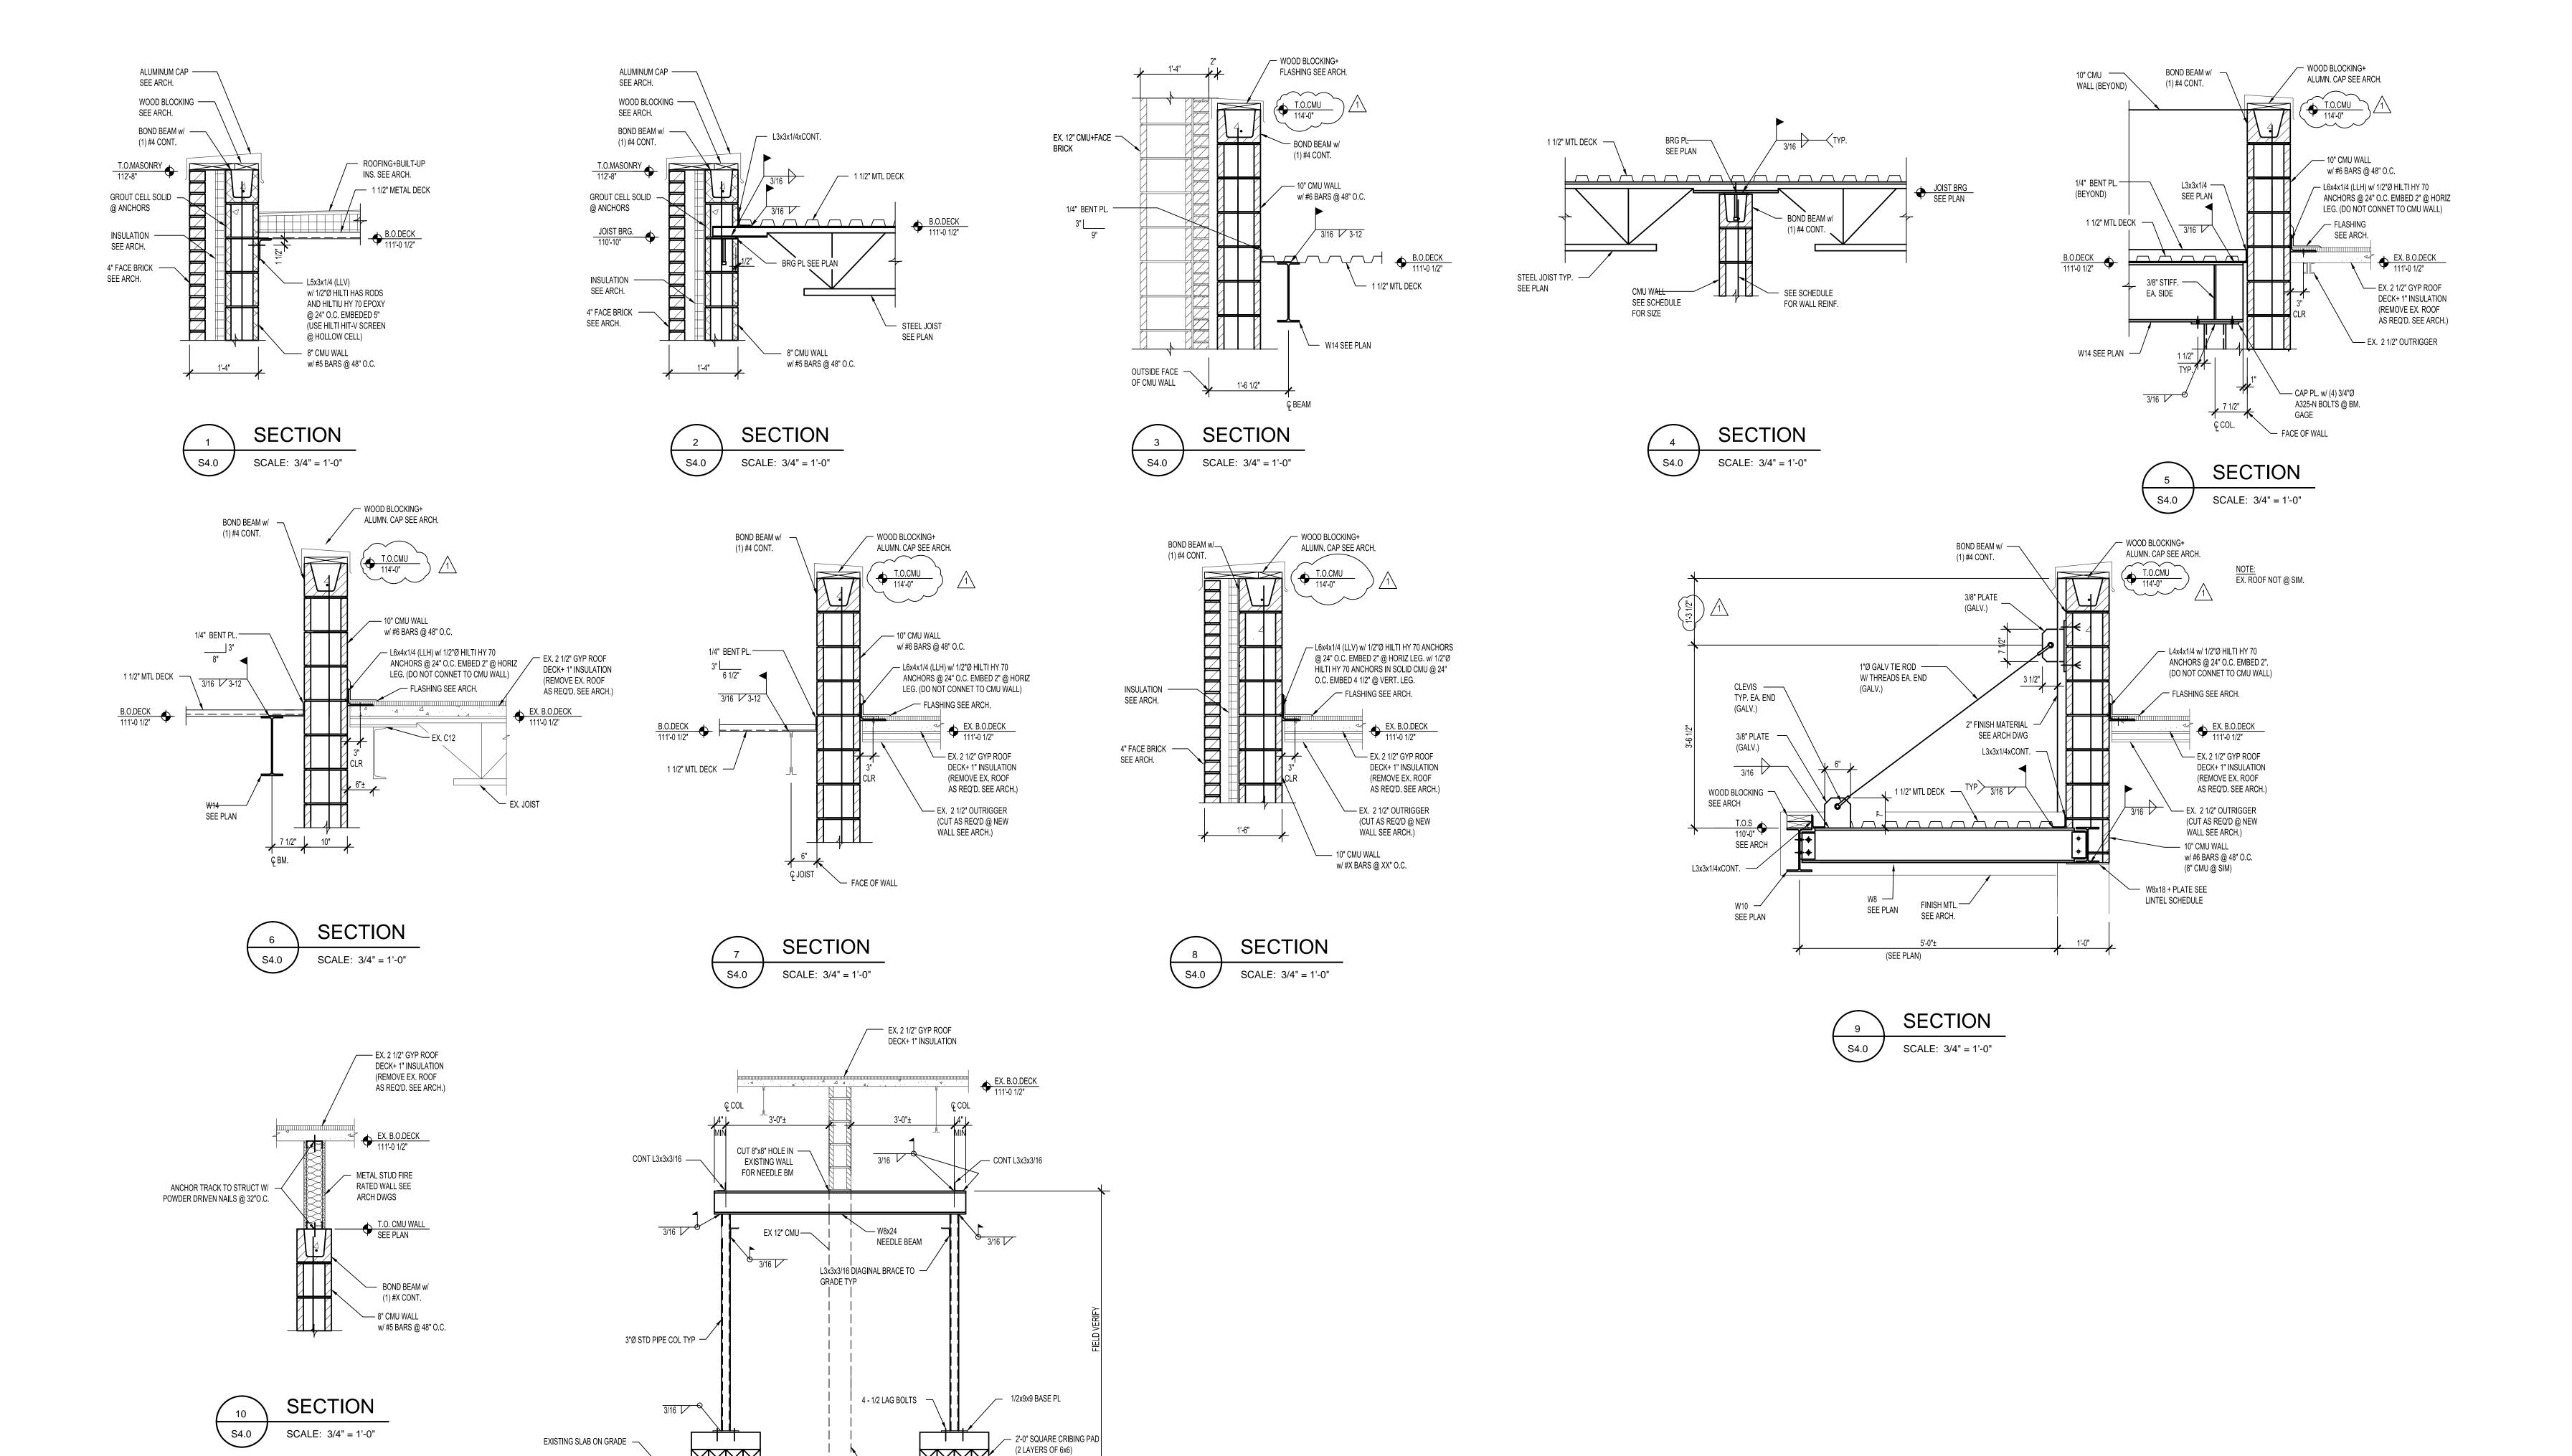

— REMOVE EX. WALL AS REQ'D

REMOVE EXIST 12" CMU TO 99'-4 -POUR NEW SLAB ON GRADE OVER TOP OF EX WALL TYP.



WAKELY ASSOCIATES, INC. ARCHITECTS

30500 VAN DYKE AVENUE SUITE M-7 WARREN, MICHIGAN 48093 PH: 586.573.4100 FX: 586.573.0822 www.WakelyAIA.com

Farmington Hills, MI 48334 KENBROOK
FARMINGTON PUBLI
31130 BONNET HILL RD, F RD,

PRELIMINARY DESIGN DEVELOPMENT CONSTRUCTION FINAL RECORD DRAWN BY \_\_\_\_ CHECKED BY\_ REVISIONS

SNYDER & STALEY ENGINEERING, P.L.C. CONSULTING ENGINEERS 3085 BAY ROAD SUITE 6

> SAGINAW, MI 48603 PH: (989) 797-1710 FX: (989) 797-1715

> > PROJECT NO. 17-828-251

171712A

### REFLECTED CEILING PLAN KEY NOTES:

#### | PLEASE NOTE: | NOT ALL FLOOR PLAN KEYNOTES APPLY TO EACH BUILDING.

- 1 REMOVE AND REINSTALL AND MODIFY EXISTING LAY-IN CEILING SYSTEM AS REQ'D FOR ALL NEW CONSTRUCTION AND OVERHEAD WORK. ADD NEW TILES/GRID ETC. TO CONTINUE EXISTING PATTERN AS REQ'D (VIF)
- 2 NOT USE
- PROVIDE NEW 2X4 ACOUSTIC CEILING AND T GRID SEE FINISH SCHEDULE FOR HT.
- REMOVE/REPLACE EXISTING LAY-IN CEILING TILES. INSTALL NEW LAY-IN TILES. EXISTING GRID TO REMAIN.
- 5 PROVIDE NEW GYPSUM BOARD CEILING ON METAL FRAMING. SEE FINISH SCHEDULE
- NOTES:
  1. NOT ALL WALL TYPES ARE USED ON EACH FLOOR.
  2. EXTEND WALLS UP FULL HEIGHT TO DECK ABOVE (U.N.O.)
- 2. EXTEND WALLS OF FULL HEIGHT TO DECK ABOVE (U.N.O.)
  3. DO NOT FASTEN VERTICAL STUDS TO TOP RUNNER TRACK @
  SECOND FLOOR ASSEMBLIES. USE SLIP TRACK TO ALLOW
  FOR DEFLECTION OF STRUCTURE WITHOUT COMPROMISING
  WALL INTEGRITY.

#### WALL TYPES:

- NOMINAL 5", ACTUAL 4  $\frac{7}{8}$ ":  $\frac{5}{8}$ " HI- IMPACT GYP BD BOTH SIDES OF 3  $\frac{5}{8}$ " 20 GA METAL STUDS AT 1'-4" O.C. MAX W/ SOUND ATTEN BLANKETS IN ALL VOIDS FULL HEIGHT
- B NOMINAL 8", ACTUAL 7 ½":
  4" BRICK ON 4" CMU FULL HEIGHT TO DECK ABOVE.
- NOMINAL 8", ACTUAL 7 %":
- NOMINAL 12", ACTUAL 11 %": 12" CMU
- NOMINAL 8", ACTUAL 7 %":

  8" CMU W/ ACOUSTIC FOAM FILL IN ALL CORES FULL HT. USE
  ACOUSTICAL SEALANT AT ADJACENT WALLS, AND AT ROOF DECK.
  FILL DECK FLUTES W/ SOUND ATTEN BLANKETS SPRAYED IN PLACE.
- $\langle F \rangle$  NOMINAL 2"  $\frac{5}{8}$ " HI-IMPACT GYP. BD. ON 1  $\frac{1}{2}$ " METAL FURRING AT 1'-4" O.C.
- NOMINAL 7",

  5%" HI -IMPACT GYP BOARD ON 3/4" METAL FURRING ON 6"CMU
- NOMINAL 6", 6" CMU
- NOMINAL 7", ACTUAL 7  $\frac{1}{4}$ "  $\frac{5}{8}$ " HI-IMPACT GYP BOARD ON METAL, ON 6" METAL STUDS AT 1'-4"
  O.C. MAX W/ SOUND BLANKETS INSTALLED IN VOIDS FULL HEIGHT
- NOMINAL 4", 4" CMU
- NOMINAL 7", ACTUAL 7 \( \frac{1}{4} \)"

  \[ \frac{5}{8} \]" HI-IMPACT GYP BOARD ON METAL, ON 6" METAL STUDS AT 1'-4" O.C.

  MAX W/ SOUND BLANKETS INSTALLED IN VOIDS FULL HEIGHT; 48" HIGH

  WITH 2" STAINED SOLID OAK TOP AND OAK TRIM ON ALL SIDES.
- M NOMINAL 10", ACTUAL 9 5/8"

### FIRE RATED WALL TYPES:

# NOTE: EXTEND WALLS UP FULL HEIGHT TO DECK ABOVE. FILL ALL VOIDS AT DECK FLUTES WITH FIRE SAFING MATERIAL AND APPROVED FIRE SPRAY SEALANTSON BOTH SIDES AS SPECIFIED.

- $\frac{\text{1 HOUR RATING (UL-U438)}}{\text{NOMINAL 5", ACTUAL 4 }\frac{7}{8}"} : \\ \frac{5}{8}" \text{ TYPE 'X' FIRE RATED GYP BD BOTH SIDES OF 3 }\frac{5}{8}" \text{ 20 GA METAL STUDS AT 1'-4" OC MAX W/ SOUND ATTEN BLANKETS IN ALL VOIDS FULL HEIGHT.}$
- 1 HOUR RATING
  NOMINAL 7", ACTUAL 7 1/4":

  1 TYPE 'X' FIRE RATED GYP BD BOTH SIDES OF 6", 20 GA METAL STUDS AT 1'-4" OC MAX W/ SOUND ATTEN BLANKETS IN ALL VOIDS FULL HEIGHT.
- 1 HOUR RATING (UL-xxx)

  NOMINAL 8", ACTUAL 7 5%":

  NEW 8" CMU TO DECK ABOVE
- 2 HOUR RATING FIRE WALL (UL-xxx)

  NOMINAL 12", ACTUAL 11 %":

  NEW 12" CMU TO DECK ABOVE
- 1 HOUR RATING FIRE WALL (UL-xxx)
  NOMINAL 12"
  4"BRICK ON 8" CMU UP TO DECK ABOVE
- PARTING FIRE WALL (UL-xxx)

  NOMINAL 8" CMU, ACTUAL 7 8":

  NEW 8" CMU TO DECK ABOVE.
- 2 HOUR RATING FIRE WALL (UL-xxx)

  NOMINAL 10" CMU, ACTUAL 9 \frac{5}{8}":
- NEW 10" CMU TO DECK ABOVE.

  1 HOUR RATING FIRE WALL (UL-xxx)

  NOMINAL 6" CMU, ACTUAL 5 %":

  NEW 6" CMU TO HEIGHT AS NOTED ON DRAWINGS.

#### NEW WORK PLAN KEYNOTES: (CONTINUED)

### PLEASE NOTE: NOT ALL FLOOR PLAN KEYNOTES APPLY TO EACH BUILDING.

- PROVIDE NEW CMU (MATCH WIDTH OF EXISTING) ON TOP OF EXIST. SCREENWALL UP TO 4" ABOVE FIN. CLG HT. MIN. (V.I.F.)
- PROVIDE NEW RUBBER FLOORING ON INCLINE OF RAMP SURFACE PER
- LOCATION OF AIPHONE UNIT AND ADA PUSH BUTTON AND CARD ACCESS PAD
- (51) NEW MASONRY/METAL PANEL COLUMN.
- (52) NEW 4" CONCRETE SLAB ON 4"COMPACTED FILL MIN.
- FILL VOID WITH TOP SOIL & SEED AND SLOPE TO DRAIN AWAY FROM
- (54) TOOTH IN SOLID BULLNOSED CMU AT JAMBS TO MATCH COURSING
- (55) 36" HORIZONTAL GRAB BAR
- (56) 42" HORIZONTAL GRAB BAR
- (57) 18" VERTICAL GRAB BAR
- TOOTH IN NEW CMU AT REMOVE WALL TO MATCH COURSING AND THICKNESS. (V.I.F.)
- PROVIDE AND INSTALL NEW P.LAM TOP TO MATCH SIZE AND SHAPE OF EXISTING. INSTALL NEW SINK (SEE MECH)
- PROVIDE NEW DROP DOWN PROJECTION SCREEN AND CEILING MOUNTED PROJECTOR.
- 61) INFILL MASONRY OPENING LEFT BY REMOVED MECHANICAL UNIT. PROVIDE FOR 15 SF OF MASONRY TO MATCH ADJACENT WALL CONSTRUCTION. TOOTH-IN TO MATCH WIDTH AND COURSING. SEE MECHANICAL.
- REMOVE AND INSTALL EXISTING HANDRAIL AS REQUIRED TO COMPLETE NEW WORK.
- (63) INFILL MASONRY OPENING LEFT BY REMOVED MECHANICAL UNIT. PROVIDE FOR 8 SF OF MASONRY TO MATCH ADJACENT WALL CONSTRUCTION. TOOTH-IN TO MATCH WIDTH AND COURSING. SEE MECHANICAL.

#### ELEMENTARY SCHOOL - NEW WORK PLAN KEYNOTES:

### PLEASE NOTE: NOT ALL FLOOR PLAN KEYNOTES APPLY TO EACH BUILDING.

- INSTALL NEW DOOR AND HARDWARE PER SCHEDULE
- INSTALL NEW ALLIMINIUM FRAME REP DOOR SCHEDUL
- 2 INSTALL NEW ALUMINUM FRAME PER DOOR SCHEDULE
- 3 INSTALL NEW H.M. FRAME PER DOOR SCHEDULE
- AT NEW DOOR OR WINDOW OPENING PROVIDE MASONRY PRECAST LINTEL ABOVE DOOR BEARING 8" MIN ON 3 COURSES GROUTED SOLID EACH SIDE. (TOOTH IN NEW CMU TO MATCH EXISTING MASONRY COURSING @ JAMBS FULL HEIGHT.) PROVIDE GALV. STEEL ANGLE LINTEL TO CARRY BRICK VENEER IF APPLICABLE SIZE TBD IN FIELD. PROVIDE FLASHING AND WEEPS AT EXTERIOR WALLS.
- CONSTRUCT NEW MASONRY CHILLER SCREEN WALL. MATCH HEIGHT, WIDTH AND COURSING TO ADJACENT EXISTING WALL. SEE DETAIL X/AX.XBV
- PAINT ALL WALLS IN ROOM FULL HEIGHT. SEE FINISH SCHEDULE FOR MORE INFO.
- PATCH WALLS FLUSH & PREP FOR PAINT. PROVIDE NEW MTL LOCKERS ON NEW 4" CONCRETE BASE W/ WOOD NAILER PAINT EXISTING 3'-6"x3'-0" (VIF) WOOD WALL CABINET TO MATCH
- REST OF ROOM. PROVIDE ALTERNATE \_\_TO REPLACE WITH LAMINATE PER DETAIL \_\_\_\_
- INSTALL NEW PCT WALL TILE WAINSCOT IN ENTIRE ROOM. SEE SECTION DETAIL. NEW TILE MUST COVER REMOVED OLD TILE LOCATIONS. (V.I.F.)
- §" HI-IMPACT GYP BOARD ON 1 \( \frac{1}{2}\)" METAL HAT CHANNEL AT 24" O.C. ON EXISTING EXPOSED TECTUM PANELS TIGHT TO CEILING. SEE DETAIL 4/A1.1BV.
- PAINT ALL WALLS IN ROOM 10'-0" HIGH. SEE FINISH SCHEDULE AND ELEVATION FOR MORE INFO.
- (12) INSTALL NEW WALL MTD. ROOM SIGNAGE IN CORRIDOR PER DETAILS
- PROVIDE NEW RUBBER STAIR TREAD AND NOSING ON ALL STEPS
- INSTALL NEW DRINKING FOUNTAIN PER MECH. DWGS. MINIMUM 1
  BOTTLE FILLER PER FLOOR.
- PROVIDE NEW TOILET AND URINALS. PROVIDE NEW SINKS AS INDICATED. (SEE MECHANICAL)
- PROVIDE NEW TOILET PARTITIONS. REFER TO SPEC.
- PROVIDE NEW TOILET ACCESSORIES. REFER TO SPEC.
- LOCATION OF NEW SOUND SYSTEM RACK.
- PAINT CMU WALLS ABOVE CERAMIC TILE WAINSCOT UP TO CEILING.
- NEW ACOUSTIC CEILING PADS IN EXISTING GRID
- PROVIDE AND INSTALL NEW LVT. SEE FINISH SCHEDULE.
- PROVIDE AND INSTALL NEW CPT. SEE FINISH SCHEDULE.
- PROVIDE AND INSTALL NEW PCT FLOOR. REFER TO SPECS.
- NEW FURNITURE (BY OTHERS).
- PROVIDE AND INSTALL NEW P. LAM. CASEWORK PER ELEVATION.
- REMOVE ELEVATED FLOOR AND RELOCATE ALL UTILITIES TO WALL FOR WALL MOUNTED FIXTURES. PROVIDE NEW CONCRETE SLAB TO MATCH HEIGHT AND SLOPE OF ADJACENT FLOOR.
- PROVIDE NEW WHITEBOARD, TACK BOARD AND SMART BOARD LAYOUT AS DETAIL ON SHEET A8.3
- INSTALL NEW WINDOW SYSTEM TO FIT EXISTING M.O. (V.I.F.)

# NEW CONCRETE SLAB FOR NEW CHILLER AND GENERATOR VERIFY (29) DIMENSIONS WITH MECHANICAL

- INSTALL NEW CEILING COMPLETE. CONNECT TO TO STRUCTURE AS REQUIRED. SEE FINISH SCHEDULE.
- SAND/ PREP/ PAINT EXISTING METAL SIDING. REFER TO SPECS.
- PROVIDE NEW WALL CONSTRUCTION SEE DETAILS
- INFILL DOOR OPENING WITH CMU TO MATCH THICKNESS AND TOOTH
  IN TO MATCH COURSING AT JAMBS. TOOTH IN NEW BRICK VENEER AT

CORRIDOR WALLS TO MATCH EXISTING IF APPLICABLE.

- NEW 4" CONC. FLOOR W/6x6, W1.4x1.4 W.W.F. ON VAPOR BARRIER ON 8" MIN. COMP. FILL. MATCH ELEVATION OF ADJACENT FLOOR.
- PAINT EXPOSED CEILING.PROVIDE FOR UP TO 3 ACCENT COLORS. PAINT ALL EXPOSED NEW AND EXISTING DUCTS, JOISTS, ETC.
- SAND/ PREP/ COAT EXISTING PANELS IN STOREFRONT SYSTEM. SEE SPEC.
- NEW CUSTOM ROUND WINDOW ALUM. FRAME W/1" INSUL. GLASS,.

  SEE ELEVATIONS.
- NEW OFFICE FURNITURE (BY OTHERS)
- install walk-off carpet in entire room or to the transition shown on dwgs
- (40) INSTALL NEW TACKBOARD
- INSTALL NEW TACKBOARD AS ALTERNATE BID
- PAINT GYP. BD. WALL FULL HEIGHT WITH MARKER BOARD PAINT.
- TECHNOLOGY CABINET ON WALL
- NEW WINDOW TREATMENTS ON ALL WINDOWS IN ROOM.
- PAINT EXISTING WOOD CABINETS (EXTERIOR SURFACE ONLY.) TYPICAL FOR ALL CLASSROOMS.
- REINSTALL P. LAM. CABINETS W/ NEW COUNTER TOPS (SEE 46) ELEVATIONS. PROVIDE NEW CASEWORK WHERE INDICATED.)

# NEW P.LAM. WARDROBE CABINET SEE ELEVATIONS.

#### DEMO PLAN NOTES: (CONTINUED)

# PLEASE NOTE: NOT ALL DEMO PLAN KEYNOTES APPLY TO EACH BUILDING.

REMOVE EXISTING P. LAM. CABINETS AND SALVAGE FOR RE-INSTALLATION IN EXACT SAME LOCATION ON NEW WALL. SEE ELEVATIONS AND DETAILS.

EXISTING P. LAM. CABINETS TO REMAIN.

REMOVE ALL EXISTING WOOD SHELVING COMPLETE IN ROOM. PATCH WALLS FLUSH TO MATCH EXISTING FINISHES.

REMOVE CONCRETE SUPPORTED SLAB CONSTRUCTION COMPLETE INCLUDING FOUNDATION FULL DEPTH. FILL HOLE WITH COMPACTED FILL.

REMOVE P.LAM. CABINETS & COUNTER TOP

√57\ REMOVE FASCIA BRICK.

REMOVE NON-LOAD BEARING WALL CONSTRUCTION ABOVE EXISTING GLASS/FRAMING TO BE REMOVED (V.I.F.)


DOCUMENT EXISTING SIZE OF COUNTERTOP FOR NEW FABRICATION. REMOVE PLAM COUNTER TOP AND SPLASH. REMOVE EXISTING SINK.

REMOVE MECHANICAL EQUIPMENT. PREP OPENING FOR MASONRY INFILL. (SEE MECH.)

### ELEMENTARY SCHOOL - DEMO PLAN NOTES:

PLEASE NOTE:
NOT ALL DEMO PLAN KEYNOTES APPLY TO EACH BUILDING.

1 REMOVE EXISTING DOOR AND HARDWARE COMPLETE. IF SALVAGE EXISTING ADA OPERATOR AND RETURN TO OWNER IF APPLICABLE.

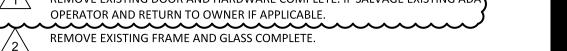

REMOVE EXISTING TILE OR PAINTED MURAL ON WOOD SUBSTRATE . RELOCATE BASED ON OWNER DIRECTION

REMOVE PORTION OF EXISTING WALL FOR NEW DOOR, DUCT OR WINDOW

OPENING PATCH FLOOR LEVEL. PROVIDE LINTEL FOR OPENING. PER DETAILS.

REMOVE EXISTING WALL COMPLETE. (SHOWN DASHED) INCLUDING ALL DOORS, GLAZING, COAT HOOKS, ETC. AS INDICATED BY DRAWINGS. GRIND FLOOR SMOOTH FOR NEW FLOORING OR CONSTRUCTION AS INDICATED IN NEW WORK PLAN. PATCH ADJACENT WALLS TO MATCH EXISTING FINISHES (V.I.F.)

REMOVE WALLPAPER AND SKIM COAT AND SAND ALL WALLS. PREP FOR NEW PAINT AS REQ'D

REMOVE EXISTING COAT HOOKS. PATCH WALL FLUCH AND PAINT TO MATCH EXISTING COLOR.

REMOVE EXISTING WALL TILE COMPLETE. PREP FOR NEW FINISH AS REQUIRED AND INDICATED ON NEW WORK PLAN.

BRACKETS ETC. COMPLETE. PATCH HOLES IN WALLS AND FLOOR AS REQUIRED TO MATCH EXISTING FINISHES. INFILL MASONRY OPENINGS WITH BRICK/ CMU TO MATCH COURSING (V.I.F.)

REMOVE EXISTING CORRIDOR SECURITY GATE AND WALL MOUNTED RACK, CASE

REMOVE ALL EXISTING WALL MOUNTED SIGNAGE PATCH WALLS FLUSH TO

REMOVE EXISTING MASONRY SCREEN WALL & 48"D CONCRETE FOOTINGS , FULL DEPTH AS SHOWN DASHED. FILL HOLE WITH COMPACTED FILL FULL DEPTH

REMOVE EXISTING DOOR, FRAME AND HARDWARE COMPLETE

REMOVE EXISTING PORCELAIN DRINKING FOUNTAIN. PATCH SURFACES TO

MATCH EXISTING SURFACES AND PREP FOR NEW SIGNAGE.

REMOVE ALL WALL MOUNTED TOILET ACCESSORIES AND TOILET PARTITIONS IN ROOM. PATCH ALL HOLES IN WALLS AND FLOORS. FLUSH TO MATCH EXISTING

MATCH AND PREP FOR INSTALLATION OF NEW DRINKING FOUNTAIN.

REMOVE ALL PLUMBING FIXTURES. SEE MECH. DRAWINGS.

DRAWINGS AND SCHEDULES.

REMOVE EXISTING CONCRETE FLOOR SLAB COMPLETE (4 - 6" THICK MIN). AS INDICATED ON PLANS.

REMOVE EXISTING OVERHANG CONSTRUCTION COMPLETE

REMOVE EXISTING CARPET, TRANSITION STRIP, RESIL BASE, ETC. SCRAPE ALL

MASTICE & ADHESIVES FROM CONCRETE FLOOR AS REQUIRED (DO NOT USE

CHEMICAL REMOVAL TECHNIQUES). FILL AND LEVEL ALL VIODS, CRACKS, ETC TO

PREP FLOOR FOR NEW FLOOR FINISHES AND BASE AS REQ'D AND INDICATED ON

REMOVE EXISTING VCT, TRANSITION STRIPS, RESIL BASE, ETC. SCRAPE ALL MASTICE & ADHESIVES FROM CONCRETE FLOOR AS REQUIRED. (DO NOT USE CHEMICAL REMOVAL TECHNIQUES). FILL AND LEVEL ALL VOIDS, CRACKS, ETC. FULL DEPTH (+/-46") TO PREP FLOOR FOR NEW FLOOR FINISHES AND BASE AS REQ'D AND INDICATED ON DRAWINGS AND SCHEDULES.

REMOVE EXISTING CHILLER AND SLAB FOUNDATION COMPLETE. PREP SITE FOR NEW CONCRETE SLAB AND FOUNDATION.

REMOVE EXISTING PCT, TRANSITIONS, PVT BASE, ETC. SCRAPE ALL MORTER BEDS FROM CONCRETE FLOOR AS REQUIRED. (DO NOT USE CHEMICAL REMOVAL TECHNIQUES). FILL AND LEVEL ALL VOIDS, CRACKS, ETC. TO PREP FLOOR FOR NEW FLOOR FINISHES AND BASE AS REQ'D AND INDICATED ON DRAWINGS AND SCHEDULES.

REMOVE EXISTING P. LAM. CASEWORK AND/OR FURNITURE COMPLETE. PATCH WALLS AND FLOORS AS REQ'D TO MATCH ADJACENT FINISHES.

REMOVE EXISTING 12" LOCKS AND TRIM. PREP TO RECEIVE NEW LOCKER.

25\ LINTEL. SEE MECH. FOR SIZE.

REMOVE EXISTING MARKER/CHALK BOARDS. SCRAPE GLUE PODS FROM WALLS.

REMOVE EXISTING TACK BOARDS. SCRAPE GLUE PODS FROM WALLS.

REMOVE PORTION OF EXISTING WALL FOR NEW DUCT. PROVIDE PC CONCRETE

REMOVE EXISTING TACK BOARDS SCRAPE GLUE PODS FROM WALL (ALTERNATE BID)

FRAMING/WIRE. AND ALL COMPONENTS: I.E. SPEAKERS, LIGHTS ETC.

REMOVE LAY-IN CEILING SYSTEM COMPLETE INCLUDING SUPPORT

REMOVE EXISTING CONCRETE SLAB +/- 6" THICK AND ALL CONC. FDN FULL DEPTH

IF PRESENT (V.I.F.

REMOVE EXISTING RECEPTION COUNTER COMPLETE. PATCH WALLS & FLOORS AS REQ'D TO MATCH ADJACENT FINISHES.

REMOVE EXISTING HARD CEILING CONSTRUCTION COMPLETE. INCLUDING ALL

REMOVE EXISTING TRACK + SUPPORTS. PATCH HOLES IN WALLS FLUSH AS REQ'D TO MATCH EXISTING FINISHES.

SUPPORT FRAMING, BRACING, ETC.

REMOVE LAY-IN CEILING TILES, GRID TO REMAIN.

REMOVE EXISTING WOOD/GLASS FRAMING SYSTEM COMPLETE. PATCH WALLS &

FLOORS AS REQ'D TO MATCH EXISTING FINISHES.

EXISTING STEEL COLUMN TO REMAIN.

REMOVE STEEL GUARDRAIL COMPLETE - PATCH HOLES IN BRICK WITH NEW BRICK

TO MATCH EXISTING (V.I.F.)

REMOVE EXISTING WINDOW TREATMENTS COMPLETE INCLUDING TRACK, ETC. IN ENTIRE ROOM.

REMOVE ALL EXISTING RACEWAYS FROM WALL. PATCH HOLES FLUSH TO MATCH ADJACENT SURFACES.

EXISTING TILE FLOOR AND MASTIC TO BE REMOVED BY ABATEMENT CONTRACTOR

EXISTING DOOR FRAME TO BE REMOVED BY ABATEMENT CONTRACTOR

REMOVE EXISTING SHELF AND BOOT SHELF COMPLETE. PATCH HOLES IN WALL FLUSH TO MATCH EXISTING FINISHES.

EXISTING HARD CEILING TO BE REMOVED BY ABATEMENT CONTRACTOR

REMOVE RECESSED F.E.C. FILL OPENING WITH CMU TO MATCH COURSING AND THICKNESS (V.I.F.)



WAKELY ASSOCIATES, INC. ARCHITECTS

30500 VAN DYKE AVENUE SUITE M-7 WARREN, MICHIGAN 48093 PH: 586.573.4100 FX: 586.573.0822

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EMENTARY SCHOOLS

0

FARMINGTON PUBLIC 2018 PROPECT KENBROOK & BFECH

DEMO PLAN KEY NOTES FLOOR PLAN KEY NOTES REFL CLG PLAN KEY NOTES WALL TYPES

PRELIMINARY

DESIGN DEVELOPMENT

CONSTRUCTION

FINAL RECORD


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CHECKED BY BJS
REVISIONS
ADD NO. 01


DATE: December 12, 2017


SHEET NO.

G4.2

JOB NO. 171712

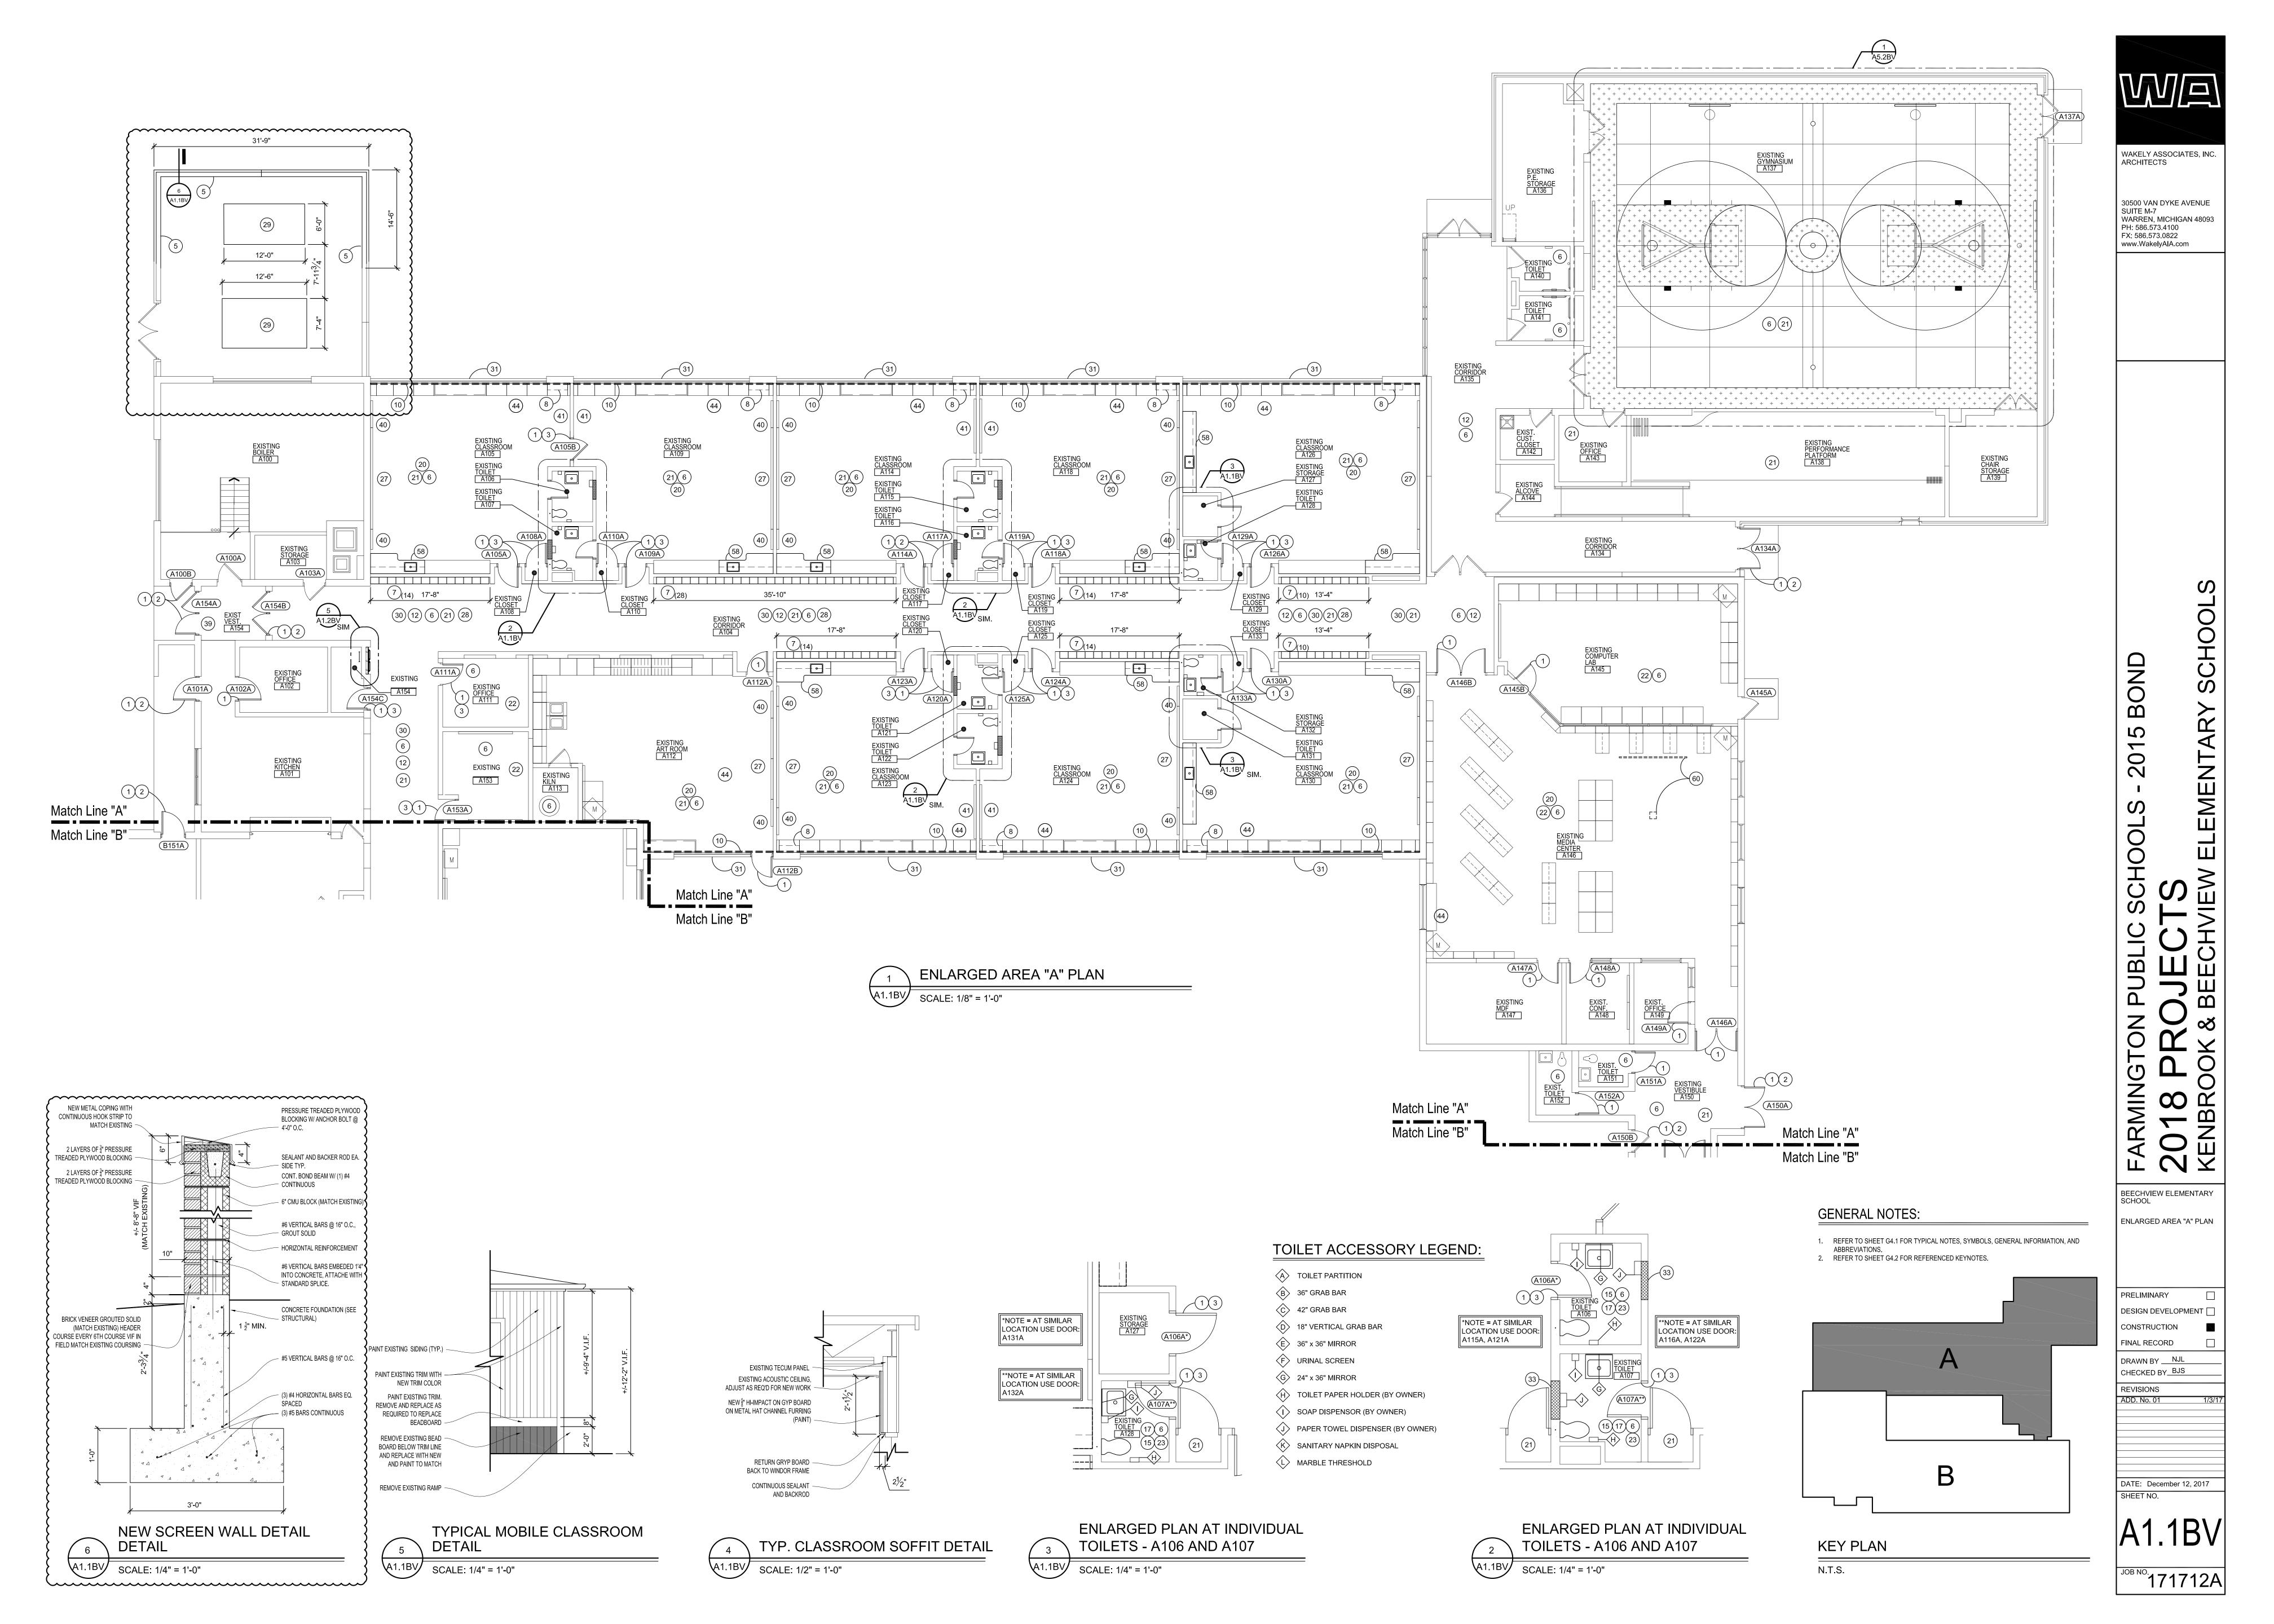

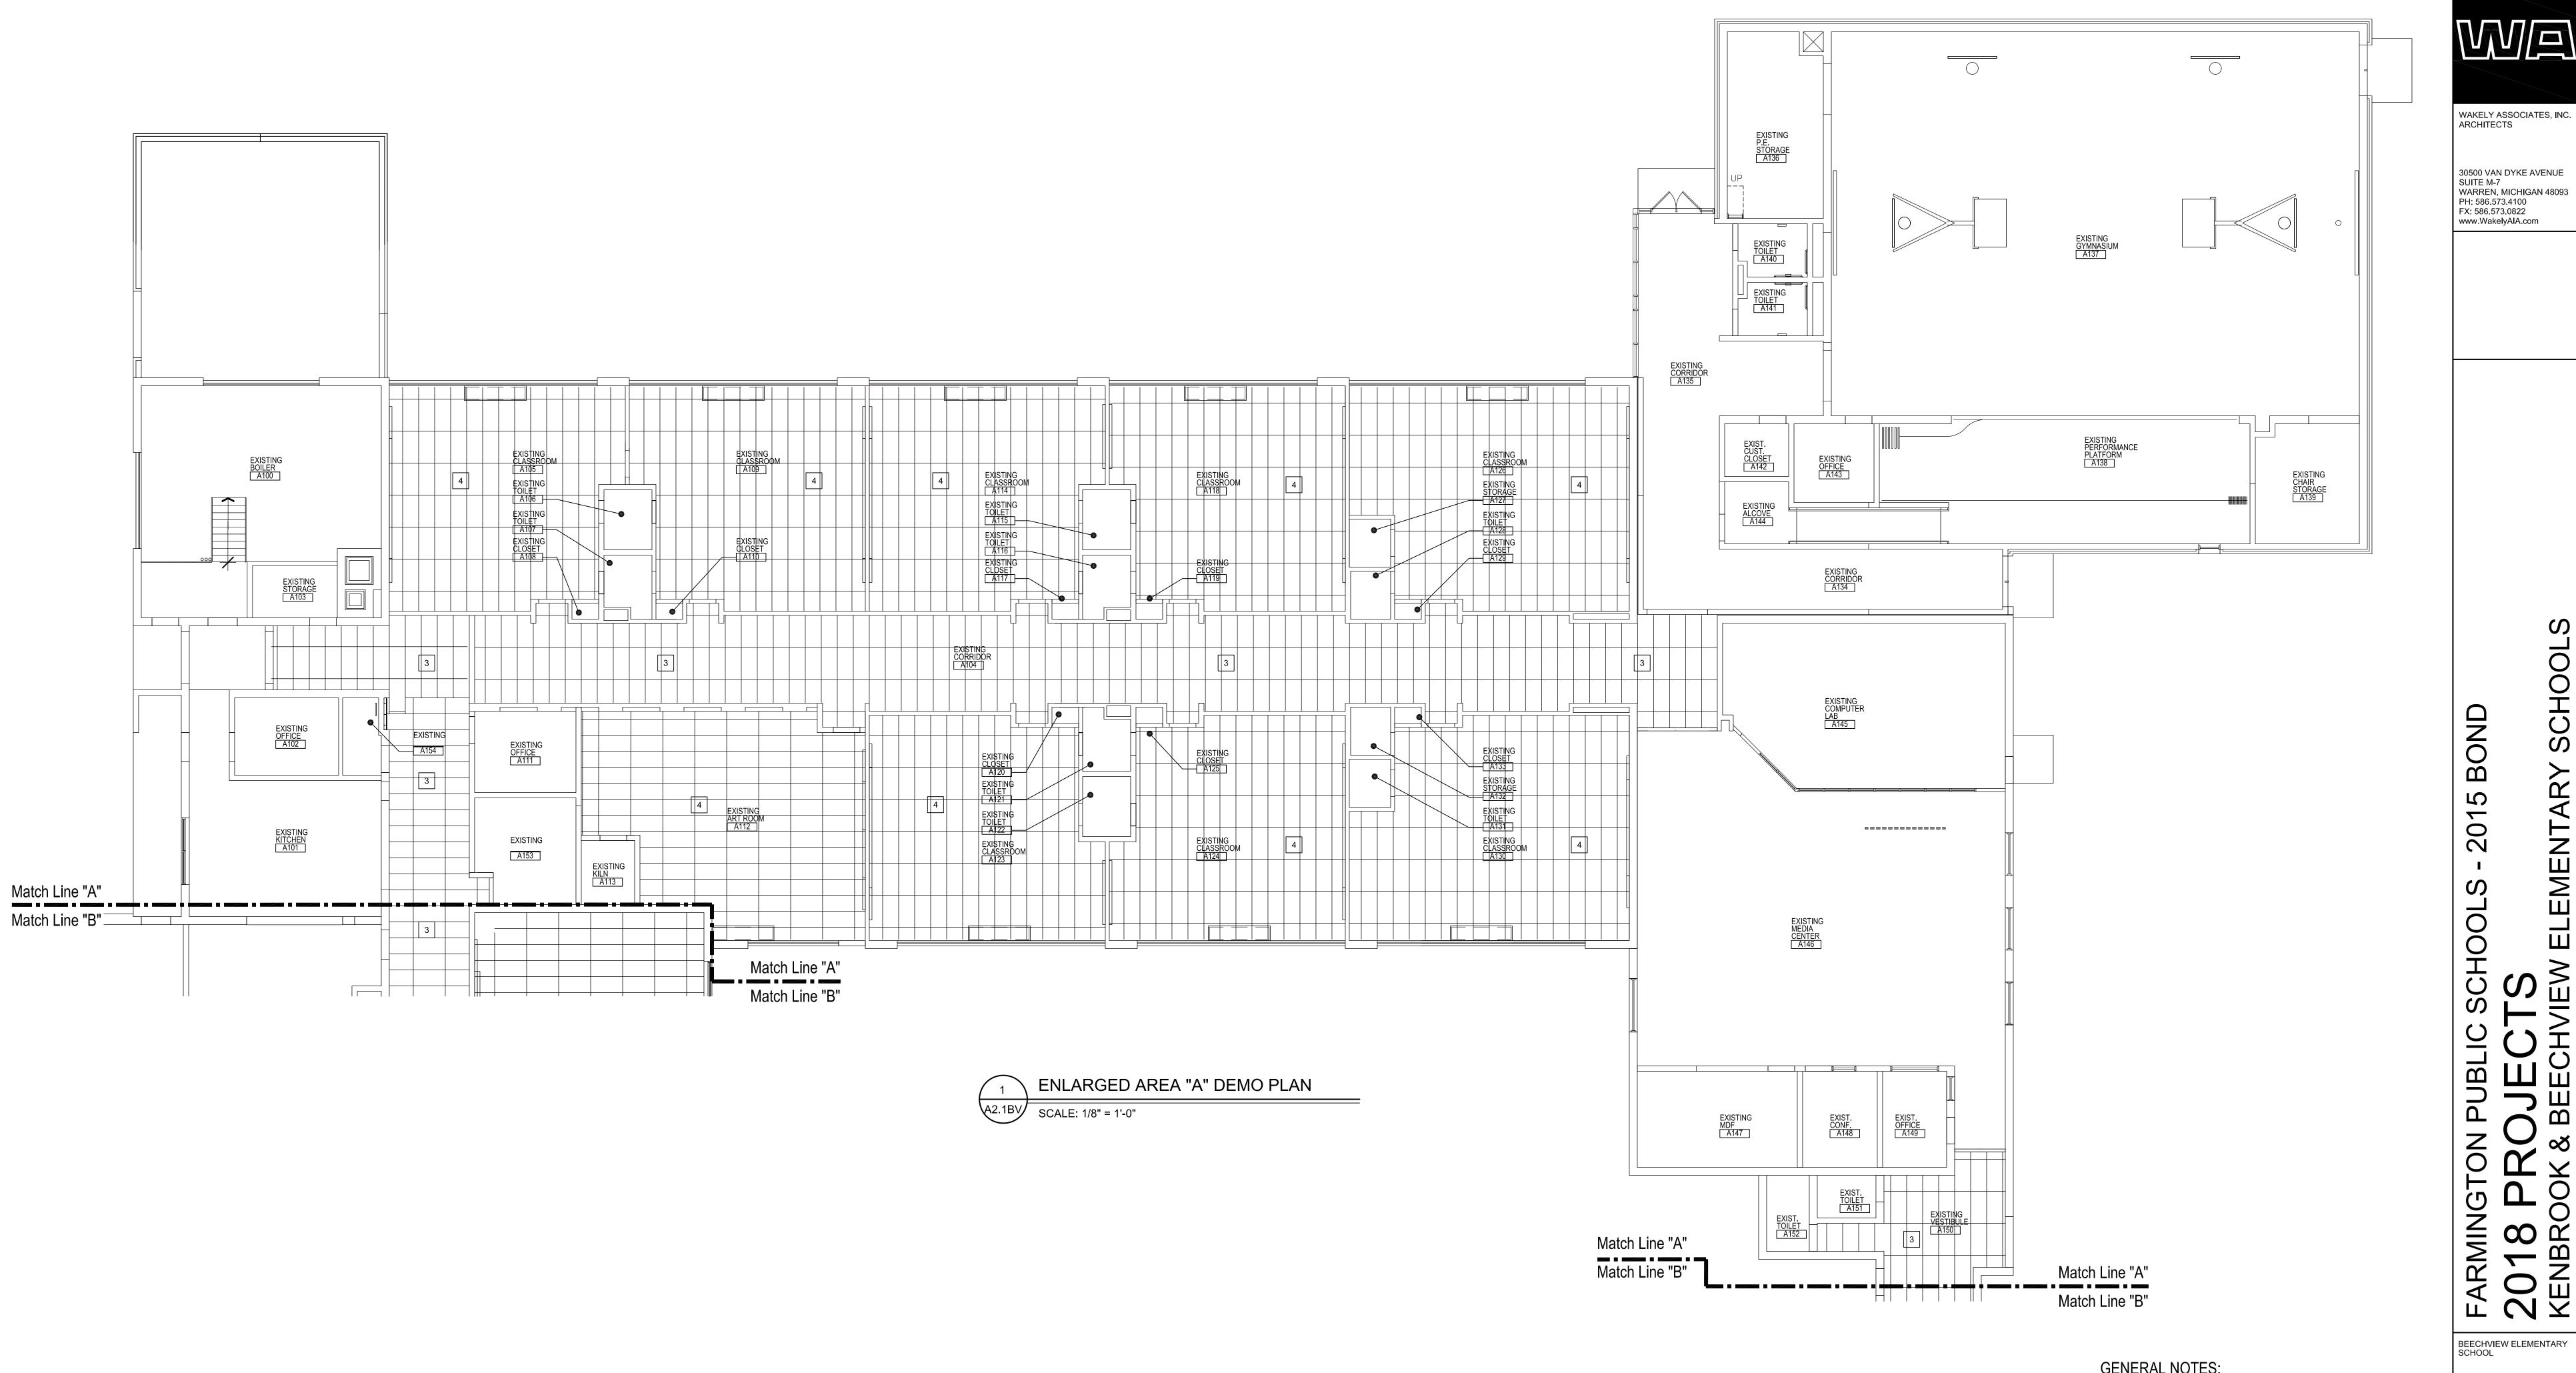

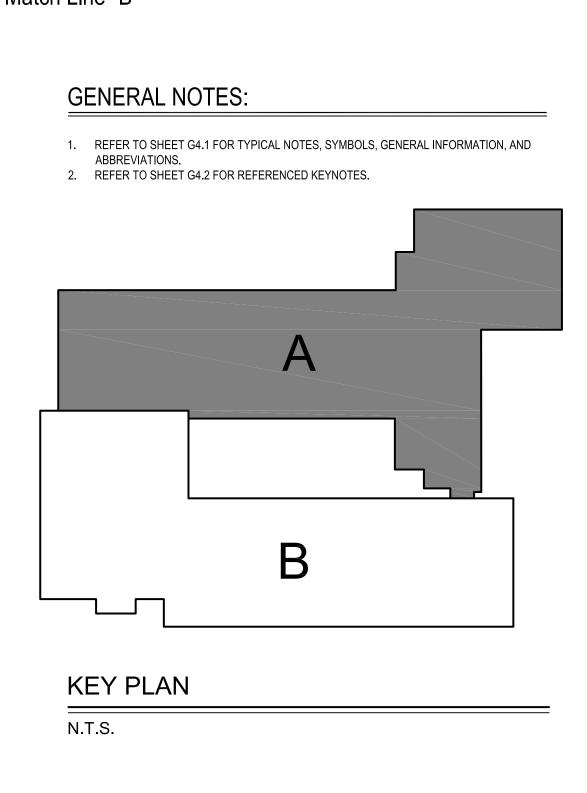

SCHOOLS **PUBLIC** 2018 KENBR( BEECHVIEW ELEMENTARY SCHOOL ENLARGED AREA "A" REFLECTED CEILING PLAN PRELIMINARY DESIGN DEVELOPMENT CONSTRUCTION FINAL RECORD DRAWN BY NJL
CHECKED BY BJS REVISIONS

DATE: December 12, 2017 SHEET NO.


A2.1BV

<sup>JOB NO.</sup>171712A

2015 BOND

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1 ENLARGED AREA "B" REFLECTED CEILING PLAN

A2.2BV SCALE: 1/8" = 1'-0"

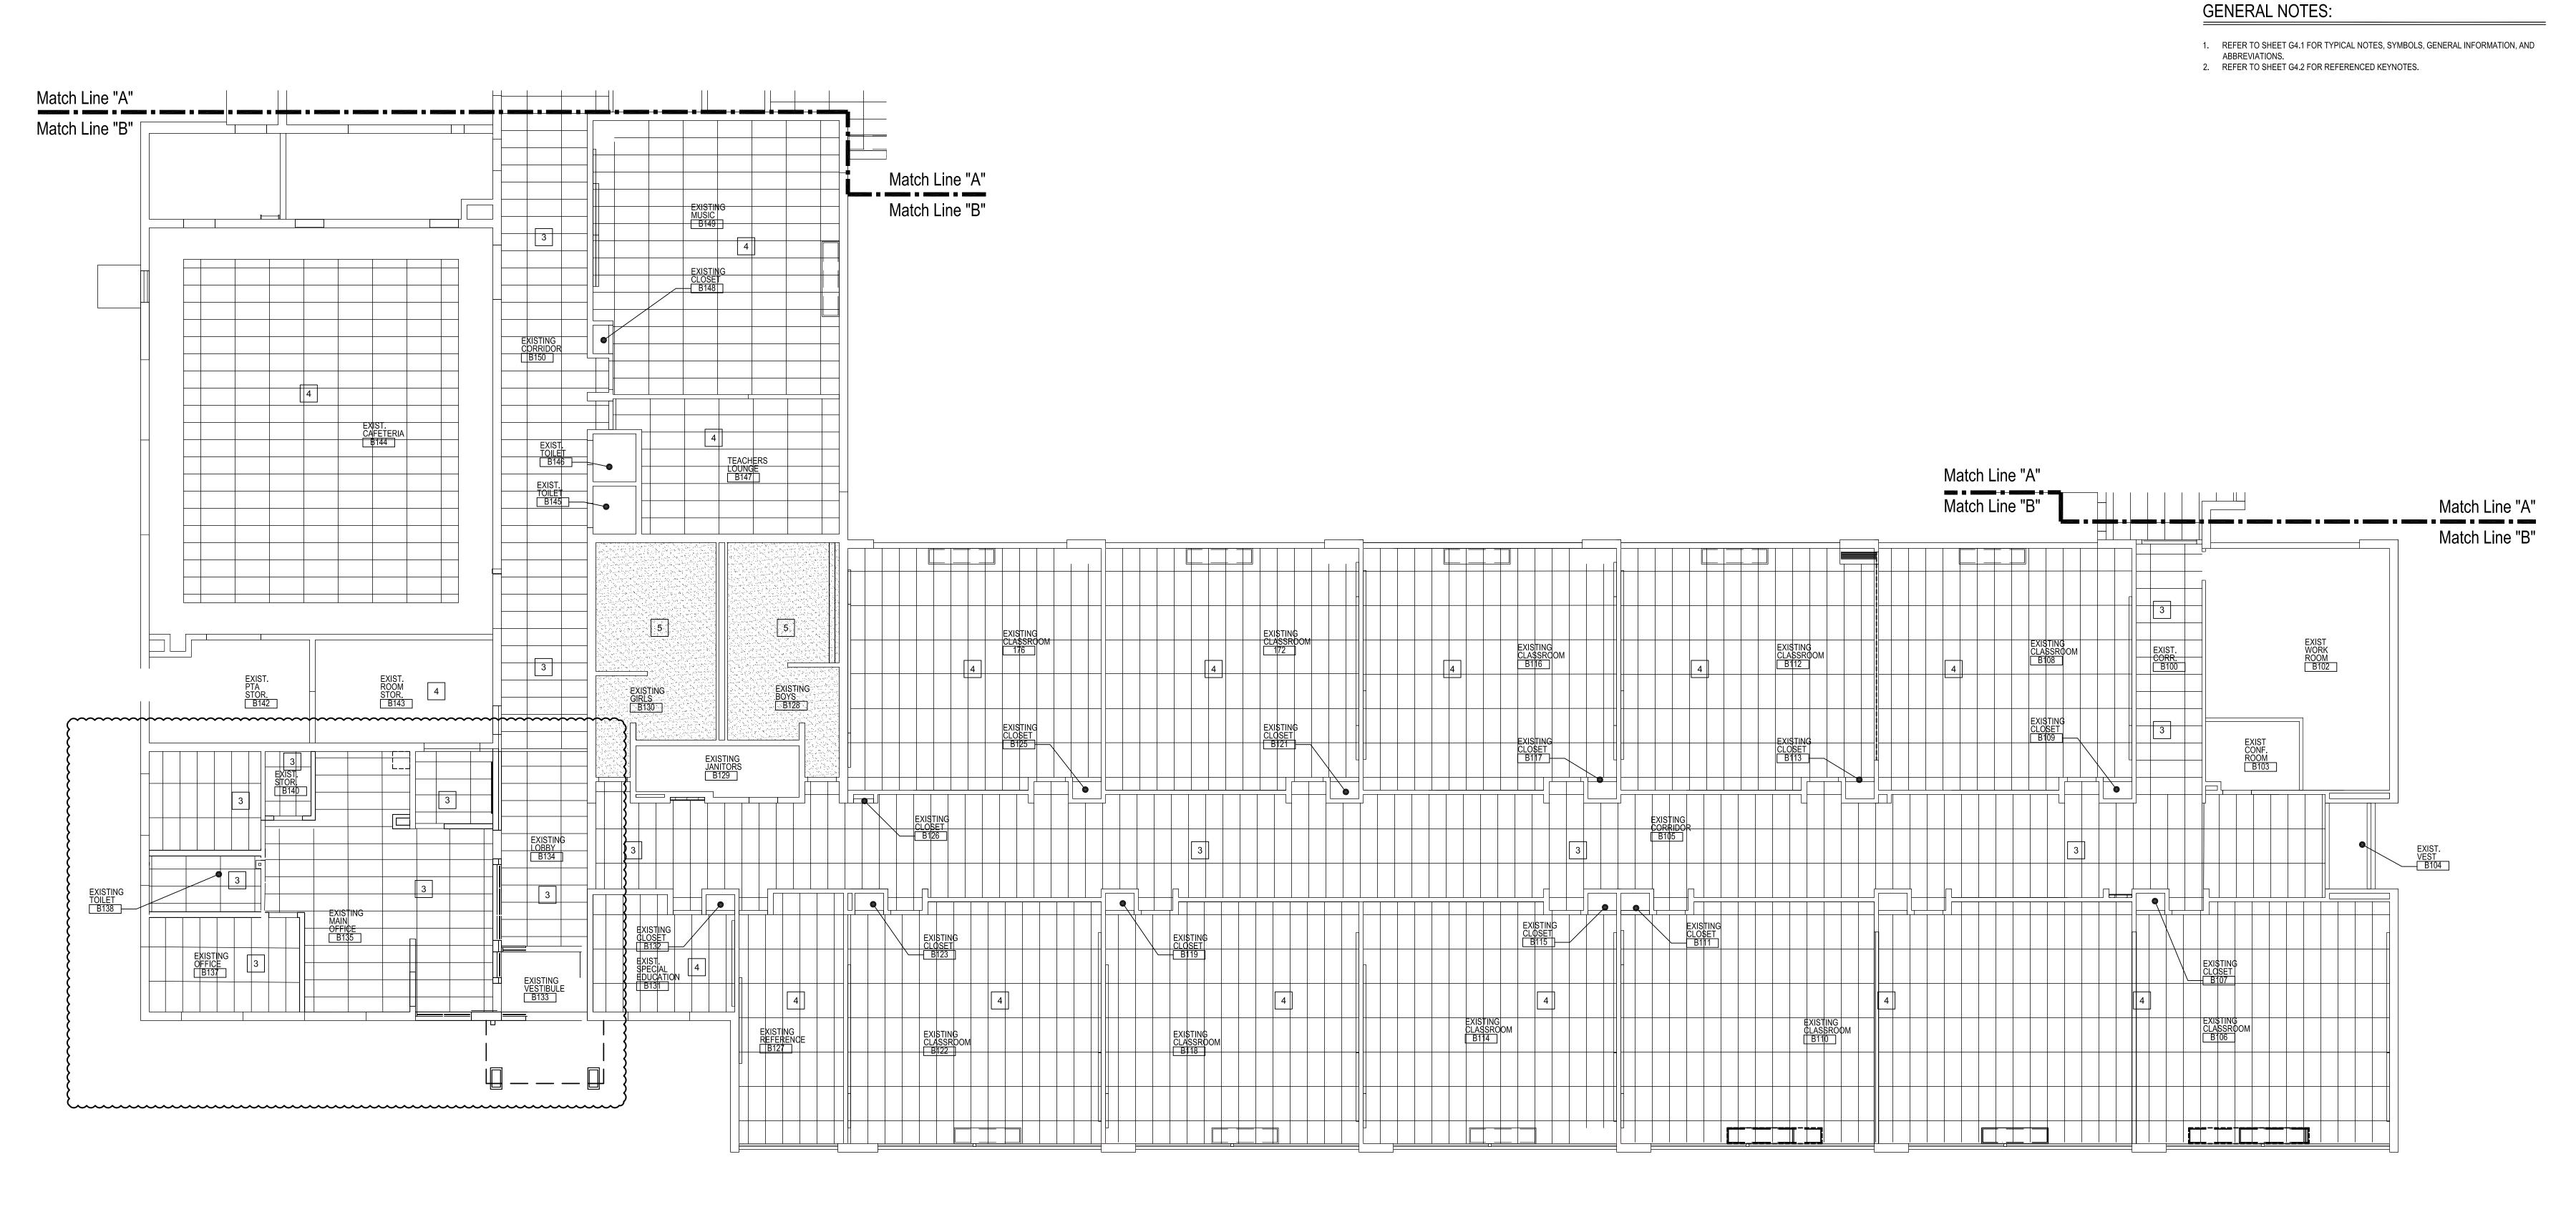

ENLARGED AREA "B" REFLECTED CEILING PLAN

PRELIMINARY

CONSTRUCTION

FINAL RECORD

REVISIONS

SHEET NO.

DRAWN BY NJL
CHECKED BY BJS

DATE: December 12, 2017

<sup>JOB NO.</sup>171712A

A

**KEY PLAN** 

N.T.S.


DESIGN DEVELOPMENT

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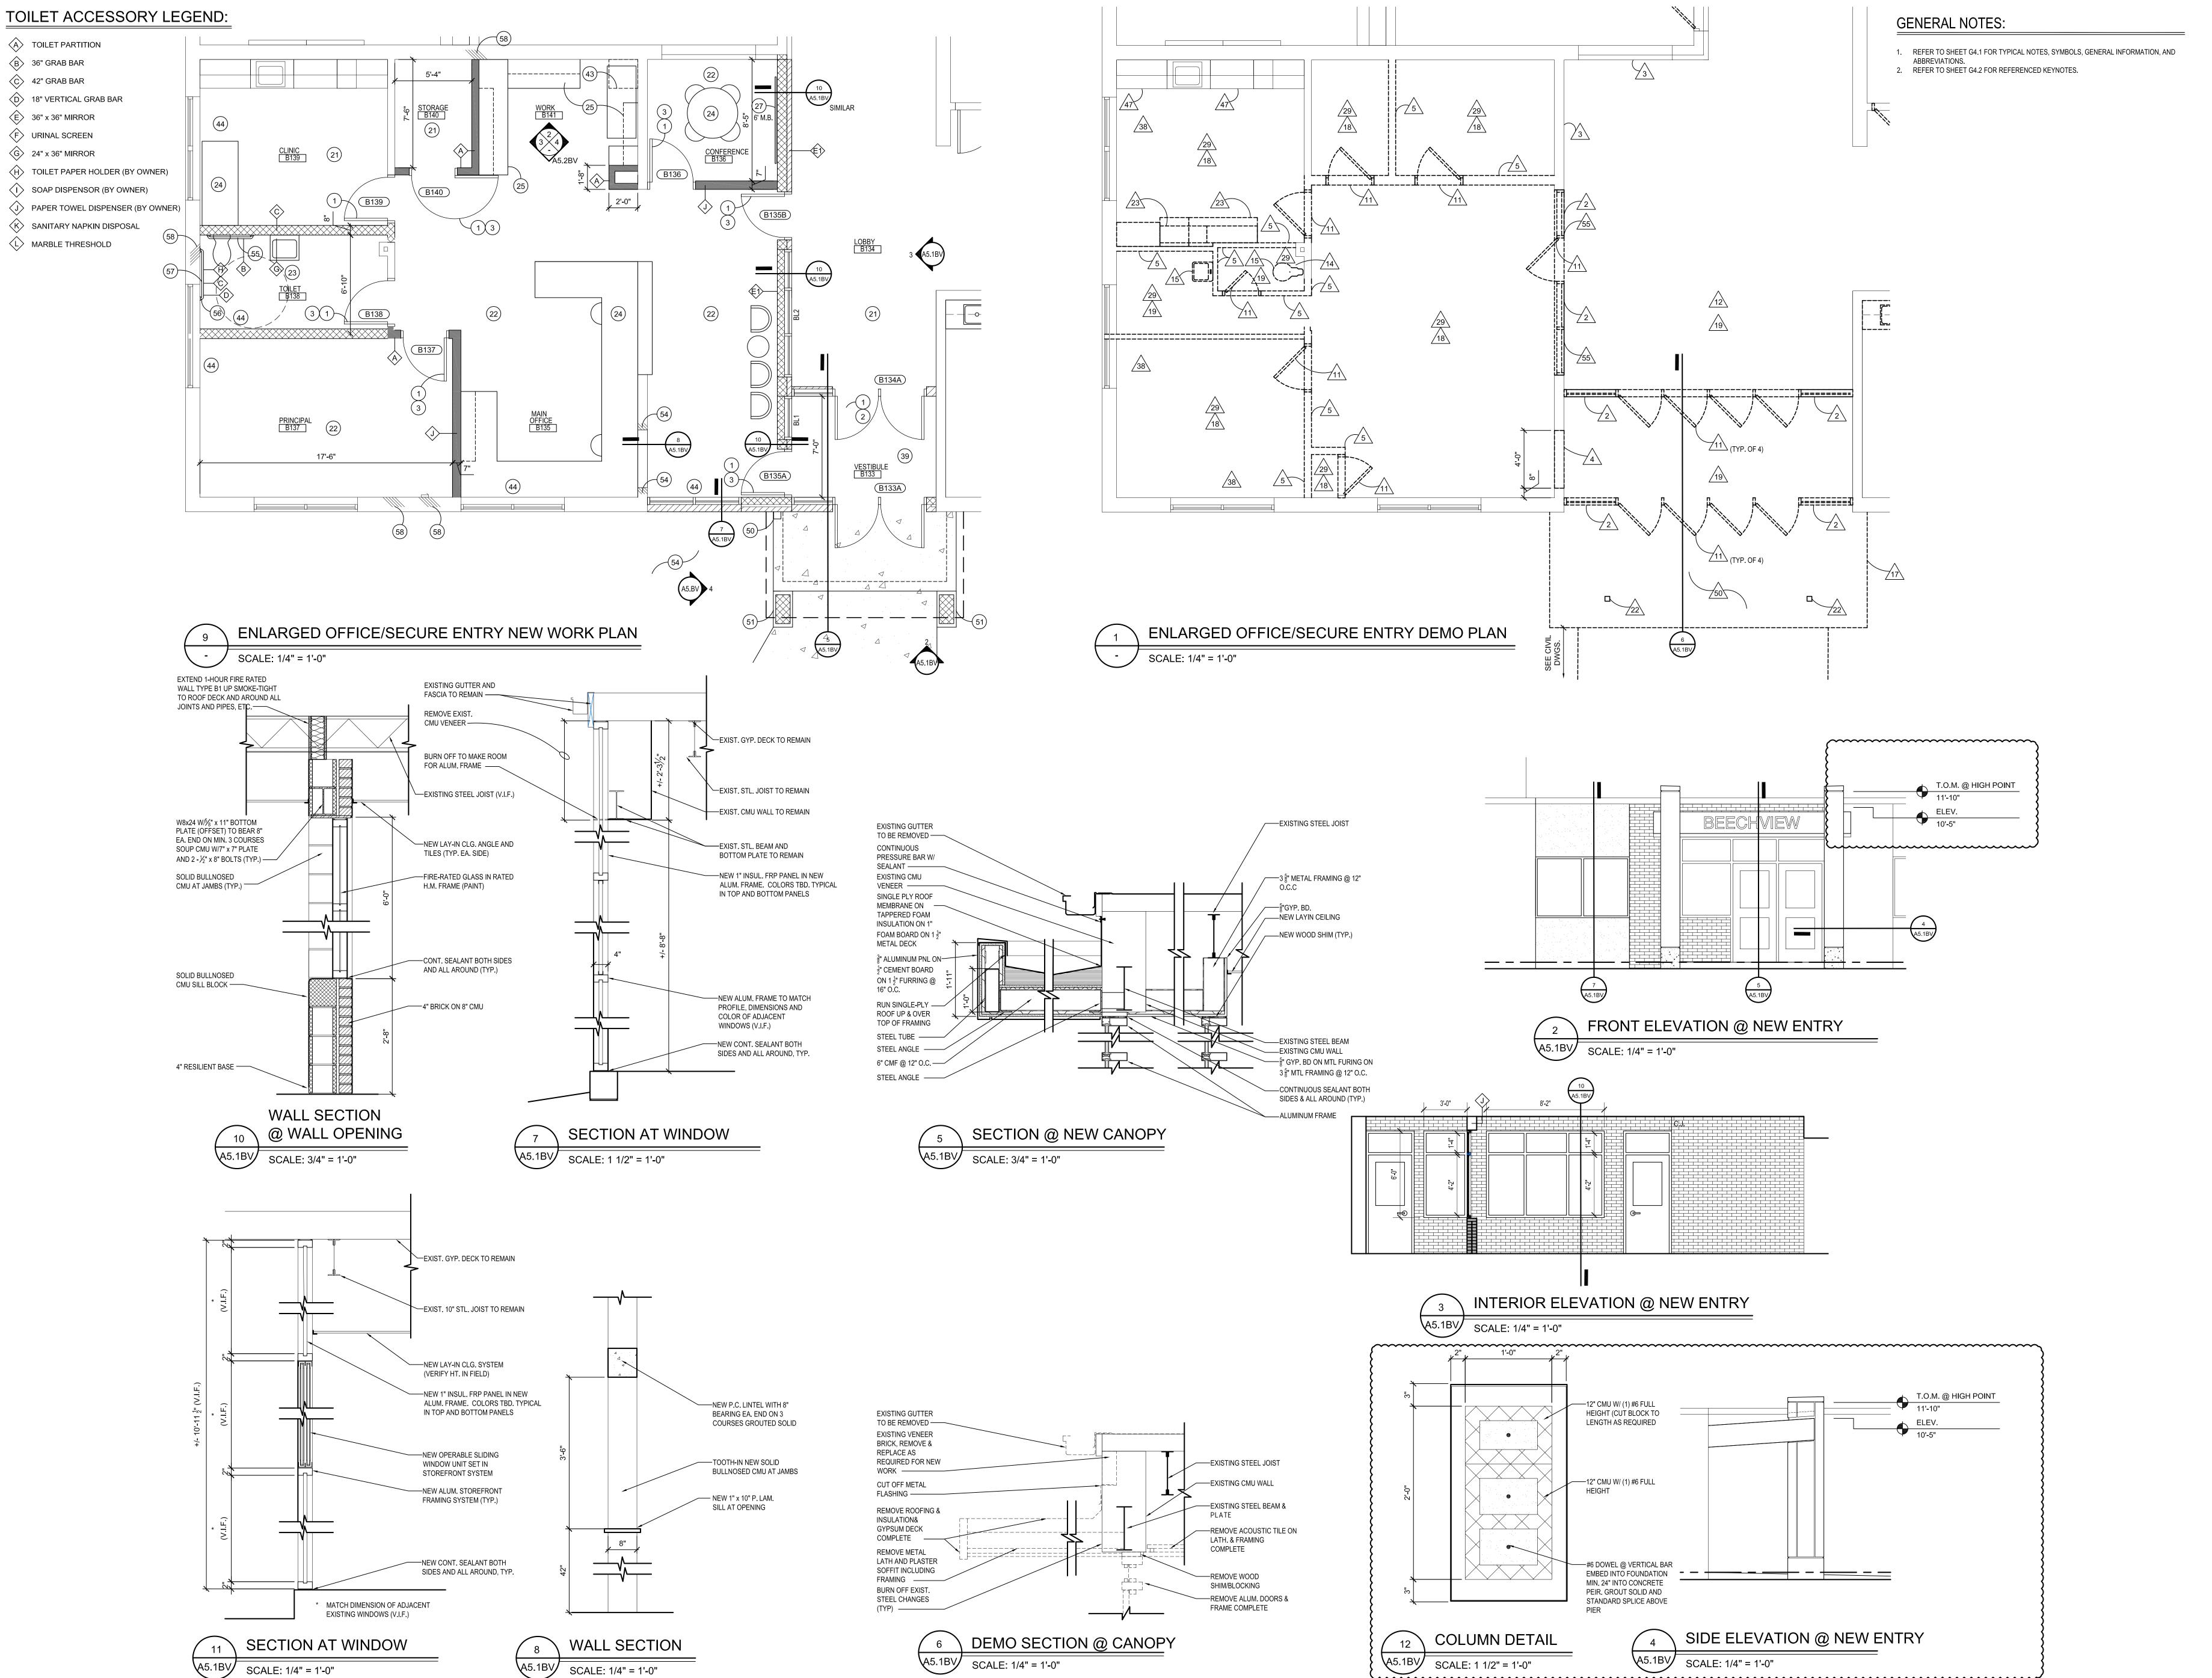
BEECHVIEW ELEMENTARY COMPOSITE PLAN

> PRELIMINARY DESIGN DEVELOPMENT ☐ CONSTRUCTION

FINAL RECORD DRAWN BY \_\_\_NJL CHECKED BY BJS REVISIONS

50% REVIEW

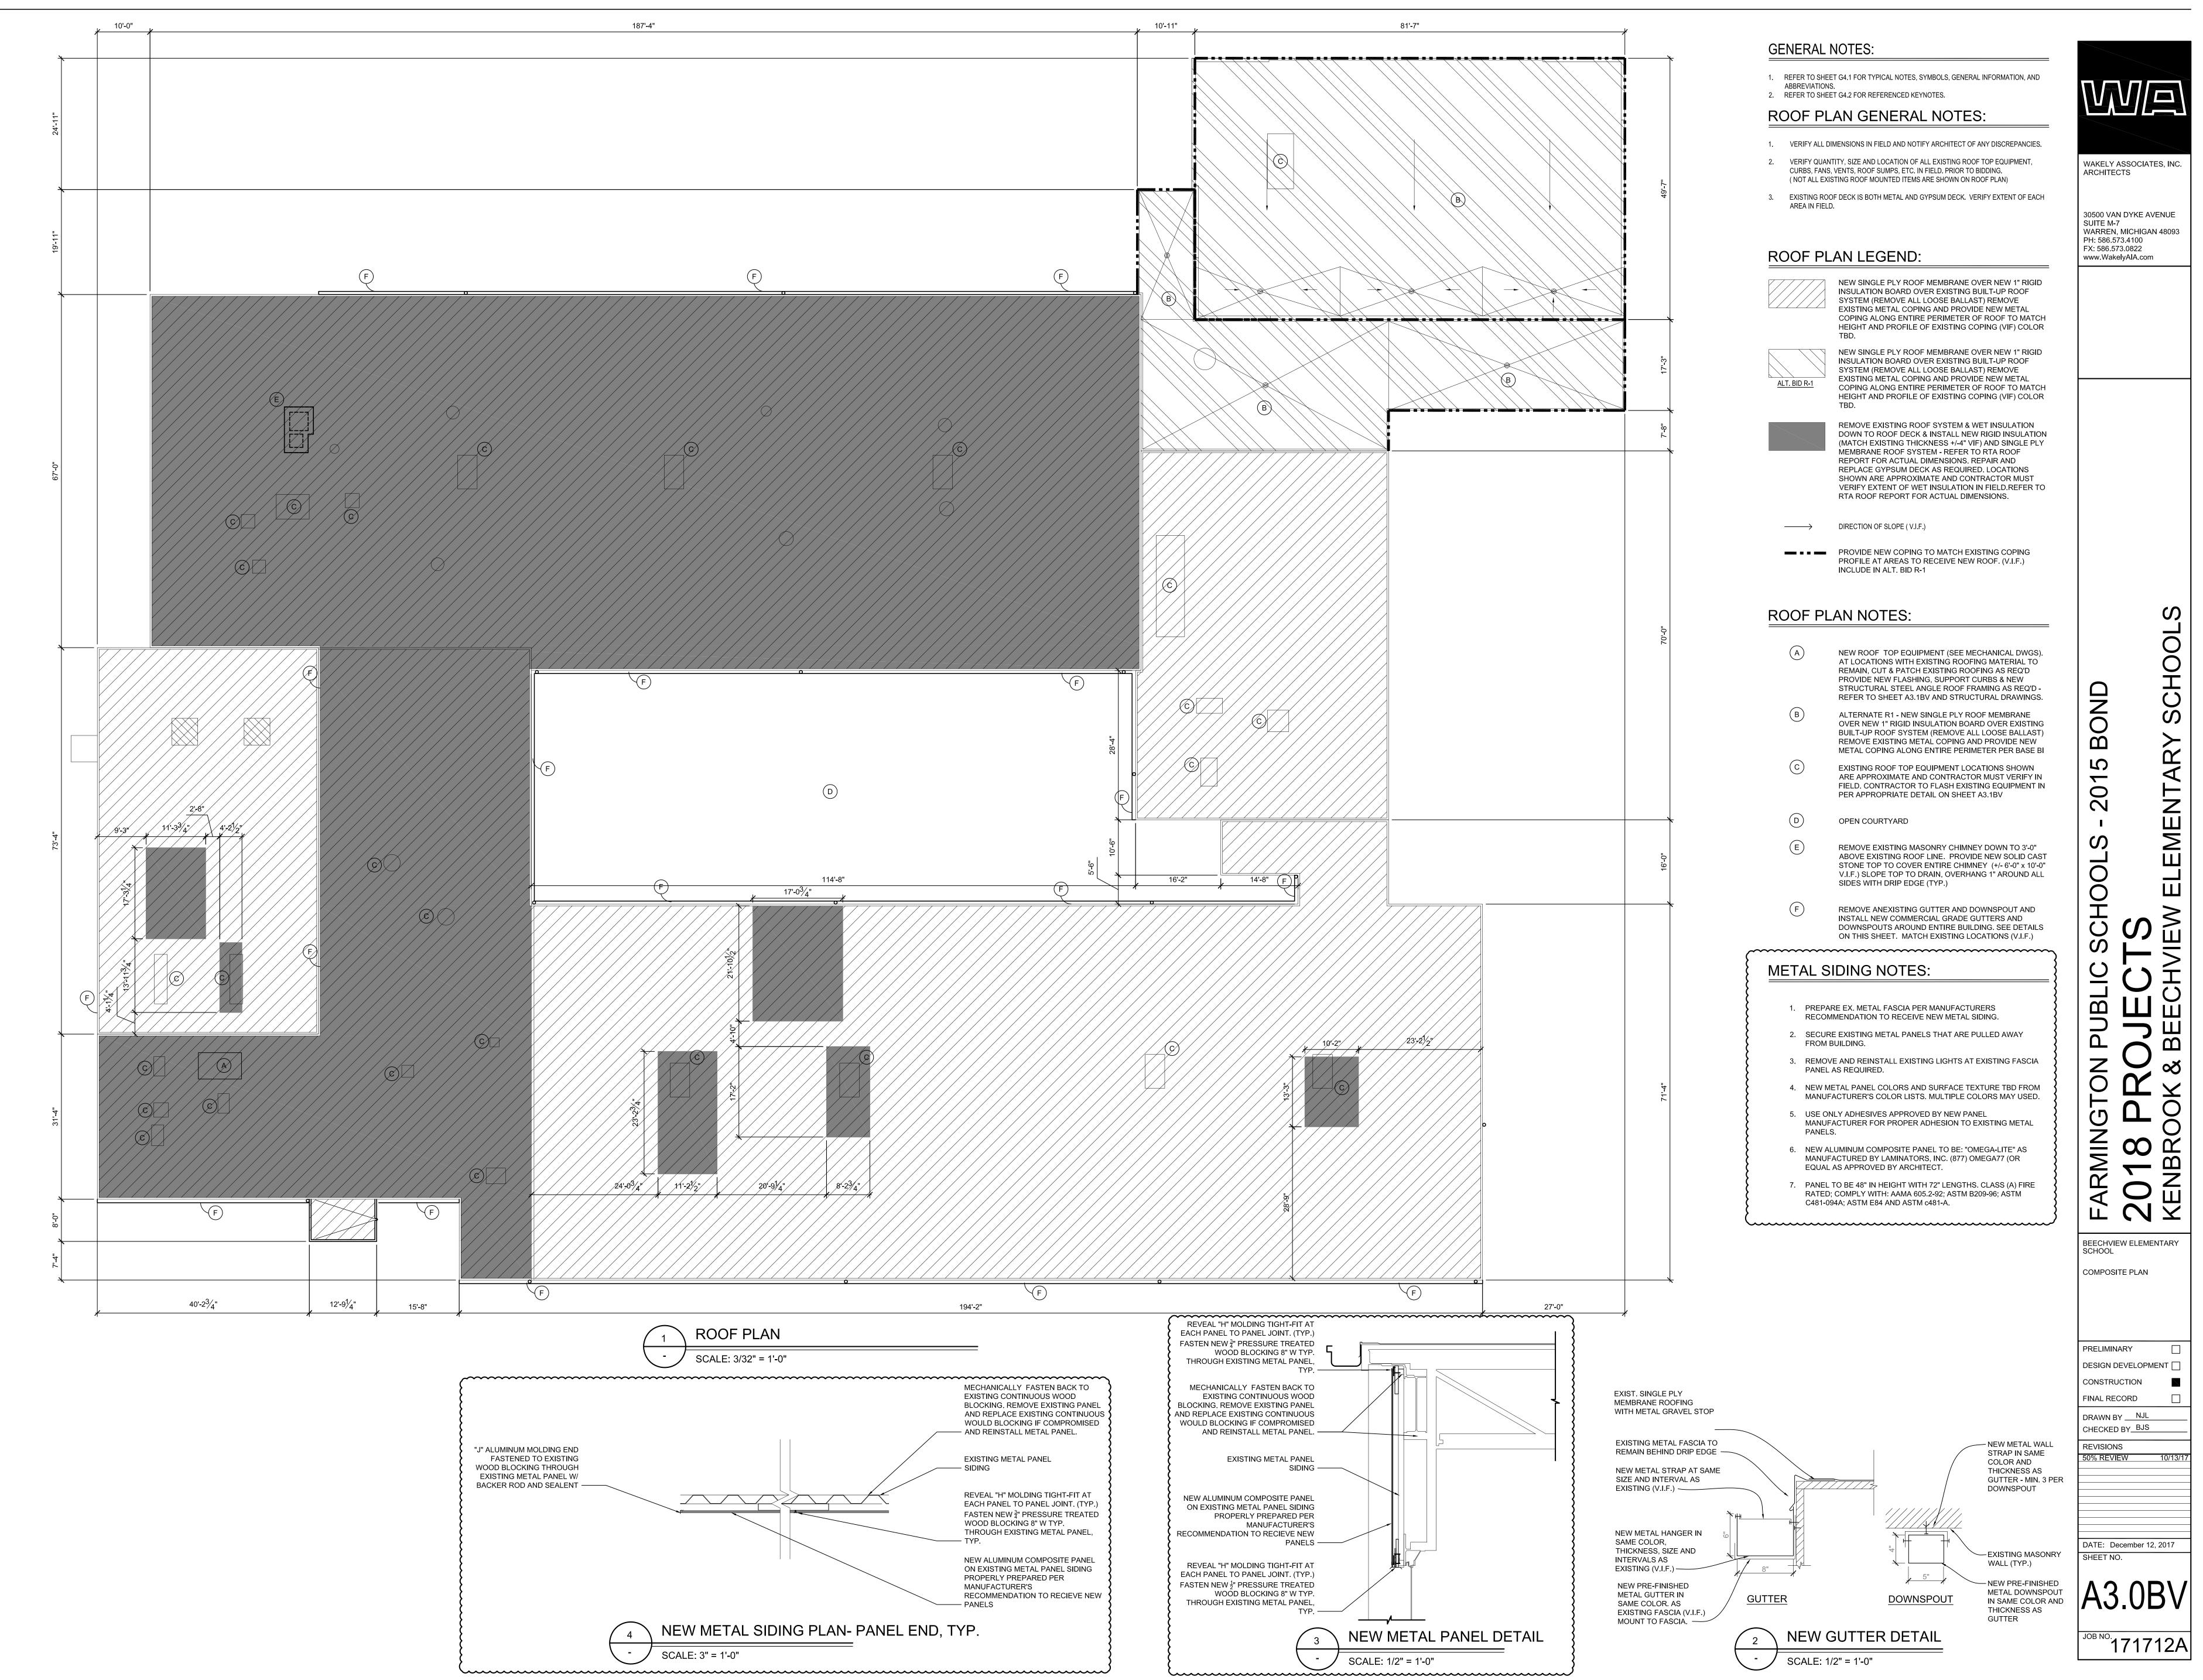DATE: December 12, 2017 SHEET NO.





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FARMINGTON PUBLIC SCHOOLS - 2015 BOND 2018 PROJECTS

KENBROOK & BEECHVIEW ELEMENTARY SCH

SCHOOL

COMPOSITE PLAN

PRELIMINARY

DESIGN DEVELOPMENT

CONSTRUCTION

FINAL RECORD

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ADD No. 1 1/3/17

DATE: December 12, 2017

A5.1BV

JOB NO. 171712A

### ROOM FINISH SCHEDULE ABBREVIATIONS:

ACT	ACOUSTICAL CEILING TILE IN NEW METAL GRID	PT	PAINT
ACT/PAD	NEW ACOUSTIC TILE IN EXIST. METAL GRID	RB	4" RESILIENT COVE BASE
BR	BRICK	RTR	RUBBER TREADS AND RISERS
CMU	CONCRETE MASONRY UNIT	SC	SEALED CONCRETE
CPT	CARPET	TEC	2'-0" x 2'-0" TECTUM IN GRID SYSTEM
EPT	EPOXY PAINT	LVT	LUXURY VINYL TILE FLOOR
ETR	EXISTING TO REMAIN	VACT	VINYL FACED ACT
EXP	EXPOSED CONSTRUCTION	VB	VENTED BASE
GB	GYPSUM BOARD	WC	WALK-OFF CARPET
PCT	PORCELAIN CERAMIC TILE	WD	WOOD
4PCT	4" PORCELAIN CERAMIC TILE COVE BASE	AF	ACCESS FLOORING

#### ROOM FINISH SCHEDULE REMARKS:

- PROVIDE MARKER BD. PAINT ON WALLS FULL HEIGHT AND WIDTH.
   NEW CEILING TO BE PLACED AT SAME HEIGHT AS EXISTING (VIF).
- NEW CEILING TO BE PLACED AT SAME HEIGHT AS EXISTING (VIF).
   SEE FLOOR PLANS FOR EXTENT OF NEW FLOORING & PATTERNS.
- MULTIPLE WALL PAINT COLORS & PATTERNS WILL BE USED IN THIS ROOM.
   MULTIPLE COLORS WILL BE USED ON EXPOSED ROOF DECK, FRAMING, DUCTWORK, ETC.
   SEE ELEVATIONS AND NOTES FOR HEIGHT OF WALL TILE. PAINT CMU WALL ABOVE TILE (VERIFY EACH ROOM
- DIMENSION IN FIELD).
  7. SEE ELEVATIONS AND DETAILS FOR SOFFITS / WALL MATERIALS TO BE PAINTED.
- 8. REMOVE WALL COVERING, SKIM COAT WALLS, SAND AND PREP FOR NEW PAINT AS REQUIRED.
- 9. NOT USED
  10. PROVIDE GYM FLOOR STRIPING AS DETAILED ON ENLARGED PLANS.
  11. PAINT WALLS UP TO CEILING LINE (+/-10'-0" A.F.F. VIF)
- 12 PROVIDE OVAL IN CARPET SEE DETAIL.

  13. PROVIDE 12'-0" x 12'-0" AREA RUG SEE SPEC.

### ROOM FINISH SCHEDULE GENERAL NOTES (APPLIES TO ALL ROOMS):

- 1. PAINT ALL EXPOSED ITEMS IN ROOMS: DOOR FRAMES, WINDOW FRAMES, DUCTS, PIPES, CONDUITS, ROOF FRAMING, ROOF DECK, ETC.
- SEE ELEVATIONS & DETAILS FOR GYP BD SOFFIT HEIGHTS & SIZES.
   SEE ELEVATIONS & DETAILS FOR WALL TILE HEIGHTS & LOCATIONS
- SEE PLANS FOR FLOOR PATTERNS AND WALK-OFF CARPET LOCATIONS
   PROVIDE VINYL TRANSITION STRIPS AT DISSIMILAR FLOOR FINISHES CARPET / TILE, CARPET / CONCRETE, ETC.
- 6. PAINT NEW WALL CONSTRUCTION TO MATCH EXISTING IN ROOM (VIF)7. PROVIDE STAINLESS STEEL SCHLUTER TRANSITIONS AT ALL HARD TILE / CARPET LOCATIONS.
- PROVIDE STAINLESS STEEL SCHLUTER TRANSITIONS AT ALL HARD TILE / CARPET LOCATIONS.
   MODIFY EXISTING LAY-IN CEILINGS AS REQUIRED TO ACCOMMODATE NEW WALL PLACEMENT.
- 9. REMOVE / REINSTALL EXISTING LAY-IN CEILING SYSTEMS AS REQUIRED FOR OVERHEAD PIPING, DUCT WORK, ETC (VIF).
- 10. VERIFY WITH EACH SCHOOL PRINCIPAL <u>BEFORE PAINTING OVER</u> TOP OF EXISTING PAINTED MURALS IN CORRIDOR'S AND CLASSROOMS.
  11. ALL TOILET ROOMS CALLING FOR PAINT TO BE EPOXY PAINT (WALLS & CEILINGS).

<u>RO</u>	OM FINISH SCH	EDUL	<b>_</b>				I
					CEIL	ING	
NO.	ROOM NAME	FLOOR	BASE	WALLS	MATERIAL	HGT.	REMARKS
B135	EXISTING MAIN OFFICE	CPT	RB	BR/GB-PT	ACT	+/-9'-6"(VIF)	-
B136	NEW CONFERENCE ROOM	CPT	RB	CMU/BR/ETR	ACT	9'-0"	-
B137	EXISTING OFFICE	CPT	RB	GB/CMU/PT	ACT	9'-0"	-
B138	NEW TOILET	PCT	4PCT	GB/CMU/EPT	ACT	9'-0"	-
B139	NEW CLINIC	LVT	RB	GB/CMU/PT	ACT	9'-0"	-
B140	NEW STORAGE	CPT	RB	PT	ACT		
B140   B141	NEW WORK ROOM	CPT	RB	PT	ACT	-	-
	EXISTING PTA STORAGE					-	-
B142		ETR	ETR	ETR	ETR	-	-
B143	EXIST. CONFERENCE ROOM	CPT	RB	PT	ETR	- ( 40) 0!() (!5)	-
B144	EXISTING CAFETERIA	LVT	RB	PT	ACT/PAD	+/-10'-0"(VIF)	3,4,11
B145	EXISTING TOILET	PCT	4PCT	EPT	EPT	+/-8'-0"(VIF)	-
B146	EXISTING TOILET	PCT	4PCT	EPT	EPT	+/-8'-0"(VIF)	-
B147	EXIST. TEACHERS LOUNGE	CPT/LVT	RB	PT	ACT/PAD	-	-
B148	EXISTING CLOSET	CPT	RB	ETR	ETR	-	-
B149	EXISTING MUSIC	CPT	RB	PT	ACT/PAD	+/-9'-2"(VIF)	12
	EVICTING CORRIDOR						
B150	EXISTING CORRIDOR	LVT	RB	PT	ACT	-	-
B151	EXISTING STORAGE	ETR	ETR	ETR	ETR	-	-
B152	EXISTING SERVERY	ETR	ETR	ETR	ETR	-	$\sim$
B154	EXISTING CLASSROOM	LVT	RB	PT	ACT/PAD	+/-9'-2"(VIF)	<b>\</b> 13 <b>\</b>
B155	EXISTING CLASSROOM	LVT	RB	PT	ACT/PAD	+/-9'-2"(VIF)	13
D172	EXISTING CLASSROOM	LVT	DD	DT		1/0'2"(\/IE\	<del>13</del>
B172		LVT	RB	PT	ACT/PAD	+/-9'-2"(VIF)	+ ( )
B176	EXISTING CLASSROOM	LVT	RB	PT	ACT/PAD	+/-9'-2"(VIF)	13}
-	-	-	=	-	-	-	-
-	-	-	-	-	=	-	-

NO.	ROOM NAME	FLOOR	BASE	WALLS	MATERIAL	HGT.	REMARKS
\100 \101	EXISTING BOILER EXISTING KITCHEN	ETR ETR	ETR ETR	ETR ETR	ETR ETR	-	-
\101 \102	EXISTING STORAGE	ETR	ETR	ETR	ETR	-	-
4103 4104	EXISTING OFFICE EXISTING CORRIDOR	ETR LVT	ETR RB	ETR PT	ETR ACT	- +/-7'-11"(VIF)	2,3,4
						,	
4105 4106	EXISTING CLASSROOM EXISTING TOILET	LVT PCT	RB 4PCT	PT PT	ACT/PAD ETR/PT	+/-9'-2"(VIF) +/-8'-0"(VIF)	13
4107	EXISTING TOILET	PCT	4PCT	PT	ETR/PT	+/-8'-0"(VIF)	-
4108 4109	EXISTING CLOSET EXISTING CLASSROOM	LVT LVT	RB RB	ETR PT	ETR ACT/PAD	- +/-9'-2"(VIF)	13
1103						17-3-2 (VII )	
A110 A111	EXISTING CLOSET EXISTING OFFICE	LVT CPT	RB RB	PT PT	ETR ACT/PAD	-	-
4112	EXISTING OFFICE  EXISTING ART ROOM	LVT	RB	PT	ACT/PAD	+/-9'-2"(VIF)	-
4113 4114	EXISTING KILN EXISTING CLASSROOM	ETR LVT	ETR RB	ETR PT	ETR ACT/PAD	- +/-9'-2"(VIF)	13
		LVI	ND ND	FI	ACTIFAD	+/-9 -2 (VIF)	13)
4115 4116	EXISTING TOILET EXISTING TOILET	PCT PCT	4PCT 4PCT	PT PT	ETR/PT ETR/PT	+/-8'-0"(VIF) +/-8'-0"(VIF)	-
A117	EXISTING CLOSET	LVT	RB	ETR	ETR	+/-8'-0"(VIF)	-
A118 A119	EXISTING CLASSROOM EXISTING CLOSET	LVT LVT	RB RB	PT ETR	ACT/PAD ETR	+/-9'-2"(VIF)	-
1119	EXISTING CLOSET	LVI	Kb	EIK	LIK	-	-
4120 4121	EXISTING CLOSET EXISTING TOILET	LVT PCT	RB 4PCT	ETR PT	ETR ETR/PT	- +/ 8' 0"(\/IE\	-
4121	EXISTING TOILET	PCT	4PCT	PT	ETR/PT	+/-8'-0"(VIF) +/-8'-0"(VIF)	- -
\123 \124	EXISTING CLASSROOM EXISTING CLASSROOM	LVT	RB RB	PT PT	ACT/PAD	+/-9'-2"(VIF)	(13) (13)
124	LAISTING CLASSKOOM	LVT	RB	PT	ACT/PAD	+/-9'-2"(VIF)	<u>{13}</u>
A125	EXISTING CLASSPOOM	LVT	RB	ETR	ETR	- +/ 0' 2"(\/IE)	(12)
4126 4127	EXISTING CLASSROOM EXISTING STORAGE	LVT LVT	RB RB	PT ETR	ACT/PAD ETR	+/-9'-2"(VIF) -	(13)
<b>A128</b>	EXISTING TOILET	PCT	4PCT	PT	ETR/PT	+/-8'-0"(VIF)	-
4129	EXISTING CLOSET	LVT	RB	ETR	ETR	-	-
A130	EXISTING CLASSROOM	LVT	RB	PT	ACT/PAD	+/-9'-2"(VIF)	[13]
4131 4132	EXISTING STORAGE EXISTING TOILET	LVT PCT	RB 4PCT	ETR PT	ETR ETR/PT	- +/-8'-0"(VIF)	-
4133	EXISTING COPPIDOR	LVT	RB	ETR	ETR	-	-
4134	EXISTING CORRIDOR	LVT	RB	PT	ETR	-	3,4
A135	EXISTING CORRIDOR	LVT	RB	PT	ETR	-	3,4
4136 4137	EXISTING P.E. STORAGE EXISTING GYMNASIUM	ETR LVT	ETR RB	ETR PT	ETR ETR/PT	-	4,5,10
4138	EXIST. PERFORMANCE PLATFORM	LVT	RB	PT	PT	-	-
4139	EXISTING CHAIR STORAGE	ETR	ETR	ETR	ETR	-	-
4140	EXISTING TOILET	ETR	ETR	PT	ETR	-	-
A141 A142	EXISTING TOILET EXISTING CUST. CLOSET	ETR ETR	ETR ETR	PT ETR	ETR ETR	-	-
4143	EXISTING OFFICE	LVT	RB	PT	ACT	-	2
4144	EXISTING ACLOVE	LVT	RB	PT	ETR	-	-
4145	EXISTING COMPUTER LAB	CPT	RB	ETR	ETR	-	-
4146 4147	EXISTING MEDIA CENTER EXISTING MDF	CPT ETR	RB ETR	PT ETR	ACT/PAD ETR	-	4 -
A148	EXISTING CONF.	ETR	ETR	ETR	ETR	-	-
4149	EXISTING OFFICE	ETR	ETR	ETR	ETR	-	-
4150	EXISTING VESTIBULE	LVT	RB	PT	ACT	-	-
A151 A152	EXISTING TOILET EXISTING TOILET	ETR ETR	ETR ETR	PT PT	ETR ETR	-	-
A153	EXISTING OFFICE	CPT	RB	PT	ACT	-	2
-	-	-	-	-	-	-	-
3100	EXISTING CORRIDOR	LVT	RB	PT	ACT	8'-0"	3,4
3101 3102	- EXISTING WORK ROOM	- ETR	- ETR	- ETR	- ETR	9'-2"	-
B102 B103	EXISTING CONF. ROOM	CPT	RB	PT	ETR	-	-
3104	EXISTING VESTIBULE	WC	RB	PT	ACT	9'-2"	-
B105	EXISTING CORRIDOR	LVT	RB	PT	ACT	8'-0"	3.4
B106 B107	EXISTING CLASSROOM EXISTING CLOSET	LVT LVT	RB RB	PT ETR	ACT/PAD ETR	9'-2"	9,13
310 <i>7</i> 3108	EXISTING CLOSET  EXISTING CLASSROOM	LVT	RB RB	PT	ACT/PAD	9'-2"	9,13
3109	EXISTING CLOSET	LVT	RB	ETR	ETR	-	
B110	EXISTING CLASSROOM	LVT	RB	PT	ACT	9'-2"	[13]
3110A B111	EXISTING CLASSROOM EXISTING CLOSET	LVT LVT	RB RB	PT ETR	ACT ETR	9'-2"	[13]
B111 B112	EXISTING CLOSET  EXISTING CLASSROOM	LVT	RB RB	PT	ACT/PAD	9'-2"	[13]
3113	EXISTING CLOSET EXISTING CLASSROOM	LVT	RB DB	ETR	ETR	- 0' 2"	$\sim$
B114	LAISTING CLASSKOOM	LVT	RB	PT	ACT/PAD	9'-2"	133
B115	EXISTING CLASSPOOM	LVT	RB	ETR	ETR	- 0' 2"	(12)
B116 3117	EXISTING CLASSROOM EXISTING CLOSET	LVT LVT	RB RB	PT ETR	ACT/PAD ETR	9'-2"	(13)
3118	EXISTING CLASSROOM	LVT	RB	PT	ACT/PAD	9'-2"	13
3119	EXISTING CLOSET	LVT	RB	ETR	ETR	-	-
B120	-	-	-	-	-	-	-
B121 3122	EXISTING CLOSET EXISTING CLASSROOM	LVT LVT	RB RB	ETR PT	ETR ACT/PAD	9'-2"	<u>-</u> (13)
3123	EXISTING CLOSET	LVT	RB	ETR	ETR	-	
3124	-	-	-	-	-	-	-
B125	EXISTING CLOSET	LVT	RB	ETR	ETR	-	-
B126 B127	- EXISTING REFERENCE	-   \/T	- DR	- PT	- ^CT/P^D	-	-
B127 B128	EXISTING REFERENCE EXISTING BOYS	LVT PCT	RB 4PCT	PCT/EPT	ACT/PAD GYP/EPT	-	6
B129	EXISTING JANITORS	ETR	ETR	ETR	ETR	-	-
B130	EXISTING GIRLS	PCT	4PCT	PCT/EPT	GYP/EPT	-	6
B131	EXIST. SPECIAL EDUCATION	LVT	RB	PT	ACT/PAD	-	-
B132 B133	EXISTING CLOSET EXISTING VESTIBULE	LVT WC	RB -	ETR ETR	ETR BR/ETR	-	-
. 55	EXISTING LOBBY	LVT	RB	ETR/PT	ACT	9'-6"	-



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IGTON PUBLIC SCHOOLS - 2015 BON PROJECTS

OOK & BEECHVIEW ELEMENTARY S

BEECHVIEW ELEMENTARY SCHOOL

ROOM FINISH SCHEDULE

PRELIMINARY 
DESIGN DEVELOPMENT 
CONSTRUCTION 
FINAL RECORD


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DATE: December 12, 2017
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A7.2BV



	PLAN	OWNER					PLAN	OWNER			
QTY	NO.	NO.		MOUNTING	TEXT	QTY	NO.		TYPE	MOUNTING	TEXT
FI	RST	FLOOR	I	Г	Г		1	FLOOR		1	
-	-	_	-	-	-	1	A100	-	6	-	LINE1: BOILER LINE 2: ROOM
1	B127 B128	2 -	6	-	LINE 1: 2 LINE 1: BOYS	2	A101 A102	-	6	-	LINE 1: KITCHEN LINE 1: CUSTODIAL
1	B129	-	6	-	LINE 2: RESTROOM LINE 1: CUSTODIAL	1 -	A103	-	6 -	-	LINE 1: STORAGE
1	B130	-	5	-	LINE 1: GIRLS LINE 2: RESTROOM	1 1	A105 A106	25	1 6	-	LINE 1: 25 LINE 1: RESTROOM
1 -	B131 -	1	1 -	-	-	1 -	A107 A108	-	6	-	LINE 1: RESTROOM
-	-	-	-	-	-	1	A109	24	1	-	LINE 1: 24
2	B135	-	5	-	LINE 1: MAIN LINE 2: OFFICE	1	- A111	16	1	-	LINE 1: 16 LINE 2: OFFICE
1	B136 B137		6 7	-	LINE 1: CONFERENCE LINE 1: PRINCIPAL	1 1	A112 A113		1 5	-	LINE 1: 17 LINE 1: KILN
1	B138 B139		6	-	- LINE 1: CONFERENCE	1	A114	23	1	-	LINE 2: ROOM LINE 1: 23
1 -	B140	-	6	-	LINE 1: STORAGE	1 1	A115 A116		6	-	LINE 1: RESTROOM
1	B142	-	5	-	LINE 1: PTA LINE 2: STORAGE	- 1	- A118	-	<u>-</u> 1	-	- LINE 1: 22
1 2	B143 B144		6 6	-	LINE 1: STORAGE LINE 1: CAFETERIA	-	-	-	-	-	-
1	B145	-	5	-	LINE 1: STAFF	1 1	- A121	-	- 6	-	LINE 1: RESTROOM
1	B146	-	5	-	LINE 2: RESTROOM LINE 1: STAFF LINE 2: RESTROOM	1 1 1	A122 A123 A124	- 18 19	6 1 1	-	LINE 1: RESTROOM LINE 1: 18 LINE 1: 19
-	B147	-	-	-	-	- 1	- A126	- 21	- 1	-	- LINE 1: 21
1	B149	14	1	-	LINE 1: 14	-	A127 A128	-	6	-	LINE 1: STORAGE LINE 1: RESTROOM
1	- B151	-	6	-	LINE 1: STORAGE	-	A129	-	-	-	-
<u>1</u>	B152	-	6	-	LINE 1: SURVERY	1 1	A130 A131	20	6	-	LINE 1: 20 LINE 1: STORAGE
	B172 B176		1 1	- - -	LINE 1: 12 LINE 1: 13	-	A132 -	-	6 - -	-	LINE 1: RESTROOM -
	, . <del>.</del>		<u>,</u>	•	•	-	-	-	-	-	-
						1	A136 A137	-	6 6	-	LINE 1: MECHANICALINE 1: GYMNASIUI
						-	A138 A139		5 6	-	LINE 1: PERFORMA LINE 2: PLATFORM LINE 1: STORAGE
						1	A140	-	2	-	_
						1 1 1	A141 A142 A143		6 6	-	LINE 1: CUSTODIAL
						-	A144	-	-	-	-
						1	A145	-	5	-	LINE 1: COMPUTER LINE 2: LAB
						1	A146 A147	-	5	-	LINE 1: MEDIA LINE 2: CENTER LINE 1: MDF
						1	A148 A149	-	6	-	LINE 2: ROOM LINE 1: CONFEREN LINE 1: OFFICE
							A 149	-	-	-	-
						1	A151 A152	-	6 6	-	LINE 1: RESTROOM
						1	A153		1	-	LINE 1: 15 LINE 1: OFFICE
						1	A154	-	6 	-	LINE 1: CUSTODIAL
						1	B102	-	5	-	LINE 1: WORK LINE 2: ROOM
						1	B103	8	1	-	LINE 1: 8 LINE 2: OFFICE
						- 1	- B106	7	<u>-</u> 1	-	- LINE 1: 7
						- 1	- B108	9	1	-	- LINE 1: 9
						1	- B110	6	<u>-</u> 1	-	LINE 1: 7
						- 1	- B112	10	- 1	-	- LINE 1: 9
						- 1	- B114	5	<u>-</u> 1	-	- LINE 1: 5
						- 1	- B116	<u>-</u> 11	<u>-</u> 1	-	- LINE 1: 11
						- 1	B116 - B118	- 4	1 - 1	-	LINE 1: 11 - LINE 1: 4
						-	-	-	-	-	-
						- 1	- - R122	- ·	- -	-	- - I INE 1: 3
						-	B122 -	3	1 -	-	LINE 1: 3
						-	_		-	-	=



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FARMINGTON PUBLIC SCHOOLS - 2015 BOND

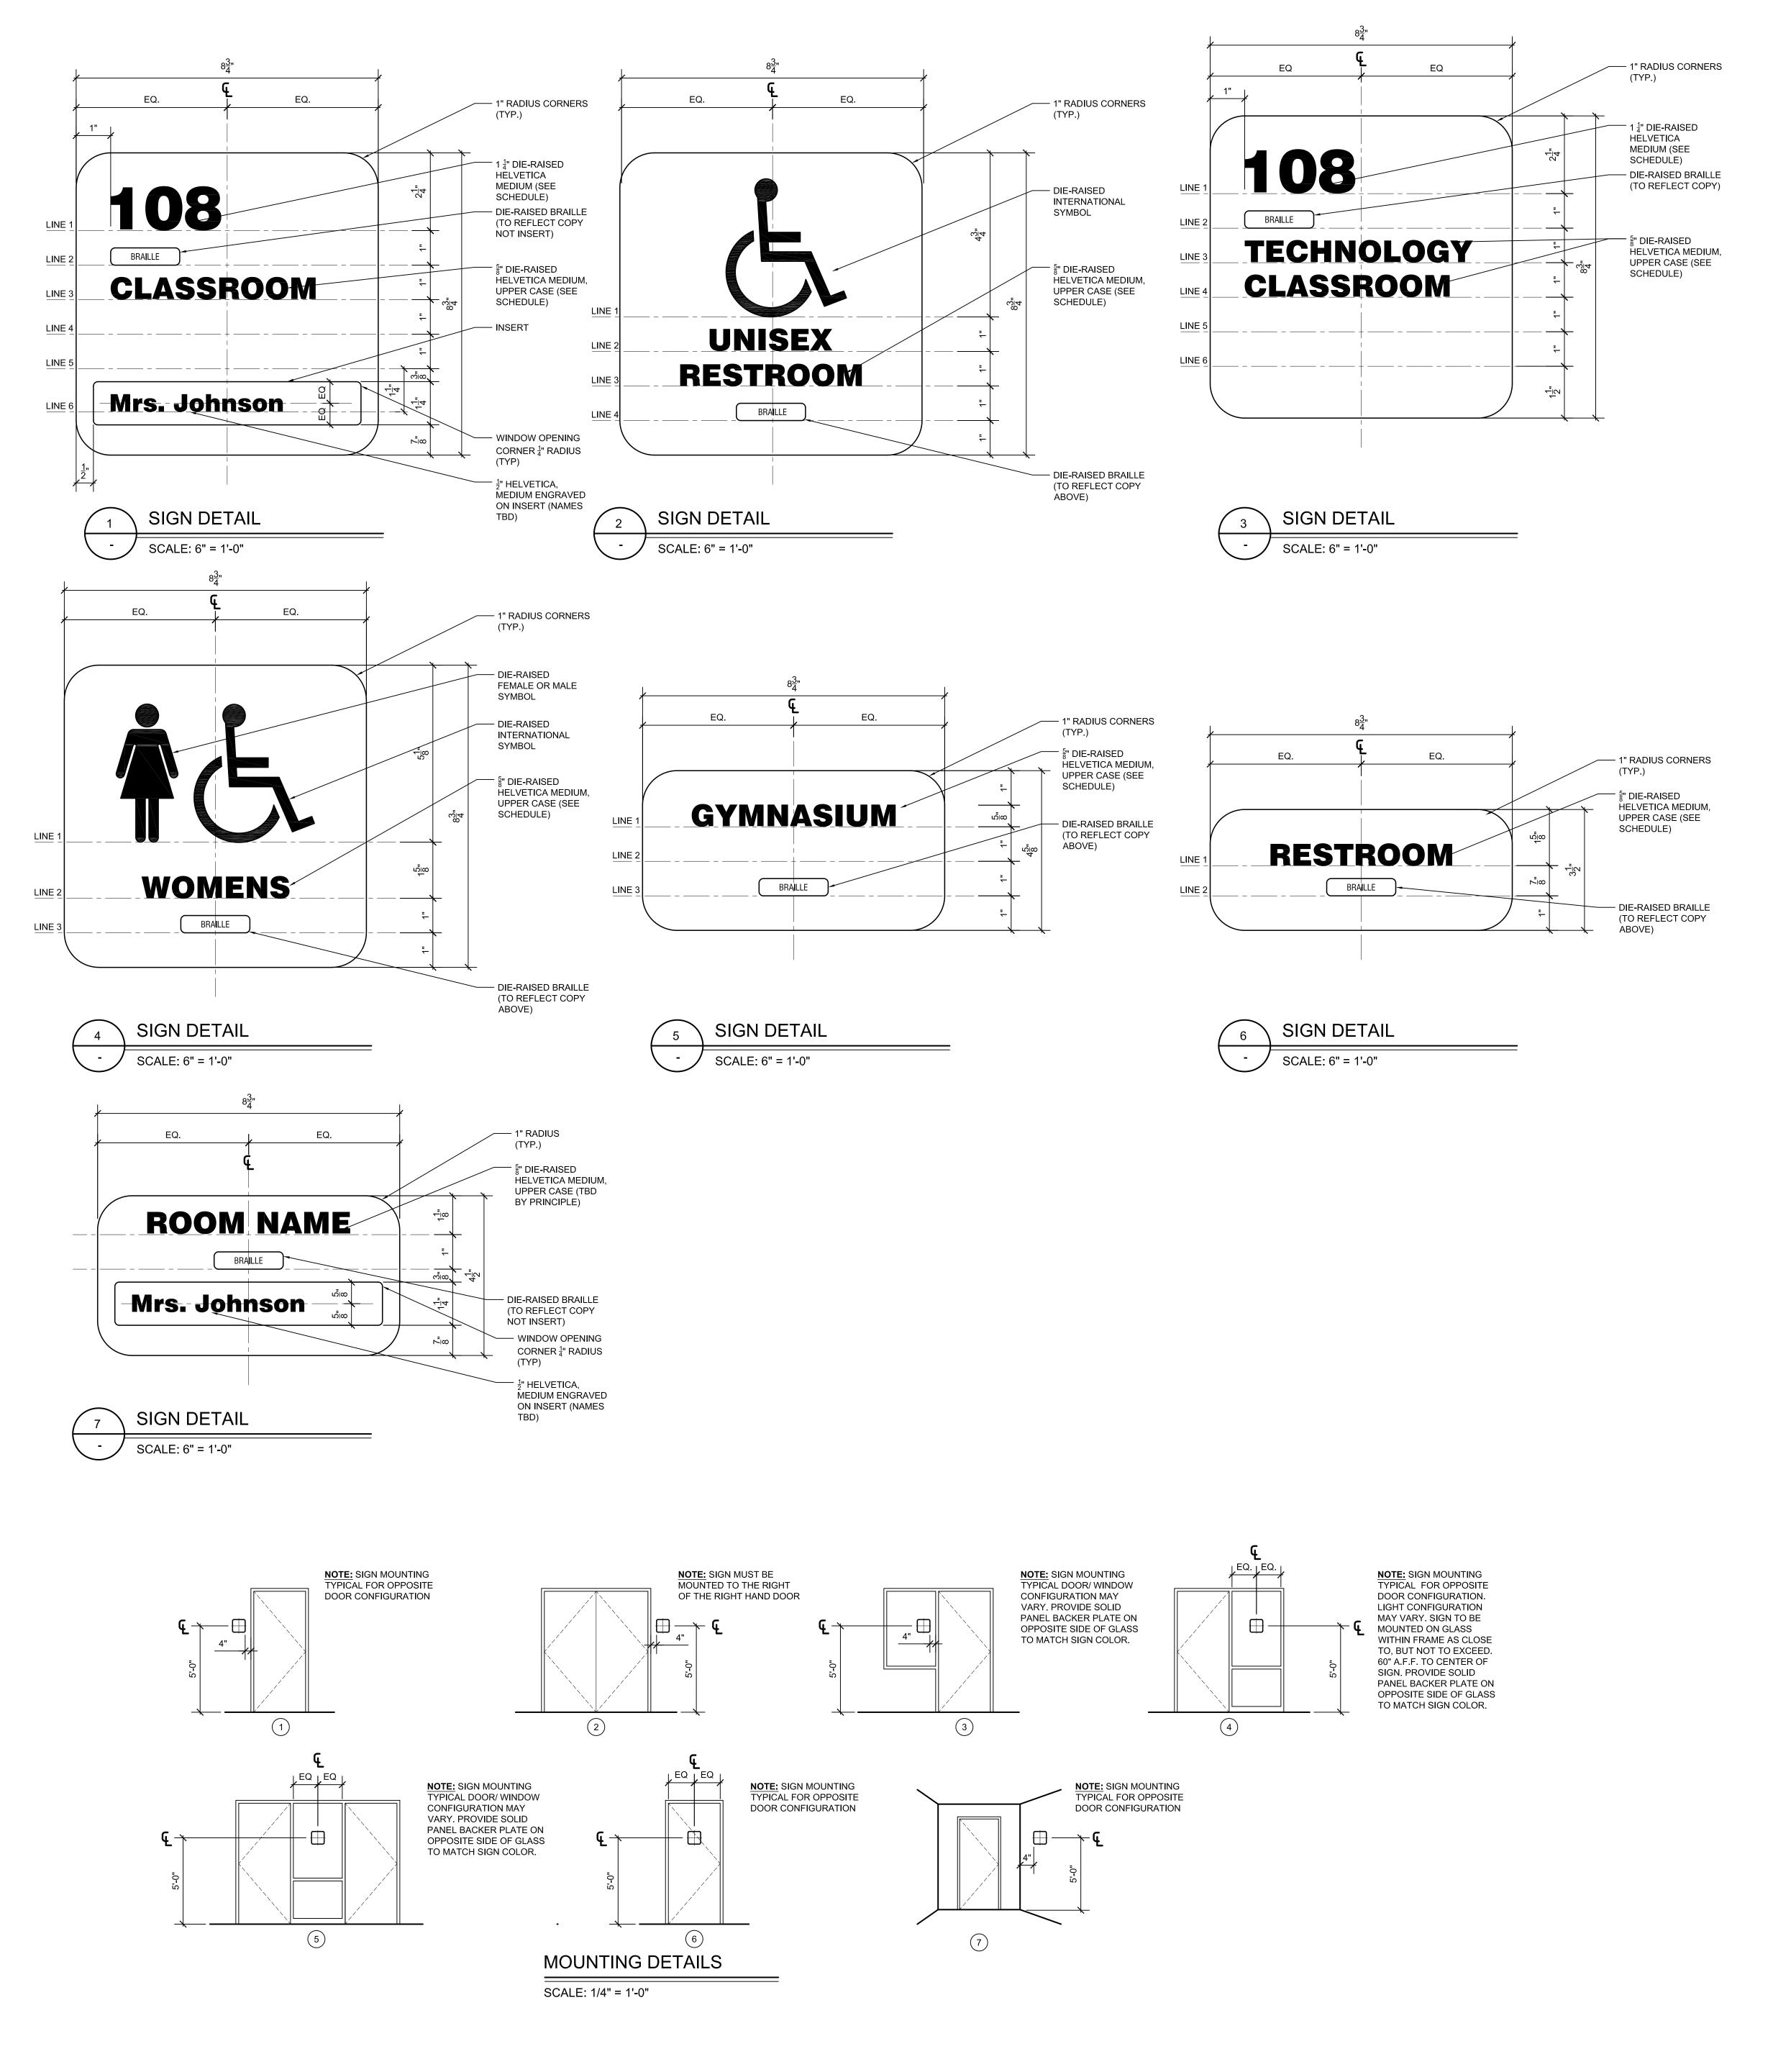2018 PROJECTS

KENBROOK & BEECHVIEW ELEMENTARY SCHOOL

BEECHVIEW ELEMENTARY SCHOOL SIGNAGE SCHEDULE AND DETAILS

PRELIMINARY 
DESIGN DEVELOPMENT 
CONSTRUCTION


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ARCHITECTURAL SITE PLAN SCALE: 1/32" = 1'-0"

SITE PLAN NEW WORK KEY NOTES:

- 1 REMOVE AND REPAIR PARKING LOT PROVIDE NEW PAVEMENT AS INDICATED ON CIVIL DRAWINGS
- 2 R/R CONCRETE SIDEALKS
- (3) FIX DRAINAGE AT COURTYARD
- FIX DRAINAGE @ PLAYGROUND ADD NEW DRYWELL, BIOSWAL, AND EXTEND 7 ROOF CONDUCTORS.
- 5 NEW PLAYGROUND EQUIPMENT
- 6 R/R PAVEMENT- PROVIDE NEW HEAVY DUTY PAVEMENT AT BUS LOOP AS INDICATED ON CIVIL DRAWINGS
- 7) JOINT SEAL, SEAL COAT, AND RESTRIPE PARKING LOT
- 8 REMOVE AND REPLACE EXISTING PLAY PAD. RESTRIPE TO MATCH EXISTING GAME STRIPING.
- 9 REGRADE BACK LAWN FOR DRAINAGE.
- (10) REDESIGN CONCRETE SIDEWALK AT ENTRY FOR NEW DESIGN. (FINAL DESIGN TDB.)
- (11) REMOVE AND REPLACE EXISTING BITUMINOUS WALKS
- (12) CONCRETE PAVEMENT REMOVE AND REPAIR
- 13 EXTEND CULVERT
- REMOVE AND REINSTALL VERTICAL SUPPORTS AT PICNIC TABLES. CONFIRM LOCATIONS WITH OWNER
- REMOVE REPLACE EXISTING WOOD DUMPSTER SURROUND.
  REPLACE EXISTING 1 FOR 1. REUSE EXISTING GALVANIZED METAL
- PROVIDE ALTERNATE FOR FULL REPLACEMENT OF EXISTING WATER MAIN.



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2015 BON SCHOOLS

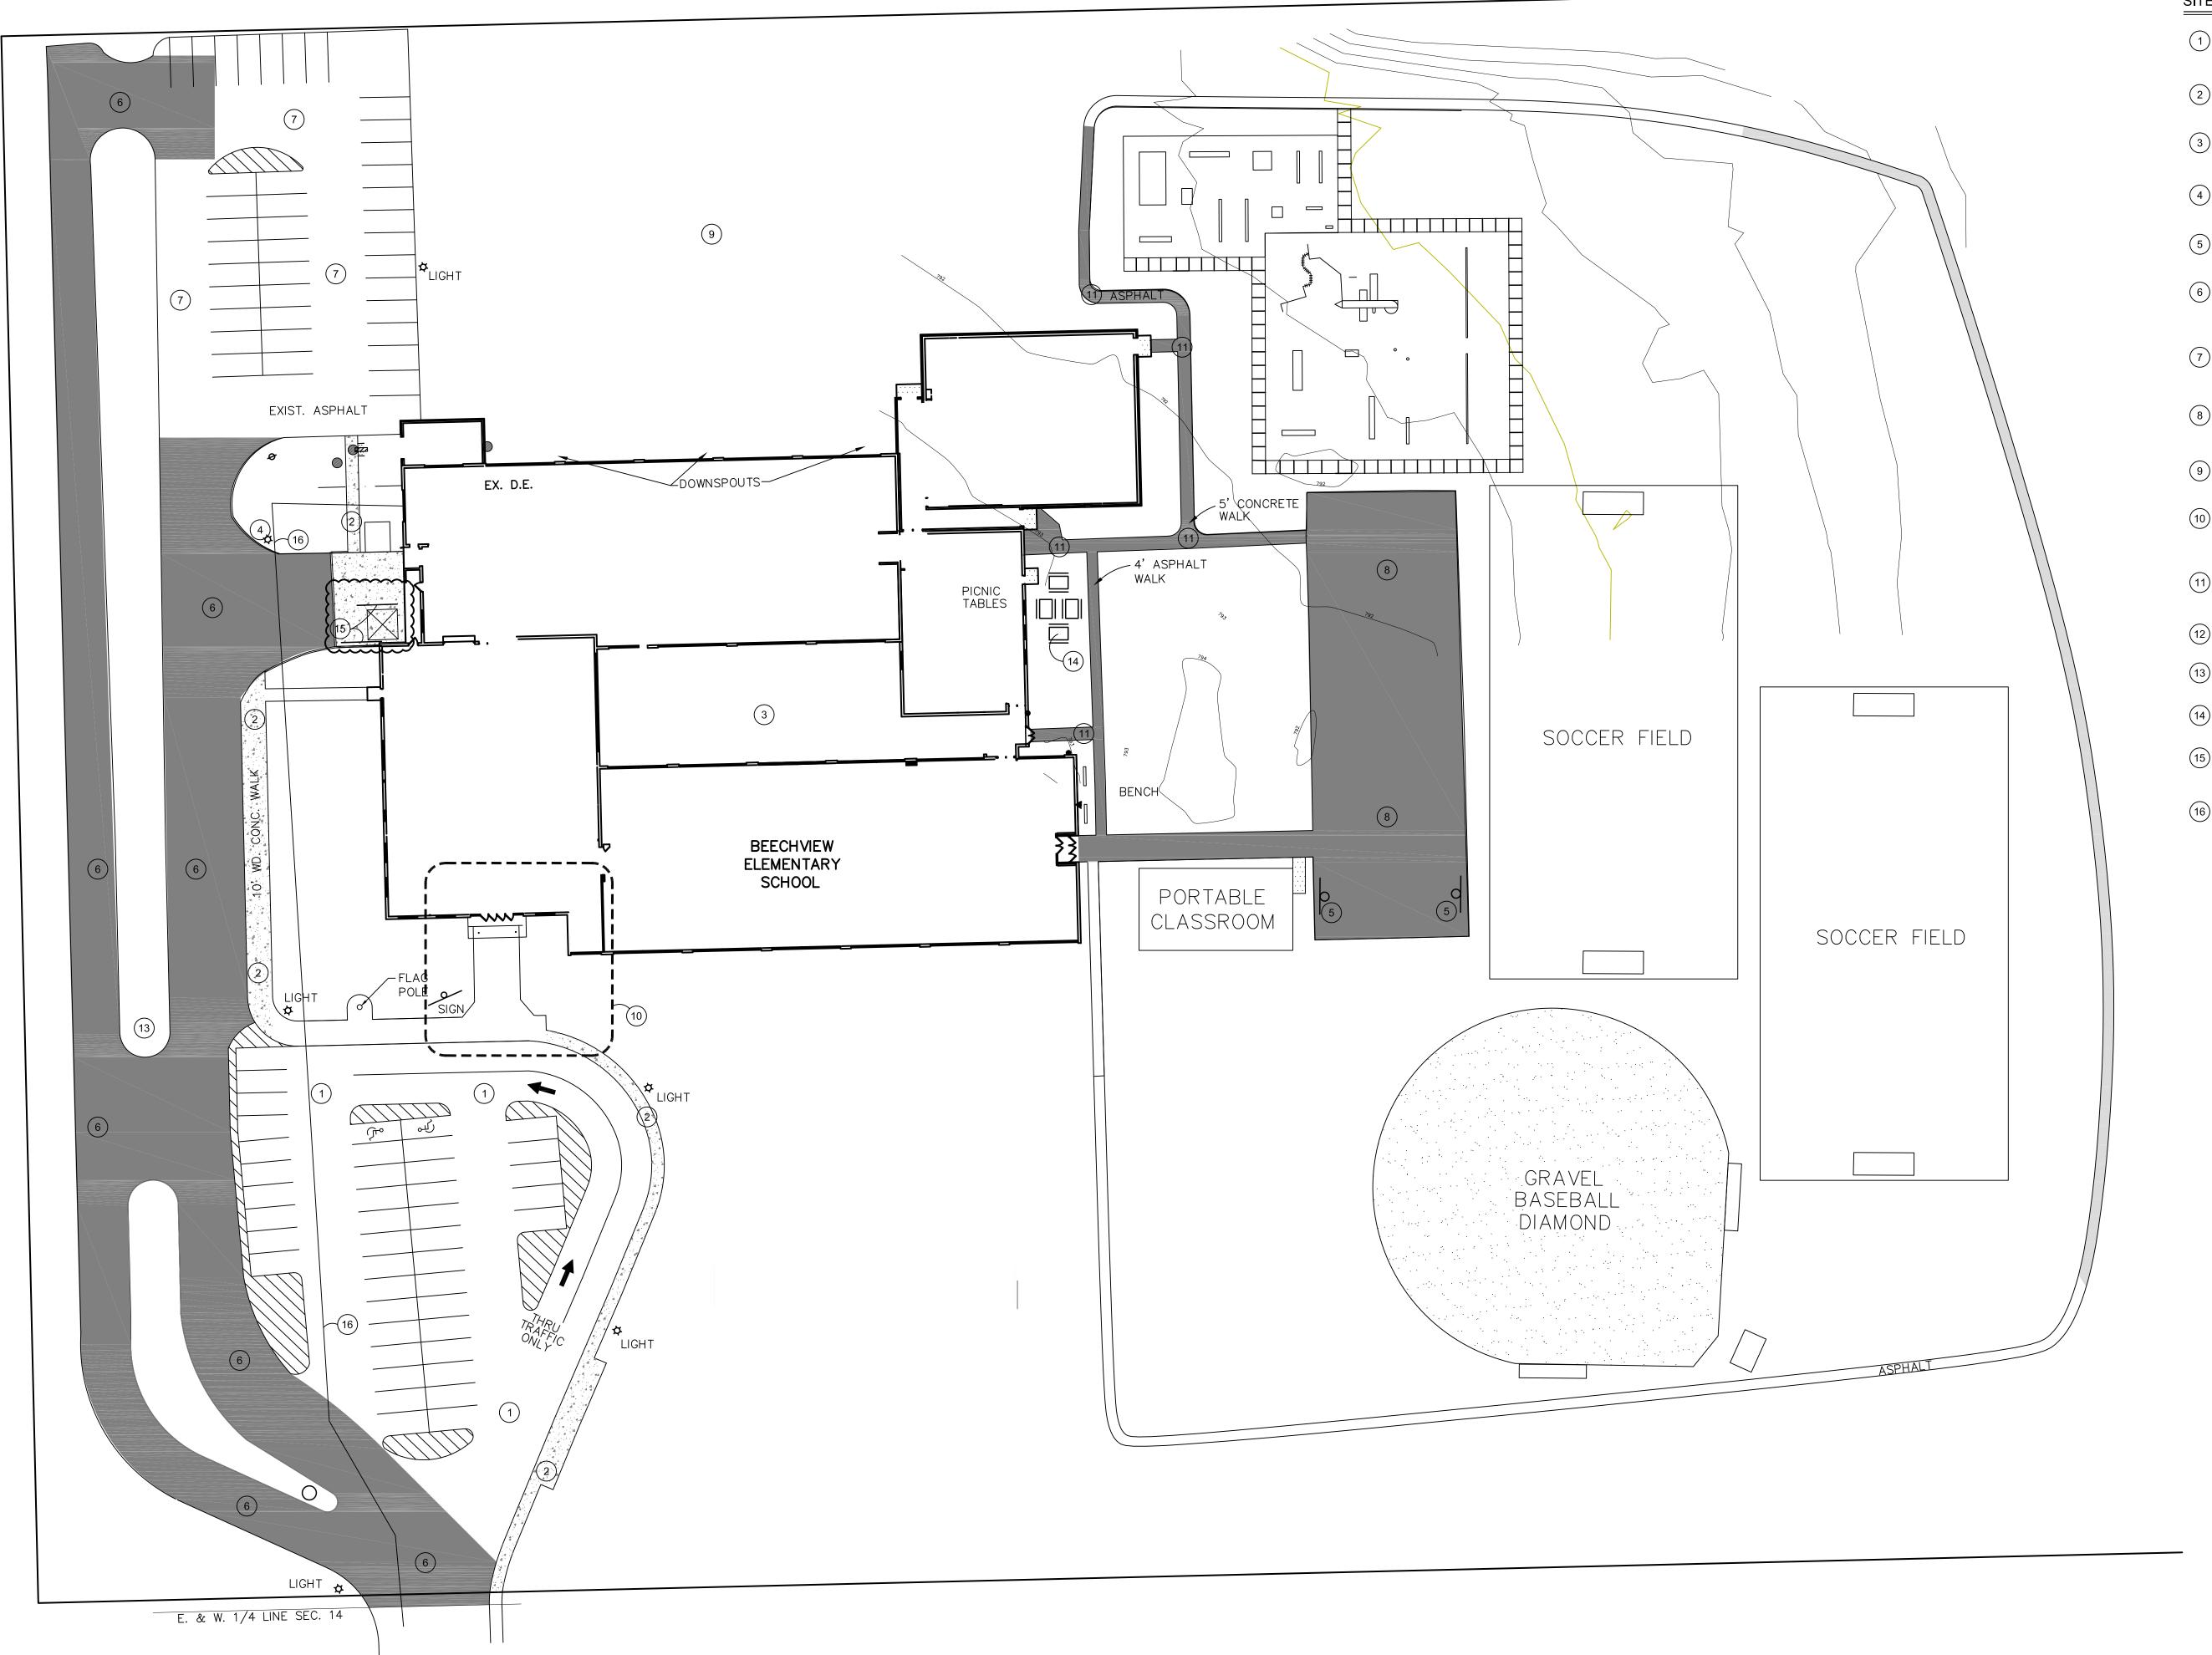BEECHVIEW ELEMENTARY SCHOOL


ARCHITECTURAL SITE PLAN


PRELIMINARY DESIGN DEVELOPMENT CONSTRUCTION

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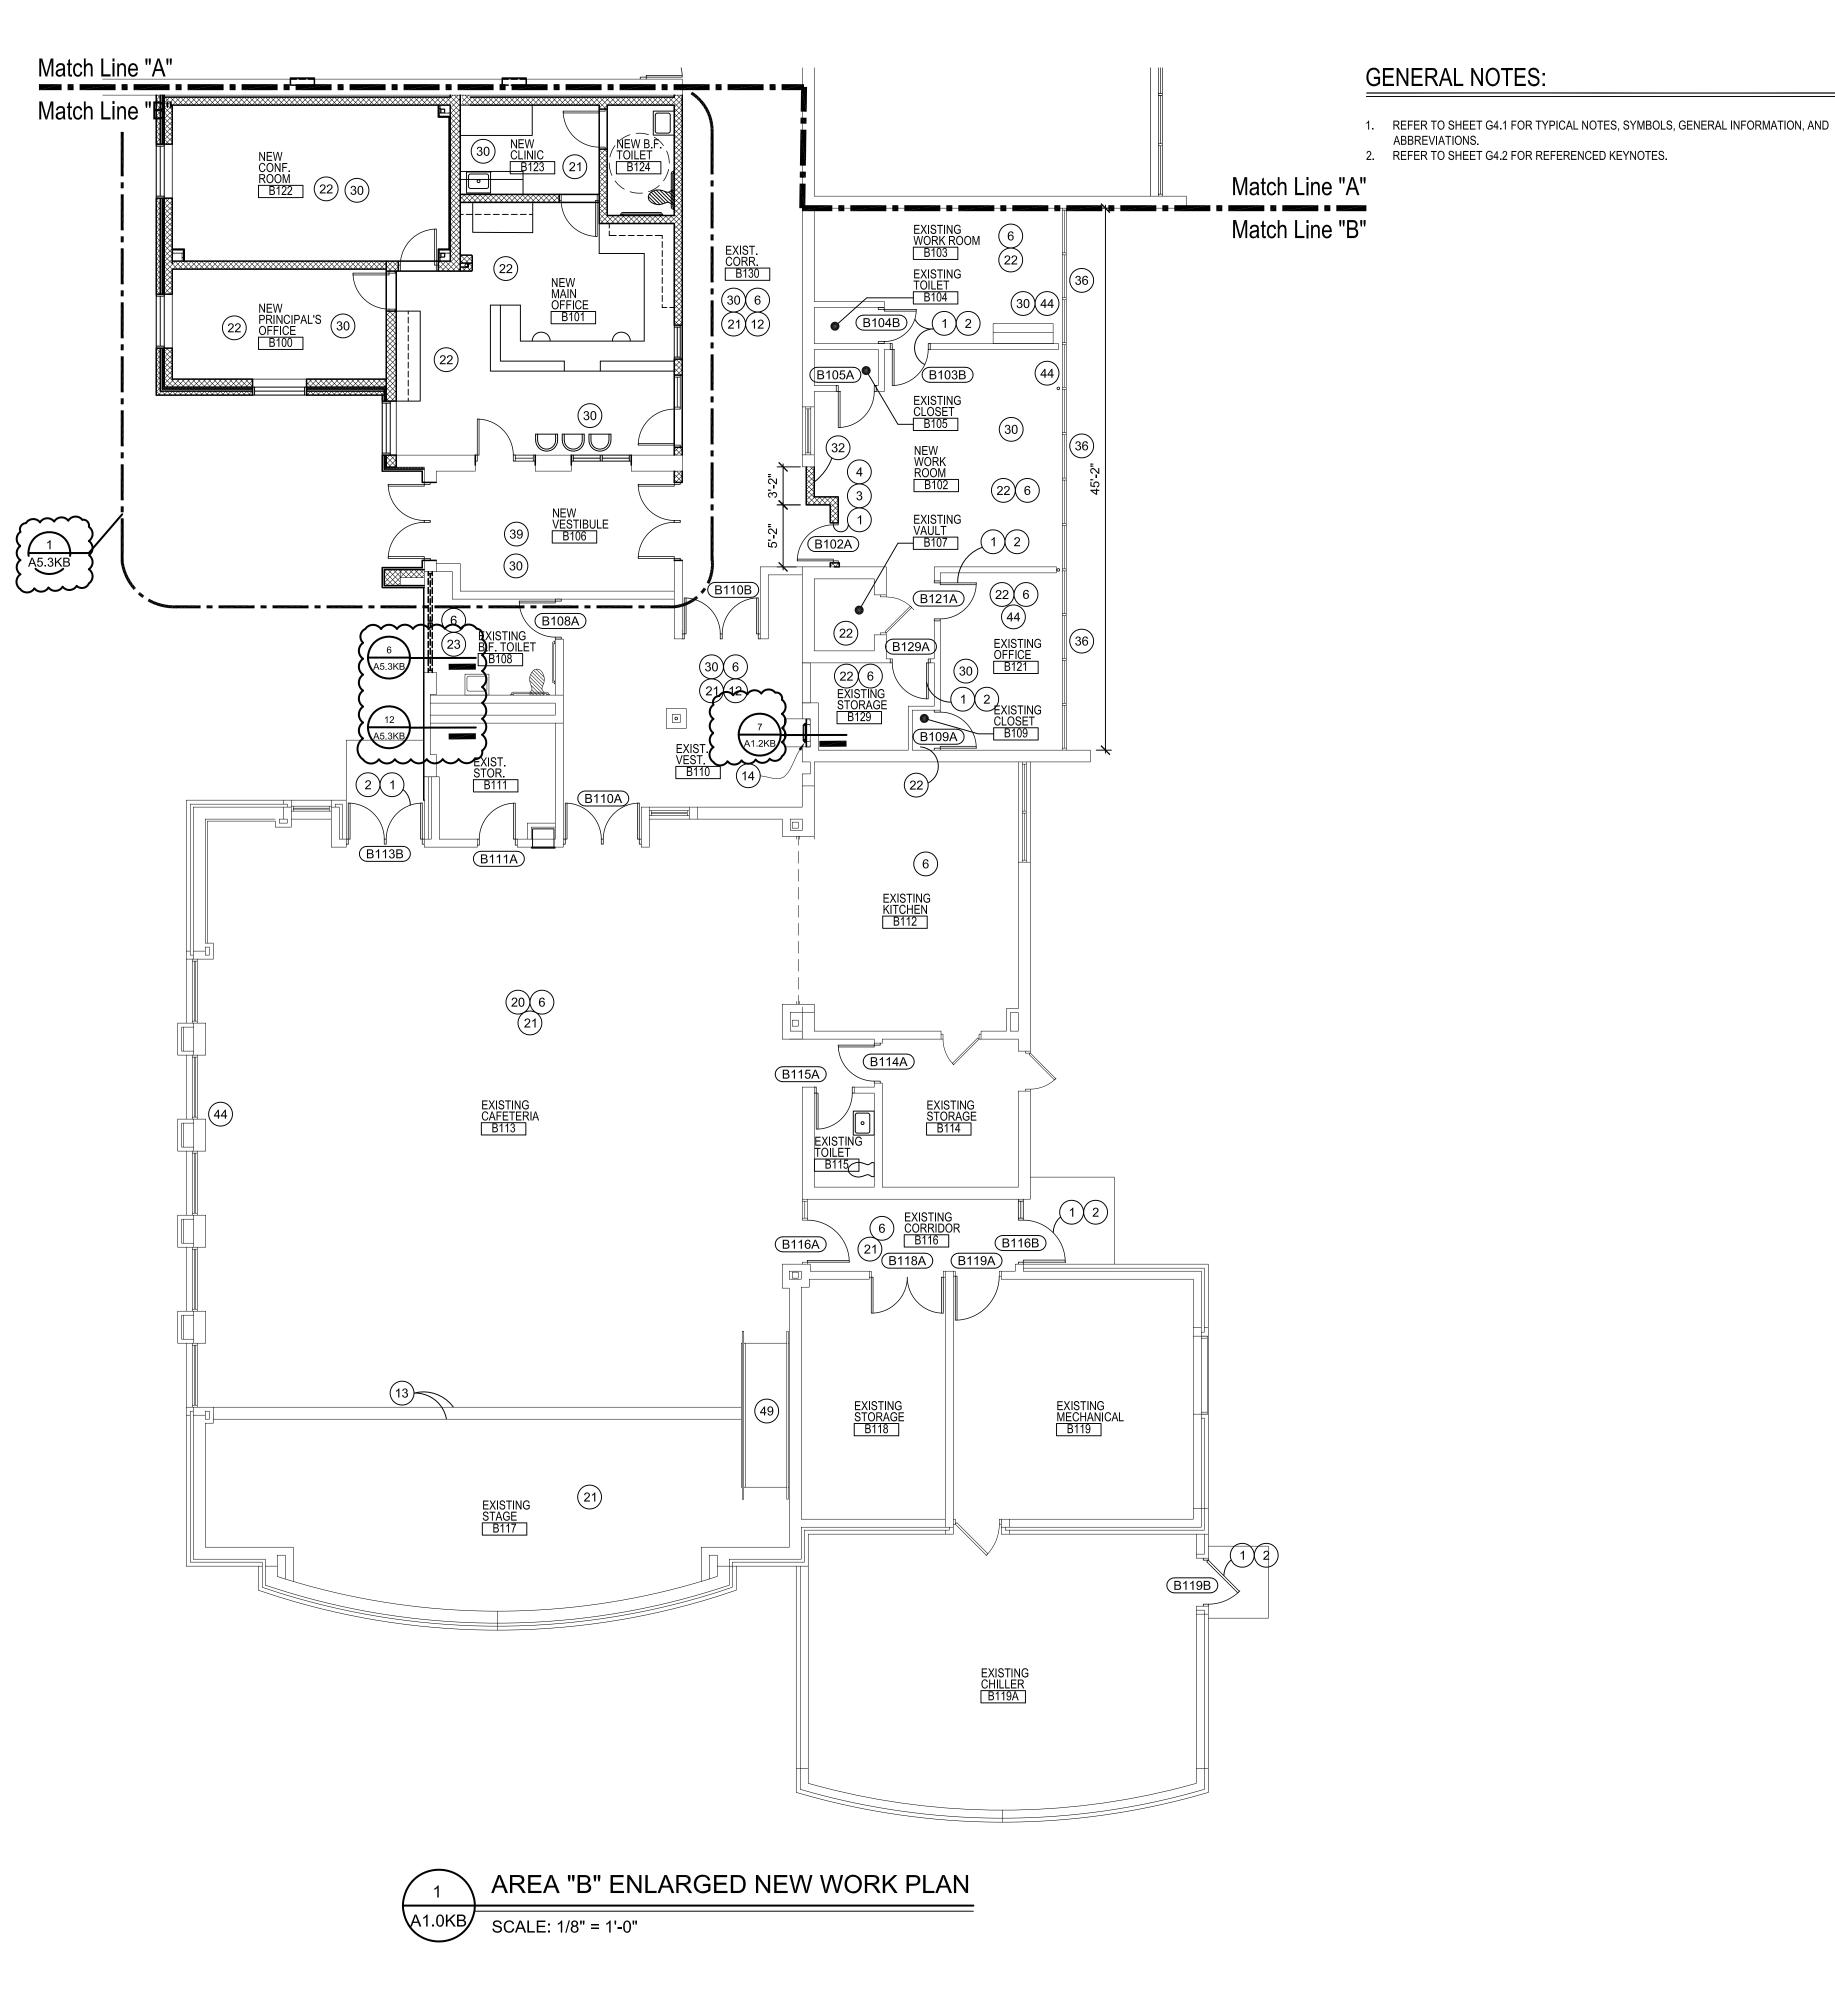



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SCALE: 1/4" = 1'-0"

SINGLE TOILET

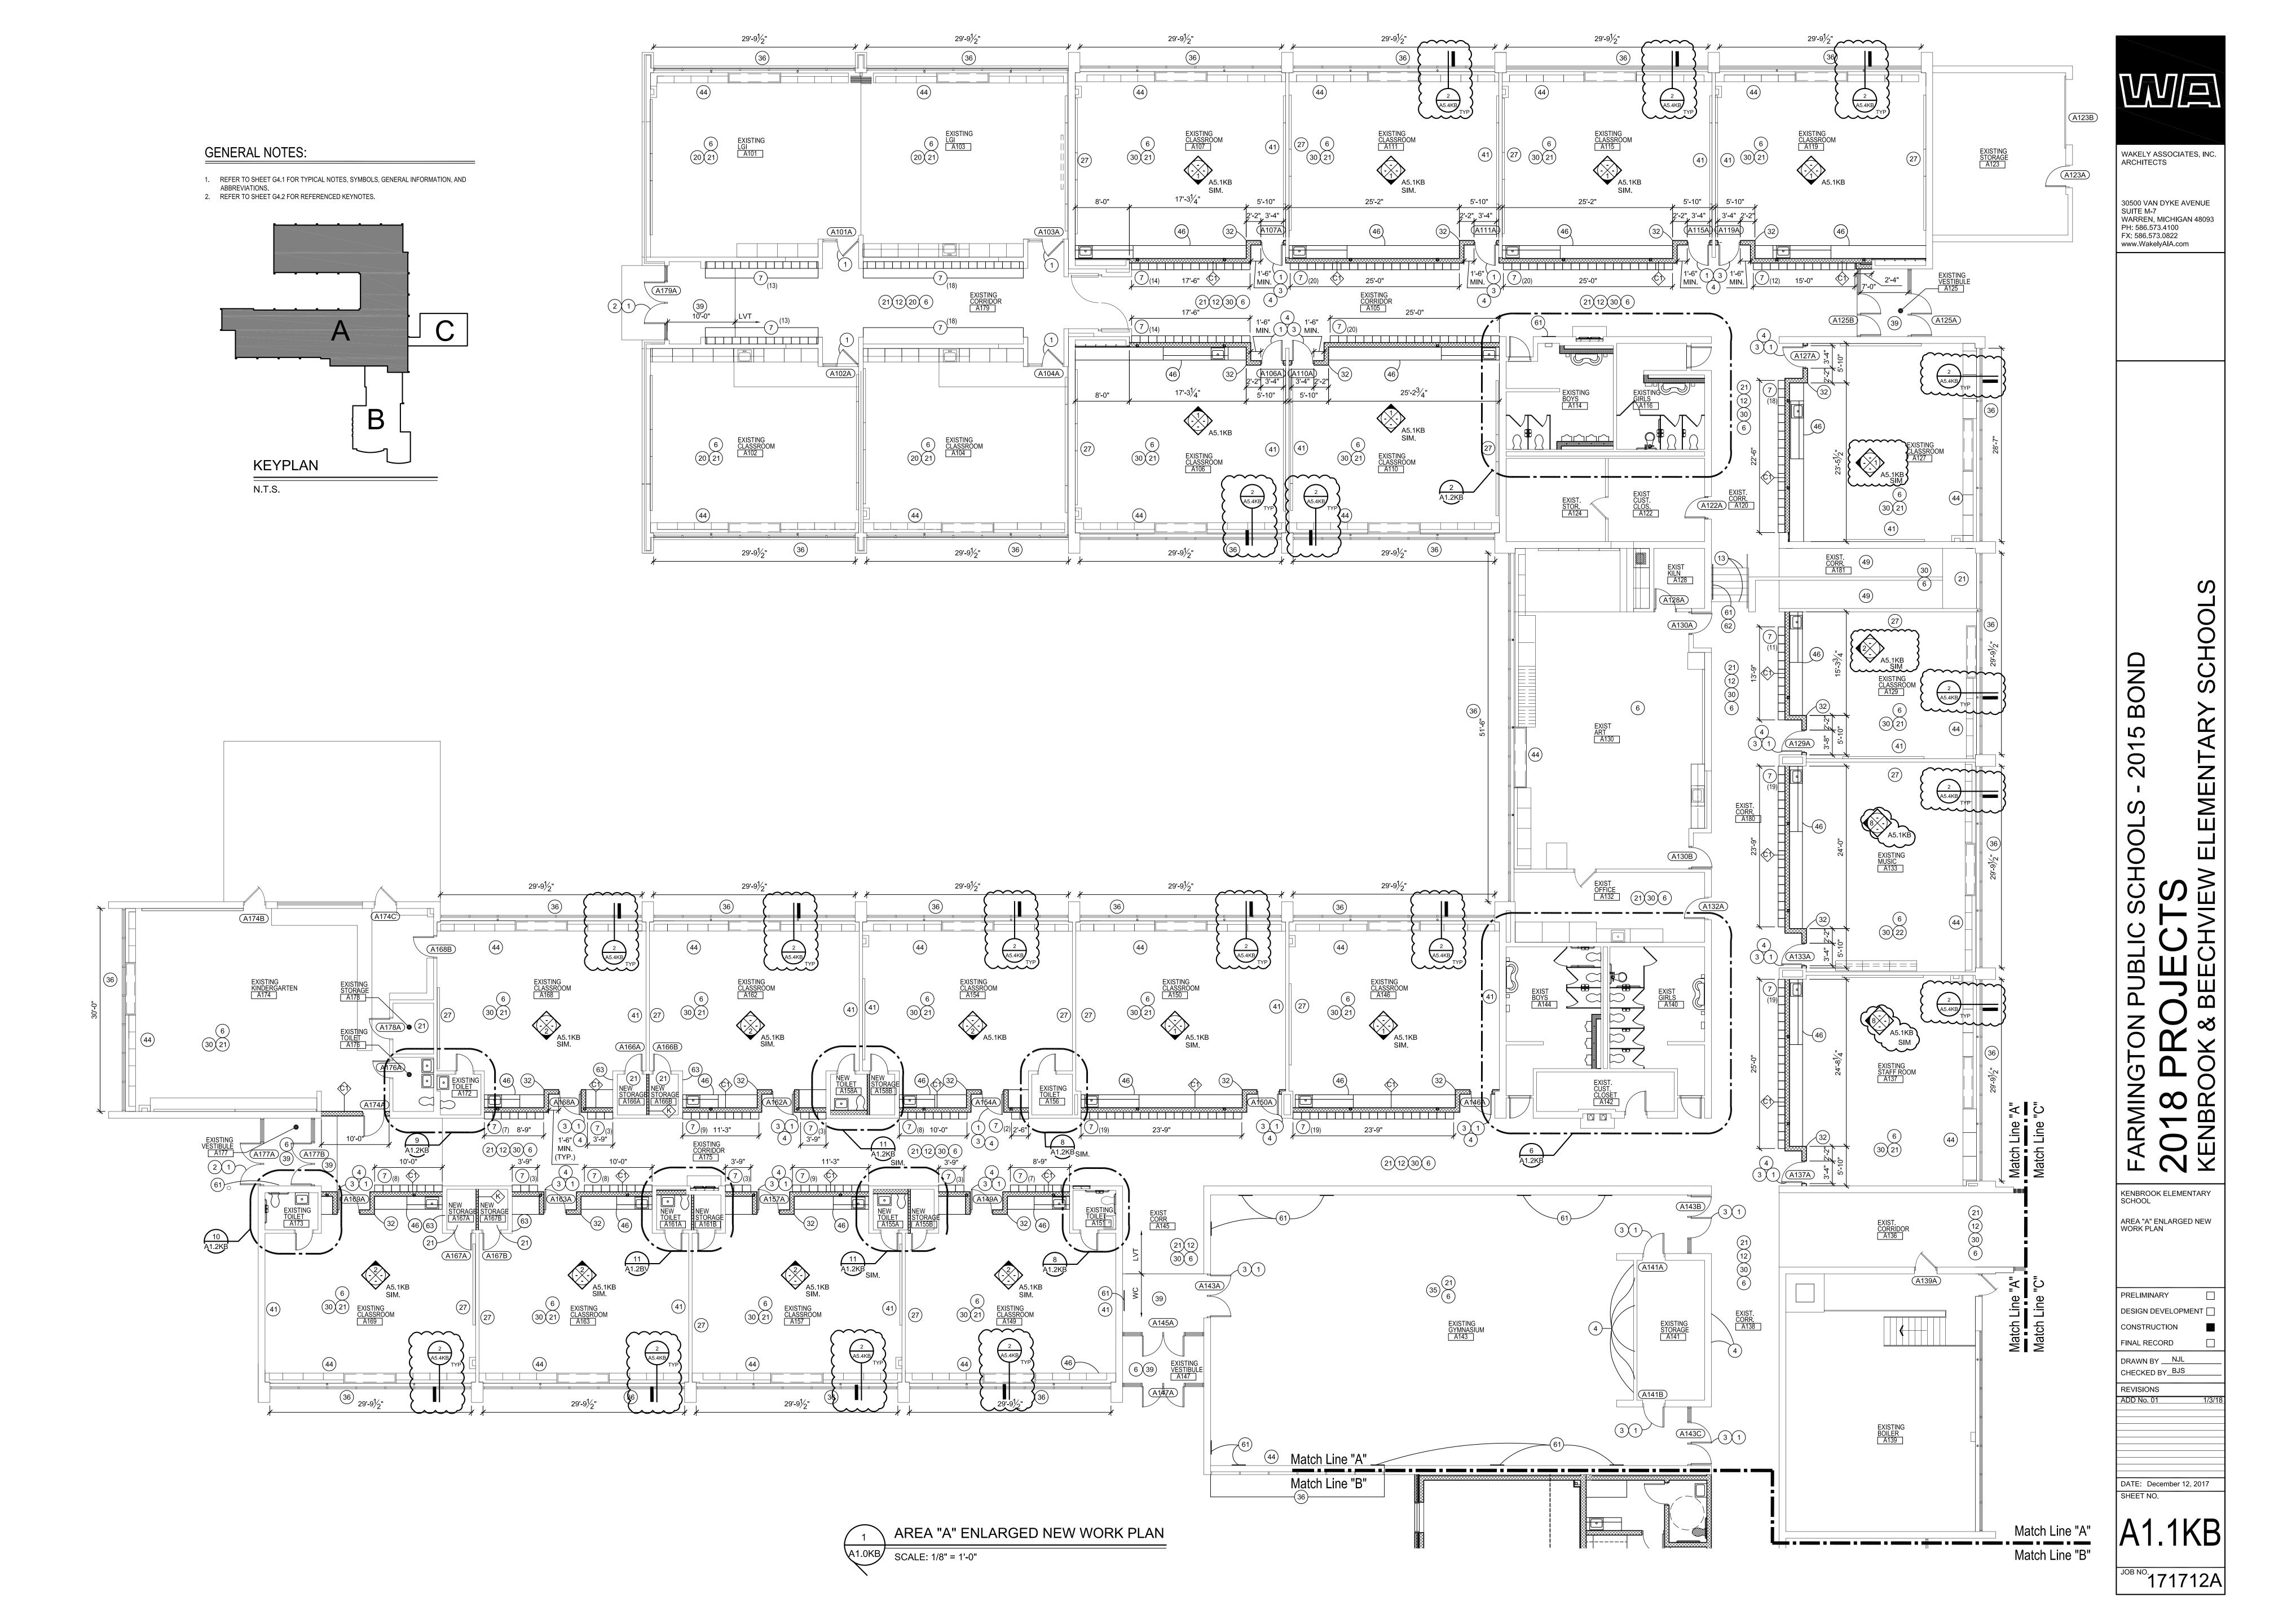SCALE: 1/2" = 1'-0"

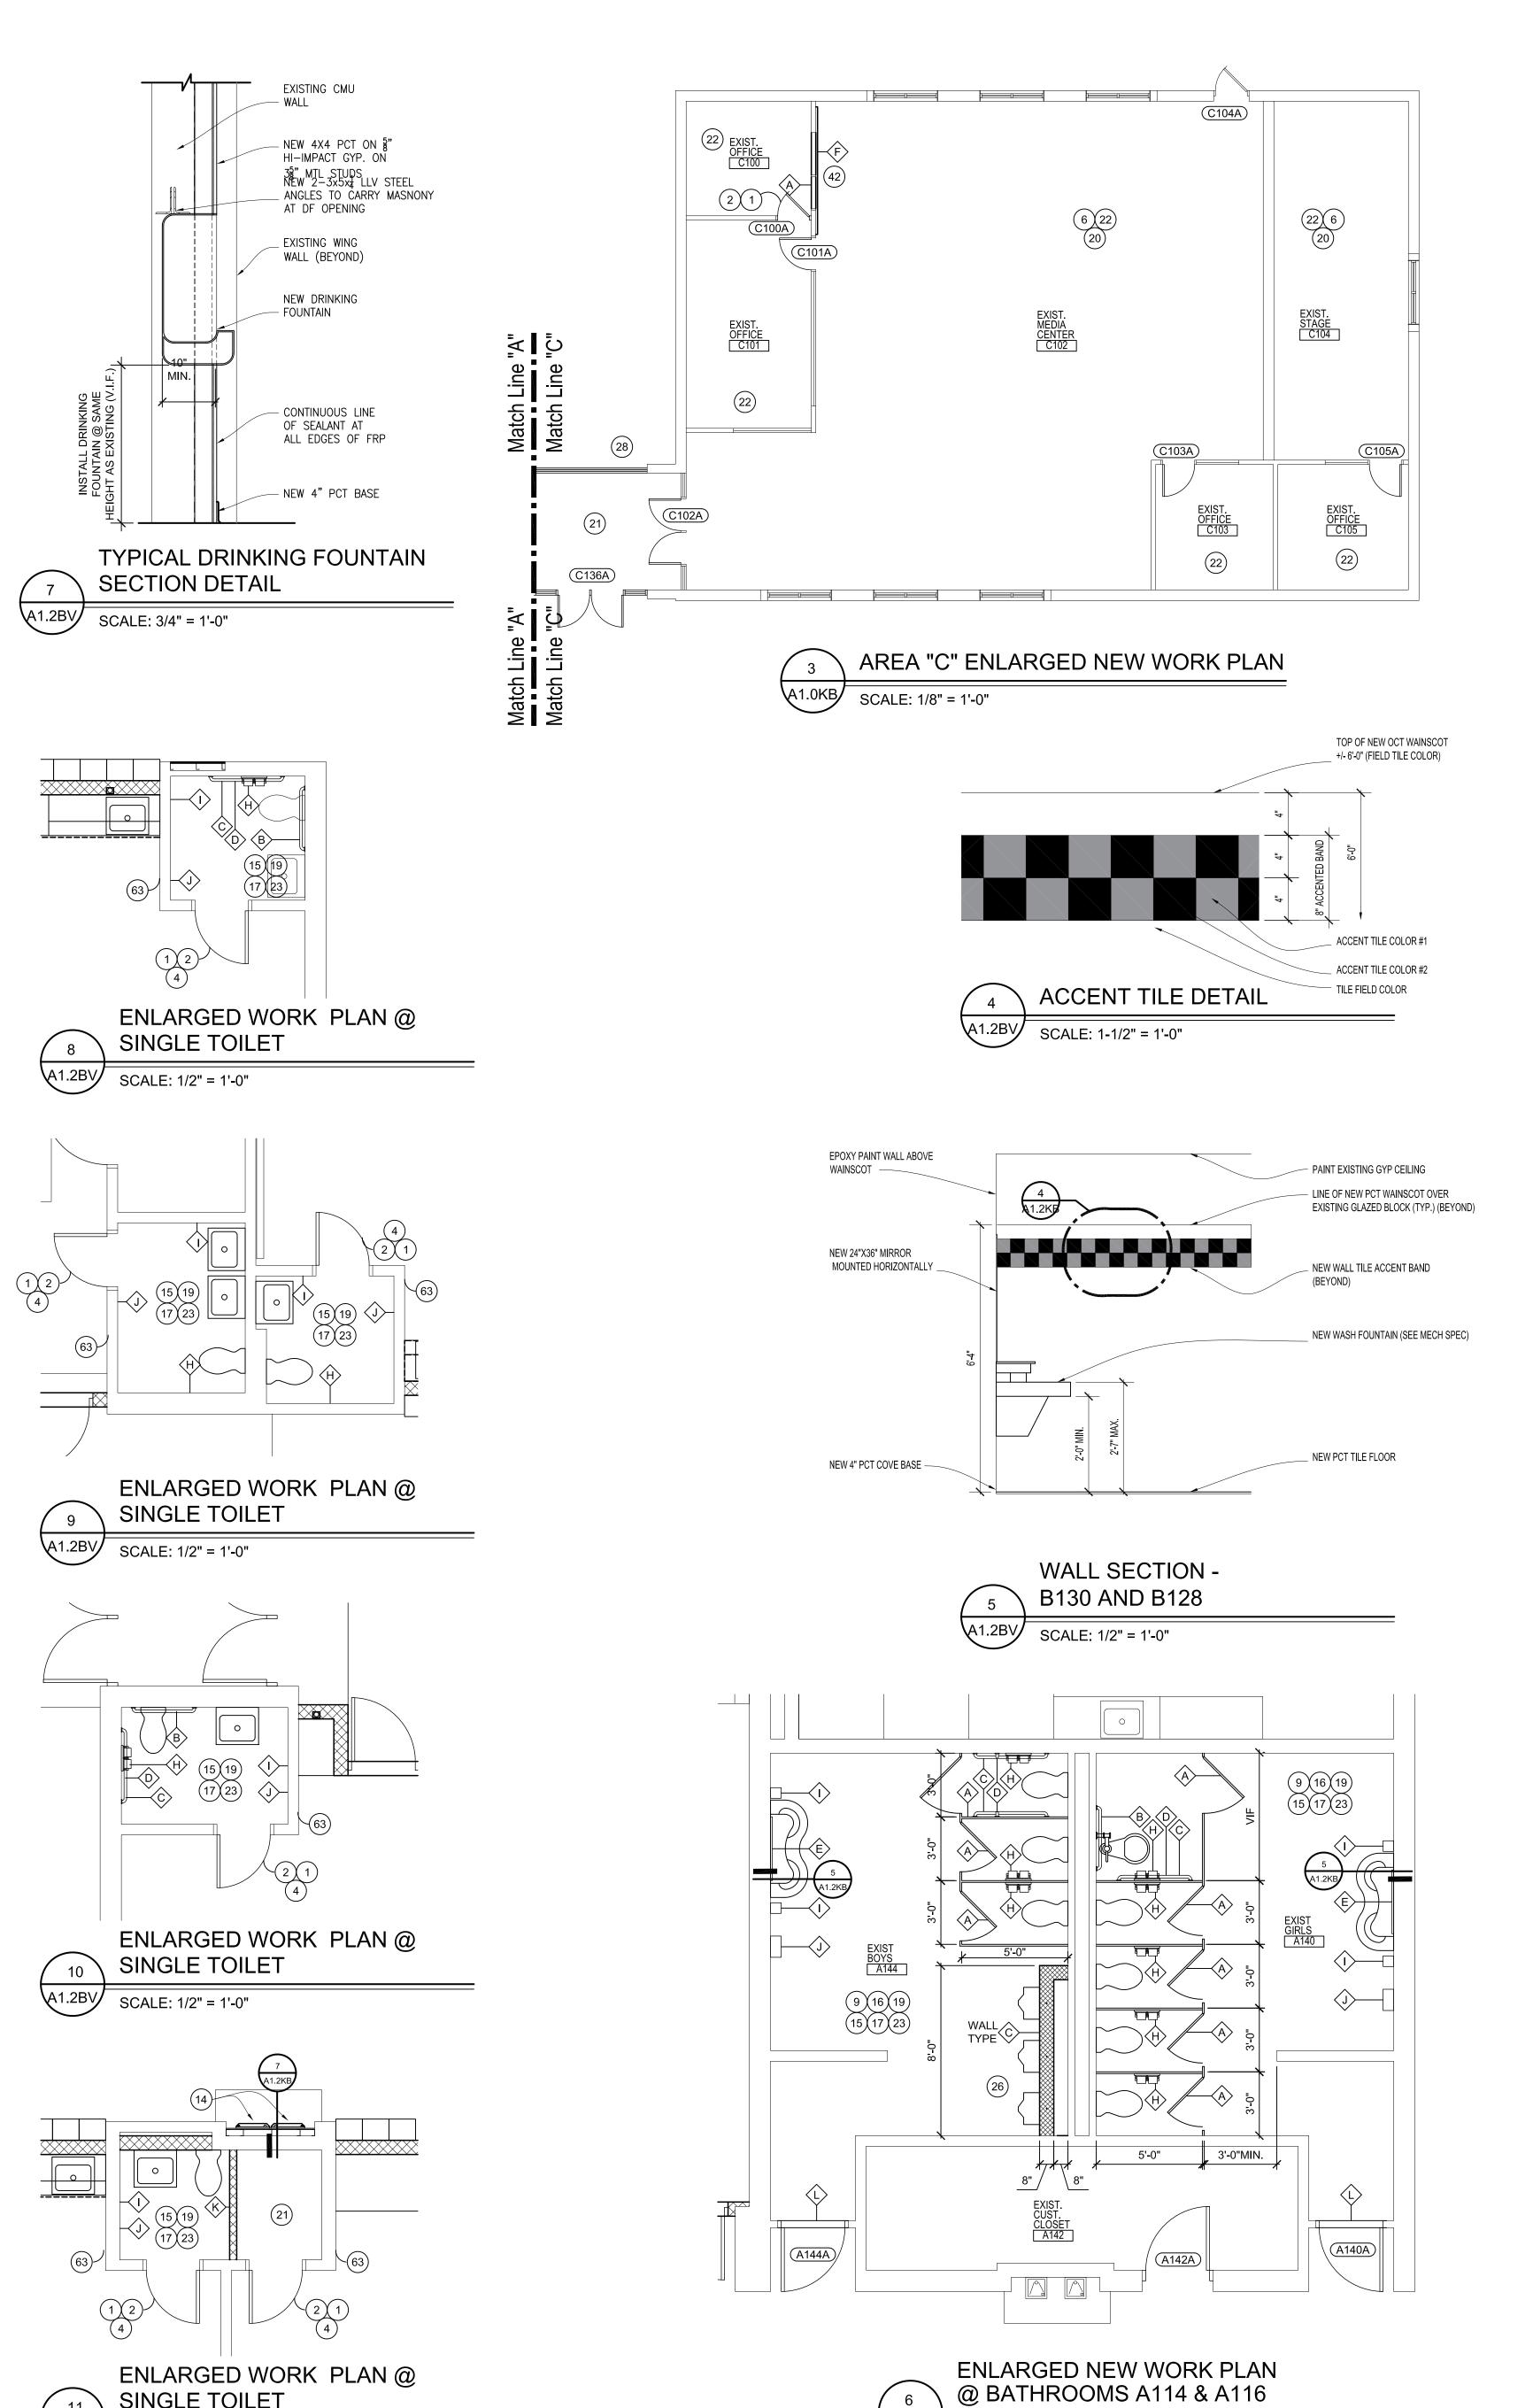

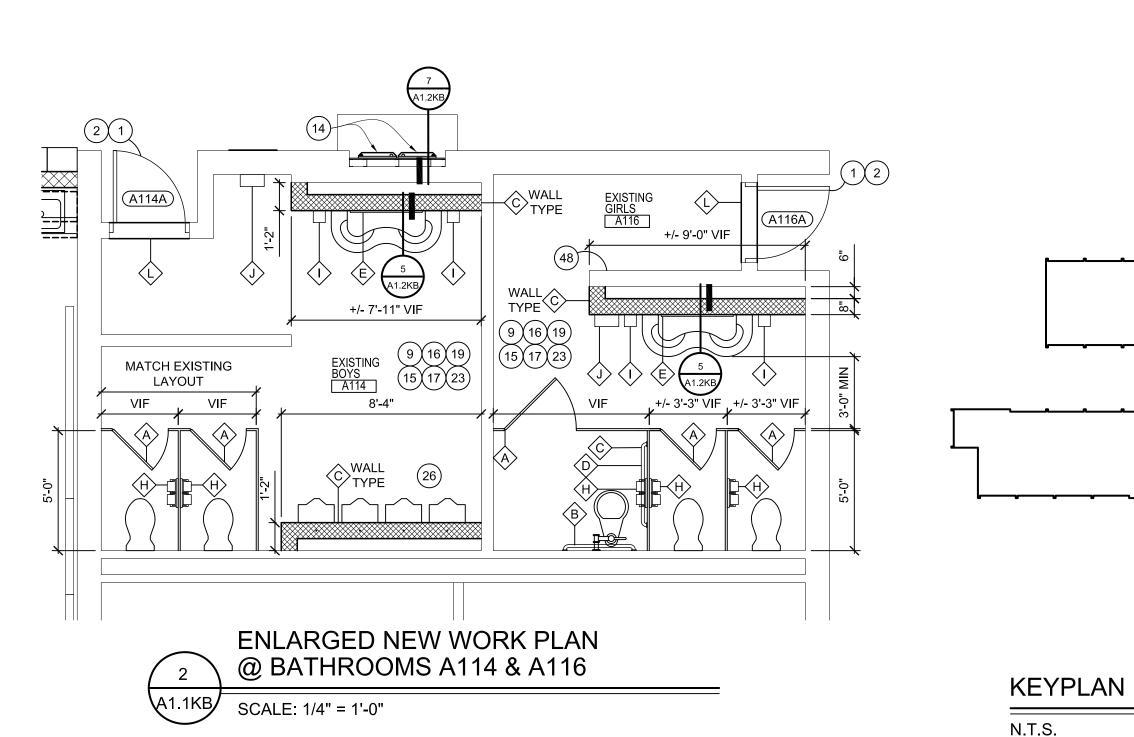

TOILET ACCESSORY LEGEND:

A TOILET PARTITION

B 36" GRAB BAR

C 42" GRAB BAR

⟨E⟩ 36" x 36" MIRROR

(F) URINAL SCREEN

G 24" x 36" MIRROR

(H) TOILET PAPER HOLDER (BY OWNER)


J PAPER TOWEL DISPENSER (BY OWNER)

⟨I⟩ SOAP DISPENSOR (BY OWNER)

K SANITARY NAPKIN DISPOSAL

(L) MARBLE THRESHOLD

D 18" VERTICAL GRAB BAR

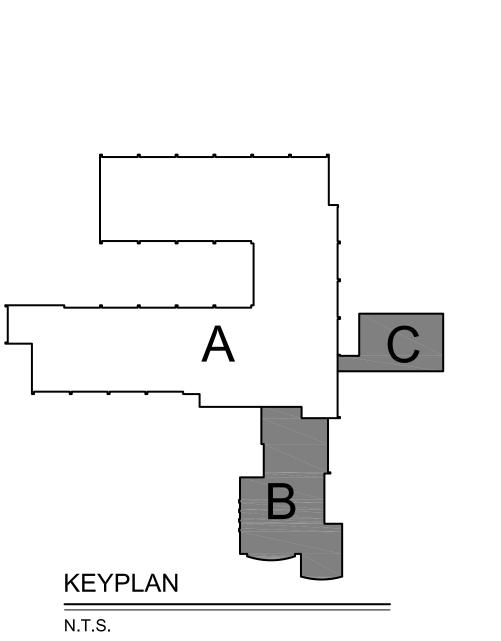

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KENBROOK ELEMENTARY SCHOOL AREA "B" & "C" ENLARGED NEW WORK PLANS

PRELIMINARY DESIGN DEVELOPMENT CONSTRUCTION


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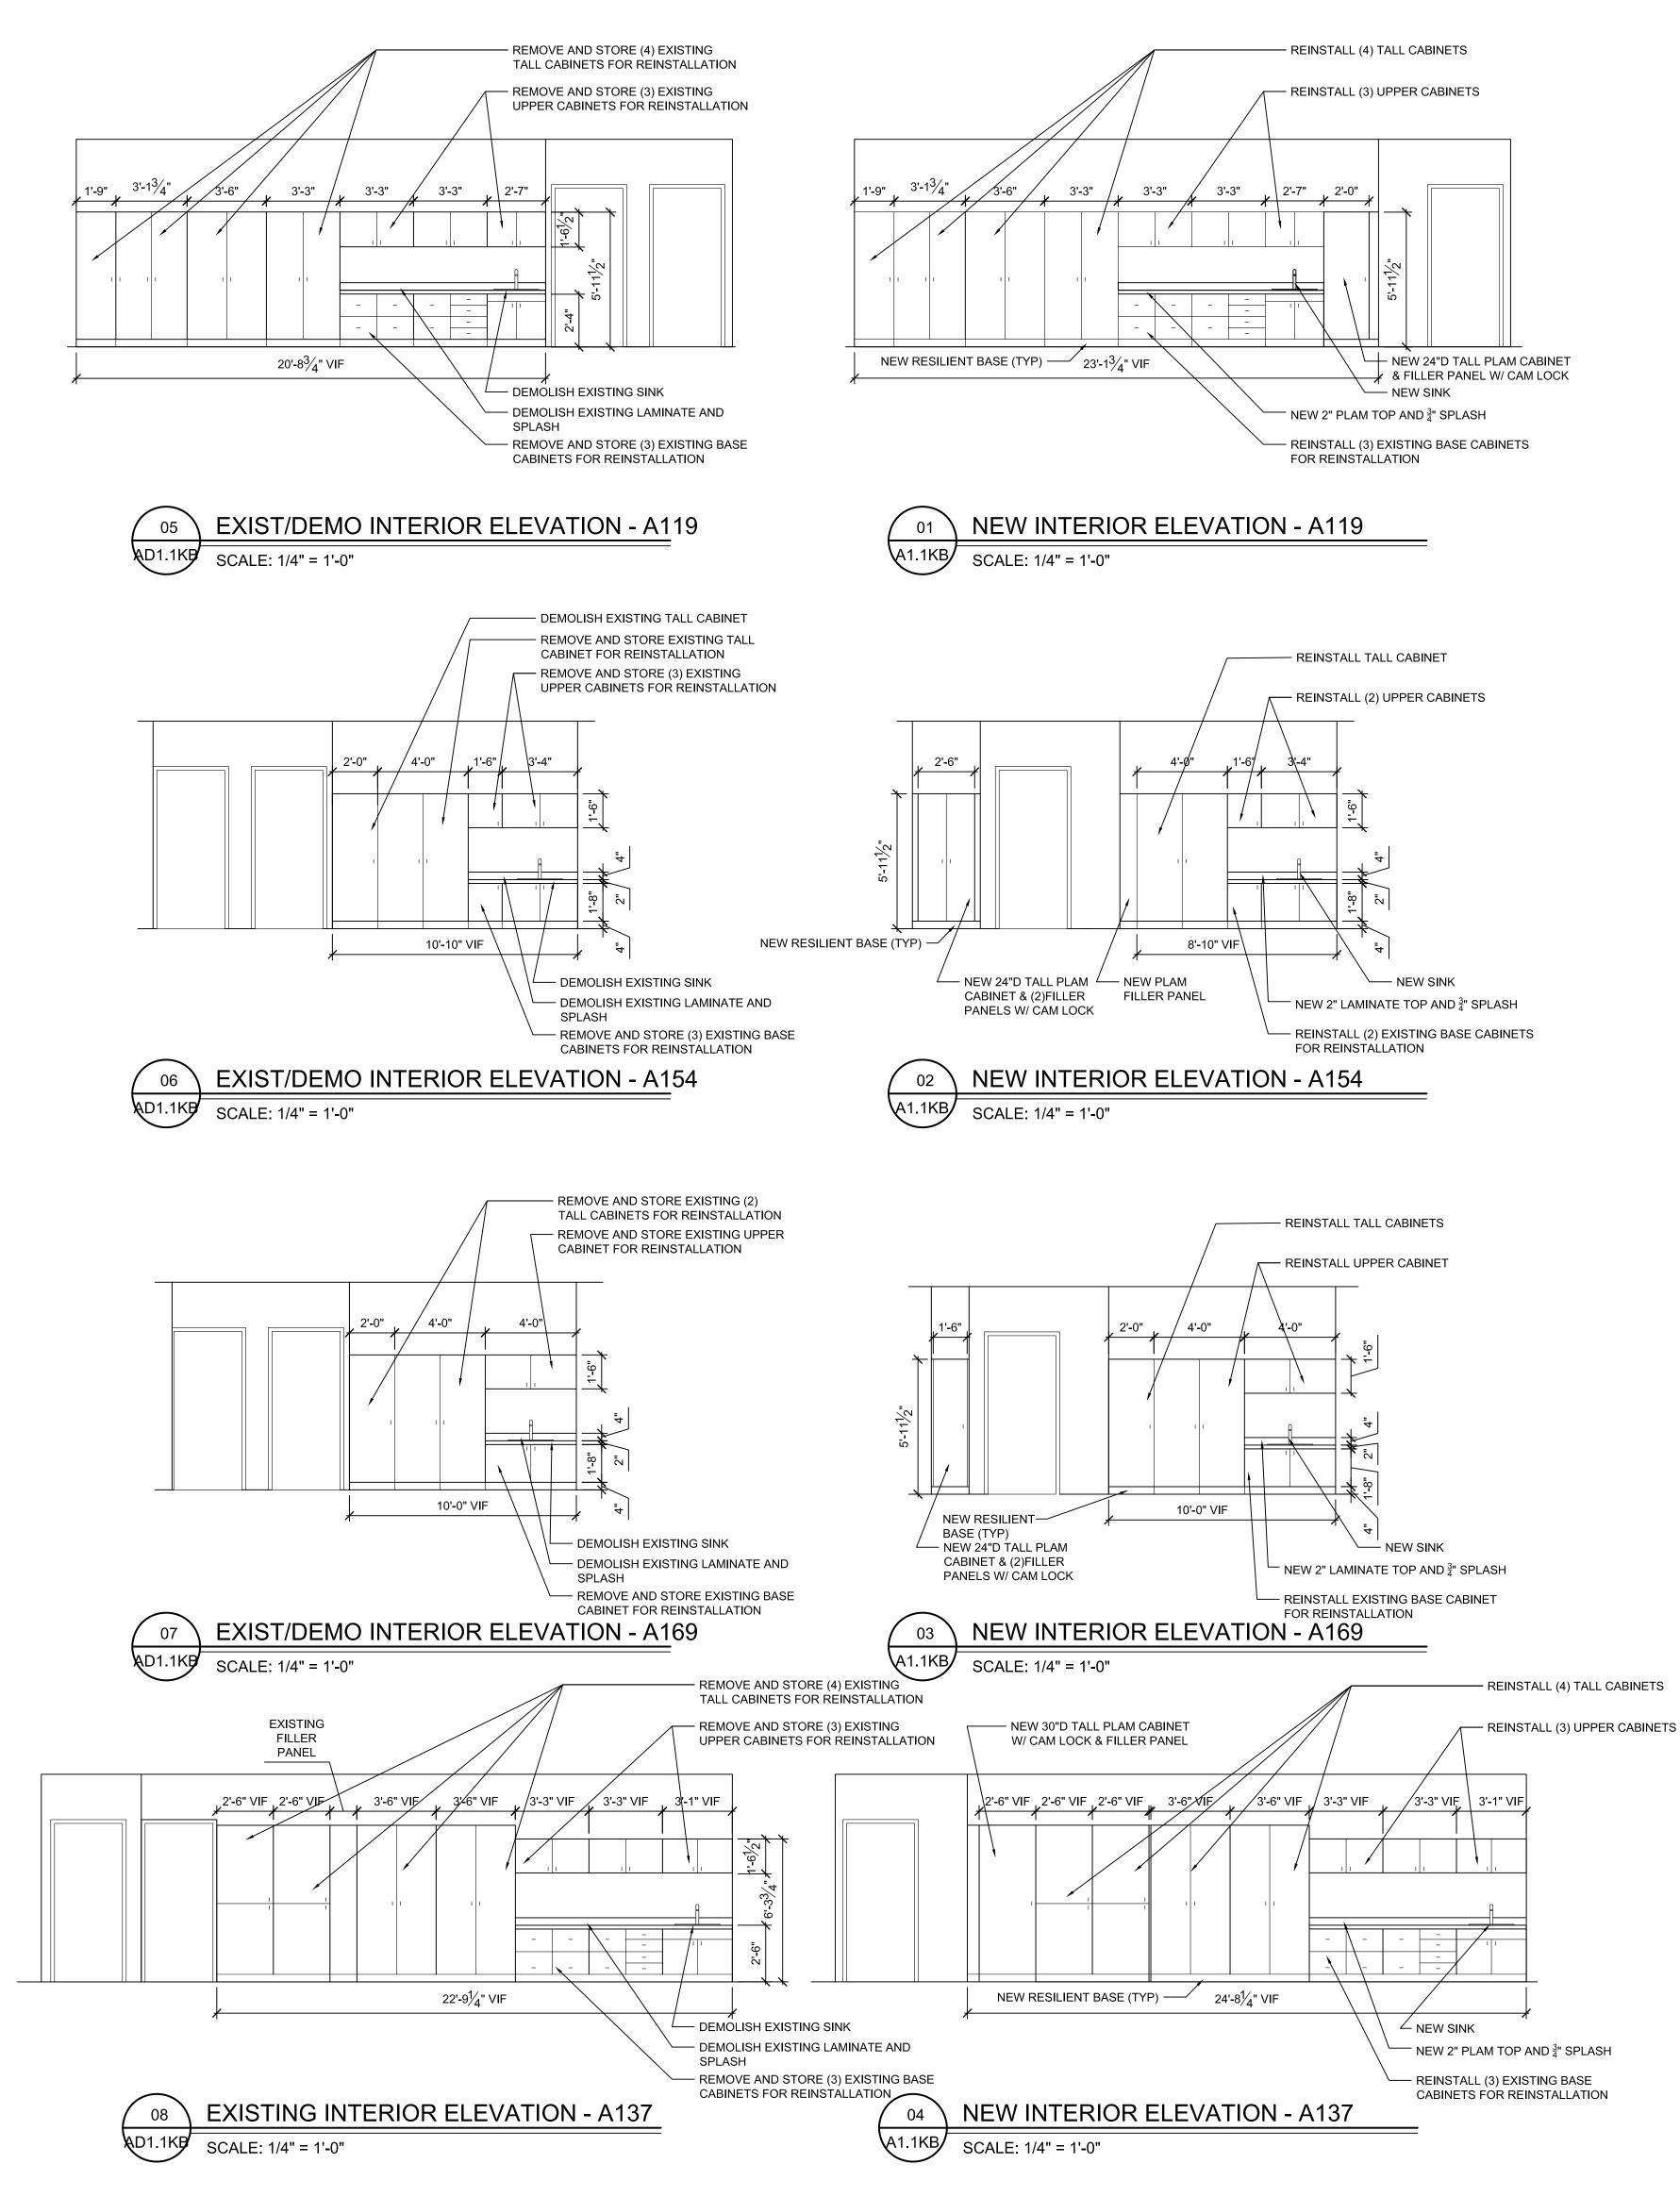
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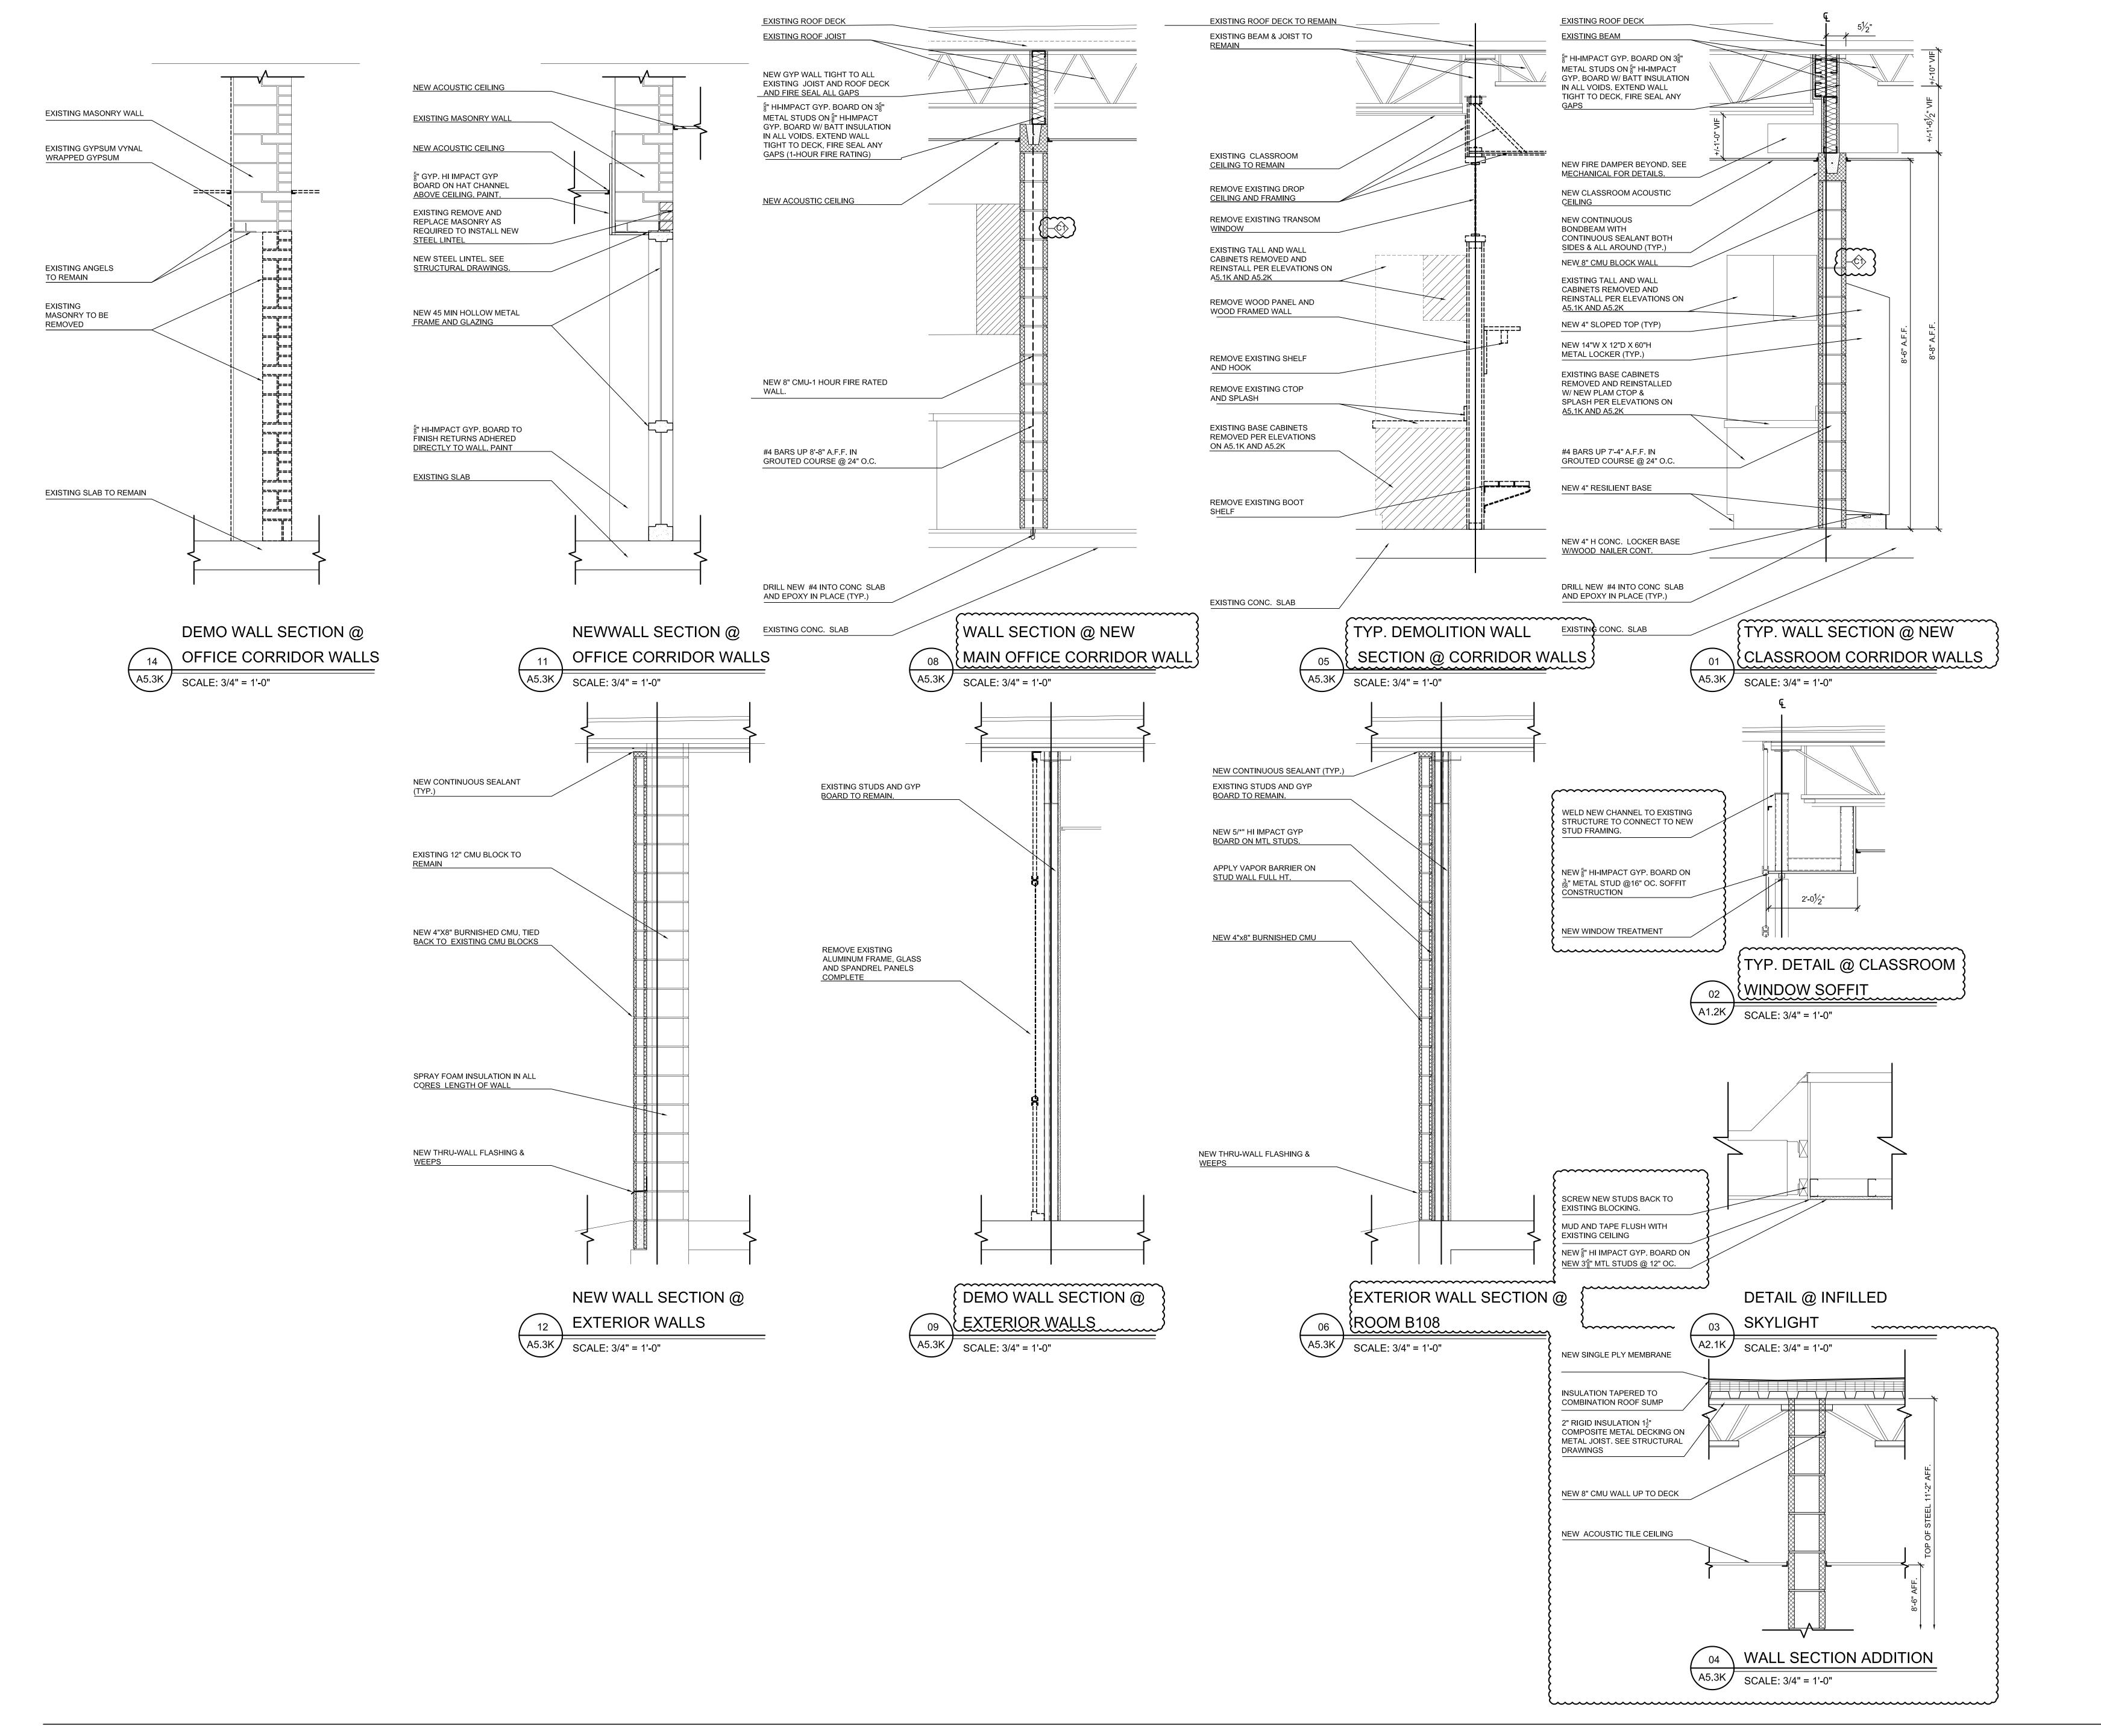
KENBROOK ELEMENTARY


INTERIOR ELEVATIONS

PRELIMINARY DESIGN DEVELOPMENT CONSTRUCTION FINAL RECORD

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FARMINGTON PUBLIC SCHOOLS - 2015 BOND

2018 PROJECTS

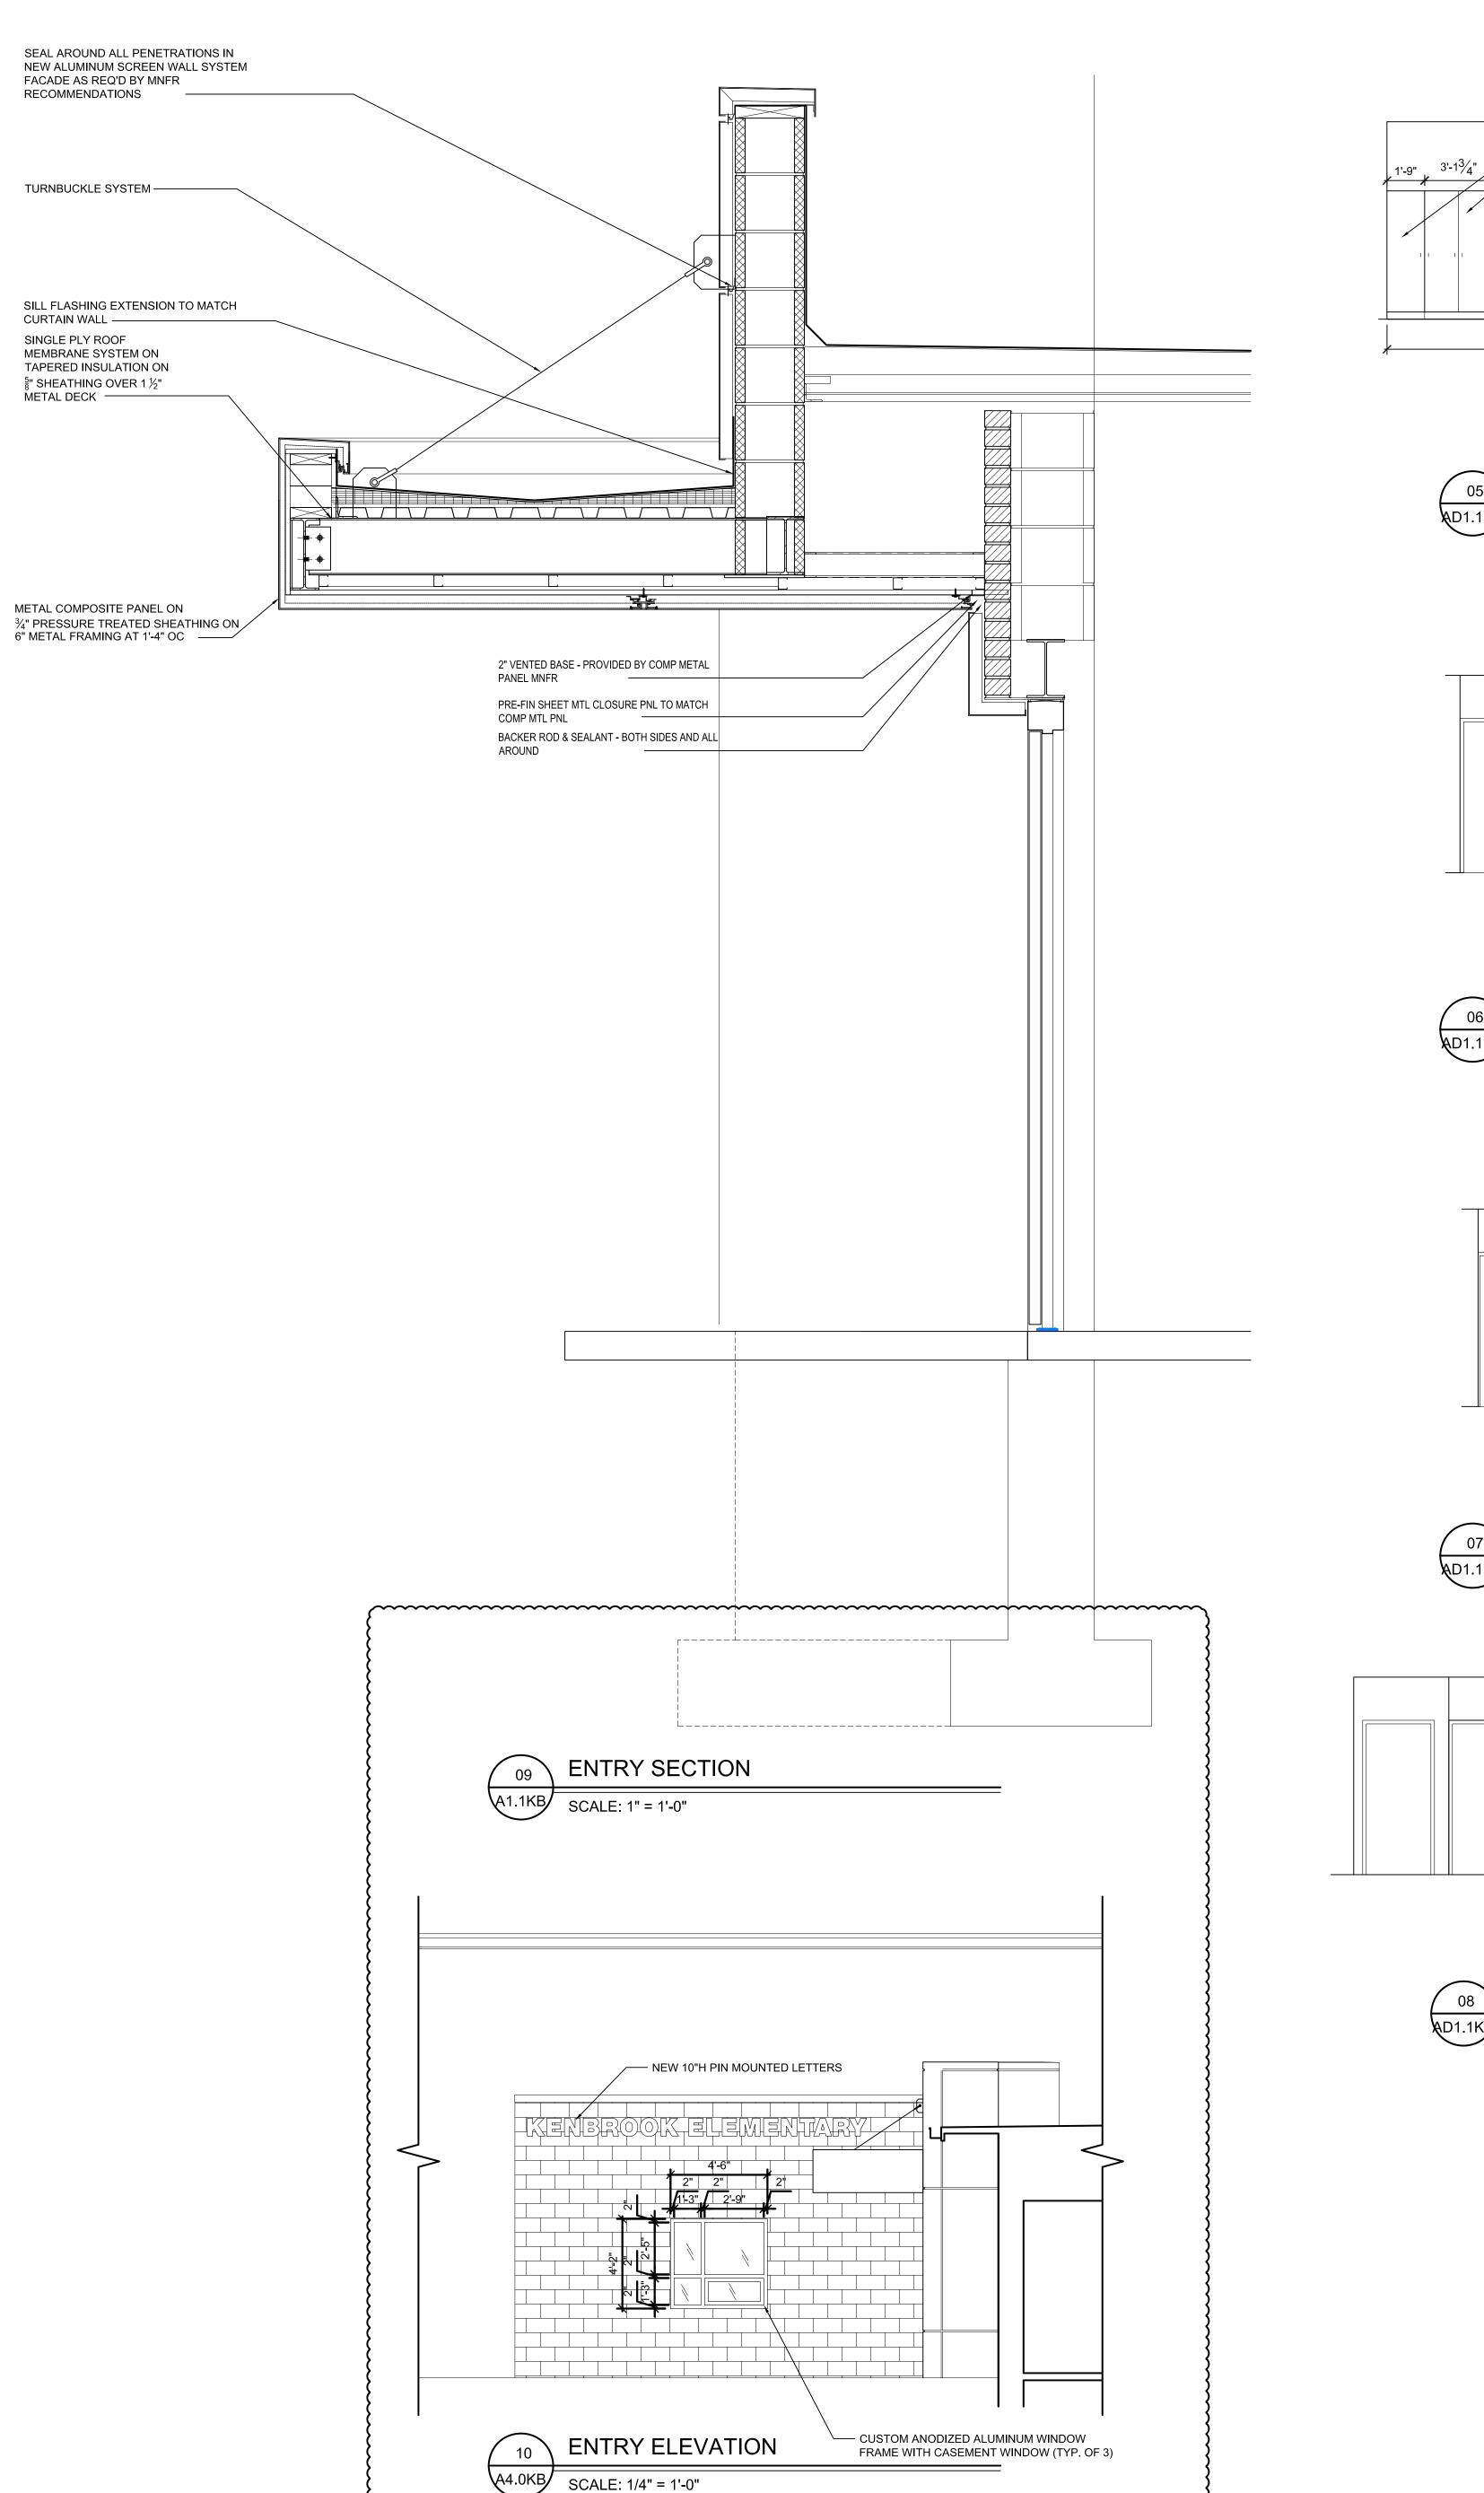KENBROOK & BEECHVIEW ELEMENTARY SCHO

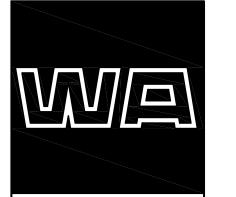PRELIMINARY

CONSTRUCTION

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REVISIONS

FINAL RECORD

DESIGN DEVELOPMENT

#### ROOM FINISH SCHEDULE ABBREVIATIONS:

ACT	ACOUSTICAL CEILING TILE IN METAL GRID	PT	PAINT
BR	BRICK	RB	4" RESILIENT COVE BASE
CMU	CONCRETE MASONRY UNIT	RTR	RUBBER TREADS AND RISERS
CPT	CARPET	SC	SEALED CONCRETE
EPT	EPOXY PAINT	TEC	2'-0" x 2'-0" TECTUM IN GRID SYSTEM
ETR	EXISTING TO REMAIN	LVT	LUXURY VINYL TILE FLOOR
EXP	EXPOSED CONSTRUCTION	VACT	VINYL FACED ACT
GB	GYPSUM BOARD	VB	VENTED BASE
PCT	PORCELAIN CERAMIC TILE	WC	WALK-OFF CARPET
4PCT	4" PORCELAIN CERAMIC TILE COVE BASE	WD	WOOD
		AF	ACCESS FLOORING

### ROOM FINISH SCHEDULE REMARKS:

- PROVIDE MARKER BD. PAINT ON WALLS FULL HEIGHT AND WIDTH.
- NEW CEILING TO BE PLACED AT SAME HEIGHT AS EXISTING (VIF). SEE FLOOR PLANS FOR EXTENT OF NEW FLOORING & PATTERNS.
- MULTIPLE WALL PAINT COLORS & PATTERNS WILL BE USED IN THIS ROOM.
- MULTIPLE COLORS WILL BE USED ON EXPOSED ROOF DECK, FRAMING, DUCTWORK, ETC. 6. SEE ELEVATIONS AND NOTES FOR HEIGHT OF WALL TILE. PAINT CMU WALL ABOVE TILE (VERIFY EACH ROOM DIMENSION IN FIELD).
- SEE ELEVATIONS AND DETAILS FOR SOFFITS / WALL MATERIALS TO BE PAINTED. REMOVE WALL COVERING, SKIM COAT WALLS, SAND AND PREP FOR NEW PAINT AS REQUIRED.
- PROVIDE HOLD DOWN CLIPS IN ACOUSTIC CEILING TILE SYSTEM.
- 10 PROVIDE GYM FLOOR STRIPING AS DETAILED ON ENLARGED PLANS.

  11. PROVIDE 12'-0" x 12'-0" AREA RUG SEE SPEC.

### ROOM FINISH SCHEDULE GENERAL NOTES (APPLIES TO ALL ROOMS):

- 1. PAINT ALL EXPOSED ITEMS IN ROOMS: DOOR FRAMES, WINDOW FRAMES, DUCTS, PIPES, CONDUITS, ROOF FRAMING, ROOF DECK, ETC.
- 2. SEE ELEVATIONS & DETAILS FOR GYP BD SOFFIT HEIGHTS & SIZES. 3. SEE ELEVATIONS & DETAILS FOR WALL TILE HEIGHTS & LOCATIONS
- 4. SEE PLANS FOR FLOOR PATTERNS AND WALK-OFF CARPET LOCATIONS
- 5. PROVIDE VINYL TRANSITION STRIPS AT DISSIMILAR FLOOR FINISHES CARPET / TILE, CARPET / CONCRETE, ETC. 6. PAINT NEW WALL CONSTRUCTION TO MATCH EXISTING IN ROOM (VIF)
- 7. PROVIDE STAINLESS STEEL SCHLUTER TRANSITIONS AT ALL HARD TILE / CARPET LOCATIONS. 8. MODIFY EXISTING LAY-IN CEILINGS AS REQUIRED TO ACCOMMODATE NEW WALL PLACEMENT.
- 9. REMOVE / REINSTALL EXISTING LAY-IN CEILING SYSTEMS AS REQUIRED FOR OVERHEAD PIPING, DUCT WORK, ETC (VIF).
- 10. VERIFY WITH EACH SCHOOL PRINCIPAL <u>BEFORE PAINTING OVER</u> TOP OF EXISTING PAINTED MURALS IN CORRIDORS AND CLASSROOMS.

  11. ALL TOILET ROOMS CALLING FOR PAINT TO BE EPOXY PAINT (WALLS & CEILINGS).

					CEIL	ING	
NO.	ROOM NAME	FLOOR	BASE	WALLS	MATERIAL	HGT.	REMARKS
B105	EXISTING CLOSET	-	-	-	-	-	-
B106	NEW VESTIBULE	WC	RB	PT	ACT	-	-
B107	EXISTING VAULT	CPT	RB	PT	ETR/PT	-	-
B108	EXISTING B.F. TOILET	CPT	RB	PT	-	-	-
B109	EXISTING CLOSET	CPT	ETR	ETR	-	-	-
B110	EXISTING VESTIBULE	LVT	RB	PT	ACT/PAD	-	2
B111	EXISTING STORAGE	ETR	ETR	ETR	ETR	-	-
B112	EXISTING KITCHEN	ETR	ETR	PT	ETR	-	-
B113	EXISTING CAFETERIA	LVT	RB	PT	ACT/PAD	-	2,3,4
B114	EXISTING STORAGE	ETR	ETR	ETR	ETR	-	-
3115	EXISTING TOILET	PCT	4PCT	EPT	ETR/EPT	+/-8-0"(VIF)	2
3116	EXISTING CORRIDOR	LVT	RB	PT	ETR	-	3,4
3117	EXISTING PERFORMANCE AREA	LVT	RB	PT	PT	-	3,4
3118	EXISTING STORAGE	ETR	ETR	ETR	ETR	-	-
3119	EXISTING MECHANICAL	ETR	ETR	ETR	ETR	-	-
3121	EXISTING OFFICE	CPT	RB	PT	ACT	-	-
3122	CONFERENCE ROOM	CPT	RB	PT	ACT	8'-6"	-
B123	NEW CLINIC	LVT	RB	EPT	ACT	8'-0"	-
B124	NEW B.F. TOILET	PCT	4PCT	EPT	PT	8'-6"	-
B129	EXISTING STORAGE	CPT	RB	PT	ACT/PAD	-	2
C100	EXISTING OFFICE	CPT	RB	PT	ACT/PAD	7'-11"	2
C101	EXISTING OFFICE	CPT	RB	ETR	ACT/PAD	7'-11"	2
C102	EXISTING MEDIA CENTER	CPT	RB	PT	ACT/PAD	9'-1"/7'-10"	2
C103	EXISTING OFFICE	CPT	RB	ETR	ETR	7'-11"	-
C104	EXISTING PERFORMANCE AREA	CPT	RB	PT	ACT/PAD	7'-11"	2
C105	EXISTING OFFICE	ETR	ETR	ETR	ETR	7'-11"	2
-	-	-	-	-	-	-	-
-	-	-	-	-	-	-	-
-	-	-	-	-	-	-	-
_	-	-	-	_	-	_	-

					CEIL	NG	
).	ROOM NAME	FLOOR	BASE	WALLS	MATERIAL	HGT.	REMARKS
00	EXISTING LGI	LVT	- RB	PT	-	- 8'-3"	<u></u>
3	EXISTING CLASSROOM EXISTING LGI	LVT LVT	RB RB	PT PT	-	8'-2" 8'-3"	\{ 11 \} \{ 11 \}
_	EXISTING CLASSROOM	LVT	RB	PT	-	8'-2"	{ 11 }
5	EXISTING CORRIDOR	LVT	RB	PT	ACT	8'-6"	3,4
-	EXISTING CLASSROOM	LVT	RB	PT	ACT	8'-6"	£113
7	EXISTING CLASSROOM -	LVT -	RB -	PT -	ACT -	8'-6" -	(11)
+	-	-	-	-	-	-	-
-	EXISTING CLASSROOM	LVT	RB	PT	ACT	8'-6"	[11]
1	EXISTING CLASSROOM -	LVT -	RB -	PT -	ACT -	8'-6" -	<u>{11}</u>
4	- EVICTING DOVE TOUET	-	-	-	-	-	-
4	EXISTING BOYS TOILET	PCT	4PCT	PCT/EPT	GYP	9'-8"	2,6
-	EXISTING CLASSROOM EXISTING GIRLS TOILET	LVT PCT	RB 4PCT	PT PCT/EPT	ACT GYP	8'-6" 9'-4"	2,6
$^{\prime}$	-	-	-	-	-	-	-
)	- EXISTING CLASSROOM	LVT	- RB	- PT	- ACT	- 8'-6"	<u>{11}</u>
							$\omega$
)	EXISTING CORRIDOR -	LVT -	RB -	PT -	ACT -	8'-6" -	3,4
+	EXISTING CUSTODIAL CLOSET		ETR	ETR	ETR	-	-
}  -	EXISTING STORAGE EXISTING STORAGE	ETR ETR	ETR ETR	ETR ETR	ETR ETR	-	-
	EXISTING VESTIBULE	WC	RB	PT	ACT	8'-5"	
	-	-	-	-	-	-	- -
+	EXISTING CLASSROOM EXISTING KILN	LVT ETR	RB ETR	PT ETR	ACT ETR	8'-6" -	<u>{11}</u>
	EXISTING KILIN EXISTING CLASSROOM	LVT	RB	PT	ACT	8'-2"	<u>-</u>
)	EXISTING ART ROOM	ETR	ETR	PT	-	8'-0"	-
1	EXISTING CLOSET	-	-	-	-	-	-
<u>2</u> 3	EXISTING OFFICE EXISTING MUSIC	CPT CPT	RB RB	PT PT	ETR ACT	8-'0" 8'-6"	-
	-	-	-	-	-	-	-
5	EXISTING CLOSET	<b>-</b>	-		-	-	-
S   7	EXISTING CORRIDOR EXISTING STAFF ROOM	LVT LVT	RB RB	PT PT	ACT ACT	8'-0" 8'-6"	3,4
3	EXISTING STAIT ROOM  EXISTING CORRIDOR	LVT	RB	PT	ACT	8'-6"	3,4
)	EXISTING BOILER ROOM	ETR	ETR	ETR	ETR	-	-
+	EXISTING GIRLS TOILET	PCT	4PCT	PCT/EPT	GYP/EPT	9'-9"	2,6
1 2	EXISTING STORAGE EXISTING CUSTODIAL CLOSET	ETR -	ETR -	ETR -	ETR -	-	-
3	EXISTING GYMNASIUM	LVT	RB	PT	ETR/PT	19'-9"	4,5,10
1	EXISTING BOYS TOILET	PCT	4PCT	PCT/EPT	GYP/EPT	9'-6"	2,6
+	EXISTING CORRIDOR	LVT	RB	PT	ACT	8'-6"	3.4
3   7	EXISTING CLASSROOM EXISTING VESTIBULE	LVT WC	RB RB	PT PT	ACT ACT	8'-6" 8'-8"	\\\\\\\\\\\\\\\\\\\\\\\\\\\\\\\\\\\\\\
3	EXISTING CLOSET	-	-	-	-	-	
9	EXISTING CLASSROOM	LVT	RB	PT	ACT	8'-6"	(11)
) 1	EXISTING CLASSROOM EXISTING TOILET	LVT PCT	RB 4PCT	PT EPT	ACT GYP/EPT	8-6" 8'-3"	(11)
<u> </u>	-	-	-	-	-	-	-
1	- EXISTING CLASSROOM	LVT	- RB	- PT	- ACT	- 8'-6"	-
+	NEW TOILET NEW STORAGE	PCT LVT	4PCT RB	EPT PT	GYP/EPT GYP/PT	8'-0" 8'-0"	2 2
5	EXISTING TOILET	PCT	4PCT	EPT	GYP/PT	8'-3"	2
+	EXISTING CLASSROOM NEW TOILET	LVT PCT	RB 4PCT	PT EPT	ACT GYP/PT	8'-6" 8'-0"	\\\\\\\\\\\\\\\\\\\\\\\\\\\\\\\\\\\\\\
В	NEW STORAGE	LVT	RB	PT	GYP/PT	8'-0"	2
A	NEW TOILET	PCT	4PCT	EPT	GYP/PT GYP/PT	8'-0" 8'-0"	2 2
+	NEW STORAGE EXISTING CLASSROOM	LVT LVT	RB RB	PT PT	GYP/PT ACT	8'-0" 8'-6"	2 (11)
-	EXISTING CLASSROOM  EXISTING CLASSROOM	LVT	RB	PT	ACT	8'-6"	11
+	-	-	-	-	-	-	
+	NEW STORAGE	LVT	RB	PT	GYP/PT	8'-0"	2
+	NEW STORAGE NEW STORAGE	LVT LVT	RB RB	PT PT	GYP/PT GYP/PT	8'-0" 8'-0"	2 2
В	NEW STORAGE EXISTING CLASSROOM	LVT	RB	PT	GYP/PT	8'-0" 8'-6"	2 (11)
		LVT	RB	PT	ACT	8'-6"	
9	EXISTING CLASSROOM -	LVT -	RB -	PT -	ACT -	8'-6" -	<u>{11}</u>
	EXISTING TOILET	PCT	4PCT	EPT	GYP/PT	8'-0"	2
_	EXISTING TOILET EXISTING KINDERGARTEN	PCT LVT	4PCT RB	EPT PT	GYP/PT ACT	8'-0" 8'-6"	2
+	EXISTING CORRIDOR EXISTING TOILET	LVT PCT	RB 4PCT	PT EPT	ACT GYP/PT	8'-6" 8'-0"	2
+	EXISTING VESTIBULE EXISTING STORAGE	WC LVT	RB RB	PT ETR	ACT ETR	8'-8"	2 2
+	EXISTING STORAGE EXISTING CORRIDOR	LVT	RB RB	PT	ACT	- 8'-6"	3,4
0	EXISTING CORRIDOR	LVT	RB	PT	ACT	8'-6"	3,4
-	EXISTING CORRIDOR  EXISTING RAMP	RTR	RB	PT	ACT	VARIES	-
+	<del>-</del>	-	-	-	-	-	-
	-	-	-	-	-	-	-
) )	NEW PRINCIPAL'S OFFICE	CPT	RB	PT	ACT	8'-6"	-
1	NEW MAIN OFFICE	CPT	RB	PT	ACT	9'-0"	3,4
2	NEW WORK ROOM EXISTING WORK ROOM	CPT CPT	RB RB	PT PT	ACT/PAD ACT	-	2 2



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ROOM FINISH SCHEDULE


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}	<u>-</u> 1	- B100	-	7	-	LINE 1: PRINCIPAL
<b>\</b>	2	B101	-	5	-	LINE 1: MAIN LINE 2: OFFICE
<b>}</b>	1	B102	-	5	-	LINE 1: STAFF
<b>{</b>	1	B103	-	5	-	LINE 2: ROOM LINE 1: WORK
<b>}</b>	1	B104		6	-	LINE 2: ROOM LINE 1: RESTROOM
<b>}</b>	1	B107 B108	-	6 2	-	LINE 1: STORAGE
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<b>}</b>	2	B113	-	6	- -	LINE 1: CAFETERIA
<b>{</b>	1	B114 B115	-	6 6	-	LINE 1: STORAGE LINE 1: RESTROOM
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<b>{</b>	-	-	-	-	-	-
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<b>{</b>	1	B122	-	5	-	LINE 1: CONFERENCE LINE 2: ROOM
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<b>{</b>	1 -	B129	-	6	-	LINE 1: STORAGE
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201 SCHOOLS


KENBROOK ELEMENTARY SIGNAGE SCHEDULE AND

PRELIMINARY

DESIGN DEVELOPMENT ☐ CONSTRUCTION FINAL RECORD DRAWN BY NJL

CHECKED BY BJS REVISIONS

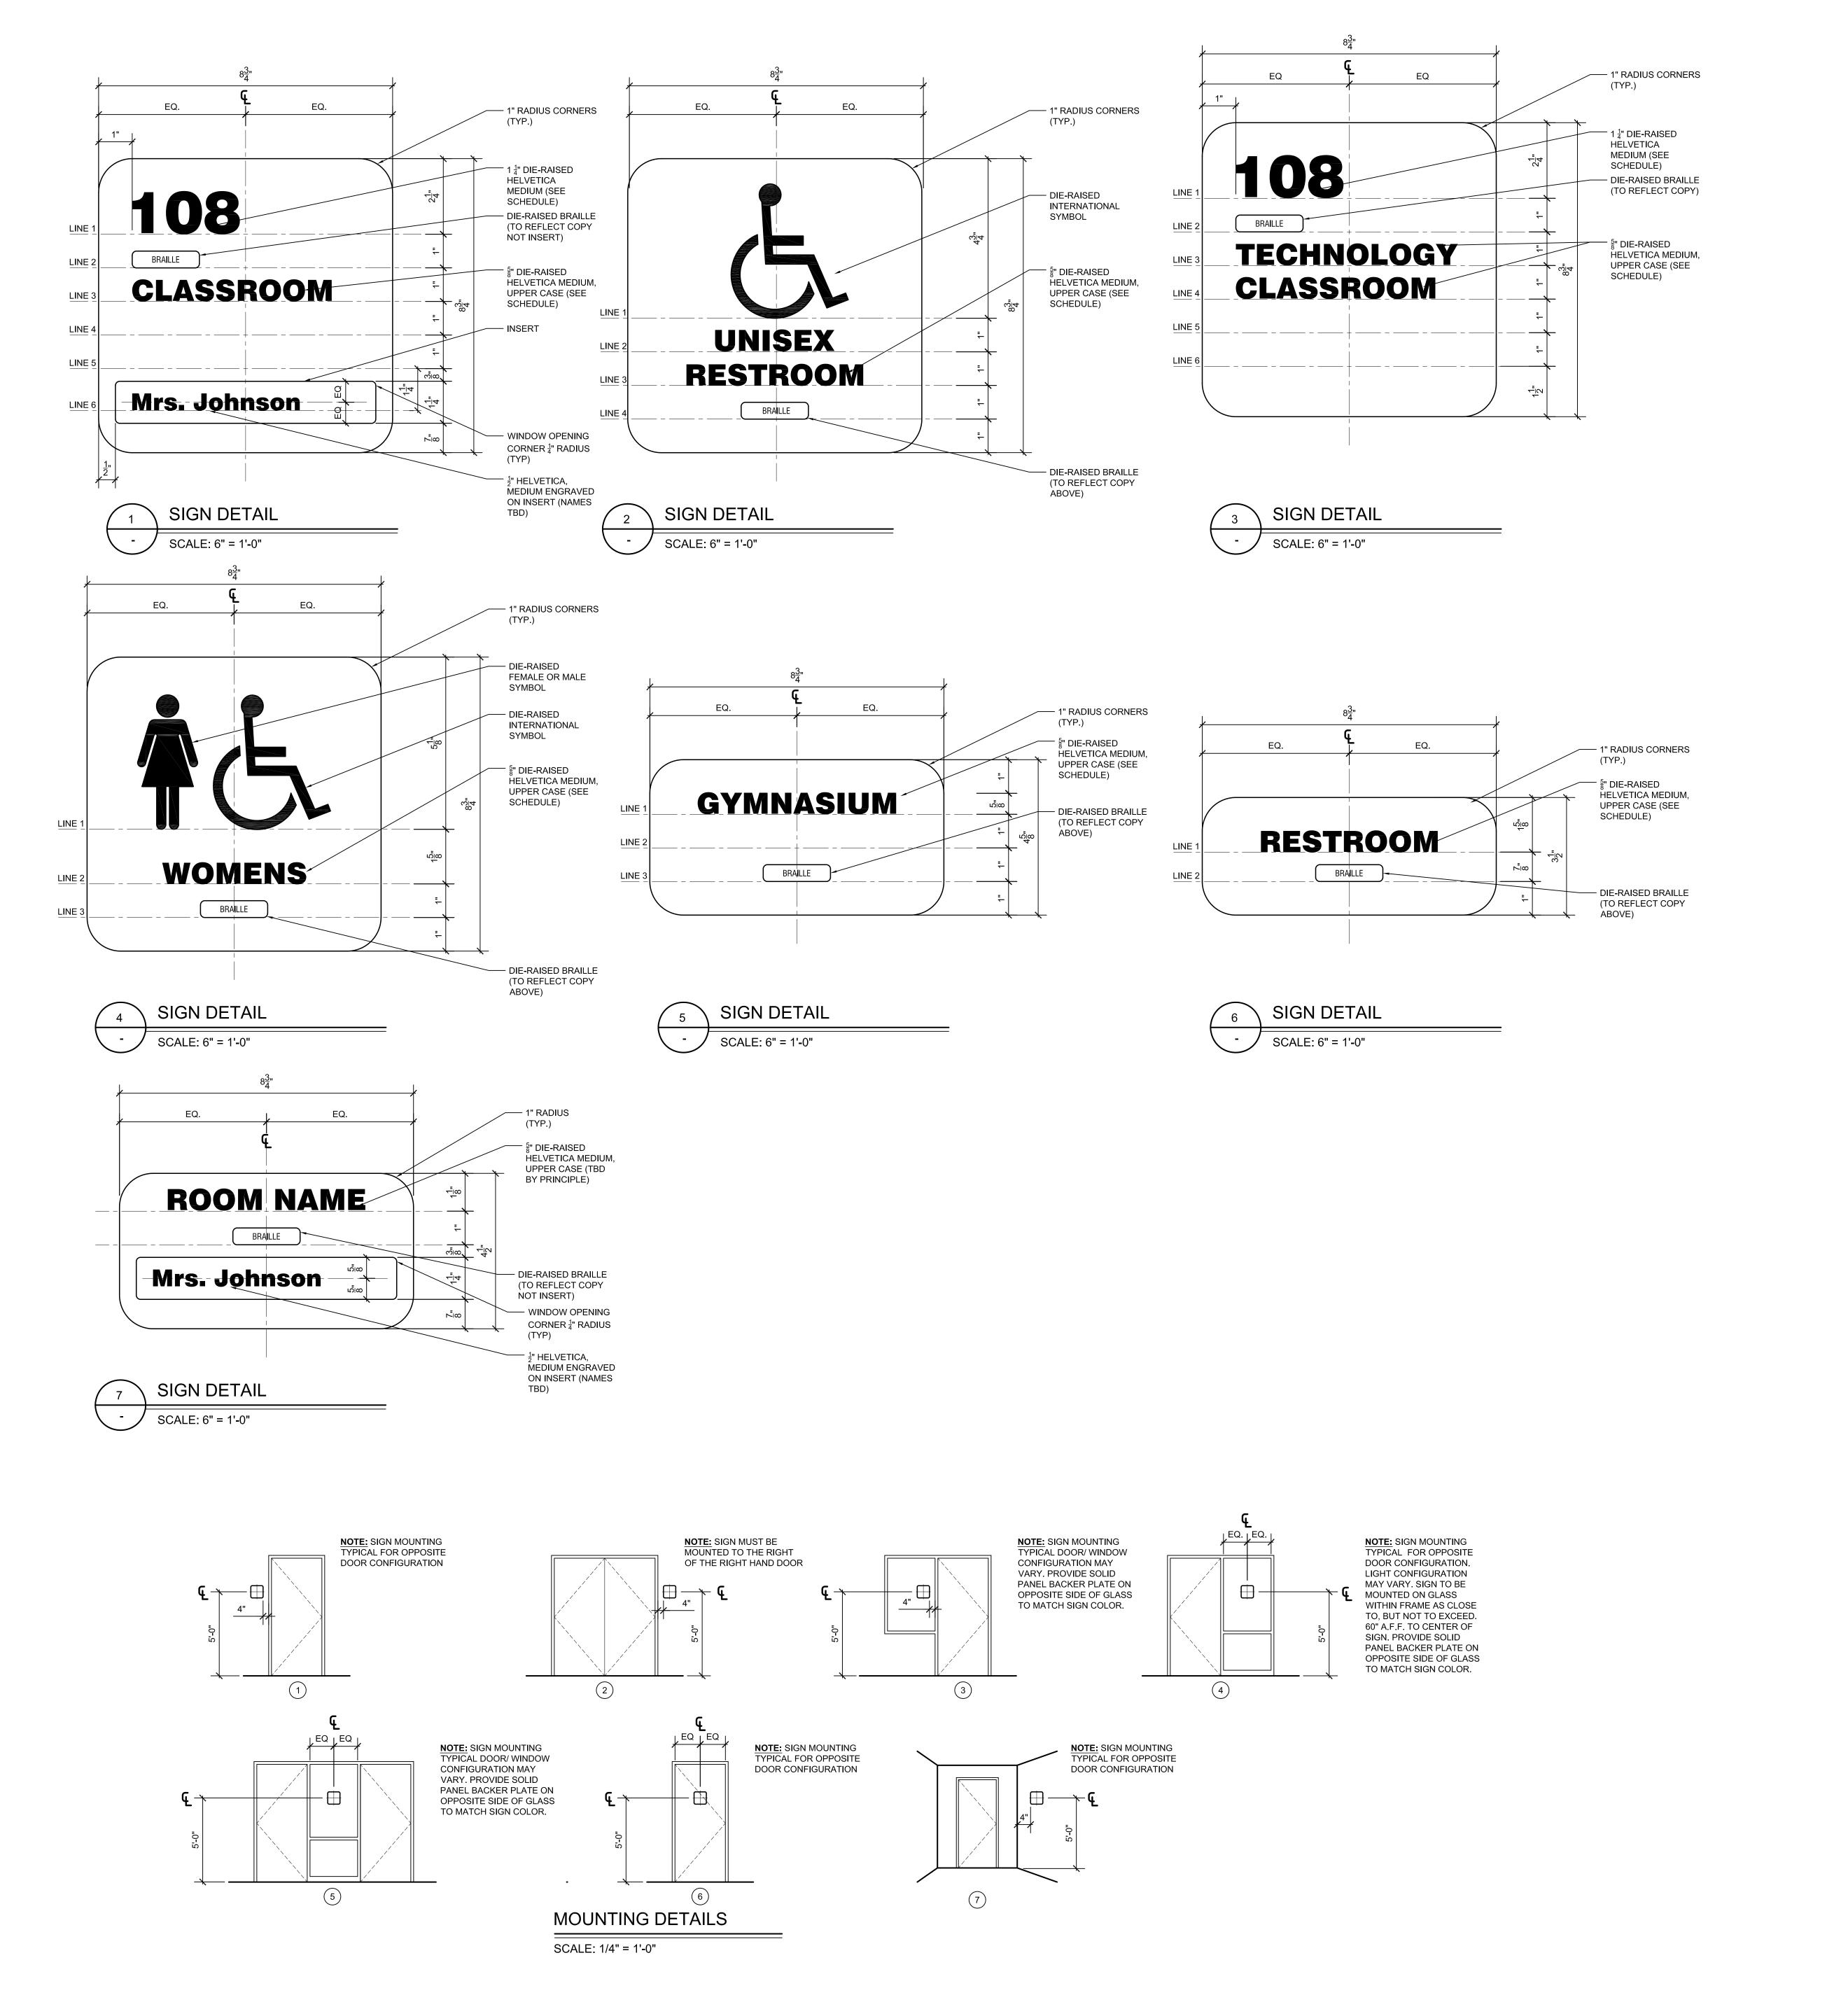DATE: December 12, 2017

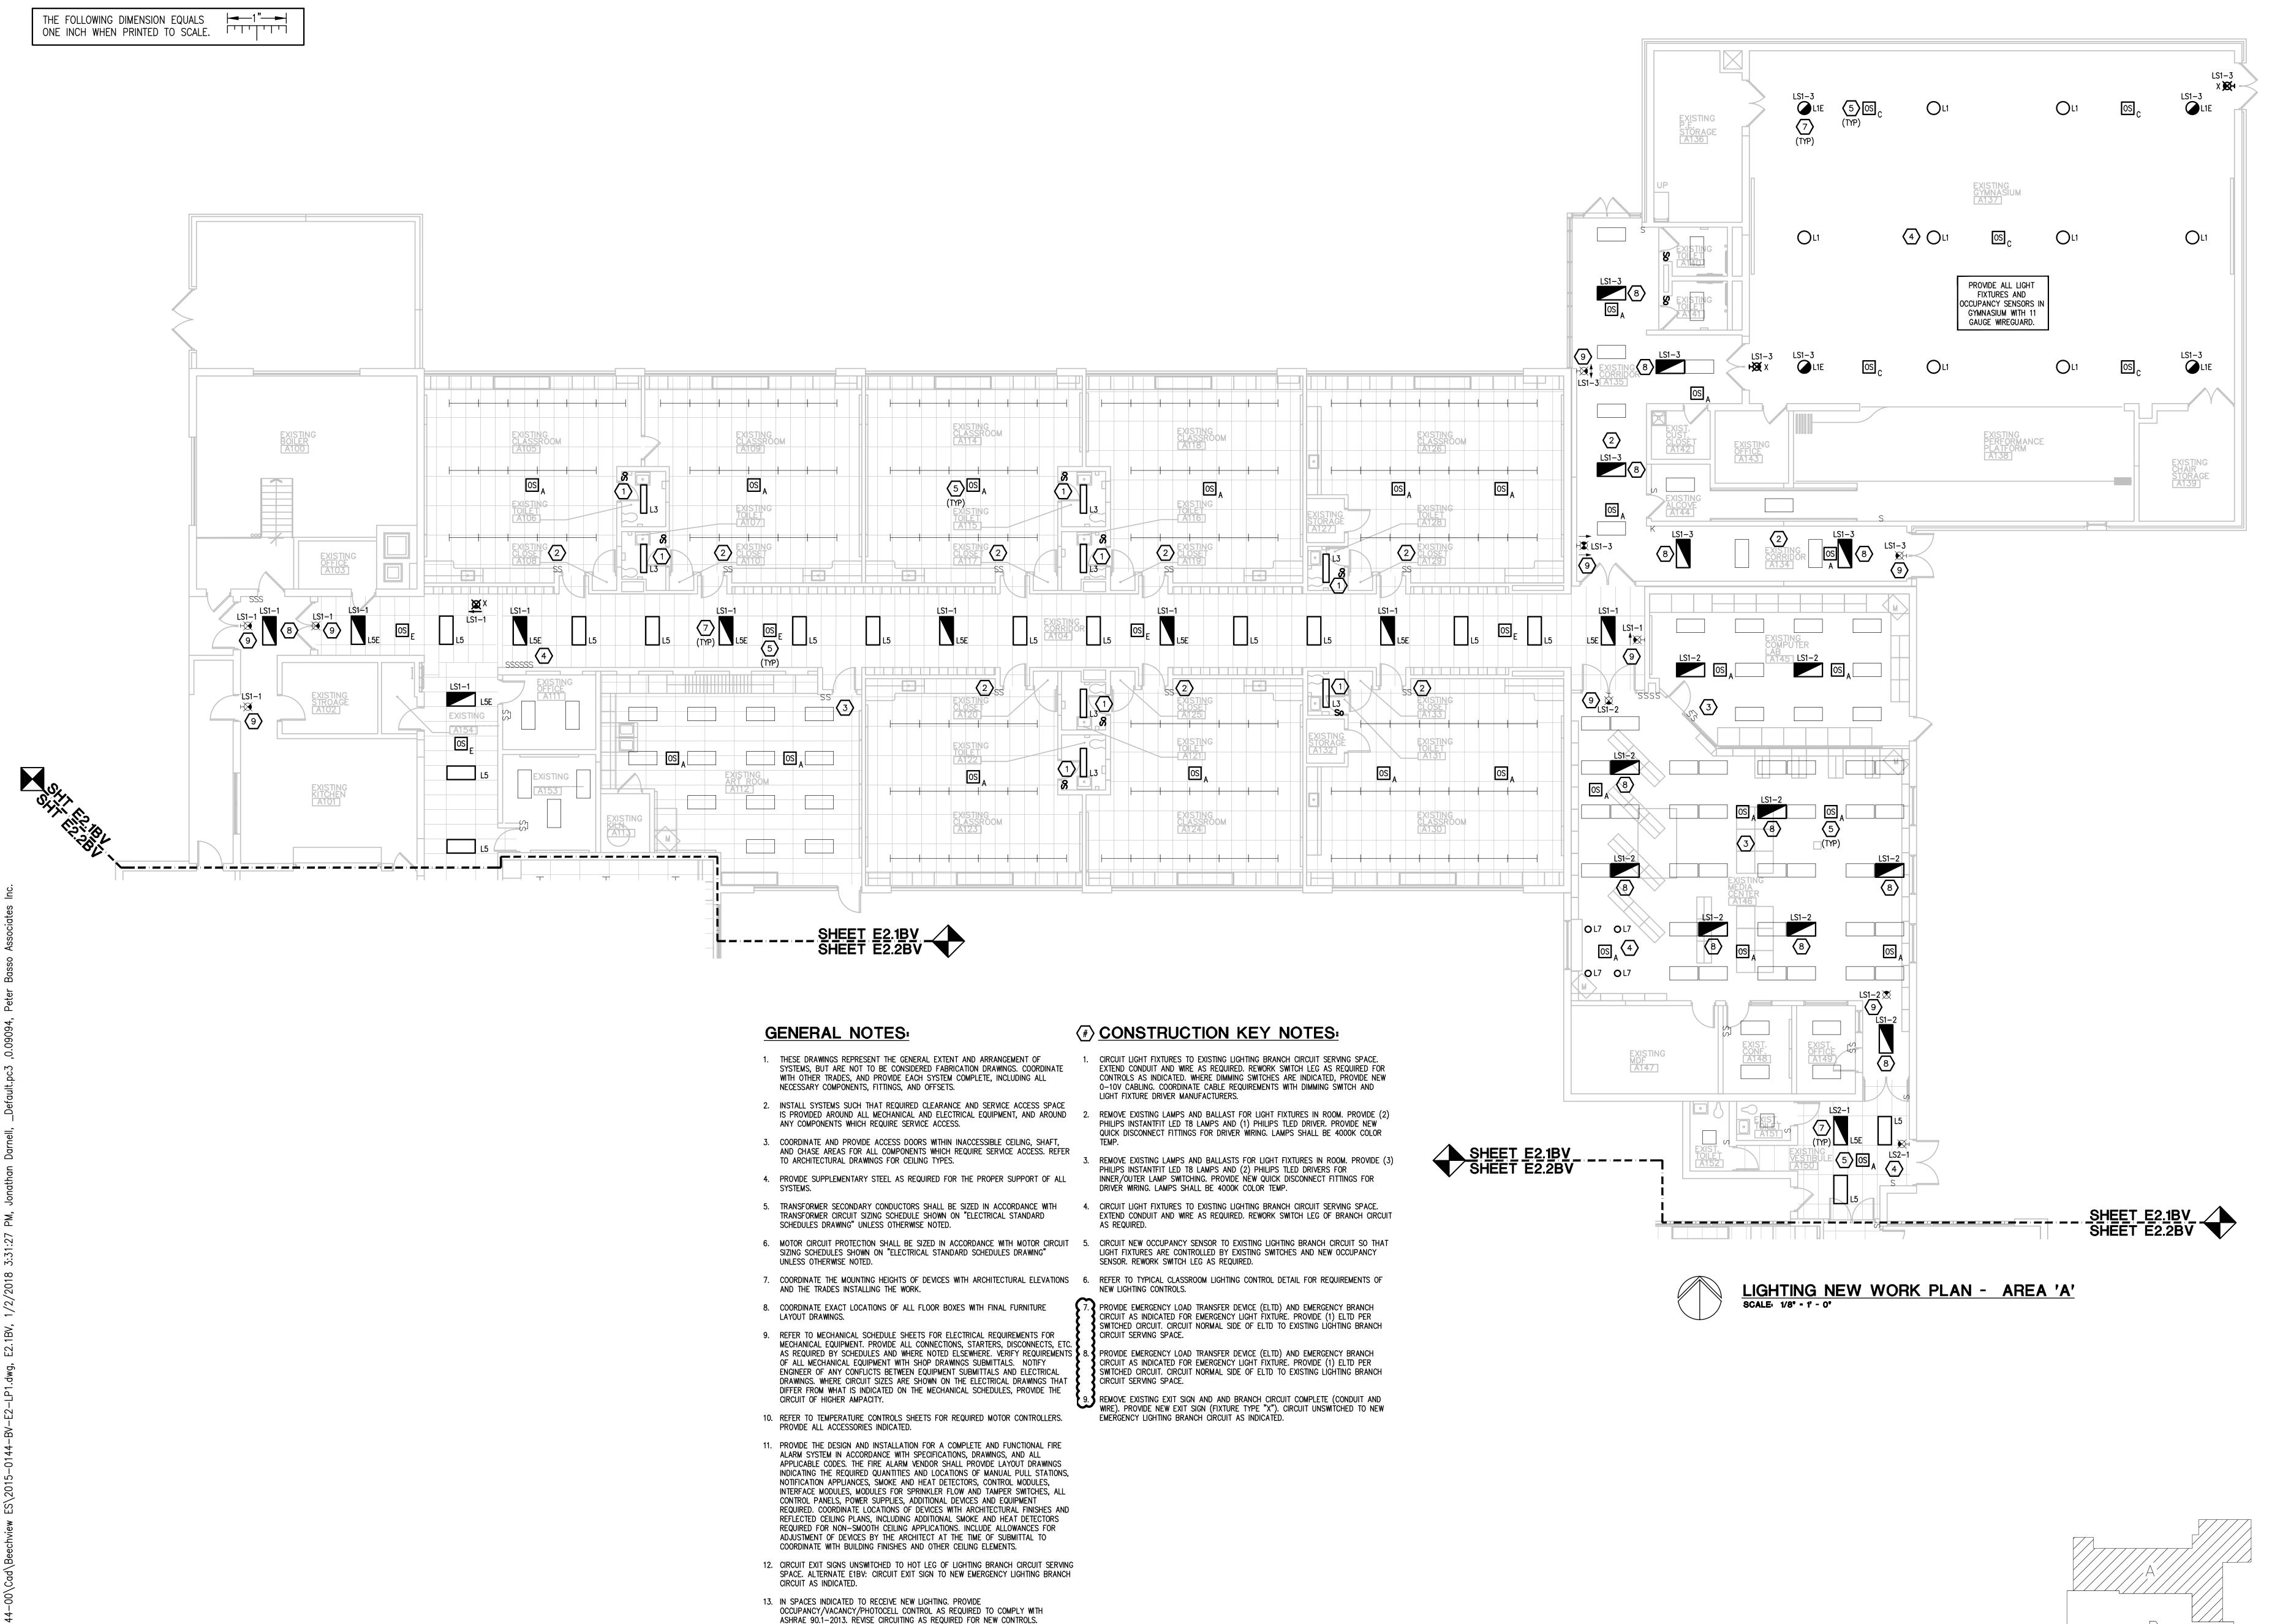

14. EXTEND EXISTING CIRCUIT GROUND AS REQUIRED PER NEC WHERE NEW LIGHTING IS BEING INSTALLED OR EXISTING LIGHTING IS BEING REMOVED AND REINSTALLED.

WAKELY ASSOCIATES, INC. ARCHITECTS & ENGINEERS 30500 VAN DYKE AVE. SUITE M-7 WARREN, MICHIGAN, 48093

E-MAIL: WA@WAKELYAIA.COM Peter Basso Associates I CONSULTING ENGINEERS 5145 Livernois, Suite 100

TEL. 586-573-4100 FAX. 586-573-0822

Troy, Michigan 48098–3276
Tel: 248–879–5666
Fax: 248–879–0007 www.PeterBassoAssociates.com PBA Project No.: 2015-0144

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BEECHVIEW ELEMENTARY SCHOOL LIGHTING NEW WORK PLAN -

**PRELIMINARY** DESIGN DEVELOPMENT CONSTRUCTION

FINAL RECORD DRAWN BY:

CHECKED BY: REVISIONS:

ADDENDUM NO. 1 01/03/

DATE: 12-15-17 SHEET NO.:

1 JOB NO.: 171712A

KEY PLAN

os <sub>A</sub>

7 LS1-5 L3E

LS1-5 OS

L3E

LS1-1 L5E

L8 4

P 0S<sub>A</sub> 5

TO SWITCH "C" TO "A" SWITCHES

LIGHTING NEW WORK PLAN - AREA 'B'
SCALE: 1/8' - 1' - 0'

# **GENERAL NOTES:**

- THESE DRAWINGS REPRESENT THE GENERAL EXTENT AND ARRANGEMENT OF SYSTEMS, BUT ARE NOT TO BE CONSIDERED FABRICATION DRAWINGS. COORDINATE WITH OTHER TRADES, AND PROVIDE EACH SYSTEM COMPLETE, INCLUDING ALL NECESSARY COMPONENTS, FITTINGS, AND OFFSETS.
- 2. INSTALL SYSTEMS SUCH THAT REQUIRED CLEARANCE AND SERVICE ACCESS SPACE IS PROVIDED AROUND ALL MECHANICAL AND ELECTRICAL EQUIPMENT, AND AROUND ANY COMPONENTS WHICH REQUIRE SERVICE ACCESS.
- 3. COORDINATE AND PROVIDE ACCESS DOORS WITHIN INACCESSIBLE CEILING, SHAFT, AND CHASE AREAS FOR ALL COMPONENTS WHICH REQUIRE SERVICE ACCESS. REFER TO ARCHITECTURAL DRAWINGS FOR CEILING TYPES.

4. PROVIDE SUPPLEMENTARY STEEL AS REQUIRED FOR THE PROPER SUPPORT OF ALL


- 5. TRANSFORMER SECONDARY CONDUCTORS SHALL BE SIZED IN ACCORDANCE WITH TRANSFORMER CIRCUIT SIZING SCHEDULE SHOWN ON "ELECTRICAL STANDARD
- 6. MOTOR CIRCUIT PROTECTION SHALL BE SIZED IN ACCORDANCE WITH MOTOR CIRCUIT SIZING SCHEDULES SHOWN ON "ELECTRICAL STANDARD SCHEDULES DRAWING" UNLESS OTHERWISE NOTED.
- 7. COORDINATE THE MOUNTING HEIGHTS OF DEVICES WITH ARCHITECTURAL ELEVATIONS AND THE TRADES INSTALLING THE WORK.
- 8. COORDINATE EXACT LOCATIONS OF ALL FLOOR BOXES WITH FINAL FURNITURE LAYOUT DRAWINGS.

SCHEDULES DRAWING" UNLESS OTHERWISE NOTED.

- 9. REFER TO MECHANICAL SCHEDULE SHEETS FOR ELECTRICAL REQUIREMENTS FOR MECHANICAL EQUIPMENT. PROVIDE ALL CONNECTIONS, STARTERS, DISCONNECTS, ET AS REQUIRED BY SCHEDULES AND WHERE NOTED ELSEWHERE. VERIFY REQUIREMENT OF ALL MECHANICAL EQUIPMENT WITH SHOP DRAWINGS SUBMITTALS. NOTIFY ENGINEER OF ANY CONFLICTS BETWEEN EQUIPMENT SUBMITTALS AND ELECTRICAL DRAWINGS. WHERE CIRCUIT SIZES ARE SHOWN ON THE ELECTRICAL DRAWINGS THAT DIFFER FROM WHAT IS INDICATED ON THE MECHANICAL SCHEDULES, PROVIDE THE CIRCUIT OF HIGHER AMPACITY.
- 10. REFER TO TEMPERATURE CONTROLS SHEETS FOR REQUIRED MOTOR CONTROLLERS. PROVIDE ALL ACCESSORIES INDICATED.
- 11. PROVIDE THE DESIGN AND INSTALLATION FOR A COMPLETE AND FUNCTIONAL FIRE ALARM SYSTEM IN ACCORDANCE WITH SPECIFICATIONS, DRAWINGS, AND ALL APPLICABLE CODES. THE FIRE ALARM VENDOR SHALL PROVIDE LAYOUT DRAWINGS INDICATING THE REQUIRED QUANTITIES AND LOCATIONS OF MANUAL PULL STATIONS, NOTIFICATION APPLIANCES, SMOKE AND HEAT DETECTORS, CONTROL MODULES, INTERFACE MODULES, MODULES FOR SPRINKLER FLOW AND TAMPER SWITCHES, ALL CONTROL PANELS, POWER SUPPLIES, ADDITIONAL DEVICES AND EQUIPMENT REQUIRED. COORDINATE LOCATIONS OF DEVICES WITH ARCHITECTURAL FINISHES AND REFLECTED CEILING PLANS, INCLUDING ADDITIONAL SMOKE AND HEAT DETECTORS REQUIRED FOR NON-SMOOTH CEILING APPLICATIONS. INCLUDE ALLOWANCES FOR ADJUSTMENT OF DEVICES BY THE ARCHITECT AT THE TIME OF SUBMITTAL TO COORDINATE WITH BUILDING FINISHES AND OTHER CEILING ELEMENTS.
- 12. CIRCUIT EXIT SIGNS UNSWITCHED TO HOT LEG OF LIGHTING BRANCH CIRCUIT SERVING SPACE. ALTERNATE E1BV: CIRCUIT EXIT SIGN TO NEW EMERGENCY LIGHTING BRANCH CIRCUIT AS INDICATED.
- 13. IN SPACES INDICATED TO RECEIVE NEW LIGHTING, PROVIDE OCCUPANCY/VACANCY/PHOTOCELL CONTROL AS REQUIRED TO COMPLY WITH ASHRAE 90.1-2013. REVISE CIRCUITING AS REQUIRED FOR NEW CONTROLS.

# **#** CONSTRUCTION KEY NOTES:

- CIRCUIT LIGHT FIXTURES TO EXISTING LIGHTING BRANCH CIRCUIT SERVING SPACE. EXTEND CONDUIT AND WIRE AS REQUIRED. REWORK SWITCH LEG AS REQUIRED FOR CONTROLS AS INDICATED. WHERE DIMMING SWITCHES ARE INDICATED, PROVIDE NEW 0-10V CABLING. COORDINATE CABLE REQUIREMENTS WITH DIMMING SWITCH AND LIGHT FIXTURE DRIVER MANUFACTURERS.
- REMOVE EXISTING LAMPS AND BALLAST FOR LIGHT FIXTURES IN ROOM. PROVIDE (2) PHILIPS INSTANTFIT LED T8 LAMPS AND (1) PHILIPS TLED DRIVER. PROVIDE NEW QUICK DISCONNECT FITTINGS FOR DRIVER WIRING. LAMPS SHALL BE 4000K COLOR
- REMOVE EXISTING LAMPS AND BALLASTS FOR LIGHT FIXTURES IN ROOM. PROVIDE (3) PHILIPS INSTANTFIT LED T8 LAMPS AND (2) PHILIPS TLED DRIVERS FOR INNER/OUTER LAMP SWITCHING. PROVIDE NEW QUICK DISCONNECT FITTINGS FOR DRIVER WIRING. LAMPS SHALL BE 4000K COLOR TEMP.
- 4. CIRCUIT LIGHT FIXTURES TO EXISTING LIGHTING BRANCH CIRCUIT SERVING SPACE. EXTEND CONDUIT AND WIRE AS REQUIRED. REWORK SWITCH LEG OF BRANCH CIRCUIT AS REQUIRED.
- 5. CIRCUIT NEW OCCUPANCY SENSOR TO EXISTING LIGHTING BRANCH CIRCUIT SO THAT LIGHT FIXTURES ARE CONTROLLED BY EXISTING SWITCHES AND NEW OCCUPANCY SENSOR. REWORK SWITCH LEG AS REQUIRED.
- 6. REFER TO TYPICAL CLASSROOM LIGHTING CONTROL DETAIL FOR REQUIREMENTS OF NEW LIGHTING CONTROLS.
- PROVIDE EMERGENCY LOAD TRANSFER DEVICE (ELTD) AND EMERGENCY BRANCH CIRCUIT AS INDICATED FOR EMERGENCY LIGHT FIXTURE. PROVIDE (1) ELTD PER SWITCHED CIRCUIT. CIRCUIT NORMAL SIDE OF ELTD TO EXISTING LIGHTING BRANCH CIRCUIT SERVING SPACE.
- PROVIDE EMERGENCY LOAD TRANSFER DEVICE (ELTD) AND EMERGENCY BRANCH CIRCUIT AS INDICATED FOR EMERGENCY LIGHT FIXTURE. PROVIDE (1) ELTD PER SWITCHED CIRCUIT. CIRCUIT NORMAL SIDE OF ELTD TO EXISTING LÌGHTING BRANCH
- 9.3 REMOVE EXISTING EXIT SIGN AND AND BRANCH CIRCUIT COMPLETE (CONDUIT AND WIRE). PROVIDE NEW EXIT SIGN (FIXTURE TYPE "X"). CIRCUIT UNSWITCHED TO NEW EMERGENCY LIGHTING BRANCH CIRCUIT AS INDICATED.

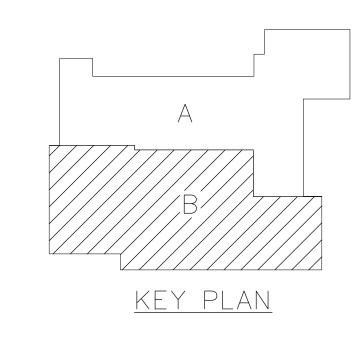

WAKELY ASSOCIATES, INC. ARCHITECTS & ENGINEERS 30500 VAN DYKE AVE. SUITE M-7 WARREN, MICHIGAN, 48093

> TEL. 586-573-4100 FAX. 586-573-0822 -MAIL: WA@WAKELYAIA.COM



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RMIN BEECHVIEW ELEMENTARY SCHOOL LIGHTING NEW WORK PLAN -

**PRELIMINARY** DESIGN DEVELOPMENT CONSTRUCTION


AREA 'B'

FINAL RECORD DRAWN BY: CHECKED BY:

REVISIONS:

ADDENDUM NO. 1 01/03/ DATE: SHEET NO.:

1<sup>JOB NO.:</sup> 171712A <sup>1</sup>

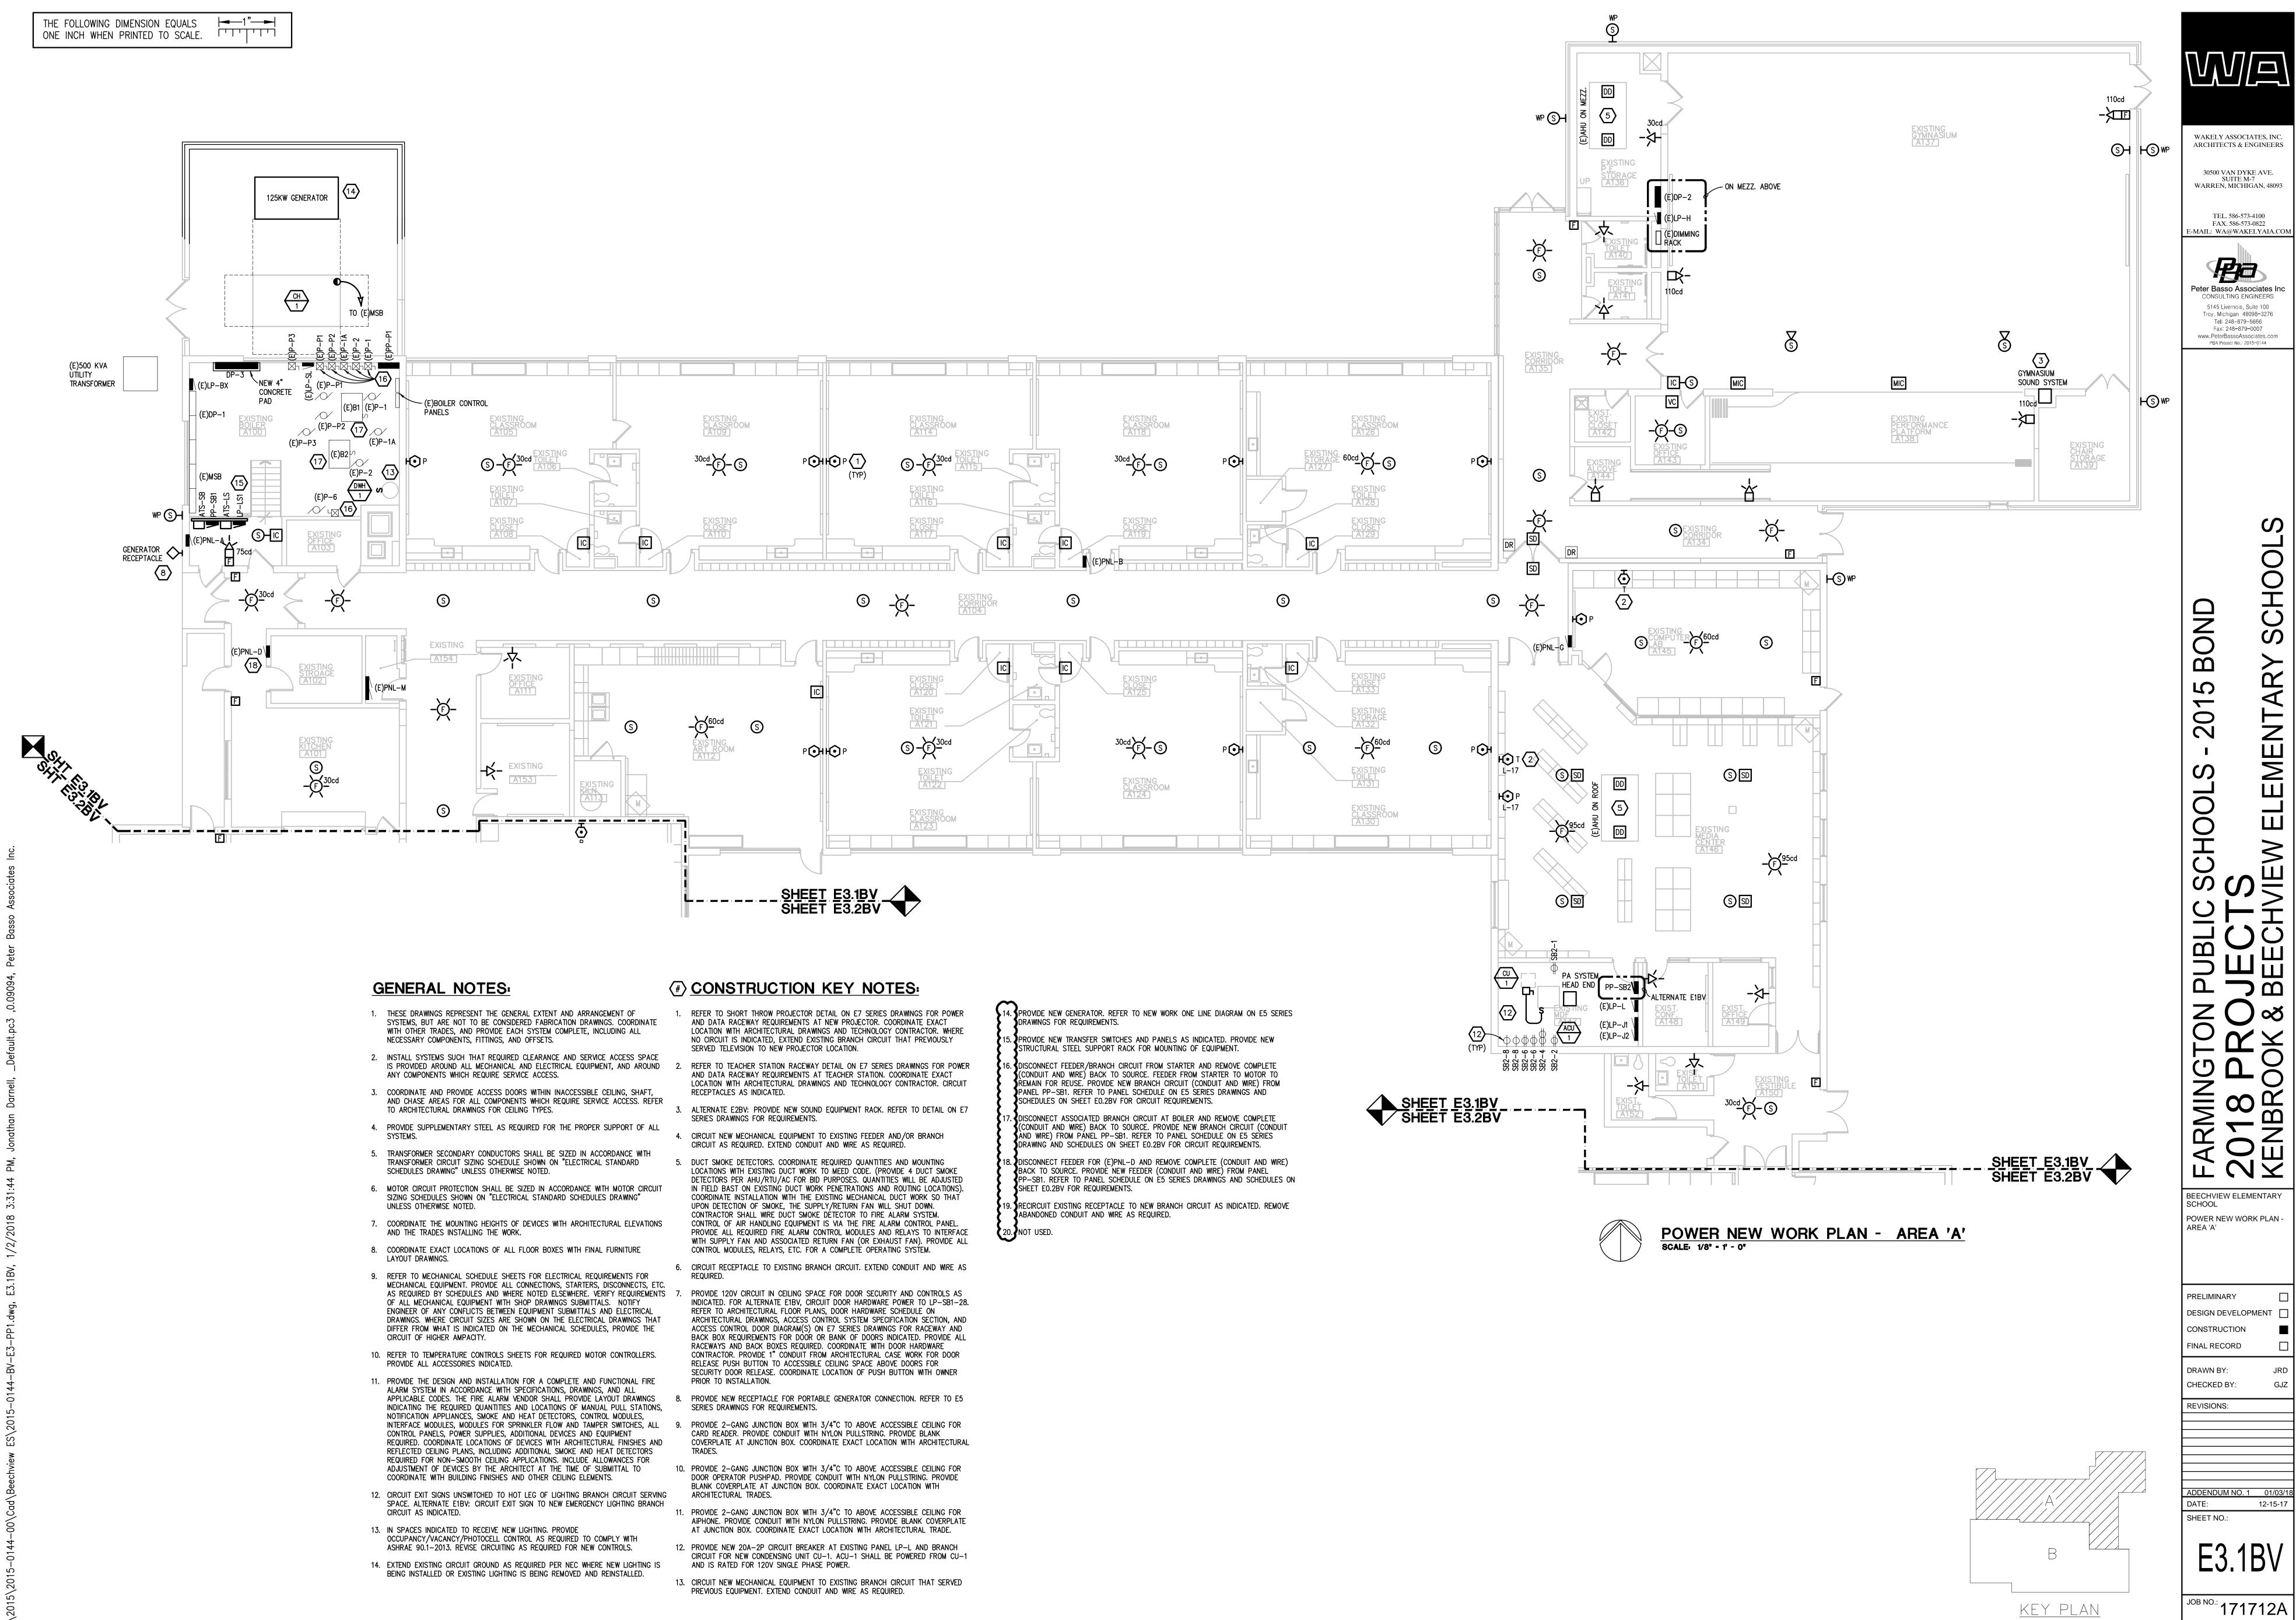

WAKELY ASSOCIATES, INC. ARCHITECTS & ENGINEERS 30500 VAN DYKE AVE. SUITE M-7 WARREN, MICHIGAN, 48093

TEL. 586-573-4100 FAX. 586-573-0822 -MAIL: WA@WAKELYAIA.COM

Peter Basso Associates II 5145 Livernois, Suite 100 Troy, Michigan 48098-3276 Tel: 248-879-5666 Fax: 248-879-0007

www.PeterBassoAssociates.com PBA Project No.: 2015-0144

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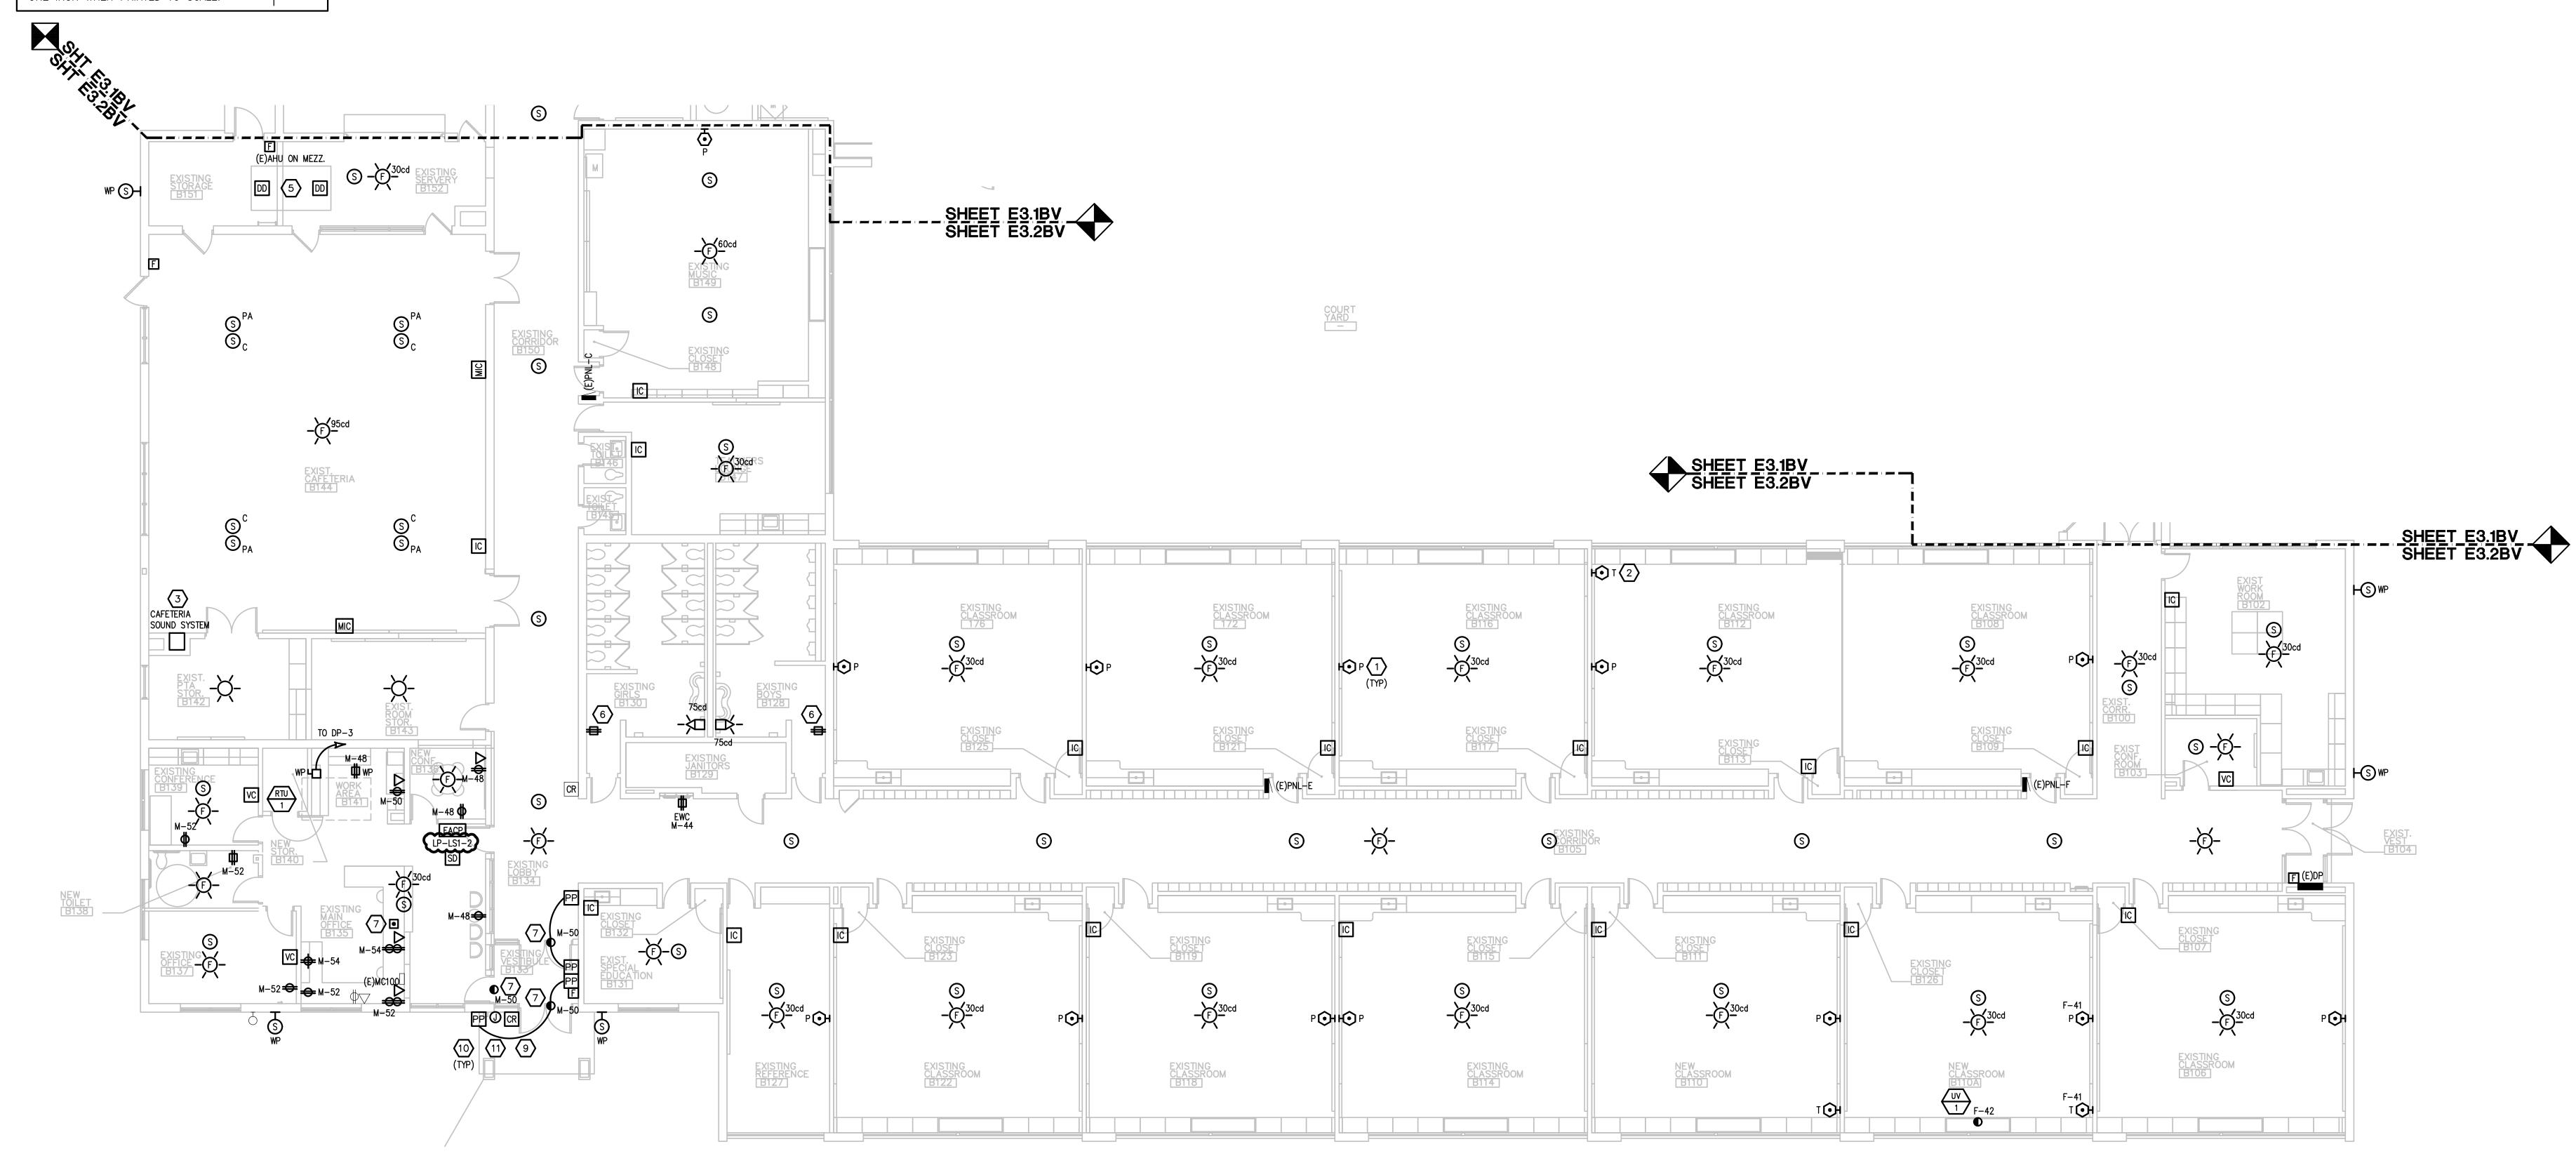
BEECHVIEW ELEMENTARY SCHOOL POWER NEW WORK PLAN -

**PRELIMINARY** DESIGN DEVELOPMENT CONSTRUCTION FINAL RECORD

DRAWN BY: CHECKED BY:

**REVISIONS:** 

ADDENDUM NO. 1 01/03. DATE: 12-15-17 SHEET NO.:



POWER NEW WORK PLAN - AREA 'B' SCALE: 1/8" - 1' - 0"

## **GENERAL NOTES:**

- 1. THESE DRAWINGS REPRESENT THE GENERAL EXTENT AND ARRANGEMENT OF SYSTEMS, BUT ARE NOT TO BE CONSIDERED FABRICATION DRAWINGS. COORDINATE WITH OTHER TRADES, AND PROVIDE EACH SYSTEM COMPLETE, INCLUDING ALL NECESSARY COMPONENTS, FITTINGS, AND OFFSETS.
- IS PROVIDED AROUND ALL MECHANICAL AND ELECTRICAL EQUIPMENT, AND AROUND ANY COMPONENTS WHICH REQUIRE SERVICE ACCESS. 3. COORDINATE AND PROVIDE ACCESS DOORS WITHIN INACCESSIBLE CEILING, SHAFT,

2. INSTALL SYSTEMS SUCH THAT REQUIRED CLEARANCE AND SERVICE ACCESS SPACE

- AND CHASE AREAS FOR ALL COMPONENTS WHICH REQUIRE SERVICE ACCESS. REFER TO ARCHITECTURAL DRAWINGS FOR CEILING TYPES.
- 4. PROVIDE SUPPLEMENTARY STEEL AS REQUIRED FOR THE PROPER SUPPORT OF ALL

5. TRANSFORMER SECONDARY CONDUCTORS SHALL BE SIZED IN ACCORDANCE WITH

TRANSFORMER CIRCUIT SIZING SCHEDULE SHOWN ON "ELECTRICAL STANDARD

- SCHEDULES DRAWING" UNLESS OTHERWISE NOTED. 6. MOTOR CIRCUIT PROTECTION SHALL BE SIZED IN ACCORDANCE WITH MOTOR CIRCUIT SIZING SCHEDULES SHOWN ON "ELECTRICAL STANDARD SCHEDULES DRAWING"
- UNLESS OTHERWISE NOTED. COORDINATE THE MOUNTING HEIGHTS OF DEVICES WITH ARCHITECTURAL ELEVATIONS
- AND THE TRADES INSTALLING THE WORK.
- 8. COORDINATE EXACT LOCATIONS OF ALL FLOOR BOXES WITH FINAL FURNITURE
- 9. REFER TO MECHANICAL SCHEDULE SHEETS FOR ELECTRICAL REQUIREMENTS FOR MECHANICAL EQUIPMENT. PROVIDE ALL CONNECTIONS, STARTERS, DISCONNECTS, ETC. AS REQUIRED BY SCHEDULES AND WHERE NOTED ELSEWHERE. VERIFY REQUIREMENTS OF ALL MECHANICAL EQUIPMENT WITH SHOP DRAWINGS SUBMITTALS. NOTIFY ENGINEER OF ANY CONFLICTS BETWEEN EQUIPMENT SUBMITTALS AND ELECTRICAL DRAWINGS. WHERE CIRCUIT SIZES ARE SHOWN ON THE ELECTRICAL DRAWINGS THAT DIFFER FROM WHAT IS INDICATED ON THE MECHANICAL SCHEDULES, PROVIDE THE CIRCUIT OF HIGHER AMPACITY.
- 10. REFER TO TEMPERATURE CONTROLS SHEETS FOR REQUIRED MOTOR CONTROLLERS. PROVIDE ALL ACCESSORIES INDICATED.
- 11. PROVIDE THE DESIGN AND INSTALLATION FOR A COMPLETE AND FUNCTIONAL FIRE ALARM SYSTEM IN ACCORDANCE WITH SPECIFICATIONS, DRAWINGS, AND ALL INDICATING THE REQUIRED QUANTITIES AND LOCATIONS OF MANUAL PULL STATIONS, NOTIFICATION APPLIANCES, SMOKE AND HEAT DETECTORS, CONTROL MODULES, INTERFACE MODULES, MODULES FOR SPRINKLER FLOW AND TAMPER SWITCHES, ALL CONTROL PANELS, POWER SUPPLIES, ADDITIONAL DEVICES AND EQUIPMENT REQUIRED. COORDINATE LOCATIONS OF DEVICES WITH ARCHITECTURAL FINISHES AND REFLECTED CEILING PLANS, INCLUDING ADDITIONAL SMOKE AND HEAT DETECTORS REQUIRED FOR NON-SMOOTH CEILING APPLICATIONS. INCLUDE ALLOWANCES FOR ADJUSTMENT OF DEVICES BY THE ARCHITECT AT THE TIME OF SUBMITTAL TO COORDINATE WITH BUILDING FINISHES AND OTHER CEILING ELEMENTS.
- 12. CIRCUIT EXIT SIGNS UNSWITCHED TO HOT LEG OF LIGHTING BRANCH CIRCUIT SERVING SPACE. ALTERNATE E1BV: CIRCUIT EXIT SIGN TO NEW EMERGENCY LIGHTING BRANCH CIRCUIT AS INDICATED.
- 13. IN SPACES INDICATED TO RECEIVE NEW LIGHTING. PROVIDE OCCUPANCY/VACANCY/PHOTOCELL CONTROL AS REQUIRED TO COMPLY WITH
- ASHRAE 90.1-2013. REVISE CIRCUITING AS REQUIRED FOR NEW CONTROLS. 14. EXTEND EXISTING CIRCUIT GROUND AS REQUIRED PER NEC WHERE NEW LIGHTING IS

BEING INSTALLED OR EXISTING LIGHTING IS BEING REMOVED AND REINSTALLED.

## **#** CONSTRUCTION KEY NOTES:

- REFER TO SHORT THROW PROJECTOR DETAIL ON E7 SERIES DRAWINGS FOR POWER AND DATA RACEWAY REQUIREMENTS AT NEW PROJECTOR. COORDINATE EXACT LOCATION WITH ARCHITECTURAL DRAWINGS AND TECHNOLOGY CONTRACTOR. WHERE NO CIRCUIT IS INDICATED, EXTEND EXISTING BRANCH CIRCUIT THAT PREVIOUSLY SERVED TELEVISION TO NEW PROJECTOR LOCATION.
- REFER TO TEACHER STATION RACEWAY DETAIL ON E7 SERIES DRAWINGS FOR POWER AND DATA RACEWAY REQUIREMENTS AT TEACHER STATION. COORDINATE EXACT LOCATION WITH ARCHITECTURAL DRAWINGS AND TECHNOLOGY CONTRACTOR. CIRCUIT RECEPTACLES AS INDICATED.
- ALTERNATE E2BV: PROVIDE NEW SOUND EQUIPMENT RACK. REFER TO DETAIL ON E7 SERIES DRAWINGS FOR REQUIREMENTS.
- CIRCUIT NEW MECHANICAL EQUIPMENT TO EXISTING FEEDER AND/OR BRANCH CIRCUIT AS REQUIRED. EXTEND CONDUIT AND WIRE AS REQUIRED.
- DUCT SMOKE DETECTORS. COORDINATE REQUIRED QUANTITIES AND MOUNTING LOCATIONS WITH EXISTING DUCT WORK TO MEED CODE. (PROVIDE 4 DUCT SMOKE DETECTORS PER AHU/RTU/AC FOR BID PURPOSES. QUANTITIES WILL BE ADJUSTED IN FIELD BAST ON EXISTING DUCT WORK PENETRATIONS AND ROUTING LOCATIONS). COORDINATE INSTALLATION WITH THE EXISTING MECHANICAL DUCT WORK SO THAT UPON DETECTION OF SMOKE, THE SUPPLY/RETURN FAN WILL SHUT DOWN. CONTRACTOR SHALL WIRE DUCT SMOKE DÉTECTOR TO FIRE ALARM SYSTEM. CONTROL OF AIR HANDLING EQUIPMENT IS VIA THE FIRE ALARM CONTROL PANEL. PROVIDE ALL REQUIRED FIRE ALARM CONTROL MODULES AND RELAYS TO INTERFACE WITH SUPPLY FAN AND ASSOCIATED RETURN FAN (OR EXHAUST FAN). PROVIDE ALL CONTROL MODULES, RELAYS, ETC. FOR A COMPLETE OPERATING SYSTEM.
- CIRCUIT RECEPTACLE TO EXISTING BRANCH CIRCUIT. EXTEND CONDUIT AND WIRE AS
- PROVIDE 120V CIRCUIT IN CEILING SPACE FOR DOOR SECURITY AND CONTROLS AS INDICATED. FOR ALTERNATE E1BV, CIRCUIT DOOR HARDWARE POWER TO LP-SB1-28. REFER TO ARCHITECTURAL FLOOR PLANS, DOOR HARDWARE SCHEDULE ON ARCHITECTURAL DRAWINGS, ACCESS CONTROL SYSTEM SPECIFICATION SECTION, AND ACCESS CONTROL DOOR DIAGRAM(S) ON E7 SERIES DRAWINGS FOR RACEWAY AND BACK BOX REQUIREMENTS FOR DOOR OR BANK OF DOORS INDICATED. PROVIDE ALL RACEWAYS AND BACK BOXES REQUIRED. COORDINATE WITH DOOR HARDWARE CONTRACTOR. PROVIDE 1" CONDUIT FROM ARCHITECTURAL CASE WORK FOR DOOR RELEASE PUSH BUTTON TO ACCESSIBLE CEILING SPACE ABOVE DOORS FOR SECURITY DOOR RELEASE. COORDINATE LOCATION OF PUSH BUTTON WITH OWNER PRIOR TO INSTALLATION.
- APPLICABLE CODES. THE FIRE ALARM VENDOR SHALL PROVIDE LAYOUT DRAWINGS 8. PROVIDE NEW RECEPTACLE FOR PORTABLE GENERATOR CONNECTION. REFER TO E5 SERIES DRAWINGS FOR REQUIREMENTS.
  - PROVIDE 2-GANG JUNCTION BOX WITH 3/4"C TO ABOVE ACCESSIBLE CEILING FOR CARD READER. PROVIDE CONDUIT WITH NYLON PULLSTRING. PROVIDE BLANK COVERPLATE AT JUNCTION BOX. COORDINATE EXACT LOCATION WITH ARCHITECTURAL
  - 10. PROVIDE 2-GANG JUNCTION BOX WITH 3/4"C TO ABOVE ACCESSIBLE CEILING FOR DOOR OPERATOR PUSHPAD. PROVIDE CONDUIT WITH NYLON PULLSTRING. PROVIDE BLANK COVERPLATE AT JUNCTION BOX. COORDINATE EXACT LOCATION WITH ARCHITECTURAL TRADES.
  - 11. PROVIDE 2-GANG JUNCTION BOX WITH 3/4"C TO ABOVE ACCESSIBLE CEILING FOR AIPHONE. PROVIDE CONDUIT WITH NYLON PULLSTRING, PROVIDE BLANK COVERPLATE AT JUNCTION BOX. COORDINATE EXACT LOCATION WITH ARCHITECTURAL TRADE.
  - 12. PROVIDE NEW 20A-2P CIRCUIT BREAKER AT EXISTING PANEL LP-L AND BRANCH CIRCUIT FOR NEW CONDENSING UNIT CU-1. ACU-1 SHALL BE POWERED FROM CU-1 AND IS RATED FOR 120V SINGLE PHASE POWER.

13. CIRCUIT NEW MECHANICAL EQUIPMENT TO EXISTING BRANCH CIRCUIT THAT SERVED PREVIOUS EQUIPMENT. EXTEND CONDUIT AND WIRE AS REQUIRED.

14. PROVIDE NEW GENERATOR. REFER TO NEW WORK ONE LINE DIAGRAM ON E5 SERIES


- DRAWINGS FOR REQUIREMENTS. PROVIDE NEW TRANSFER SWITCHES AND PANELS AS INDICATED. PROVIDE NEW
- STRUCTURAL STEEL SUPPORT RACK FOR MOUNTING OF EQUIPMENT. (CONDUIT AND WIRE) BACK TO SOURCE. FEEDER FROM STARTER TO MOTOR TO REMAIN FOR REUSE. PROVIDE NEW BRANCH CIRCUIT (CONDUIT AND WIRE) FROM PANEL PP-SB1. REFER TO PANEL SCHEDULE ON E5 SERIES DRAWINGS AND

SCHEDULES ON SHEET E0.2BV FOR CIRCUIT REQUIREMENTS.

 $\P(\mathsf{CONDUIT}|\mathsf{AND}|\mathsf{WIRE})$  BACK TO SOURCE. PROVIDE NEW BRANCH CIRCUIT (CONDUIT TAND WIRE) FROM PANEL PP-SB1. REFER TO PANEL SCHEDULE ON E5 SERIES DRAWING AND SCHEDULES ON SHEET E0.2BV FOR CIRCUIT REQUIREMENTS. 8. DISCONNECT FEEDER FOR (E)PNL-D AND REMOVE COMPLETE (CONDUIT AND WIRE)

 ✓DISCONNECT ASSOCIATED BRANCH CIRCUIT AT BOILER AND REMOVE COMPLETE

- BACK TO SOURCE. PROVIDE NEW FEEDER (CONDUIT AND WIRE) FROM PANEL PP-SB1. REFER TO PANEL SCHEDULE ON E5 SERIES DRAWINGS AND SCHEDULES ON SHEET E0.2BV FOR REQUIREMENTS.
- 9. RECIRCUIT EXISTING RECEPTACLE TO NEW BRANCH CIRCUIT AS INDICATED. REMOVE ABANDONED CONDUIT AND WIRE AS REQUIRED.

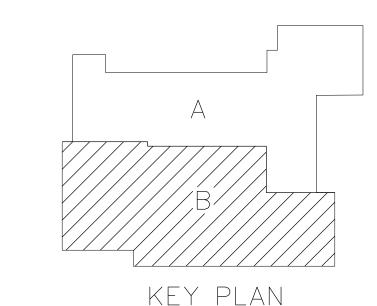

WAKELY ASSOCIATES, INC. ARCHITECTS & ENGINEERS 30500 VAN DYKE AVE. SUITE M-7 WARREN, MICHIGAN, 48093

> TEL. 586-573-4100 FAX. 586-573-0822 -MAIL: WA@WAKELYAIA.COM



Peter Basso Associates I www.PeterBassoAssociates.com PBA Project No.: 2015-0144

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BEECHVIEW ELEMENTARY SCHOOL POWER NEW WORK PLAN -

**PRELIMINARY** DESIGN DEVELOPMENT CONSTRUCTION FINAL RECORD


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ADDENDUM NO. 1 01/03/

DATE: 12-15-17 SHEET NO.:

1 JOB NO.: 171712A '

# ONE LINE DIAGRAM - DEMOLITION NO SCALE

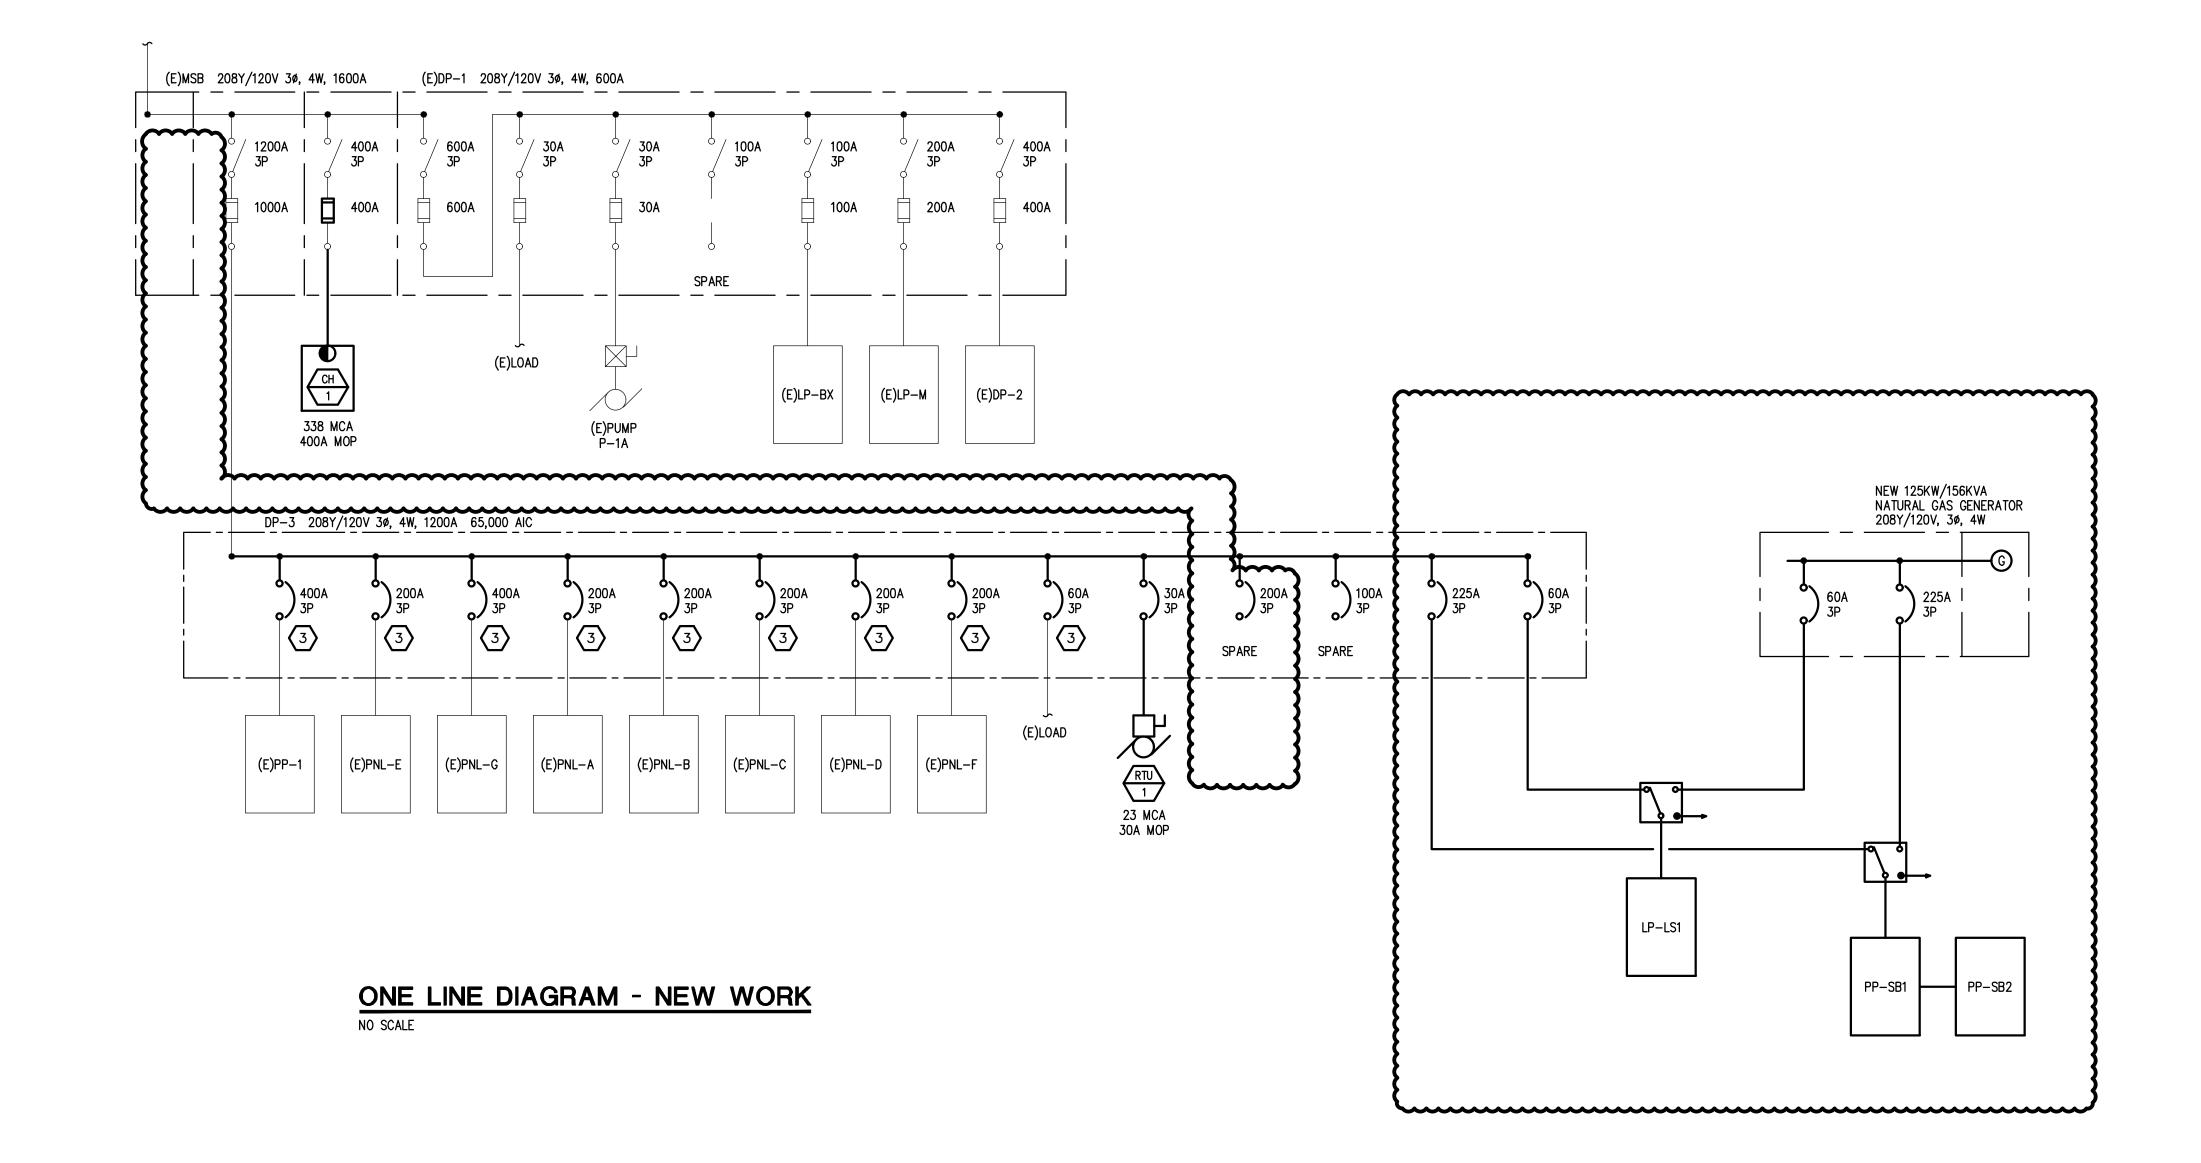

### **GENERAL NOTES:**

- 1. THESE DRAWINGS REPRESENT THE GENERAL EXTENT AND ARRANGEMENT OF SYSTEMS, BUT ARE NOT TO BE CONSIDERED FABRICATION DRAWINGS. COORDINATE WITH OTHER TRADES, AND PROVIDE EACH SYSTEM COMPLETE, INCLUDING ALL NECESSARY COMPONENTS, FITTINGS, AND OFFSETS.
- 2. FEEDER AND BRANCH CIRCUIT CONDUCTORS SHALL BE SIZED IN ACCORDANCE WITH THE "FEEDER AND BRANCH CIRCUIT SIZING SCHEDULE-GENERAL PURPOSE" ON THE "ELECTRICAL STANDARD SCHEDULES DRAWING" UNLESS SPECIFICALLY NOTED
- 3. TRANSFORMER SECONDARY CONDUCTORS SHALL BE SIZED IN ACCORDANCE WITH THE "TRANSFORMER CIRCUIT SIZING SCHEDULE-GENERAL PURPOSE" ON THE "ELECTRICAL STANDARD SCHEDULES DRAWING" UNLESS SPECIFICALLY NOTED OTHERWISE.
- 4. MOTOR CIRCUIT PROTECTION SHALL BE SIZED IN ACCORDANCE WITH THE MOTOR CIRCUIT SIZING SCHEDULES ON THE "ELECTRICAL STANDARD SCHEDULES DRAWING" UNLESS SPECIFICALLY NOTED OTHERWISE.
- 5. BASIS OF DESIGN IS SIEMENS DISTRIBUTION EQUIPMENT AND ASCO TRANSFER SWITCHES. IF THE CONTRACTOR ELECTS TO PROVIDE EQUIPMENT FROM OTHER APPROVED MANUFACTURERS, THE CONTRACTOR SHALL BE RESPONSIBLE TO COORDINATE THE LAYOUT AND CLEARANCE REQUIREMENTS IN ALL SPACES CONTAINING ELECTRICAL EQUIPMENT AND PROVIDE EQUIPMENT MEETING THE SPECIFICATIONS AND ACHIEVING CODE REQUIRED CLEARANCES WITHIN THE SPACE
- 6. BRANCH CIRCUIT CONDUCTORS, FEEDERS, AND BRANCH CIRCUIT OVERCURRENT PROTECTION ARE SIZED AT 125% OF THE TOTAL CONTINUOUS AND NON CONTINUOUS LOAD FOR LIGHTING AND MOTOR LOADS THAT RUN CONTINUOUSLY FOR THREE HOURS OR MORE (NEC 210.19 A, 210.20 A, AND 215.2 A). DEMAND AND CONNECTED LOADS ARE CALCULATED PER NEC 220.
- 7. VARIABLE FREQUENCY CONTROLLERS (VFC) FURNISHED BY MECHANICAL TRADES. ELECTRICAL CONTRACTOR SHALL INSTALL VFC, PROVIDE POWER FEEDER FROM DISTRIBUTION EQUIPMENT TO VFC AND PROVIDE POWER FEEDER FROM VFC TO MOTOR. REFER TO SPECIFICATIONS FOR APPLICATION OF VFC POWER CABLE FROM VFC TO MOTOR.

### **#** CONSTRUCTION KEY NOTES:

(1.) NOT USED. 2. NOT USED.

> 3. FIELD VERIFY BRANCH CIRCUIT CONDUCTOR SIZES OF OLD MDP AND PROVIDE NEW CIRCUIT BREAKERS IN NEW DP-3 WITH THE BREAKER SIZED BASED UPON THE EXISTING CONDUCTOR SIZES. FIELD VERIFY PRIOR TO ORDERING NEW PANEL DP-3. EXTEND BRANCH CIRCUITING AS REQUIRED.

4.) NOT USED.

## **BUILDING CONNECTED CALCULATIONS**

(E)METERED LOAD = 224 KVA X 125% METERED PER N.E.C. 220.87	280 KVA	ADDITIONAL LOAD TO MDP		
ADDITONAL LOAD TO MDP	35 KVA	<u>CH-1</u>	122 k	KVA
		<u>RTU-1</u>	8 I	KVA
TOTAL NEW BUILDING LOAD	315 KVA	<u>LP-M</u>	33 k	KVA
		TOTAL ADDED LOAD	163 H	KVA
		REMOVED LOAD (ACC-1A)	128 k	KVA
		ADDITONAL LOAD TO MDP	35 k	KVA


PRELIMINARY DESIGN DEVELOPMENT CONSTRUCTION FINAL RECORD

DRAWN BY: CHECKED BY:

**REVISIONS:** 

E5.1BV

JOB NO.: 171712A

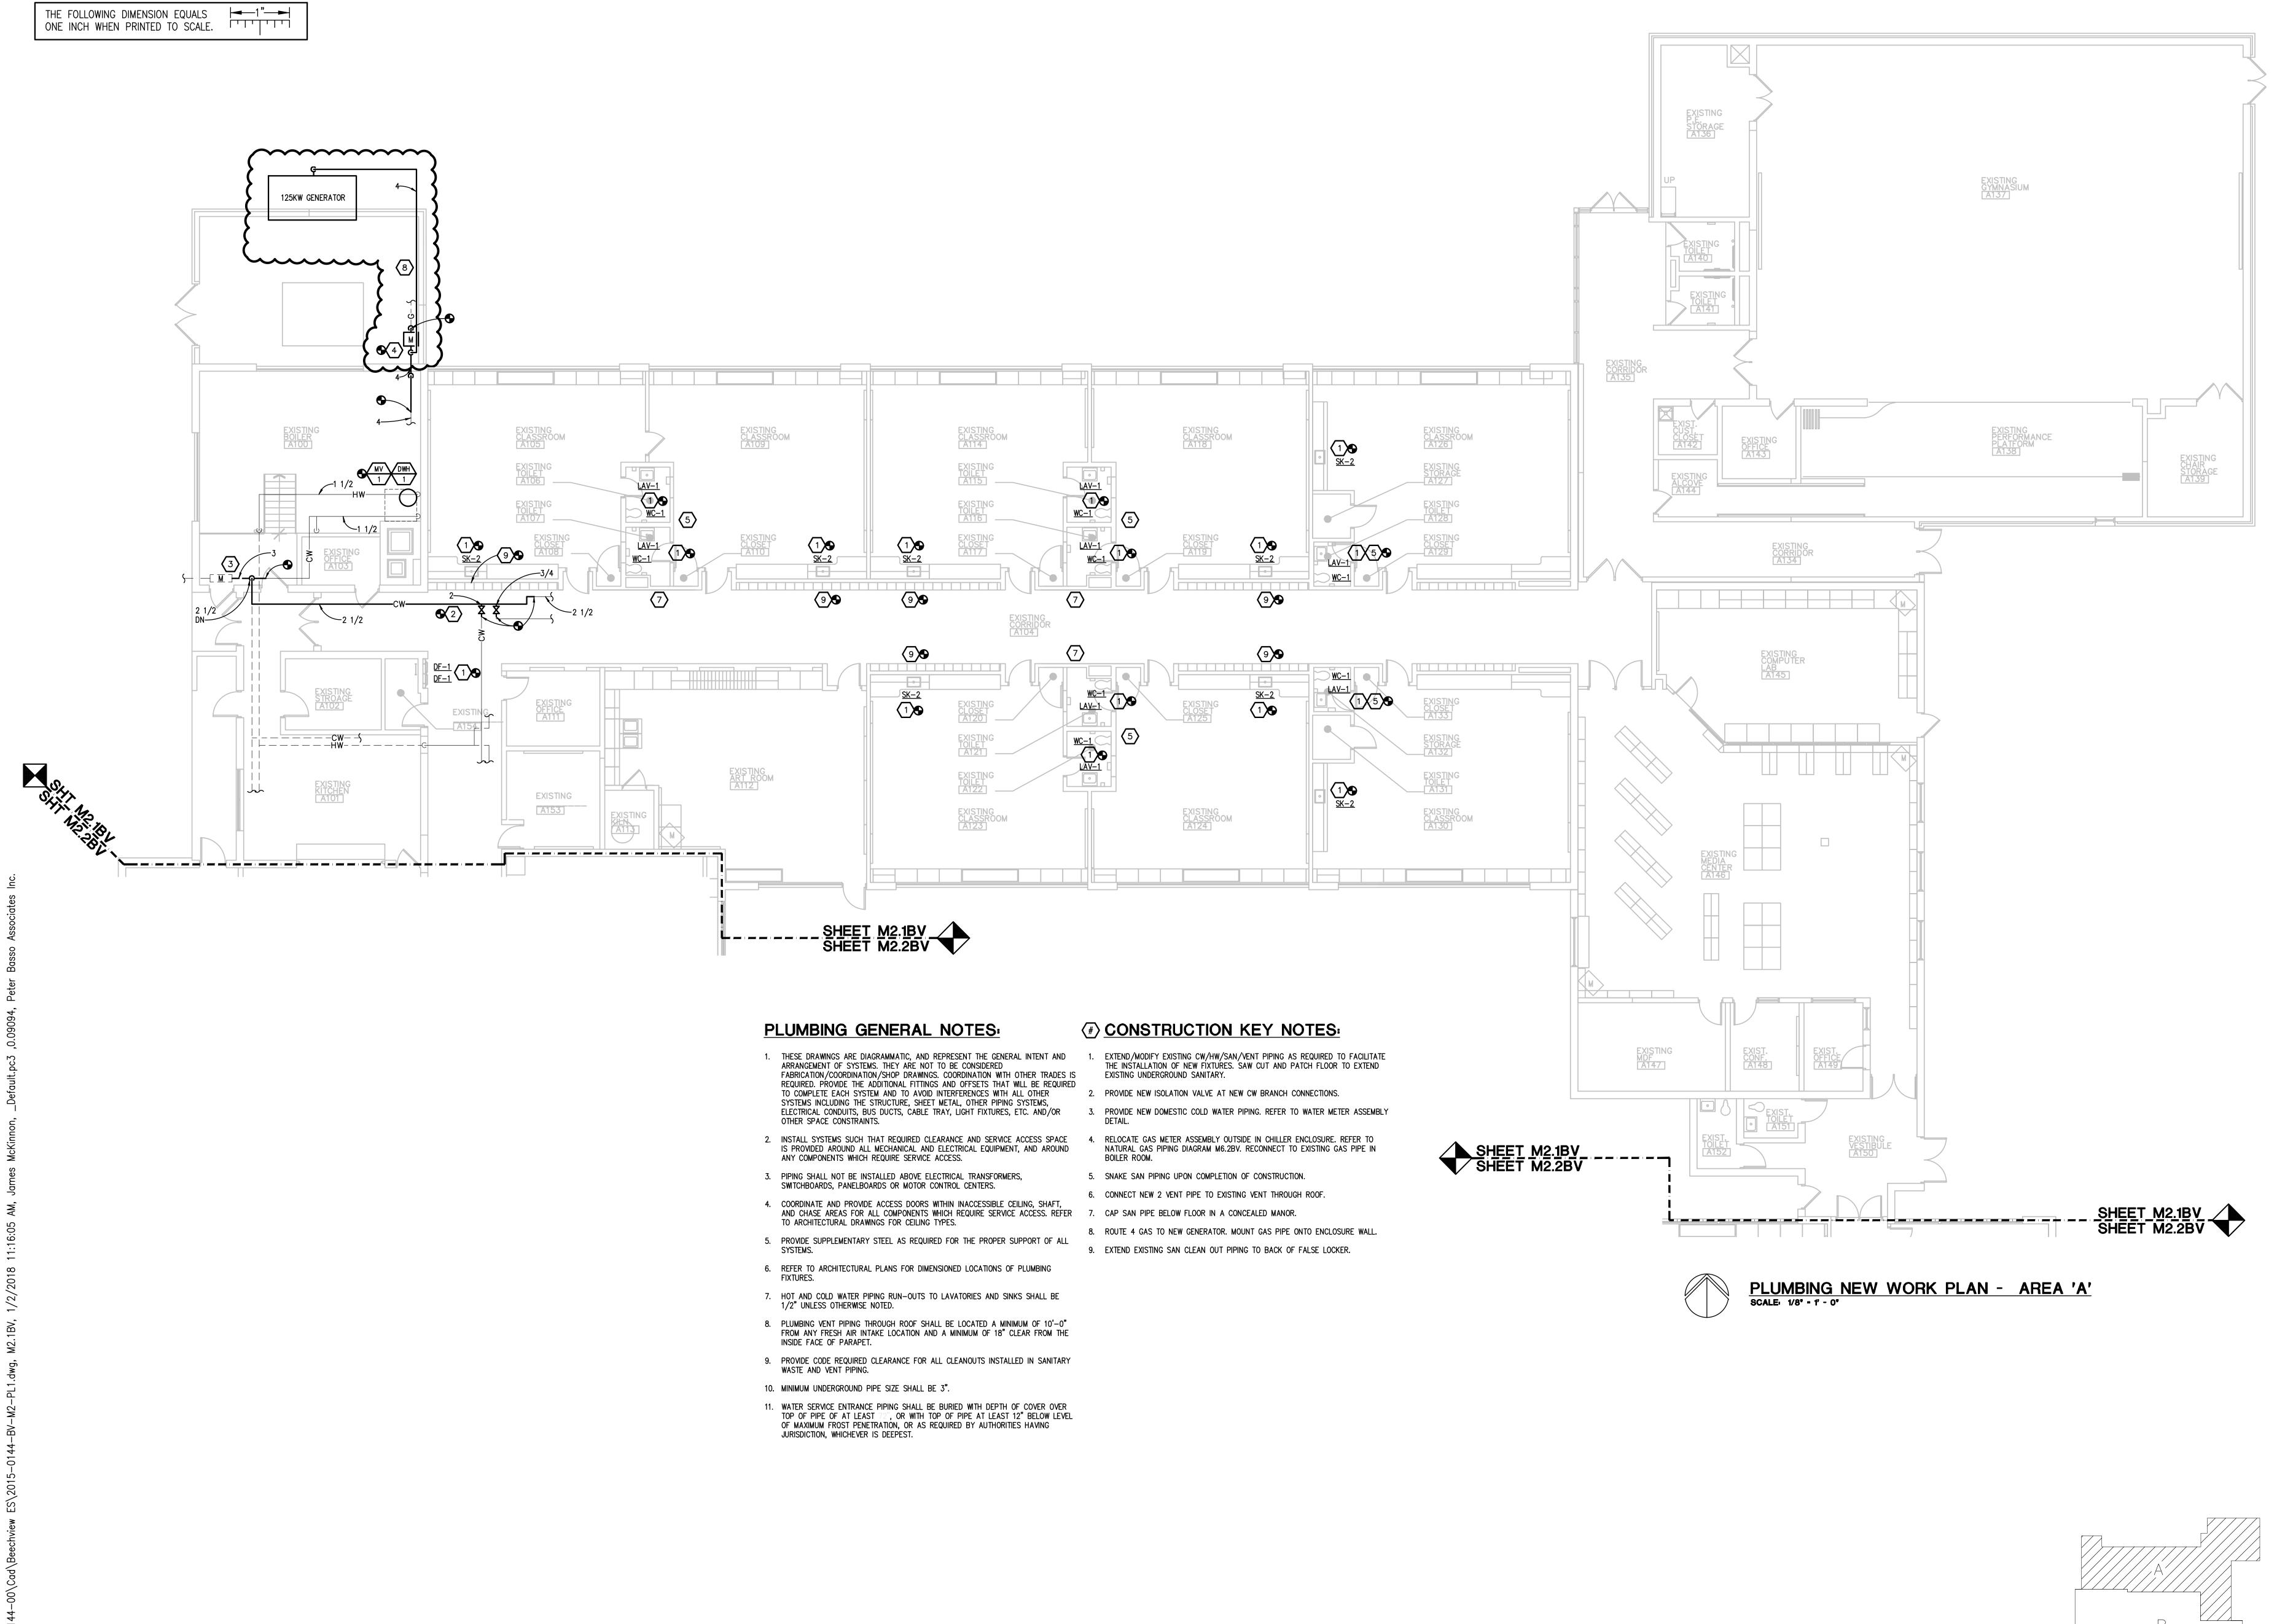

WAKELY ASSOCIATES, INC. ARCHITECTS & ENGINEERS 30500 VAN DYKE AVE. SUITE M-7 WARREN, MICHIGAN, 48093

> TEL. 586-573-4100 FAX. 586-573-0822 E-MAIL: WA@WAKELYAIA.COM

Peter Basso Associates In CONSULTING ENGINEERS Fax: 248-879-0007

5145 Livernois, Suite 100 Troy, Michigan 48098-3276 Tel: 248-879-5666 www.PeterBassoAssociates.com PBA Project No.: 2015-0144

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BEECHVIEW ELEMENTARY SCHOOL PLUMBING NEW WORK PLAN

PRELIMINARY DESIGN DEVELOPMENT CONSTRUCTION FINAL RECORD


DRAWN BY: REVISIONS:
ADDENDUM NO. 1 01/03

JOB NO.: 171712A <u>key plan</u>


TRAP DIMENSION TABLE										
T/DE 05	S.P. AT COIL DRAIN PAN (IN.) (NOTE A)	DIMENSION "A" (INCHES) MIN.	DIMENSION "B" (INCHES)	DIMENSION "C" (INCHES) (TRAP SEAL)	DIMENSION "D" (INCHES)	DIMENSION "E" (INCHES)	DIMENSION "F" (INCHES)  DRAIN PIPE SIZE (INCHES)			
TYPE OF SYSTEM										
							1 1/2	2	2 1/2, 3	4
	−5.1 TO −6	5.0	5.0	2	6	2	13.0	14.0	15.0	16.0
элсн	<b>−4.1 TO −5</b>	4.5	4.5	2	5	2	12.0	13.0	14.0	15.0
THR(	-3.1 TO -4	4.0	4.0	2	4	2	11.0	12.0	13.0	14.0
DRAW THROUGH	-2.1 TO -3	3.5	3.5	2	3	2	10.0	11.0	12.0	13.0
	UP TO -2	3.0	3.0	2	2	2	9.0	10.0	11.0	12.0
	UP TO +2	4.0	2.0	2	2	4	9.0	10.0	11.0	12.0
ЭЛСН	+2.1 TO +3	5.0	2.0	2	3	5	10.0	11.0	12.0	13.0
BLOW THROUGH	+3.1 TO +4	6.0	2.0	2	4	6	11.0	12.0	13.0	14.0
BLOW	+4.1 TO +5	7.0	2.0	2	5	7	12.0	13.0	14.0	15.0
	+5.1 TO +6	8.0	2.0	2	6	8	13.0	14.0	15.0	16.0


NOTES: A. REFER TO ROOFTOP AIR HANDLING UNIT (COMMERCIAL, UNITARY, MODULAR) SCHEDULE

- FOR (-) OR (+) STATIC PRESSURE AT COIL DRAIN PAN. B. ENERGY RECOVERY UNIT HEAT EXCHANGER CONDENSATE PAN TRAP PIPING OUTSIDE
- CASING SHALL BE INSULATED AND HEAT TRACED. C. DIMENSION "G" IS MIN: 3" FOR UP TO 1 1/2" DRAIN PIPE
  - 4" FOR 2" DRAIN PIPE 5" FOR 2 1/2" OR 3" DRAIN PIPE
- 6" FOR 4" DRAIN PIPE D. PROVIDE ROOF CURB WITH ADEQUATE HEIGHT TO MEET DIMENSION "F"

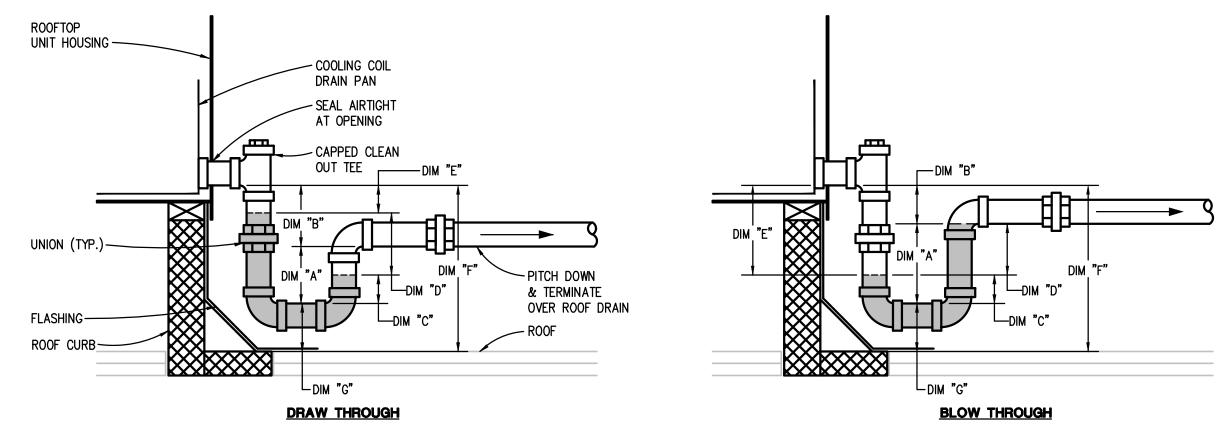


ROOFTOP AIR HANDLING UNIT CONDENSATE DRAIN PAN TRAP DETAIL NO SCALE

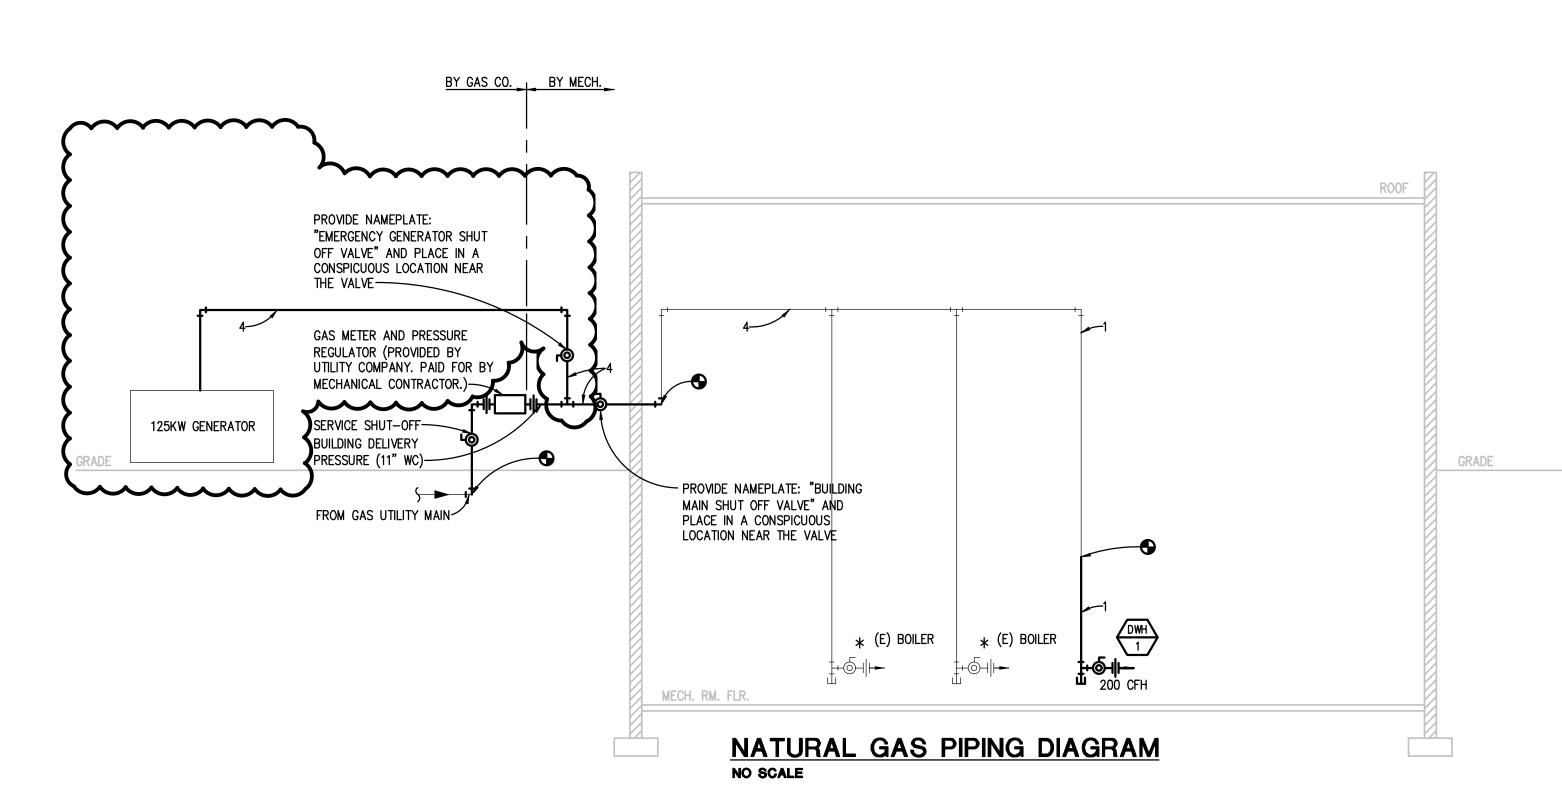


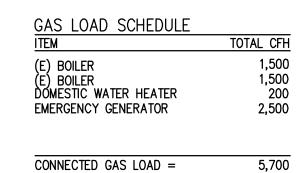

\*GAS TRAIN PROVIDED BY EQUIPMENT MANUFACTURER - SEE SPECIFICATIONS \*\* GAS PRESSURE REGULATOR PROVIDED BY FOOD SERVICE MANUFACTURER \*\*\* THE GAS SERVICE COMPONENTS SHALL BE RATED IN ACCORDANCE WITH THE FOLLOWING CHART METER OUTLET MINIMUM SYSTEM PRESSURE RATING PRESSURE (psig)

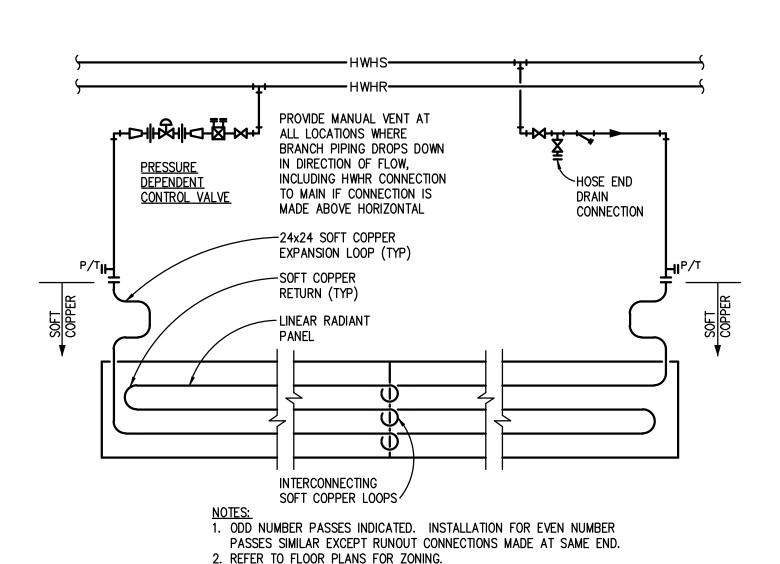


END FEED LINEAR RADIANT CEILING PANEL PIPING DIAGRAM

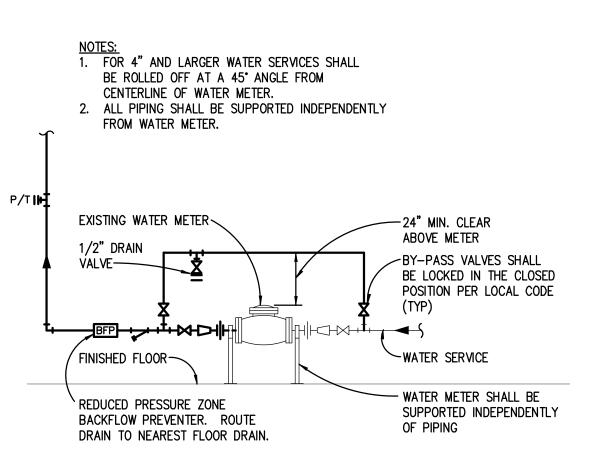


DOMESTIC WATER METER PIPING DIAGRAM
NO SCALE

RETURN FLOW.


SETTINGS.

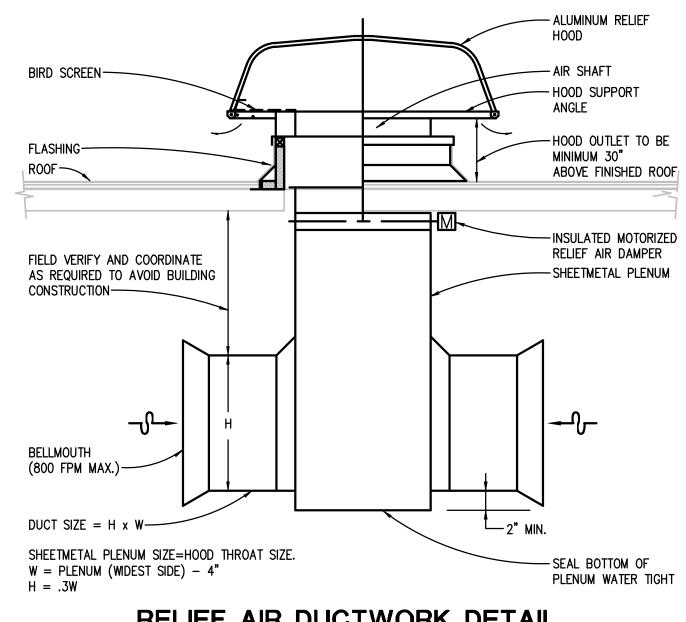

RELIEF AIR DUCTWORK DETAIL NO SCALE

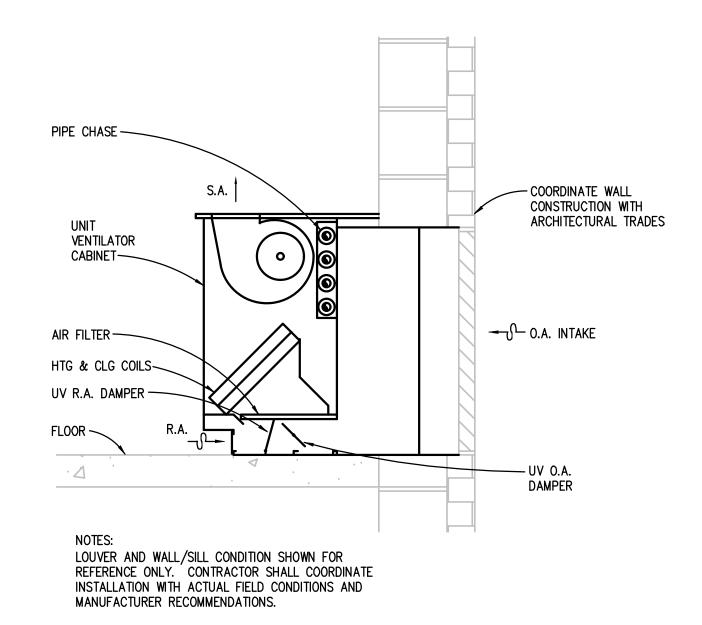

UNIT VENTILATOR INSTALLATION DETAIL

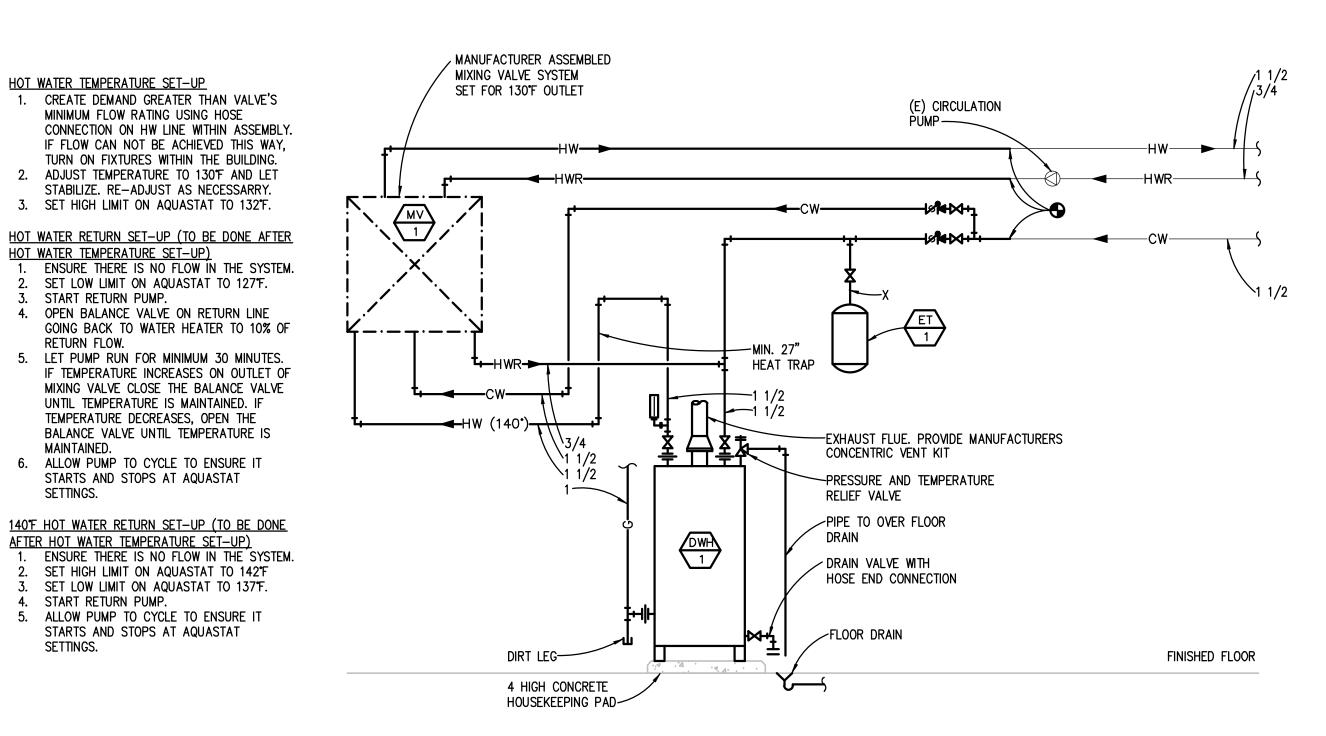

GAS FIRED ATMOSPHERIC VENT WATER
HEATER WITH MIXING VALVE PIPING DIAGRAM
NO SCALE



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WAKELY ASSOCIATES, INC.

**ARCHITECTS & ENGINEERS** 

30500 VAN DYKE AVE. SUITE M-7

WARREN, MICHIGAN, 48093

TEL. 586-573-4100

20 RMING. BEECHVIEW ELEMENTARY SCHOOL

MECHANICAL DETAILS **PRELIMINARY** 

DESIGN DEVELOPMENT CONSTRUCTION FINAL RECORD DRAWN BY: CHECKED BY:

**REVISIONS:** ADDENDUM NO. 1 01/03

DATE: 12-15-17 SHEET NO.:

JOB NO.: 171712A