# **Construction Change Directive**

<b>PROJECT:</b> (name and address)	
Highland Township Fire Station	2
PIA #18-122B	

**OWNER:** (name and address) Highland Township 250 W. Livingston Road Highland, MI 48357

### **CONTRACT INFORMATION:**

Contract For: General Construction

**ARCHITECT:** (name and address)
PARTNERS in Architecture, PLC
65 Market Street

Mount Clemens, MI 48043

### CCD INFORMATION:

Directive Number: 001 Date: July 13, 2021

**CONTRACTOR:** (name and address)
Axiom Construction Services Group, LLC

7789 E. M-36

Whitmore Lake, MI 48189

The Contractor is hereby directed to make the following change(s) in this Contract: (Insert a detailed description of the change and, if applicable, attach or reference specific exhibits.)

Refer to attached "Exhibit A" - Write Up
Refer to attached "Exhibit B" - Specifications
Refer to attached "Exhibit C" - Revised Drawings

### PROPOSED ADJUSTMENTS

- - As follows: These changes will result in an add to the contract. The final amount is to be determined. An adjustment will be made to the contract amount, afterwards, via Change Order.
- 2. The Contract Time is proposed to remain unchanged. The proposed adjustment, if any, is (0 days).

NOTE: The Owner, Architect and Contractor should execute a Change Order to supersede this Construction Change Directive to the extent they agree upon adjustments to the Contract Sum, Contract Time, or Guaranteed Maximum price for the change(s) described herein.

When signed by the Owner and Architect and received by the Contractor, this document becomes effective IMMEDIATELY as a Construction Change Directive (CCD), and the Contractor shall proceed with the change(s) described above.

Contractor signature indicates agreement with the proposed adjustments in Contract Sum and Contract Time set forth in this CCD.

PARTNERS in Architecture, PLC

Highland Township

Axiom Construction Services Group,

LLC

OWNER (Firm name)

CONTRACTOR (Firm name)

SIGNATURE

Joseph Valeri, RA, NCARB, LEED GA, Senior Project Architect

PRINTED NAME AND TITLE

July 13, 2021

DATE

SIGNATURE

**DATE** 

Ken Chapman, Fire Chief

PRINTED NAME AND TITLE

SIGNATURE

Deib Mougrabi, Director of Field Operations

PRINTED NAME AND TITLE

DATE

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User Notes: (3B9ADA56)

Highland Township CCD No. 1 July 13, 2021 Page 1

# "EXHIBIT A" - CCD NO. 1

Project Name: Highland Township – Highland Township Fire Station No. 2 CCD No: One (1)

Project Number: 18-122B Issue Date: July 13, 2021

Project Location: 2550 E. Wardlow Rd., Highland, MI 48356

This Addendum forms a part of the above described Bidding/Permit Construction Documents and supersedes, supplements or clarifies parts thereof to the extent defined by the terms set forth in this Construction Change Directive.

This CCD consists of (3) three typed pages and the following attachments:

Specifications: 102800 Toilet Accessories

Drawings: Site Topographic Survey (TS-1), Site Layout Plan (SP-1), Site Soil Erosion & Sedimentation Control

Plan (SE-1), Site Paving & Grading Plan (C-1), Site Stormwater Management Plan & Details (C-2), Site Utilities Plan (C-3), Site Storm Sewer Profiles (C-4), Site Water Main Profiles (C-5), Site Septic System Details (C-6), Dimension Plan (A3-03), Enlarged Floor Plans (A3-10), Plan Details (A3-21), Reflected Ceiling Plans & Details (A4-01), Floor Plans – Fire Protection (FP0-01), Floor Plans – Sanitary & Vent (M1-01), Floor Plans – Domestic Water (M1-02), Floor Plans – Piping (M3-01),

Mechanical Details (M5-01) and Floor Plans – Power (E3-00).

# **EXHIBIT B - SPECIFICATIONS:**

ITEM SP1 SPECIFICATION SECTION 102800 – TOILET ACCESSORIES

**Steel Equipment** A. Changed typical size of Mirror Unit TA-4, in Section 2.1 Washroom Accessories, paragraph C.4, to 24" x 36" if not otherwise noted on the drawings.

### **EXHIBIT C - DRAWINGS:**

CIVIL Janette & Sons Core Land Consulting ESKO Roofing

ITEM C1 TS-1 SITE TOPOGRAPHIC SURVEY

A. Added Sheet WM-4 O.C.W.R.C. Standard Water Main Details to sheet index.

ITEM C2 SP-1 SITE LAYOUT PLAN

- A. Added Sheet WM-4 O.C.W.R.C. Standard Water Main Details to sheet index.
- B. Added 2' deep sediment sump in Stormwater Detention Basin.
- C. Replaced single center downspout pipe on building west end with ones at northwest & southwest building corners.
- D. Shifted fire line & water service valve locations as necessary to separate these lines just south of the hydrant lead tee.

### ITEM C3 SE-1 SITE SOIL EROSION & SEDIMENTATION CONTROL PLAN

- A. Added 2' deep sediment sump in Stormwater Detention Basin.
- B. Replaced single center downspout pipe on building west end with ones at northwest & southwest building corners.

C. Replaced single 8" water lead south of hydrant lead tee with separate 2" water service and 6" fire line.

# ITEM C4 C-1 SITE PAVING & GRADING PLAN

- A. Added 2' deep sediment sump in Stormwater Detention Basin.
- B. Replaced single center downspout pipe on building west end with ones at northwest & southwest building corners.
- C. Replaced single 8" water lead south of hydrant lead tee with separate 2" water service and 6" fire line.

### ITEM C5 C-2 SITE STORMWATER MANAGEMENT PLAN & DETAILS

- A. Added 2' deep sediment sump in Stormwater Detention Basin.
- B. Replaced single center downspout pipe on building west end with ones at northwest & southwest building corners.
- C. Replaced single 8" water lead south of hydrant lead tee with separate 2" water service and 6" fire line.
- D. Added storm sewer calculations for roof drainage piping.
- E. Revised Detention Basin outlet structure orifice calculations and detail.

# ITEM C6 C-3 SITE UTILITIES PLAN

- A. Added 2' deep sediment sump in Stormwater Detention Basin.
- B. Replaced single center downspout pipe on building west end with ones at northwest & southwest building corners.
- C. Replaced single 8" water lead south of hydrant lead tee with separate 2" water service and 6" fire line.

# ITEM C7 C-4 SITE STORM SEWER PROFILES

A. Added 2' deep sediment sump in Stormwater Detention Basin.

# ITEM C8 C-5 SITE WATER MAIN PROFILES

A. Replaced single 8" water lead south of hydrant lead tee with separate 2" water service and 6" fire line.

### ITEM C9 C-6 SITE SEPTIC SYSTEM DETAILS

- A. Replaced single center downspout pipe on building west end with ones at northwest & southwest building corners.
- B. Replaced single 8" water lead south of hydrant lead tee with separate 2" water service and 6" fire line

# **ARCHITECTURAL**

# Castle Carpentry, Steel Equipment, Mastercraft Plumbing, Smart Lighting

# ITEM A1 A3-03 DIMENSION PLAN

- A. Add (10) ten corner guards.
- B. Add steel column D5 and increase width of partition to 7 1/4" as noted on plan.
- C. Revise dimensions in Passage 113.

### ITEM A2 A3-10 ENLARGED FLOOR PLANS

A. Add mirror size (24" x 36") to Item TA-4 in the Toilet Accessories Legend.

### ITEM A3 A3-21 PLAN DETAILS

- A. Add column D5 to Plan Detail 8/A3-01.
- B. Revise dimensions of partition at new column location and change metal stud size from 3 5/8" to 6".

### ITEM A4 A4-01 REFLECTED CEILING PLANS & DETAILS

- A. Add (4) four air reel and power chord drops to the ceiling of Apparatus Bay 121.
- B. Added a symbol for the reels on the Ceiling Symbol Legend.

Highland Township CCD No. 1 July 13, 2021 Page 3

Mohawk Fire Protection, Anton's Painting, Kapala Heating & Air, Mastercraft Plumbing

**MECHANICAL** 

ITEM M1

FP0-01 FLOOR PLANS - FIRE PROTECTION

A. Add Key Note #2

B. Delete one feed water stub and provide two feed water stubs. One for fire protection and one for domestic water.

ITEM M2 M1-01 FLOOR PLANS – SANITARY & VENT

A. Add condensate lines to heat pump units as indicated.

B. Replace floor drain to floor sink in Mechanical room as indicated.

ITEM M3 M1-02 FLOOR PLANS – DOMESTIC WATER

A. Delete one feed water stub and provide two feed water stubs. One for fire protection and one for domestic water.

ITEM M3 M3-01 FLOOR PLANS - PIPING

A. Add compressed air piping with hose reels as indicated.

ITEM M3 M5-01 MECHANICAL DETAILS

A. Revise sprinkler riser and water meter diagram.

B. Revise Heap pump flor diagram.

**ELECTRICAL** 

Smart Lighting

ITEM E1

E3-00 FLOOR PLANS - POWER

A. Added Key Note 18 as indicated.

\*\*END OF CCD-1\*\*

PARTNERS 18-122B TOILET AND BATH ACCESSORIES 102800 - 1

### **SECTION 102800 - TOILET AND BATH ACCESSORIES**

# PART 1 - GENERAL

# 1.1 SUMMARY

- A. This Section includes the following:
  - 1. Washroom accessories.
  - 2. Under lavatory guards.

# 1.2 SUBMITTALS

- A. Product Data: For each type of product indicated.
- B. Product Schedule:
  - 1. Identify locations using room designations indicated on Drawings.
  - 2. Identify products using designations indicated on Drawings.

# PART 2 - PRODUCTS

# 2.1 WASHROOM ACCESSORIES

- A. Basis-of-Design Product: The design for accessories is based on products indicated. Subject to compliance with requirements, provide the named product or a comparable product by one of the following:
  - 1. A & J Washroom Accessories, Inc.
  - 2. American Specialties, Inc.
  - 3. Bobrick Washroom Equipment, Inc.
  - 4. Bradley Corporation.
  - 5. General Accessory Manufacturing Co. (GAMCO).
- B. Grab Bar: TA-1, TA-2, TA-3.
  - 1. Basis-of-Design Product: Bobrick B-5806.
  - 2. Mounting: Flanges with concealed fasteners.
  - 3. Material: Stainless steel, 0.05 inch thick.
    - a. Finish: Smooth, No. 4, satin finish.
  - 4. Outside Diameter: 1-1/4 inches.
  - Configuration and Length: As indicated on Drawings.

# PARTNERS 18-122B TOILET AND BATH ACCESSORIES 102800 - 2

- C. Mirror Unit: TA-4
  - 1. Basis-of-Design Product: Bradley 781.
  - 2. Frame: Stainless-steel angle.
    - a. Corners: Mitered and mechanically interlocked.
  - 3. Hangers: Produce rigid, tamper- and theft-resistant installation, using method indicated below.

Wall bracket of galvanized steel, equipped with concealed locking devices requiring a special tool to remove.

- 4. Size: As indicated on drawings. If not indicated, provide 24"W x 36"H
- D. Toilet Tissue Dispenser: TA-5
  - 1. By Owner
- E. Soap Dispenser: TA-6
  - 1. By Owner
- F. Shower Curtain, Rod, & Hooks: TA-7
  - 1. Basis-of-Design product(s): Bobrick B-204-1, B-204-2, B-207x36
  - 2. Mounting: Concealed
  - 3. Material: Stainless steel.
  - 4. Length: 36 inches
  - 5. Location: 1 per shower
- G. Paper Towel Dispenser: TA-8
  - By Owner
- H. NOT USED: (TA-9)
- I. Towel Hook: (TA-10)
  - 1. Basis-of-Design product: Bobrick B-2116
  - 2. Mounting: Wall.
  - 3. Material: Stainless steel.
- J. Waste Receptacle: (TA-12)
  - 1. Basis-of-Design product: Bobrick B-2300
  - 2. Mounting: Floor-Standing
  - 3. Material: Stainless steel.
- 2.2 UNDERLAVATORY GUARDS: TA-11
  - A. Manufacturers: Subject to compliance with requirements, provide products by one of the following:
    - 1. Plumberex Specialty Products, Inc.

- 2. TCI Products.
- 3. Truebro, Inc.

# B. Under lavatory Guard:

- 1. Description: Provide insulating pipe covering for supply and drain piping assemblies. The install lavatory protective enclosure that prevent direct contact with and burns from piping. Provide 'Lav Shield' as provided by Truebro (IPS Corporation) model #2018 or approved equal with tamper resistant screws. Provide factory cut models where available (coordinate with mechanical).
- 2. Material and Finish: Impact-resistant, stain-resistant and chemical resistant rigid vinyl with China white finish.
- C. Provide at all wall mounted lavatories and as noted on drawings.

### 2.3 FABRICATION


A. Keys: Provide universal keys for internal access to accessories for servicing and resupplying. Provide minimum of six keys to Owner's representative.

# PART 3 - EXECUTION


### 3.1 INSTALLATION

A. Install accessories according to manufacturers' written instructions, using fasteners appropriate to substrate indicated and recommended by unit manufacturer. Install units level, plumb, and firmly anchored in locations and at heights indicated.

# **END OF SECTION 102800**

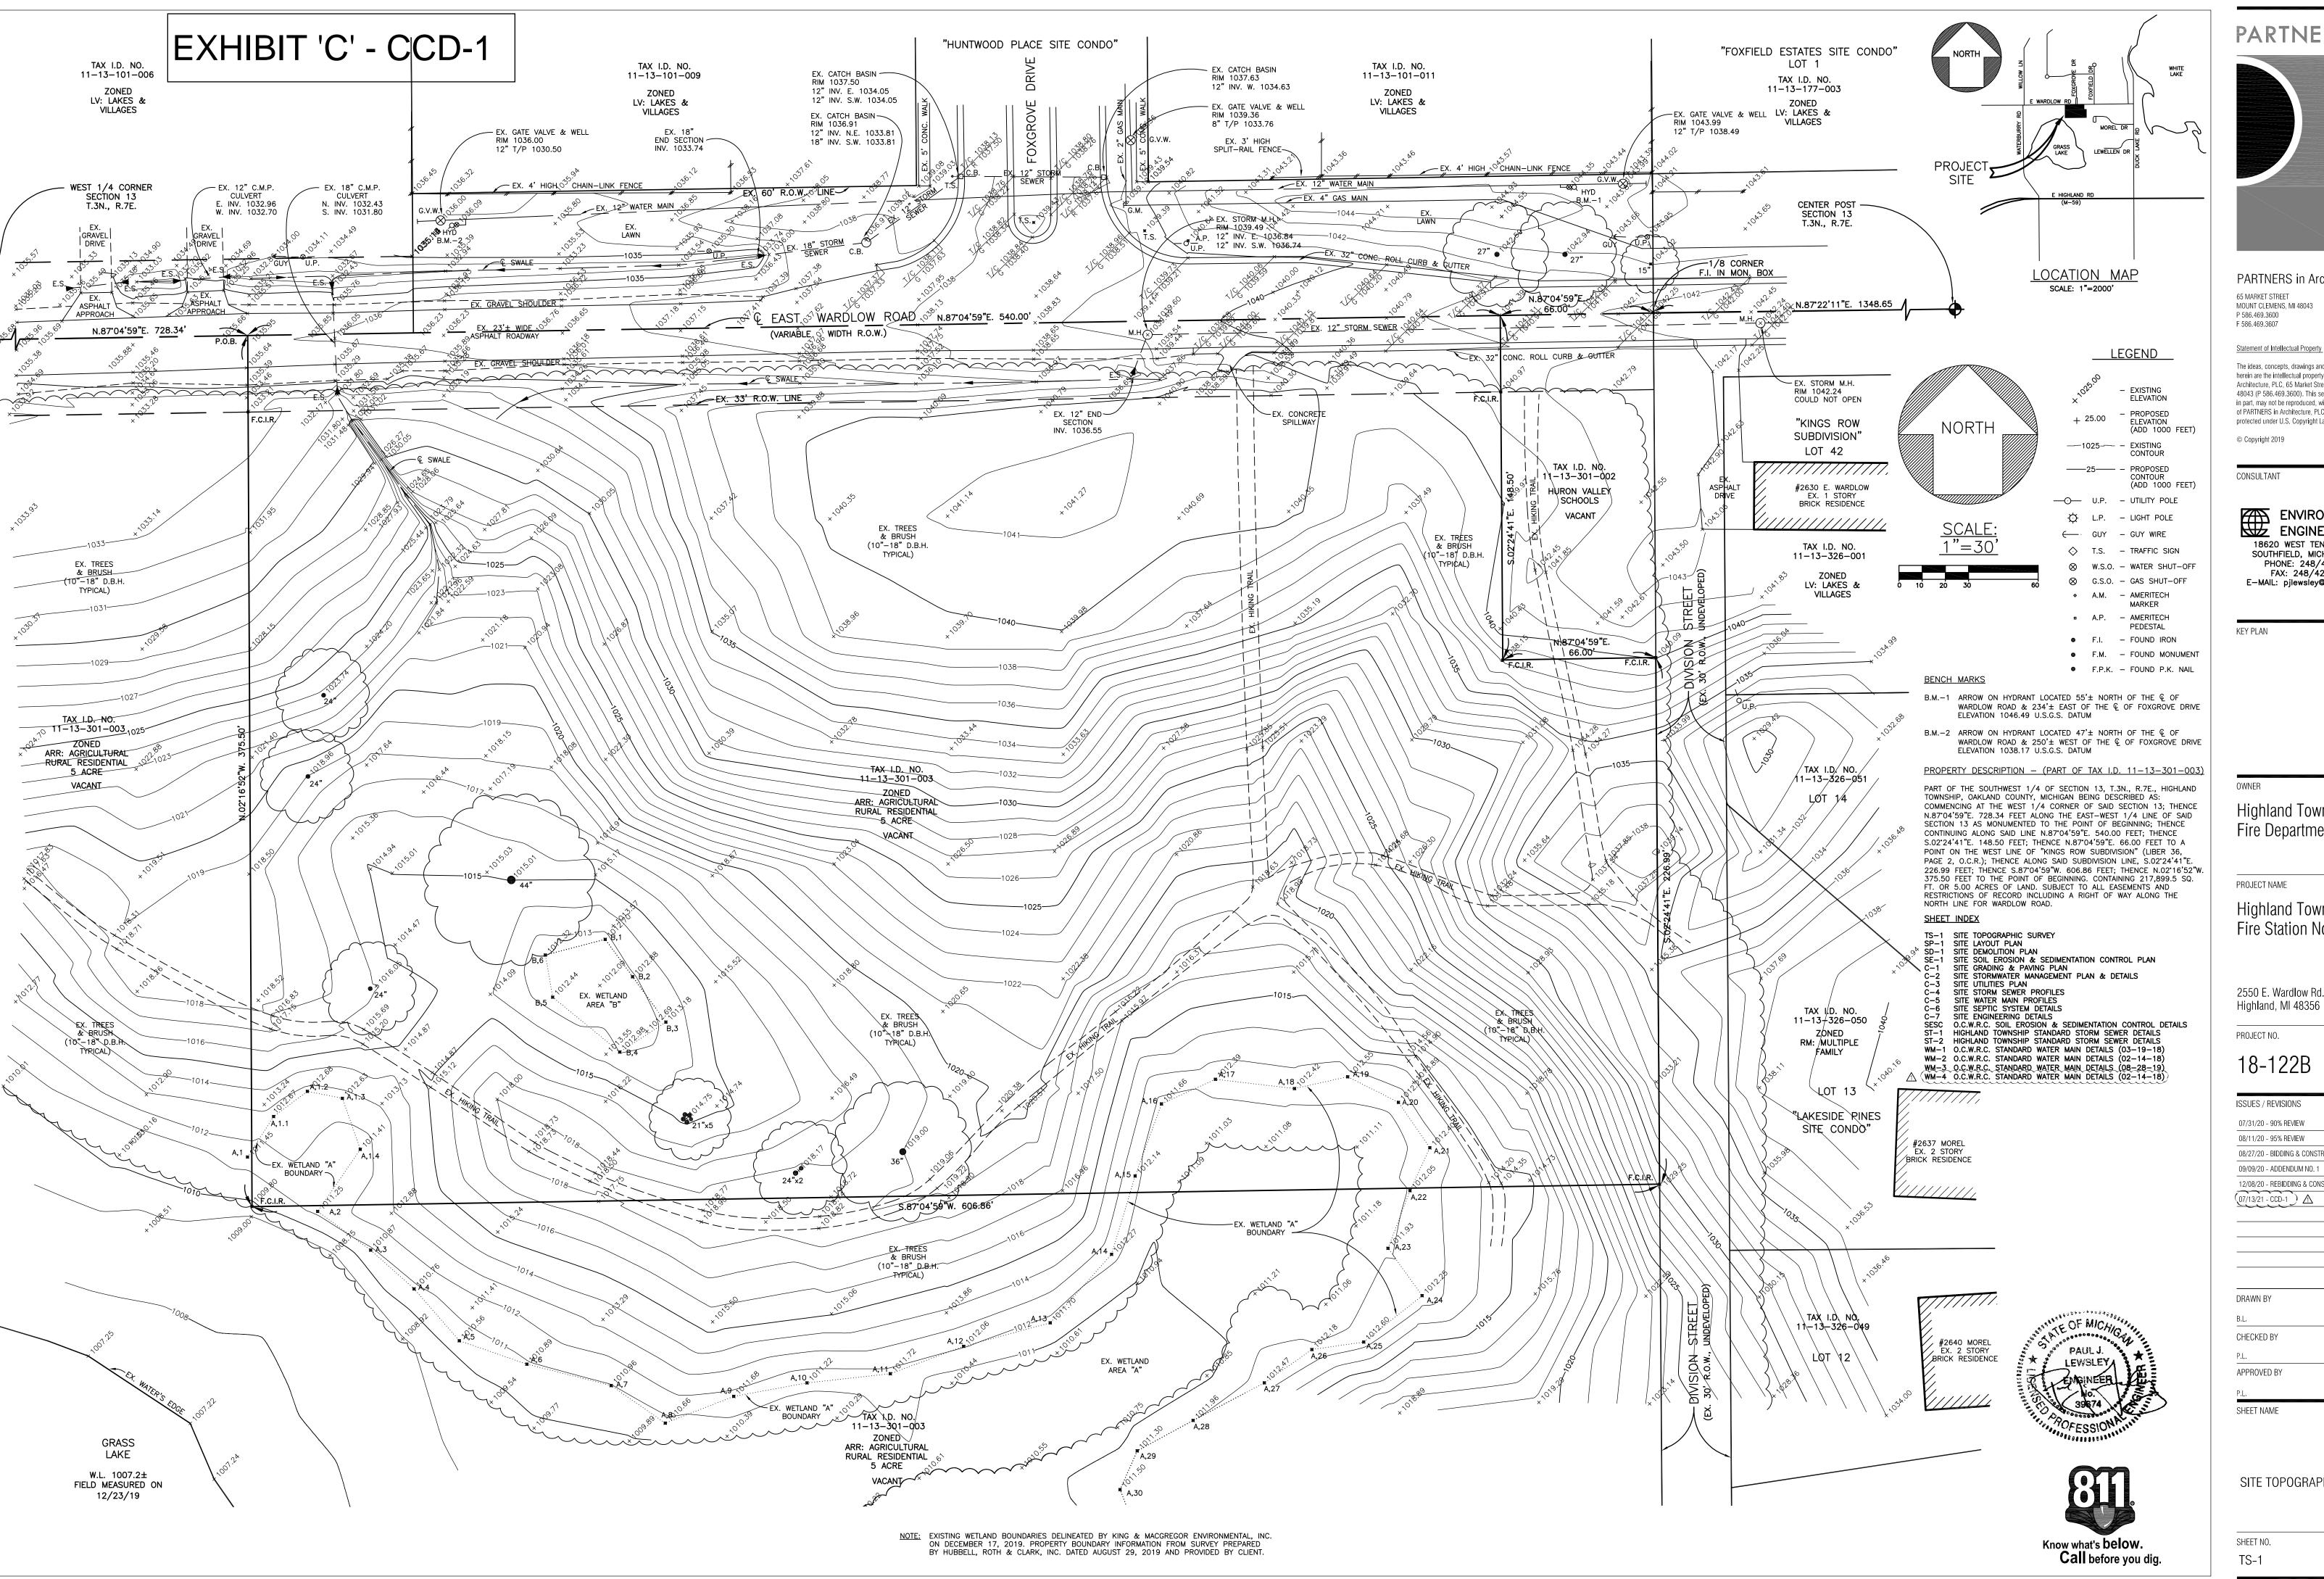



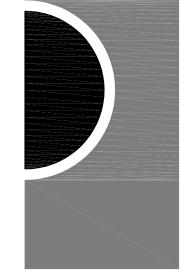

PARTNERS in Architecture, PLC 65 MARKET STREET MOUNT CLEMENS, MI 48043

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CONSULTANT

**ENVIRONMENTAL** ENGINEERS, INC. 18620 WEST TEN MILE ROAD SOUTHFIELD, MICHIGAN 48075 PHONE: 248/424-9510 FAX: 248/424-2954 E-MAIL: pjlewsley@envengrs.com

Highland Township

Highland Township Fire Station No. 2

2550 E. Wardlow Rd.

18-122B


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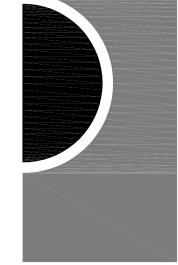
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SHEET NAME

SITE TOPOGRAPHIC SURVEY

SHEET NO.



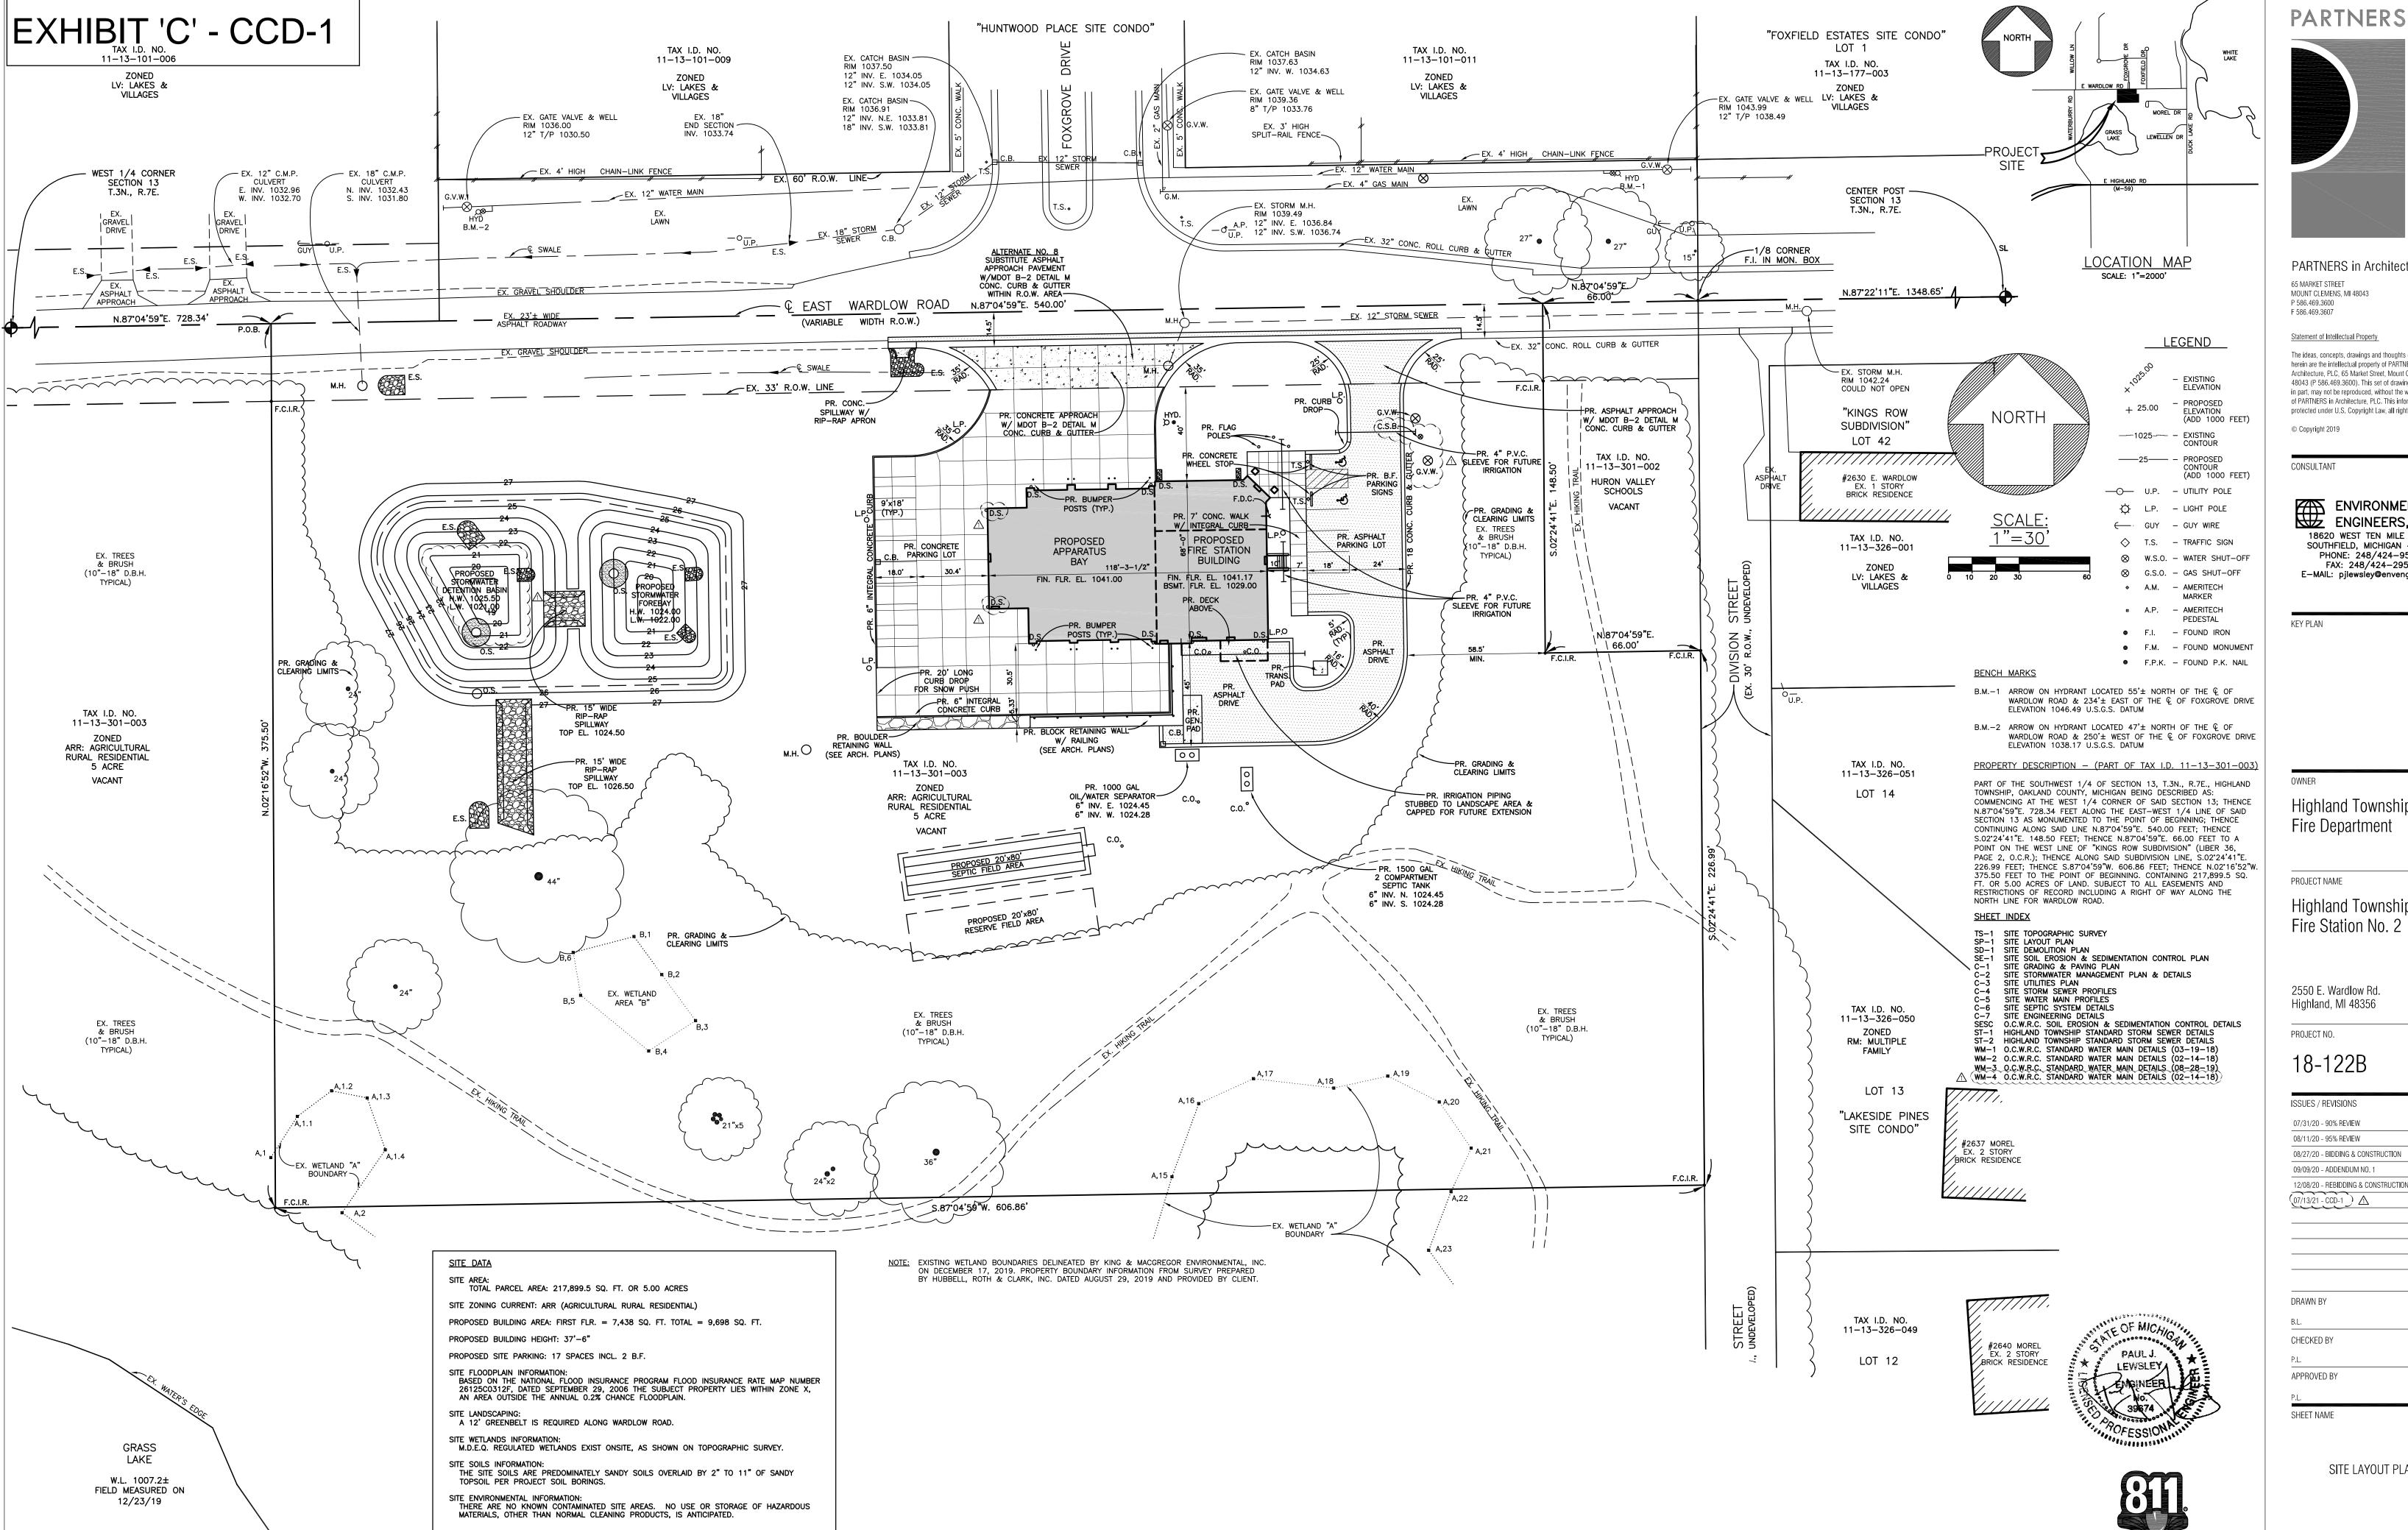

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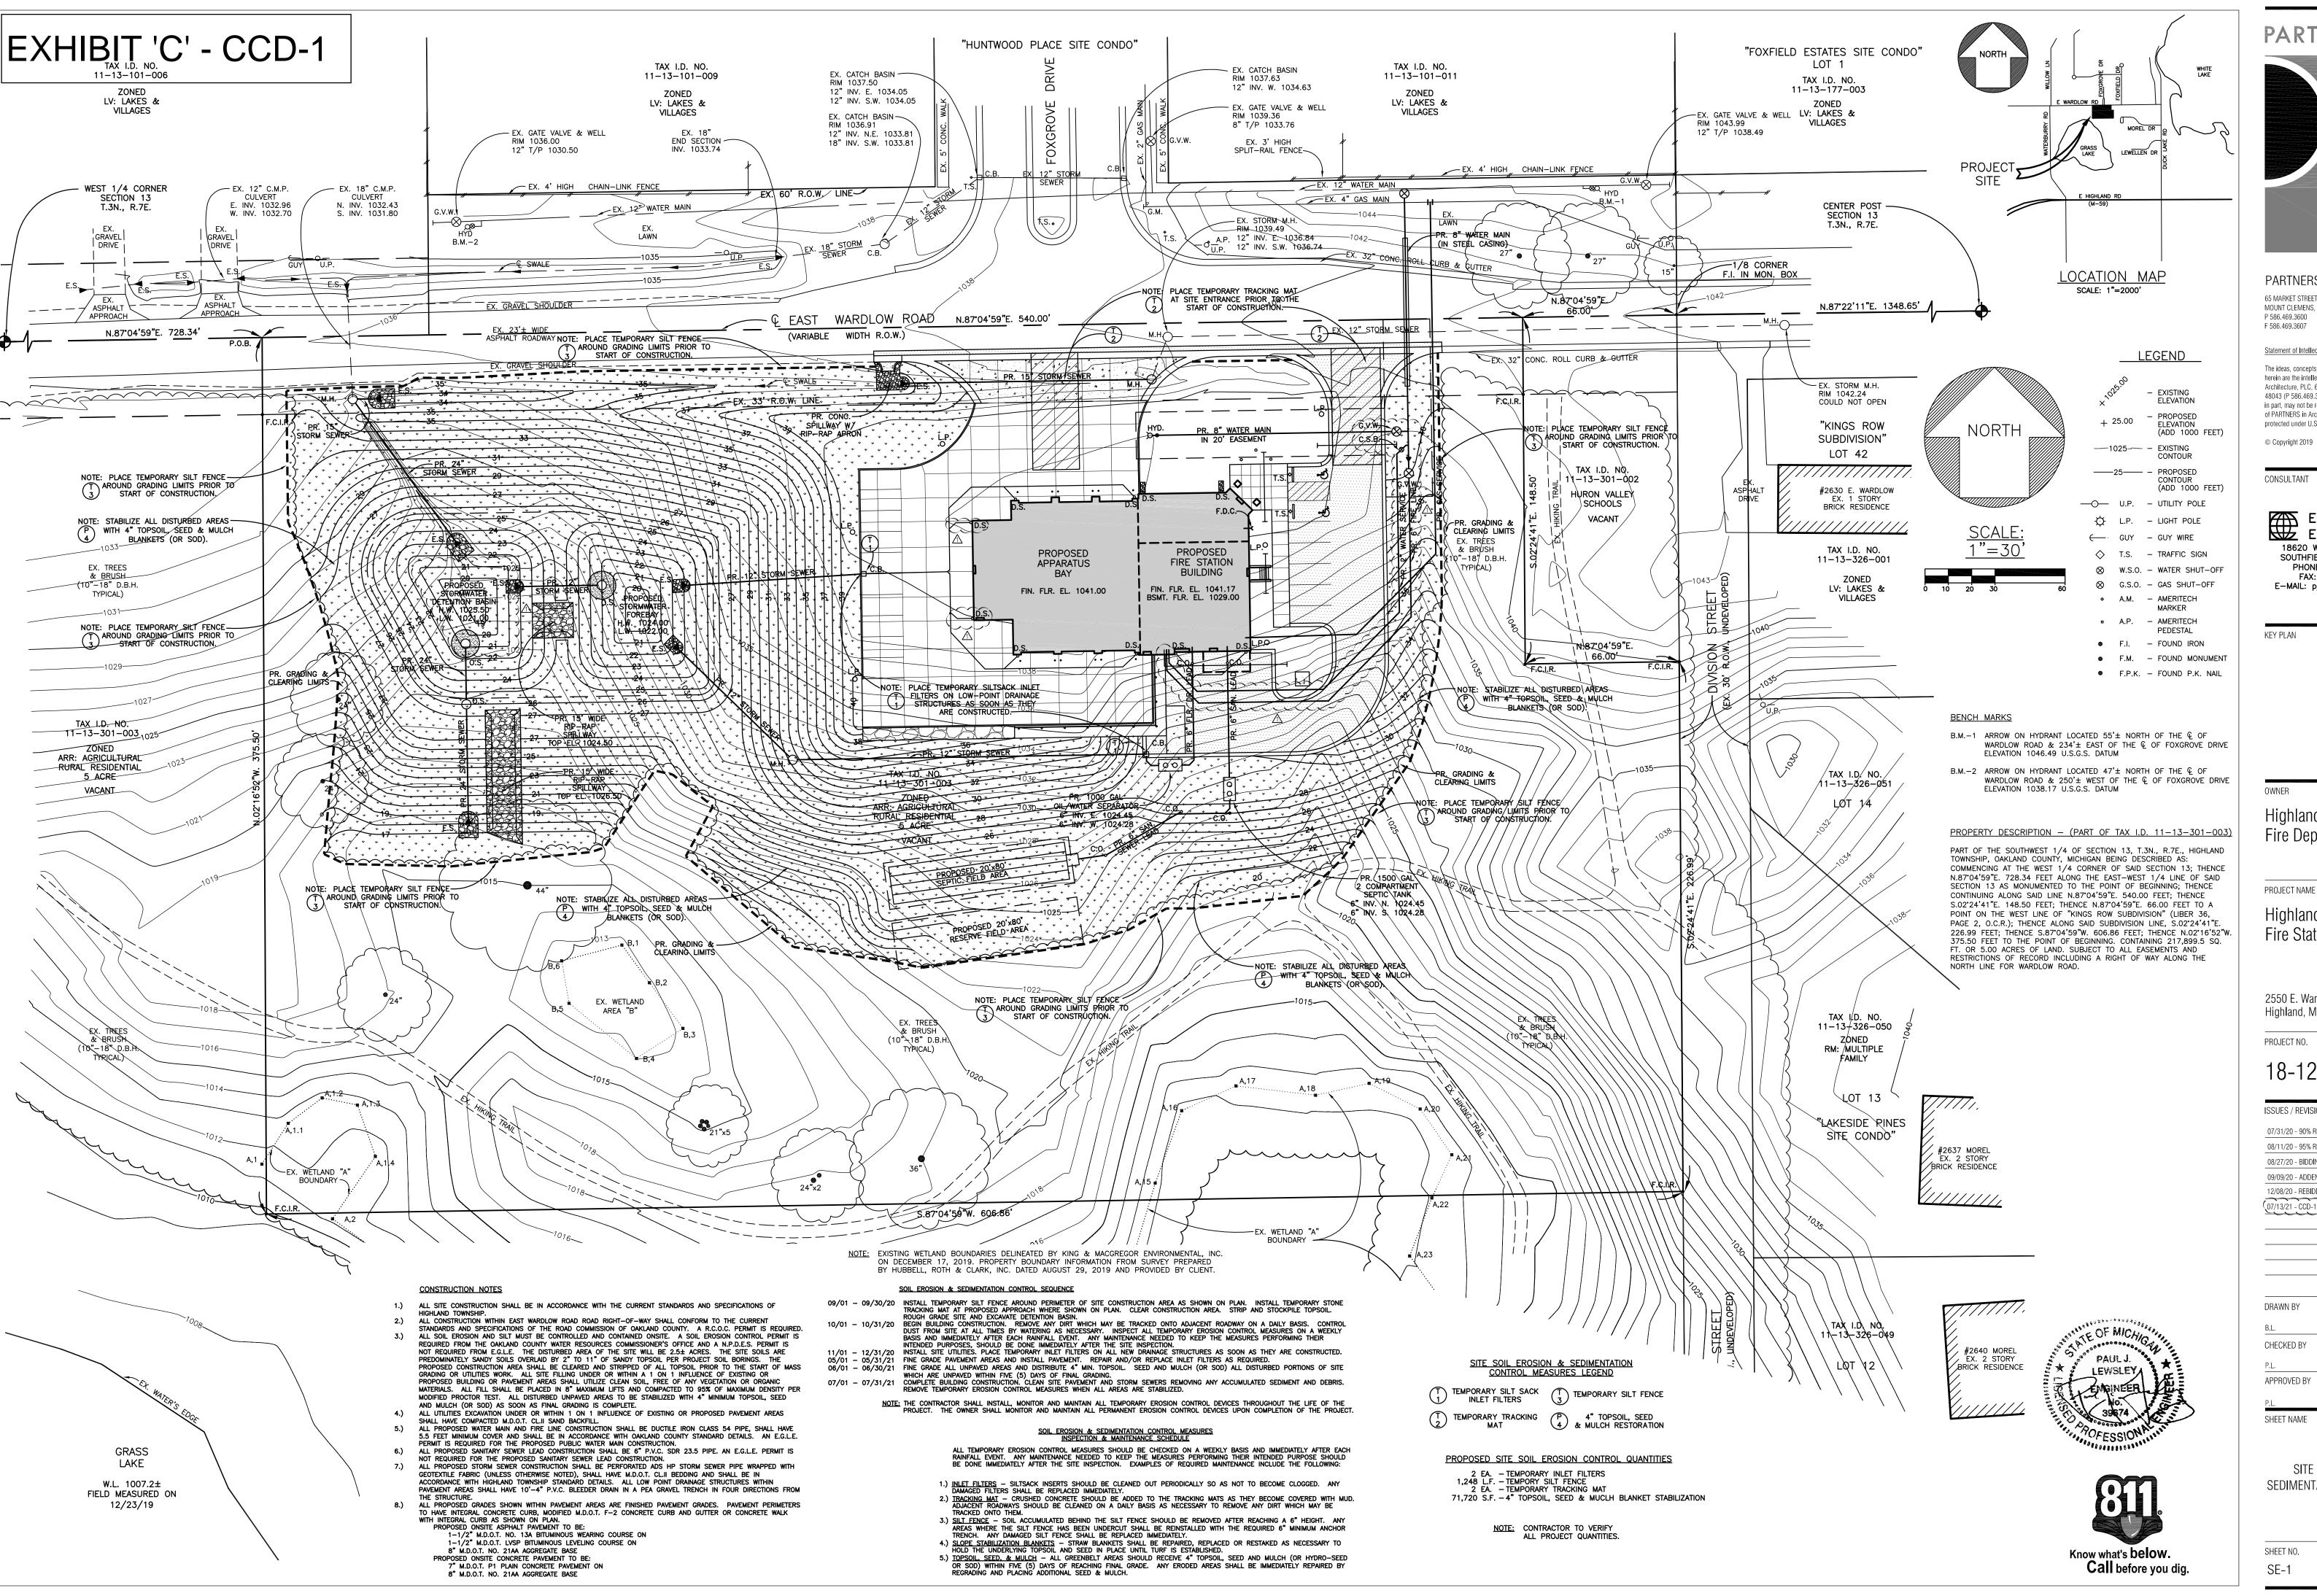
08/27/20 - BIDDING & CONSTRUCTION 12/08/20 - REBIDDING & CONSTRUCTION

SITE LAYOUT PLAN


SHEET NO. SP-1

Know what's below.

Call before you dig.





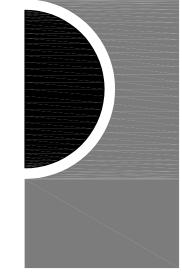

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Highland Township Fire Department

PROJECT NAME

Highland Township Fire Station No. 2

2550 E. Wardlow Rd. Highland, MI 48356

PROJECT NO.

18-122B

ISSUES / REVISIONS 07/31/20 - 90% REVIEW 08/11/20 - 95% REVIEW 08/27/20 - BIDDING & CONSTRUCTION 09/09/20 - ADDENDUM NO. 1 12/08/20 - REBIDDING & CONSTRUCTION ~~~

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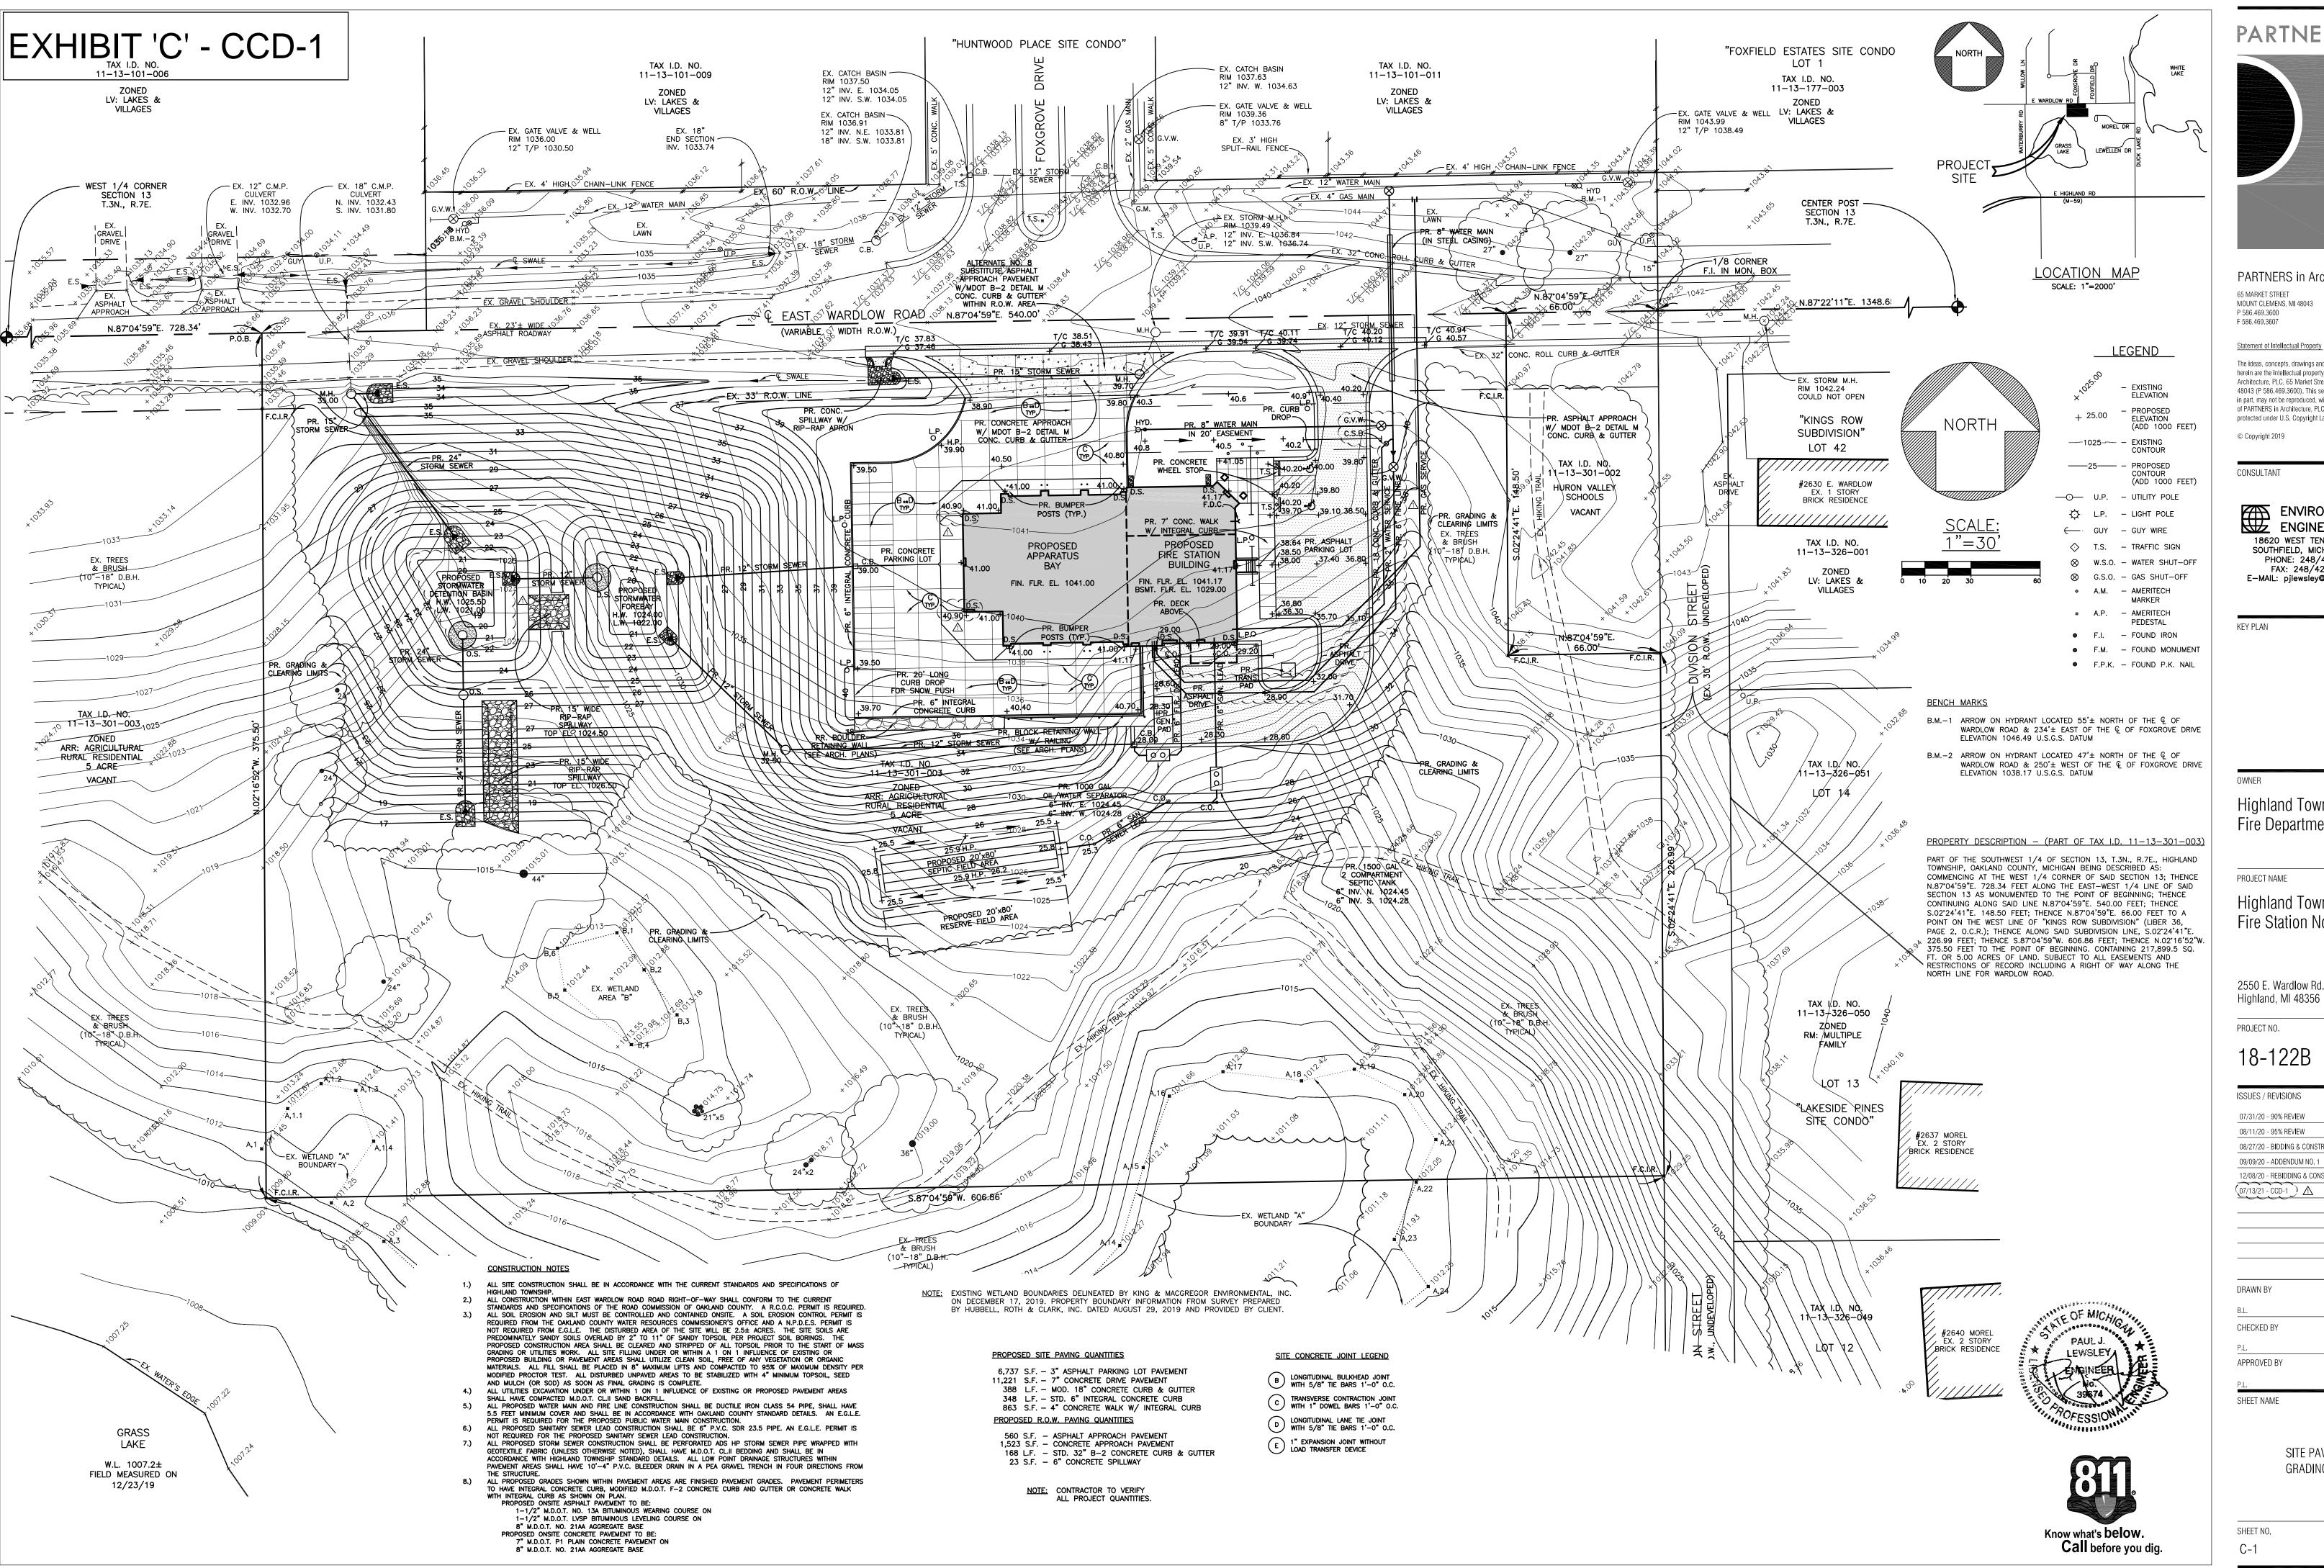
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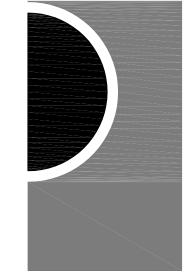
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SITE SOIL EROSION & SEDIMENTATION CONTROL PLAN

SHEET NO. SE-1







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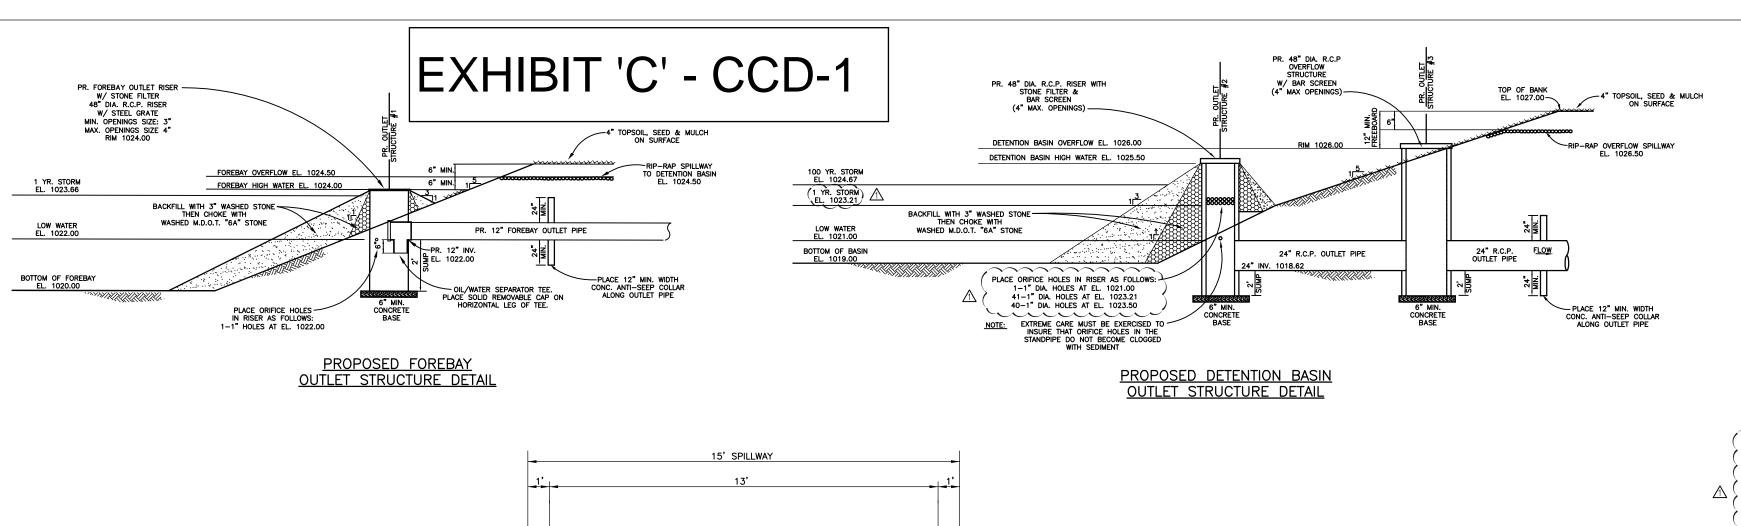
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SHEET NAME

SITE PAVING & GRADING PLAN



RIP-RAP OVERFLOW SPILLWAY

**SECTION** 

RIP-RAP (8" TO 15" TYP.)

I -		IGHLAND ] o. <u>1947</u>	OWNS	HIP FIRE	STATION_	NO.2	En	viror			enç rm Sewer Sy	ginee <sub>ystems</sub>	rs,	ln		Q = CIA		SH = 0.013	HEET <u>1</u> OF	F_
Rev.	04/2 07/1 03/0	6/20	By <u>PAL</u>	JL LEWSLE	<u> </u>									;	*  = $\frac{175}{1 + 25}$ T initial = 15 Minutes Maximum *Show formula					
From M.H. or D.P.#	To M.H. OR D.P.#	Increment Acres "A"	"c"	Equivalent Area 100% Acres CA	Total Area 100% Acres CA	T Time Min.	l inches per hour	Q c.f.s.	Diameter of pipe in.	Slope pipe ft./ft.	Slope H.G.	Length of line ft.	Velocity flow full ft./ sec.	Time of flow min.	Capacity of sewer c.f.s.	H.G. elevation upper end	Upper end	Elevation Lower end	Upper end	
S.E. BLDG.	C.B. #1	0.04	0.90	0.04	0.04	15.00	4.38	0.18	6"	0.0100	0.0010	65	2.86	0.26	0.56	1026.00		1028.00		Ť
S.W. BLDG.	PIPE JUN.	0.04	0.90	0.04	0.04	15.00	4.38	0.18	6"	0.0100	0.0010	115	2.86	0.67	0.56	1037.00	1041.00	1040.60	1037.00	T
N.W. BLDG.	PIPE JUN.	0.04	0.90	0.04	0.04	15.00	4.38	0.18	6"	0.0100	0.0010	115	2.86	0.67	0.56	1037.00	1041.00	1040.60	1037.00	T
WEST BLDG.	PIPE JUN.	0.01 0.01	0.90 0.90	0.01 0.01	0.01 0.01	15.00 15.00	4.38 4.38	0.05 0.05	6" 6"	0.0100 0.0100	0.0002 0.0002	10 10	2.86 2.86	0.07 0.07	0.56 0.56	1036.55 1036.55	1040.90 1040.90	1040.55 1040.55	1036.15 1036.15	
PIPE JUN.	C.B. #3	-	•	-	0.14	15.67	4.30	0.60	6"	0.0400	0.0114	37	5.72	0.11	1.12	1035.85	1040.60	1039.00	1035.85	
C.B. #1	₩.₩. #2	O.37 INCL. BLDG.	0.73	0.27	0.27	15.00	4.38	1.18	12"	0.0060	0.0011	152	3.5	0.72	2.76	1024.06	1028.00	1032.50	1024.00	7
M.H. #2	E.S. #1	-	-	-	0.27	15.72	4.30	1.16	12"	0.0120	0.0011	70	5.0	0.23	3.90	1022.88	1032.50	_	1022.84	
С.В. #3	Ē.S. #2	0.39 INCL. BLDG.	0.86	0.34	0.34	15.00	4.38	1.49	12"	0.0120	0.0017	78	5.0	0.25	3.90	1023.92	1039.00	_	1023.94	
0.S. #1	E.S. #3	0.39	0.33	0.13	0.74	15.95	4.27	3.16	12"	0.0120	0.0079	37	5.0	0.12	3.90	1022.87	1024.00	_	1022.00	
EX. M.H.	M.H. #4 E.S.	2.24	0.50	1.12	1.12	20.00	3.89	4.35	EX. 12"	0.0100	0.0149	19	4.5	0.07	3.56	1037.56	1039.49	1039.70	1036.74	
M.H. #4 E.S.	#4	-	-	_	1.12	20.07	3.88	4.35	15"	0.0050	0.0045	107	3.7	0.48	4.57	1037.28	1039.70	_	1036.34	1
#5	M.H. #5 E.S.	0.63	0.50	0.32	1.44	21.50	3.76	5.42	15"	0.0300	0.0070	12	9.1	0.02	11.19	1034.00	_	1035.00	1033.00	1
M.H. #5 Ö.S.	E.S. #6 0.S	9.13	0.50	4.57	6.01	30.00	3.18	19.11	24"	0.0080	0.0071	77	6.4	0.20	20.23	1025.10	1035.00		1023.62	1
0.S. #2 0.S.	#3	0.40	0.73	0.29	7.04	35.00	2.92	20.53	24"	0.0080	0.0082	26	6.4	0.07	20.23	1020.23	1025.50	1026.00	1018.62	1
0.S. #3	E.S. #7	_	-	_	7.04	35.07	2.91	20.49	24"	0.0080	0.0082	51	6.4	0.13	20.23	1020.02	1026.00		1018.41	$\downarrow$

USE O.C.W.R.C. METHOD TO DETERMINE REQUIRED SITE DETENTION VOLUME BASED ON 100 YEAR FREQUENCY STORM. THE TRIBUTARY AREA FOR THE PROPOSED DETENTION BASIN IS 1.55

ACRES. THE AVERAGE SITE RUNOFF COEFFICIENT "C" IS 0.63 AS CALCULATED ABOVE AND THE

ALLOWABLE DISCHARGE RATE IS 0.20 CFS/ACRE PER O.C.W.R.C. REQUIREMENTS.

VT100 = (12,243)(1.55)(0.63) = 11,955 CU. FT. REQUIRED FOR 100 YR. STORM

USE O.C.W.R.C. METHOD TO DETERMINE REQUIRED SITE FOREBAY VOLUME BASED ON 1 YEAR FREQUENCY STORM. THE TRIBUTARY AREA FOR THE PROPOSED FOREBAY IS 1.15 ACRES.

THE AVERAGE SITE RUNOFF COEFFICIENT "C" IS 0.63 AS CALCULATED ABOVE. THE REQUIRED FOREBAY VOLUME IS TO BE DISCHARGED OVER A 48 HOUR PERIOD. USE OCWRC METHOD TO ALSO CALCULATE REQUIRED 1 YEAR FREQUENCY STORM STORAGE VOLUME FOR DETENTION

PROPOSED FOREBAY VOLUME PROVIDED = 3,943 CU. FT.

PROPOSED DETENTION BASIN VOLUME PROVIDED = 19,371 CU. FT

COMBINED PROPOSED FOREBAY & DETENTION BASIN VOLUME PROVIDED = 3,943 CU. FT. + 19,371 CU. FT. = <u>23,314 CU. FT.</u>

Average depth volume between  $\underline{AREA} \times \underline{INTERVAL} = \underline{CONTOURS}$ 

VOLUME BETWEEN

1,377 S.F. x 1.00 FT. = 1,377 CU. FT. 1,377 CU. FT.

1,149 S.F. > 1,539 S.F. × 1.00 FT. = 1,539 CU. FT. 1,539 CU. FT. 1,539 CU. FT. 1,539 CU. FT. 2,404 CU. FT. 3,943 CU. FT. 3,130 C.F. AT EL. 1023.66

CUMULATIVE VOLUME

2,192 S.F. x 1.00 FT. = 2,192 CU. FT. 3,569 CU. FT. 1,577 CO. FT. 2,192 S.F. x 1.00 FT. = 3,159 CU. FT. 6,728 CU. FT. 4,218 C.F. AT EL. 1023.21

7,762 S.F. x 1.00 FT. = 7,762 CU. FT. 14,490 CU. FT. 11,955 C.F. AT EL. 1024.67

PROPOSED STORMWATER DETENTION BASIN DESIGN CALCULATIONS

100 YR. FREQUENCY STORM DETENTION VOLUME REQUIRED

 $V_{S100} = \frac{16.500(155.37)}{155.37 + 25} - 40(0.317)(155.37) = 12,243 \text{ C.F.}$ 

1 YR. FREQUENCY STORM FOREBAY VOLUME REQUIRED

PROPOSED FOREBAY VOLUME PROVIDED

PROPOSED DETENTION BASIN VOLUME PROVIDED

CONTOUR

1024 (H.W.)

4320(1.15)(0.63) = 3.130 CU. FT. REQUIRED FOR 1 YR. STORM

4320(1.55)(0.63) = 4.218 CU. FT. REQUIRED FOR 1 YR. STORM

1 YR. FREQUENCY STORM DETENTION BASIN VOLUME REQUIRED

AREA BELOW CONTOUR

 $Q_0 = \frac{(1.55 \text{ AC.})(0.20 \text{ CFS/AC.})}{(1.55 \text{ AC.})(0.63)} = 0.317$ 

 $T_{100} = -25 + \sqrt{\frac{10.312.5}{0.317}} = 155.37 \text{ MIN.}$ 

 $V_{S100} = \frac{16.500(T)}{T + 25} - 40(Q_0)(T)$ 

 $Q_{O} = \frac{QA}{(A)(C)}$ 

 $T_{100} = -25 + \sqrt{\frac{10.312.5}{Q_0}}$ 

 $V_{T100} = V_{S100}(A)(C)$ 


(C=0.90)

DRAINAGE **STRUCTURE** 


C.B.#2

IMP. AREA PER. AREA WATER AREA WEIGHTED AVG.

0.20

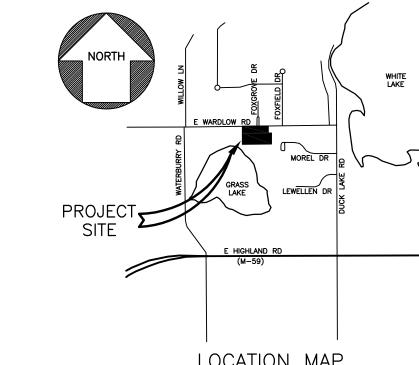

LOCATION MAP SCALE: 1"=2000'

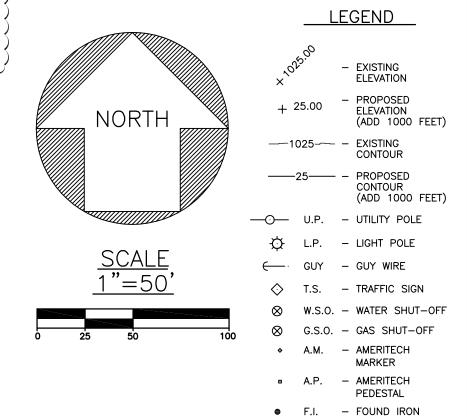

BENCH MARKS

B.M.-1 ARROW ON HYDRANT LOCATED 55'± NORTH OF THE € OF WARDLOW ROAD & 234'± EAST OF THE & OF FOXGROVE DRIVE


● F.M. – FOUND MONUMENT

● F.P.K. — FOUND P.K. NAIL

B.M.-2 ARROW ON HYDRANT LOCATED 47'± NORTH OF THE € OF WARDLOW ROAD & 250'± WEST OF THE & OF FOXGROVE DRIVE

PROPERTY DESCRIPTION - (PART OF TAX I.D. 11-13-301-003) PART OF THE SOUTHWEST 1/4 OF SECTION 13, T.3N., R.7E., HIGHLAND TOWNSHIP, OAKLAND COUNTY, MICHIGAN BEING DESCRIBED AS: COMMENCING AT THE WEST 1/4 CORNER OF SAID SECTION 13; THENCE N.87°04'59"E. 728.34 FEET ALONG THE EAST-WEST 1/4 LINE OF SAID SECTION 13 AS MONUMENTED TO THE POINT OF BEGINNING; THENCE CONTINUING ALONG SAID LINE N.87°04'59"E. 540.00 FEET; THENCE S.02°24'41"E. 148.50 FEET; THENCE N.87°04'59"E. 66.00 FEET TO A POINT ON THE WEST LINE OF "KINGS ROW SUBDIVISION" (LIBER 36, PAGE 2, O.C.R.); THENCE ALONG SAID SUBDIVISION LINE, S.02'24'41"E. 226.99 FEET; THENCE S.87\*04'59"W. 606.86 FEET; THENCE N.02\*16'52"W. 375.50 FEET TO THE POINT OF BEGINNING. CONTAINING 217,899.5 SQ. FT. OR 5.00 ACRES OF LAND. SUBJECT TO ALL EASEMENTS AND RESTRICTIONS OF RECORD INCLUDING A RIGHT OF WAY ALONG THE NORTH LINE FOR WARDLOW ROAD.

ELEVATION 1046.49 U.S.G.S. DATUM

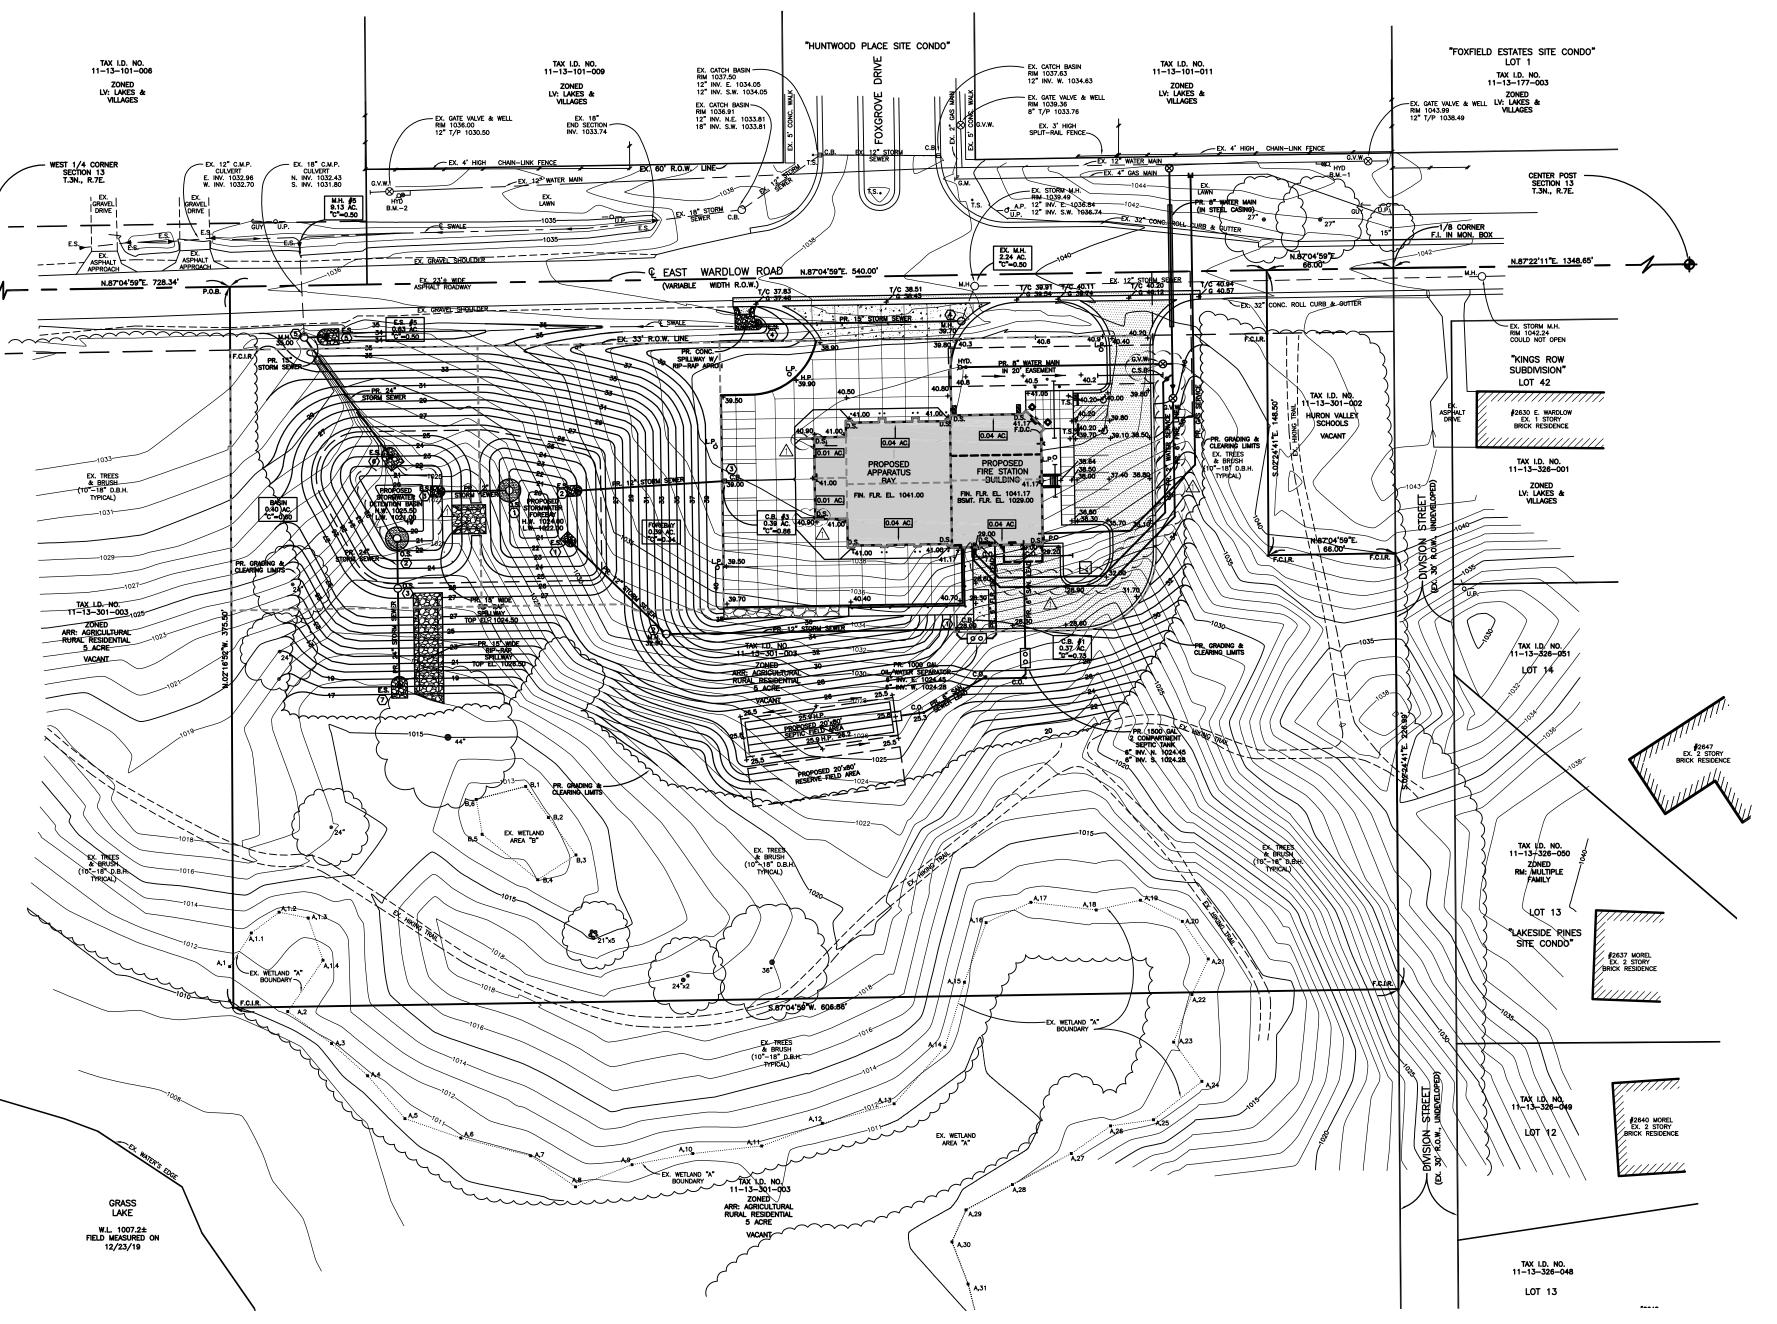

# FOREBAY OUTLET RESTRICTOR SIZING CALCULATIONS

10,558 S.F. >

 $QAVG = V_{T FF} / ((48)(60)(60)SEC.)$  $Q_{AVG} = 3,130/172,800 = 0.018 \text{ CFS}$ 

 $h_{OUT} = 0.667(Z_{FF} - Z_{OUT})$  $h_{OUT} = 0.667(1024.00 - 1022.00)$ 

NOTE: EXISTING WETLAND BOUNDARIES DELINEATED BY KING & MACGREGOR ENVIRONMENTAL, INC.

ON DECEMBER 17, 2019. PROPERTY BOUNDARY INFORMATION FROM SURVEY PREPARED BY HUBBELL, ROTH & CLARK, INC. DATED AUGUST 29, 2019 AND PROVIDED BY CLIENT.

hout = 1.33 FT. A0 =  $Q_{AVG FF}/(0.62 \times \sqrt{2xgxh_{AVG}})$ A = 0.018/(0.62 x  $\sqrt{2x(32.2)x(1.33)}$ )  $A = 0.00314 \text{ FT}^2$ 

0.00545 FT<sup>2</sup> = AREA OF A 1" DIA. HOLE REQUIRED NUMBER OF 1" DIA. HOLES = 0.00314/0.00545 = 0.58 HOLES USE 1-1" HOLES AT EL. 1022.00

DETENTION BASIN RESTRICTOR SIZING CALCULATIONS 1 YR STORM RESTRICTOR DESIGN  $^{\circ}$  QAVG =  $V_{T FF} / ((48)(60)(60)SEC.)$  $Q_{AVG} = 4,218/172,800 = 0.024 \text{ CFS}$  $h_{OUT} = 0.667(Z_{FF} - Z_{OUT})$ h<sub>OUT</sub> = 0.667(1023.21-1021.00) hout = 1.47 FT. Ao =  $Q_{AVG FF}/(0.62 \times \sqrt{2xgxh_{AVG}})$ A = 0.024/(0.62 x  $\sqrt{2x(32.2)x(1.47)}$ )  $A = 0.00398 \text{ FT}^2$  $\bigcirc$  0.00545 FT<sup>2</sup> = AREA OF A 1" DIA. HOLE REQUIRED NUMBER OF 1" DIA. HOLES = 0.00398/0.00545 = 0.73 HOLES USE 1-1" HOLES AT EL. 1021.00


100 YR STORM RESTRICTOR DESIGN

 $Q_A$  = (1.55 AC. ONSITE + 12.00 AC. OFFSITE) X 0.20 CFS/AC.  $Q_A$  = 13.55(0.20) = 2.71 CFS TOTAL DISCHARGE ALLOWED Q<sub>MAX</sub> THROUGH 1 YR. STORM RESTRICTOR:  $\begin{cases}
Q_{1YR} = A_{1YR}(0.62 \text{ x}\sqrt{2gh}) \\
Q_{1YR} = 0.00545(0.62 \text{ x}\sqrt{2(32.2)(1024.67-1021.00)})
\end{cases}$ Q<sub>1YR</sub> = 0.052 CFS

( QMAX THROUGH 100 YR. STORM RESTRICTOR:  $Q_{100YR} = Q_A - Q_{1YR}$  $Q_{100YR} = 2.710 - 0.052$  $Q_{100YR} = 2.658 \text{ CFS}$ 

 $A_{100YR} = Q_{100YR} / 0.62 \times \sqrt{2gh}$   $A_{100YR} = 2.658 / 0.62 \times \sqrt{2(32.2)(1024.67-1023.21)}$  $A_{100YR} = 0.44212 \text{ FT}^2$ 

 $^{\circ}$  0.00545 FT  $^{2}$  = AREA OF A 1" DIA. HOLE REQUIRED NUMBER OF 1" DIA. HOLES = 0.44212/0.00545 = 81.12 HOLES 40-1" DIA. HOLES AT EL. 1023.50 

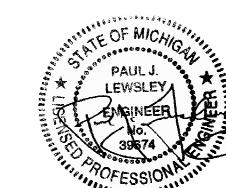





SITE STORMWATER & DETAILS

SHEET NO.

C-2

EE # 1947

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Highland Township

Fire Department

PROJECT NAME

Highland Township Fire Station No. 2

2550 E. Wardlow Rd. Highland, MI 48356

PROJECT NO.

18-122B

ISSUES / REVISIONS 07/31/20 - 90% REVIEW

08/11/20 - 95% REV**I**EW 08/27/20 - BIDDING & CONSTRUCTION

09/09/20 - ADDENDUM NO. 1 12/08/20 - REBIDDING & CONSTRUCTION 07/13/21 - CCD-1 A


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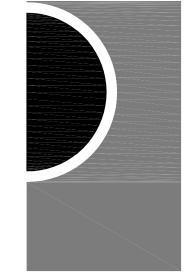
APPROVED BY

SHEET NAME

MANAGEMENT PLAN



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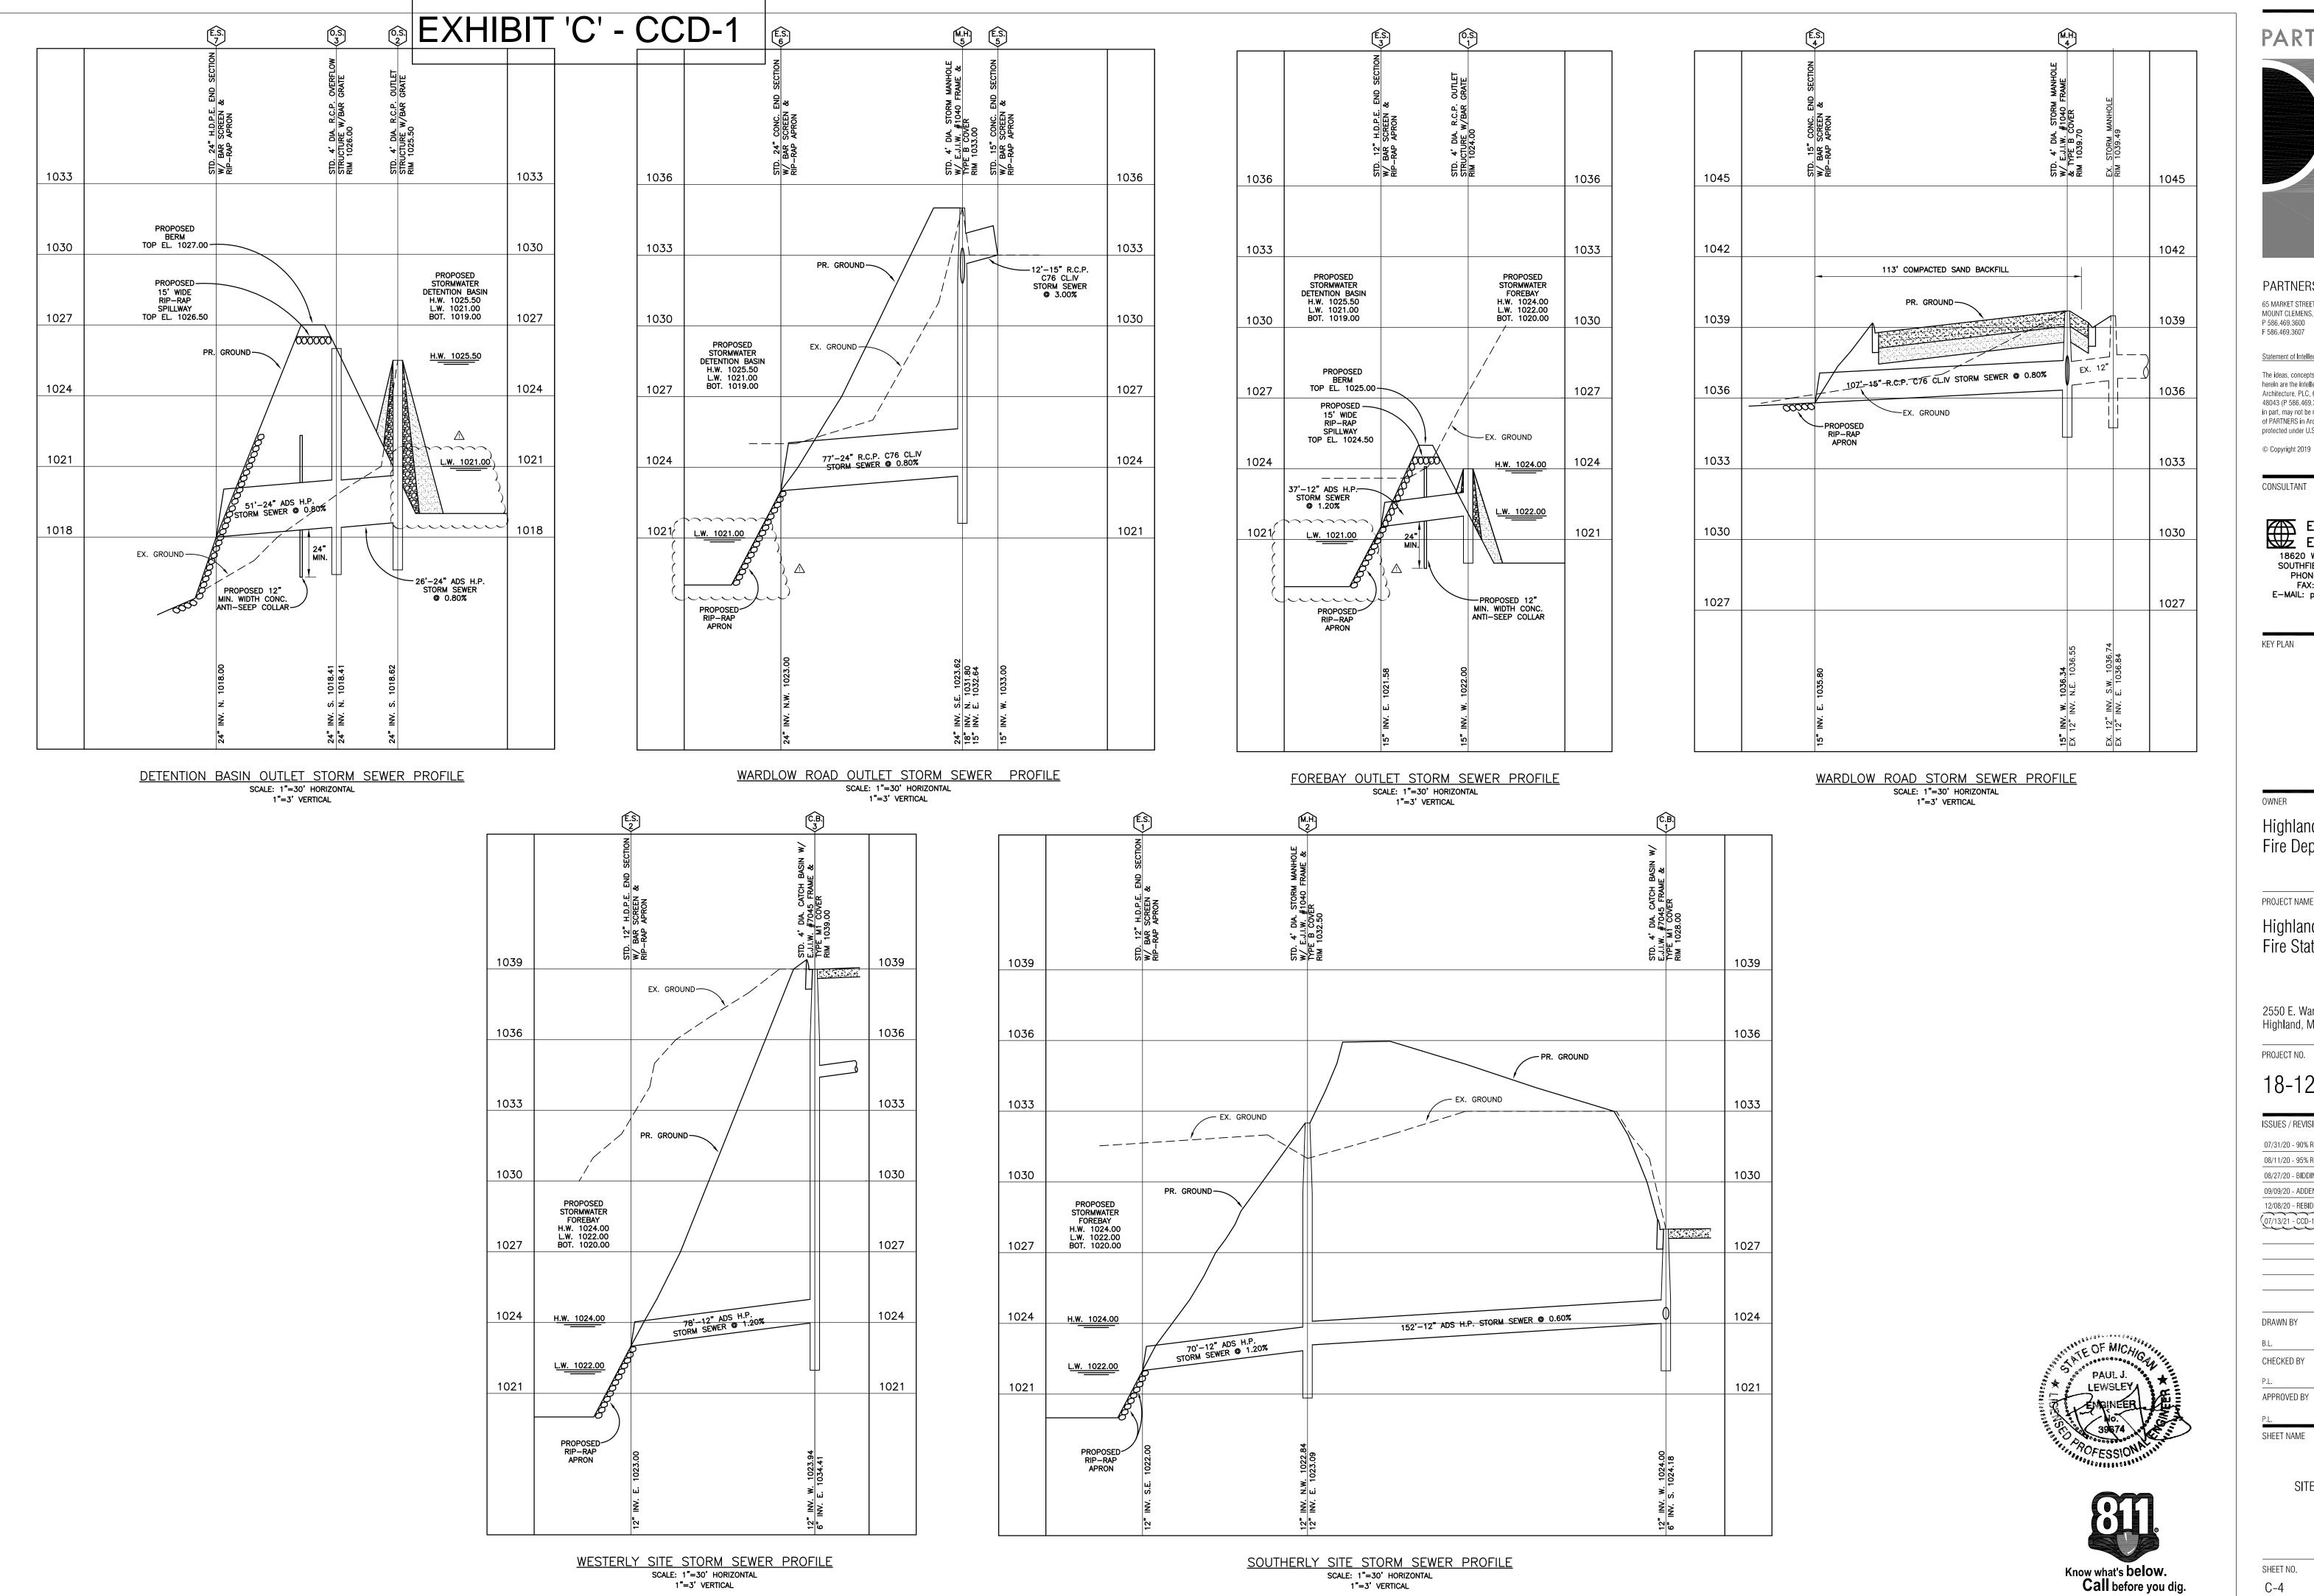
08/27/20 - BIDDING & CONSTRUCTION 08/09/20 - ADDENDUM NO. 12/08/20 - REBIDDING & CONSTRUCTION
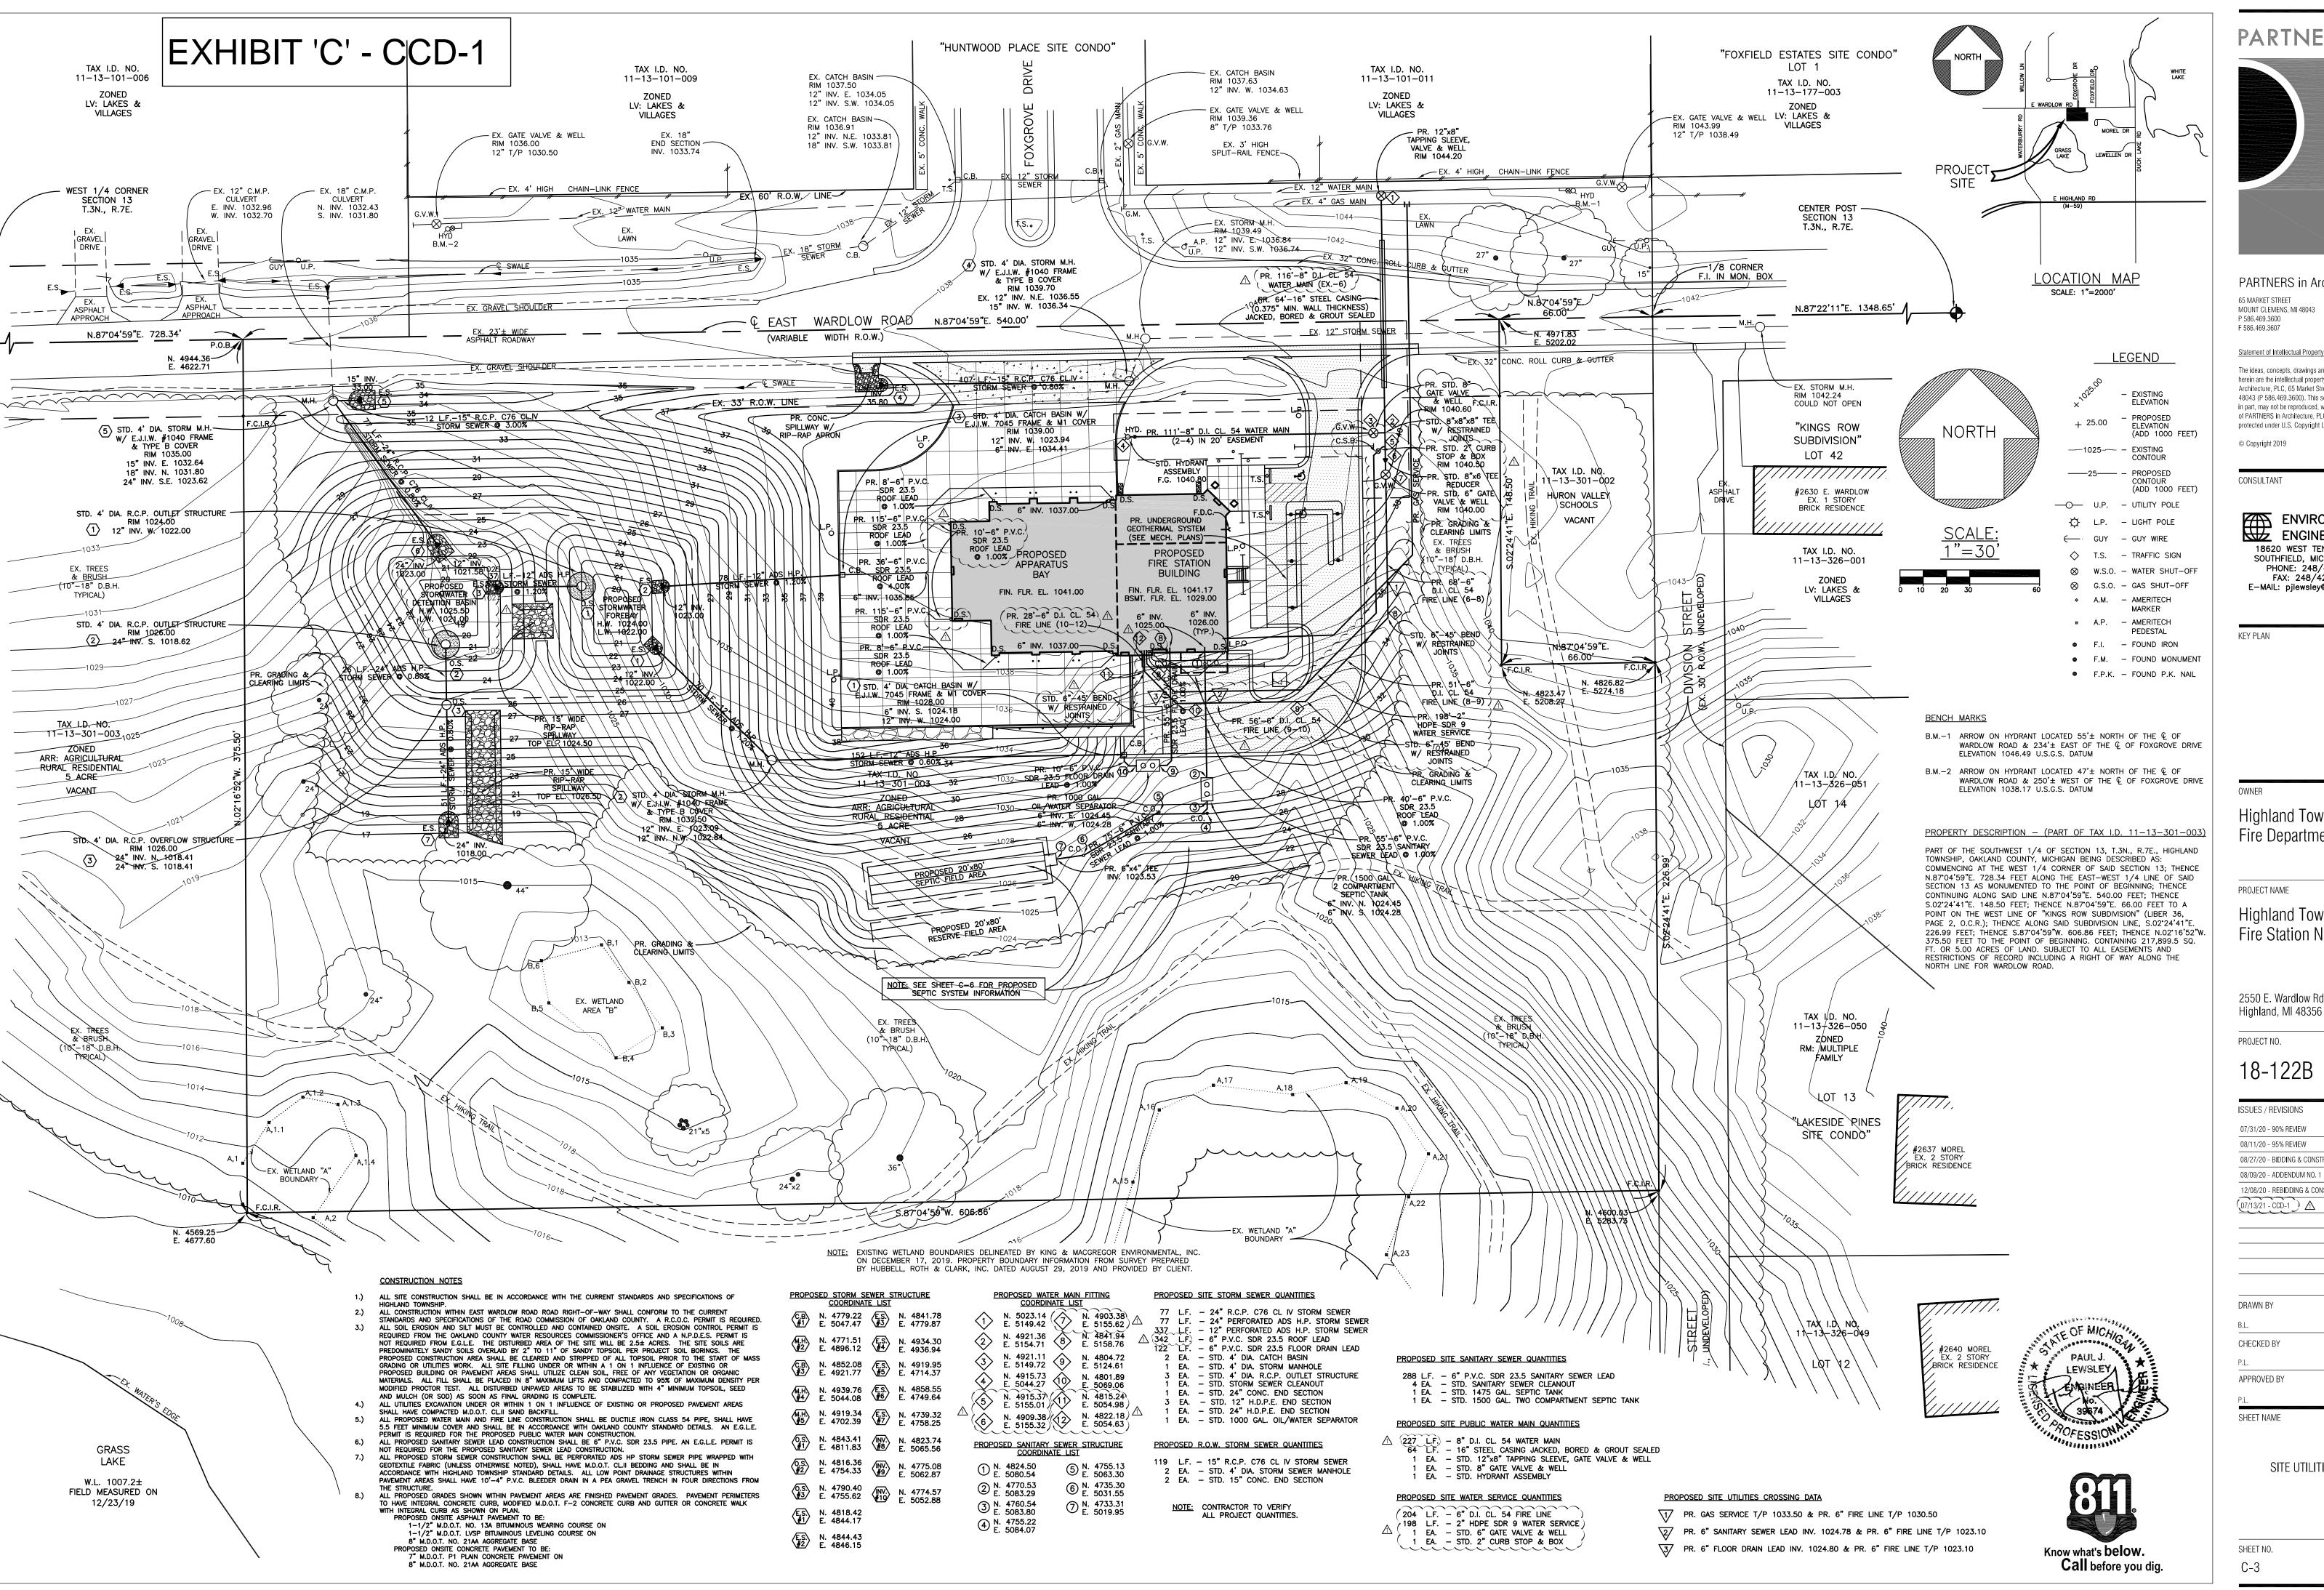
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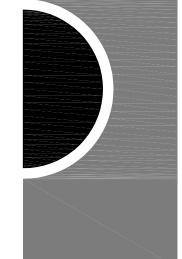
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SITE UTILITIES PLAN



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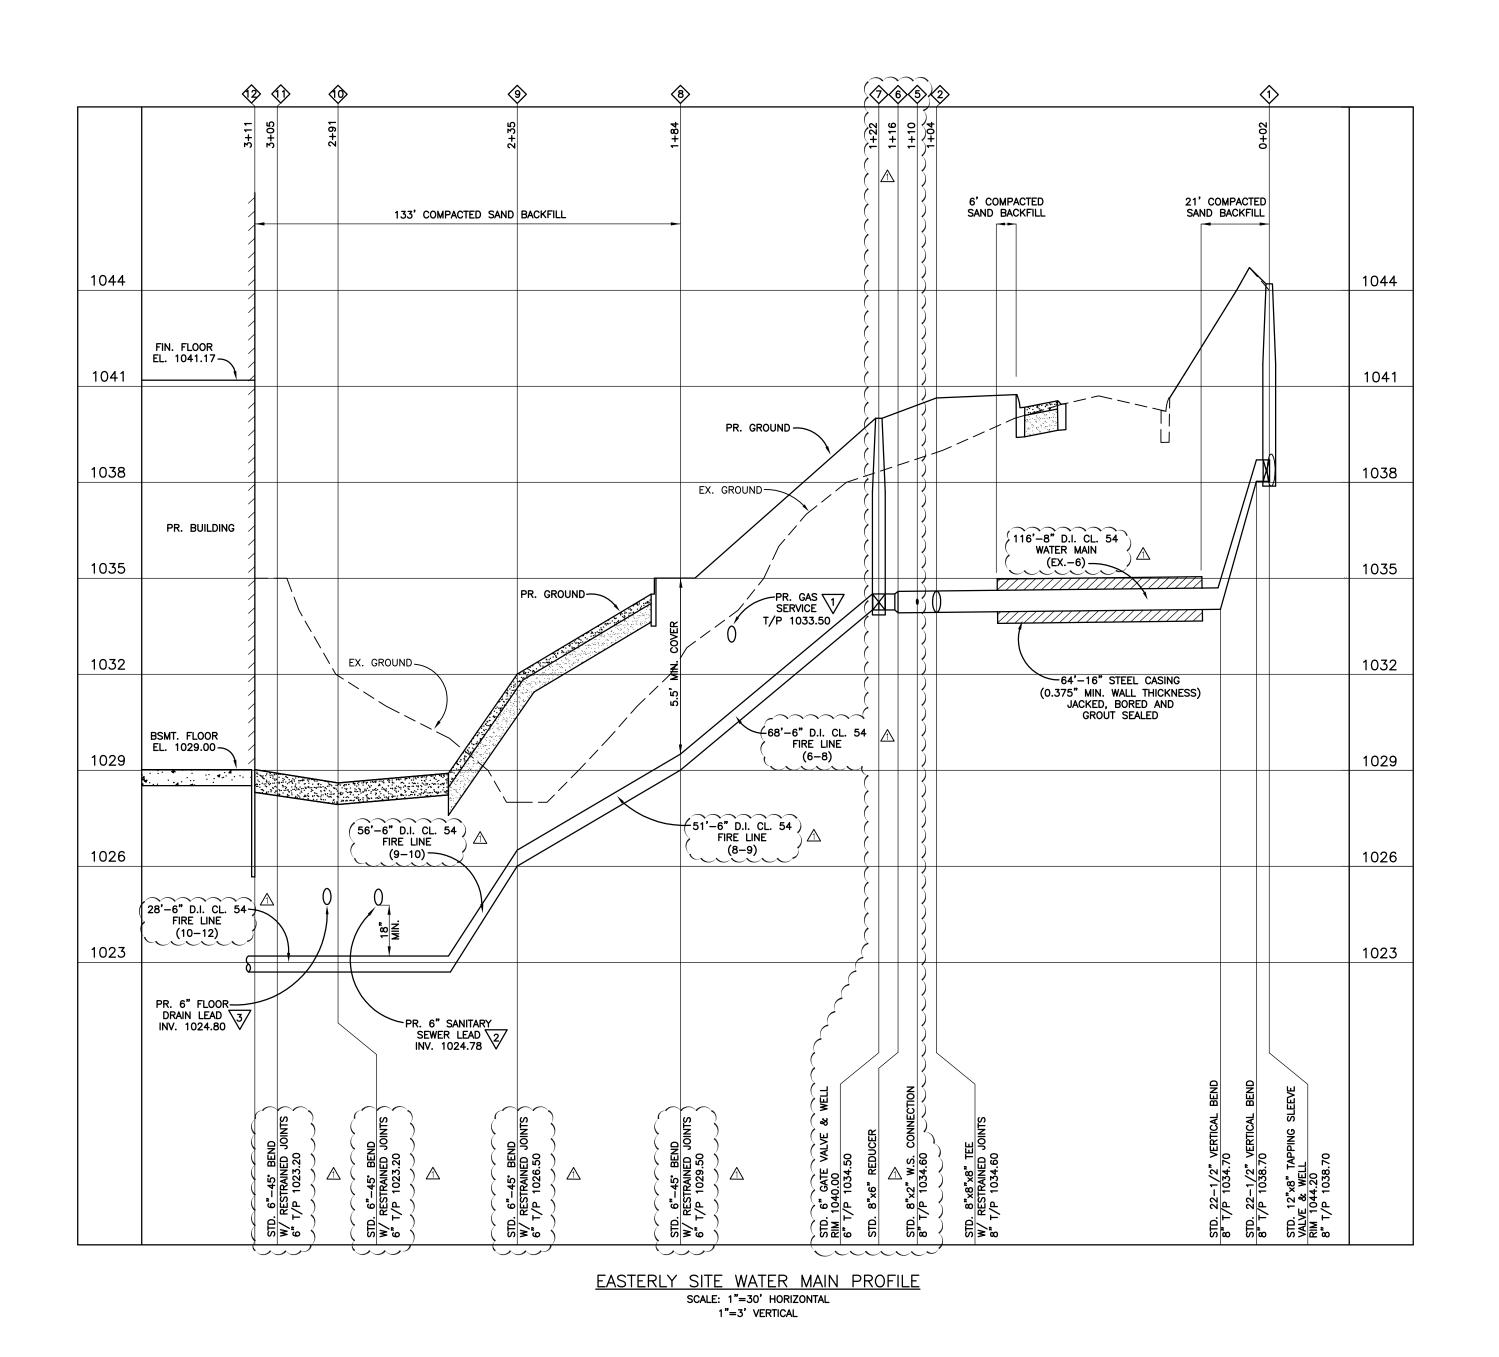
(07/13/21 - CCD-1) A


APPROVED BY

SHEET NAME

SITE STORM SEWER PROFILES

SHEET NO. C-4




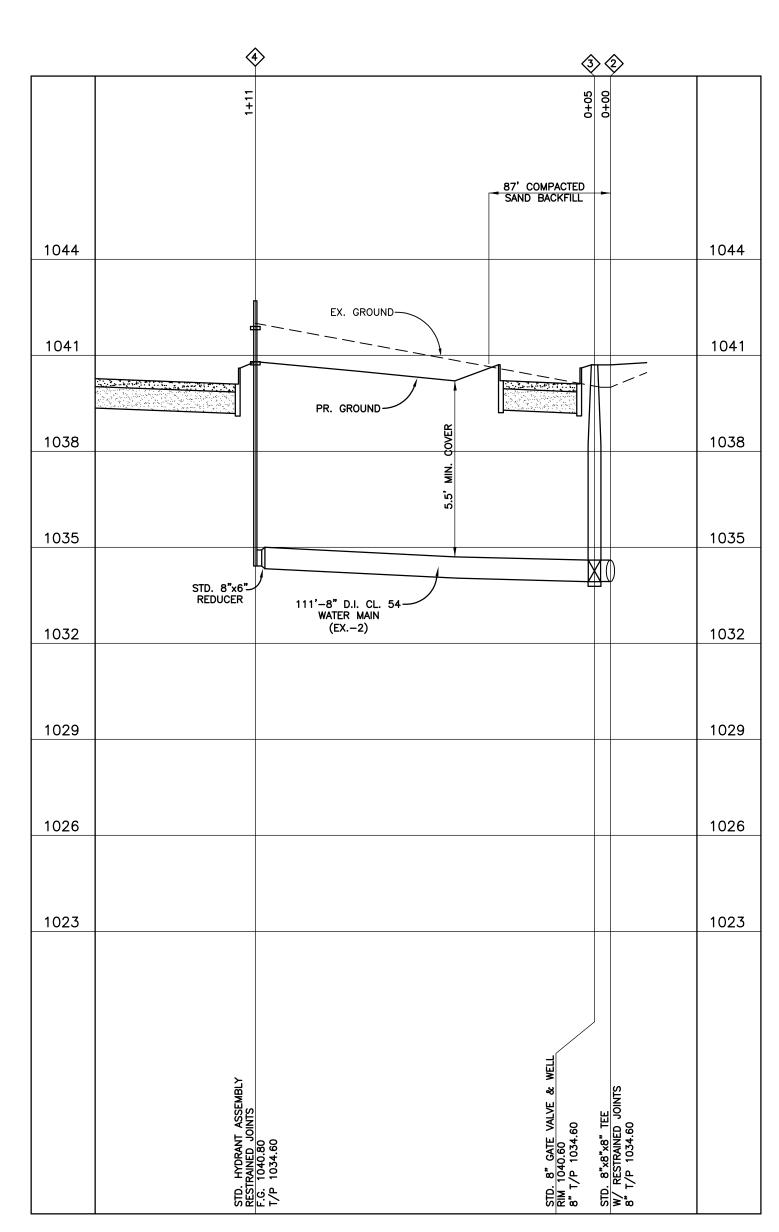

NORTHERLY SITE WATER MAIN PROFILE


SCALE: 1"=30' HORIZONTAL

1"=3' VERTICAL

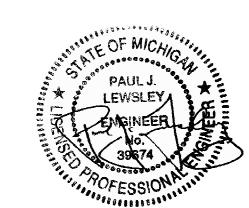



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07/13/21 - CCD-1 A
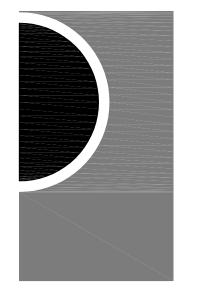
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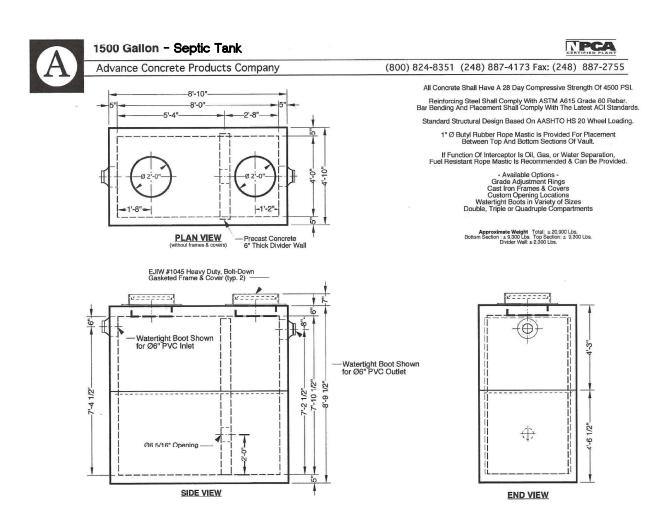
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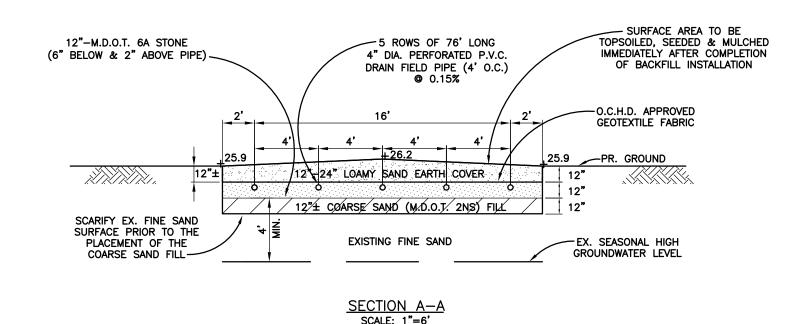
SITE WATER MAIN **PROFILES** 


SHEET NO. C-5

# PR. 36'-6" P.V.C. B SDR 235 APPAKATUS BUILDING 41.17 BAY FURE LINE (6-8) FIN. FLR. EL. 1041.17 FIN. FLR. EL. 1041.00 4.00% BSMT. FLR. EL. 1029.00 6" INV. 1035.85 NORTH PR. 28'-6" D.I. CL. 54 PR. 115'-6" P.V.C 6" INV. 1026.00 FIRE LINE (10-12)\_\_\_ 1025.00~ SDR 23.5 WX RESTRAINED ROOF LEAD JONNTS 6" INV. 1037.00 \_SDR 23.5 ROOF LEAD 39.50 @ 1.00% P.I. CL. 54 FIRE LINE (8-9)) 1) STD. 4' DIA. CATCH BASIN W/ E.J.I.W. 7045 FRAME & M1 COVER-STD. 6"/45' BEND W/ RESTRAINED RIM 1028.00 HDPE SDR 9 6" INV. S. 1024.18 WATER SERVICE 12" INV. W. 1024.00 DR. 10 -6" D.V.C. - 28.00 TO B" -6" D.V.C. - 00 "B" -1032 SDR 23.5 FLOOR DRAIN SEPARAT STD. 6"7045" BEND W/ RESTRAINED/ JOINTS 152 L.F. 12" ADS H.P. STORM SEWER @ 0.60% 34 CLEARING LIMITS 11-13-301-003 SDR 23.5 ROOF LEAD OIL/WATER SEPARATOR AGRICULTURAL \@ 1.00% WY E.J.LW. #1040 ERAME & TYPE B COVER RURAL RESIDENTIA — PR. \55'-\6" \P.V.C. SDR 23.5 \SANITARY RIM\_1032\50 SEWER LEAD @ 1.00% 12" INV. N.W. 1022.84 PR. 1500 GAL ALKAYON ... PR. 6"x4" FEE INV. 1023.53 PR. 4"-90" BEND SEPTIC TANK 6" INV. N. 1024.45 (TYPICAL) / 6" INV. \$ 1024.28 PR. 5 ROWS OF 76 LONG 4" DIA: PERFORATED P.V.C. DRAIN FIELD PUPE (4' O.C.) PR. 4" SOUD P.V.C. HEADER AT/EL. 1923.45/ PROPOSED 20'x80' RESERVE FIELD AREA PR. GRADING PR. 12"-M.Q.O.T. 6A STONE BED-(6" BELOW & 2" ABOVE RIPE) CLEARING LIMITS NOTE: THE OAKLAND COUNTY HEALTH DEPARTMENT INSPECTOR MUST SEE THE FOLLOWING: 1. ENTIRE DISPOSAL BED AREA PRIOR TO THE PLACEMENT OF THE COARSE 2NS SAND FILL 2. ENTIRE DISPOSAL BED AREA PRIOR TO THE PLACEMENT OF THE 10A STONE OVER THE EX. TREES & BRUSH SAND FILL 3. TOP OF TANK, INLET & OUTLET 4. HEADER — FULL LENGTH 5. FOOTER — FULL LENGTH 6. ENTIRE DRAIN FILE FIELD PRIOR TO THE PLACEMENT OF THE 6A STONE OVER THE TILE. (1d"\\_18" D.B.H\ TYP(CAL) `⊠,A,\20

# EXHIBIT 'C' - CCD-1






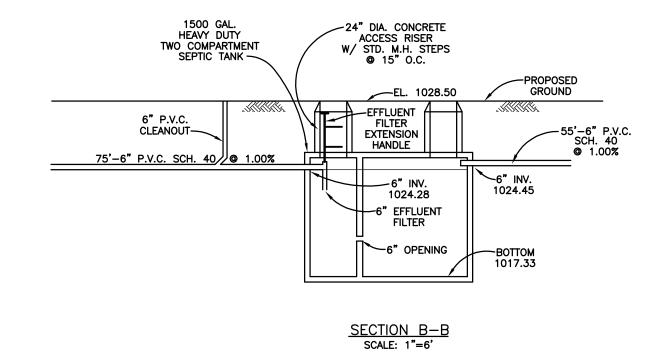

# PAUL J. LEWSLEY MO. 39674 POFESSION



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65 MARKET STREET
MOUNT CLEMENS, MI 48043
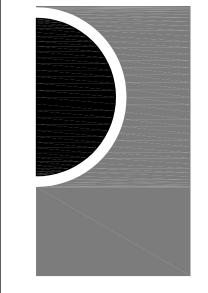
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ENVIRONMENTAL
ENGINEERS, INC.

18620 WEST TEN MILE ROAD
SOUTHFIELD, MICHIGAN 48075
PHONE: 248/424-9510
FAX: 248/424-2954
E-MAIL: pjlewsley@envengrs.com

KFY PI AN

Highland Township Fire Department

PROJECT NAME

Highland Township Fire Station No. 2

2550 E. Wardlow Rd. Highland, MI 48356

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PROJECT NO.

18-122B

ISSUES / REVISIONS

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08/27/20 - BIDDING & CONSTRUCTION
09/09/20 - ADDENDUM NO. 1

12/08/20 - REBIDDING & CONSTRUCTION

DRAWN BY

B.L.

CHECKED BY

APPROVED BY

P.L. SHEET NAME

SITE SEPTIC SYSTEM DETAILS

SHEET NO.

EE # 1947

# SEPTIC SYSTEM CONSTRUCTION NOTES

SEPTIC SYSTEM BASIS OF DESIGN

5 FULL TIME RESIDENT EMPLOYEES: 5x100 GPD = 500 GPD

MEDIUM SAND SUBSOILS PER PROJECT SOILS REPORT THEREFORE USE 0.35 GAL./S.F. APPLICATION RATE TO BE CONSERVATIVE. 500 GAL./0.35 GAL./S.F. = 1,429 S.F. MINIMUM BED SIZE. USE 1,600 S.F. BED SIZE FOR 12% ADD'L FACTOR OF SAFETY.

PROVIDE REQUIRED MINIMUM 1,500 GAL. TWO COMPARTMENT TANK


BUILDING OCCUPANCY:

SYSTEM TANK CAPACITY:

SITE SOILS:

24"x2

1.) ALL WORK SHALL BE IN ACCORDANCE WITH THE OAKLAND COUNTY HEALTH DIVISION STANDARDS AND SPECIFICATIONS. AN O.C.H.D. PERMIT IS REQUIRED.
2.) THE SEPTIC TANK SHALL BE WATERTIGHT HEAVY DUTY REINFORCED CONCRETE WITH RUBBER BOOTS AS MANUFACTURED BY ADVANCE CONCRETE PRODUCTS CO, OR APPROVED EQUAL. AN EFFLUENT FILTER WITH EXTENSION HANDLE SHALL BE INSTALLED ON THE 6" OUTLET OF THE 1500 GAL. TWO COMPARTMENT SEPTIC TANK. THE FILTER SHALL BE ZABEL MODEL A100—8x26 OR APPROVED EQUAL. A 24" DIAMETER CONCRETE RISER EXTENDED UP TO FINISHED GRADE SHALL BE INSTALLED ON THE SEPTIC TANK ACCESS OPENINGS. STANDARD MANHOLE STEPS SHALL BE INSTALLED 15" ON CENTER IN THE 24" RISERS OVER THE EFFLUENT FILTER & EFFLUENT PUMP. ALL CONCRETE RISERS SHALL HAVE AN E.J.I.W. #1000A FRAME & COVER (OR APPROVED EQUAL) WITH A GASKET SEAL.

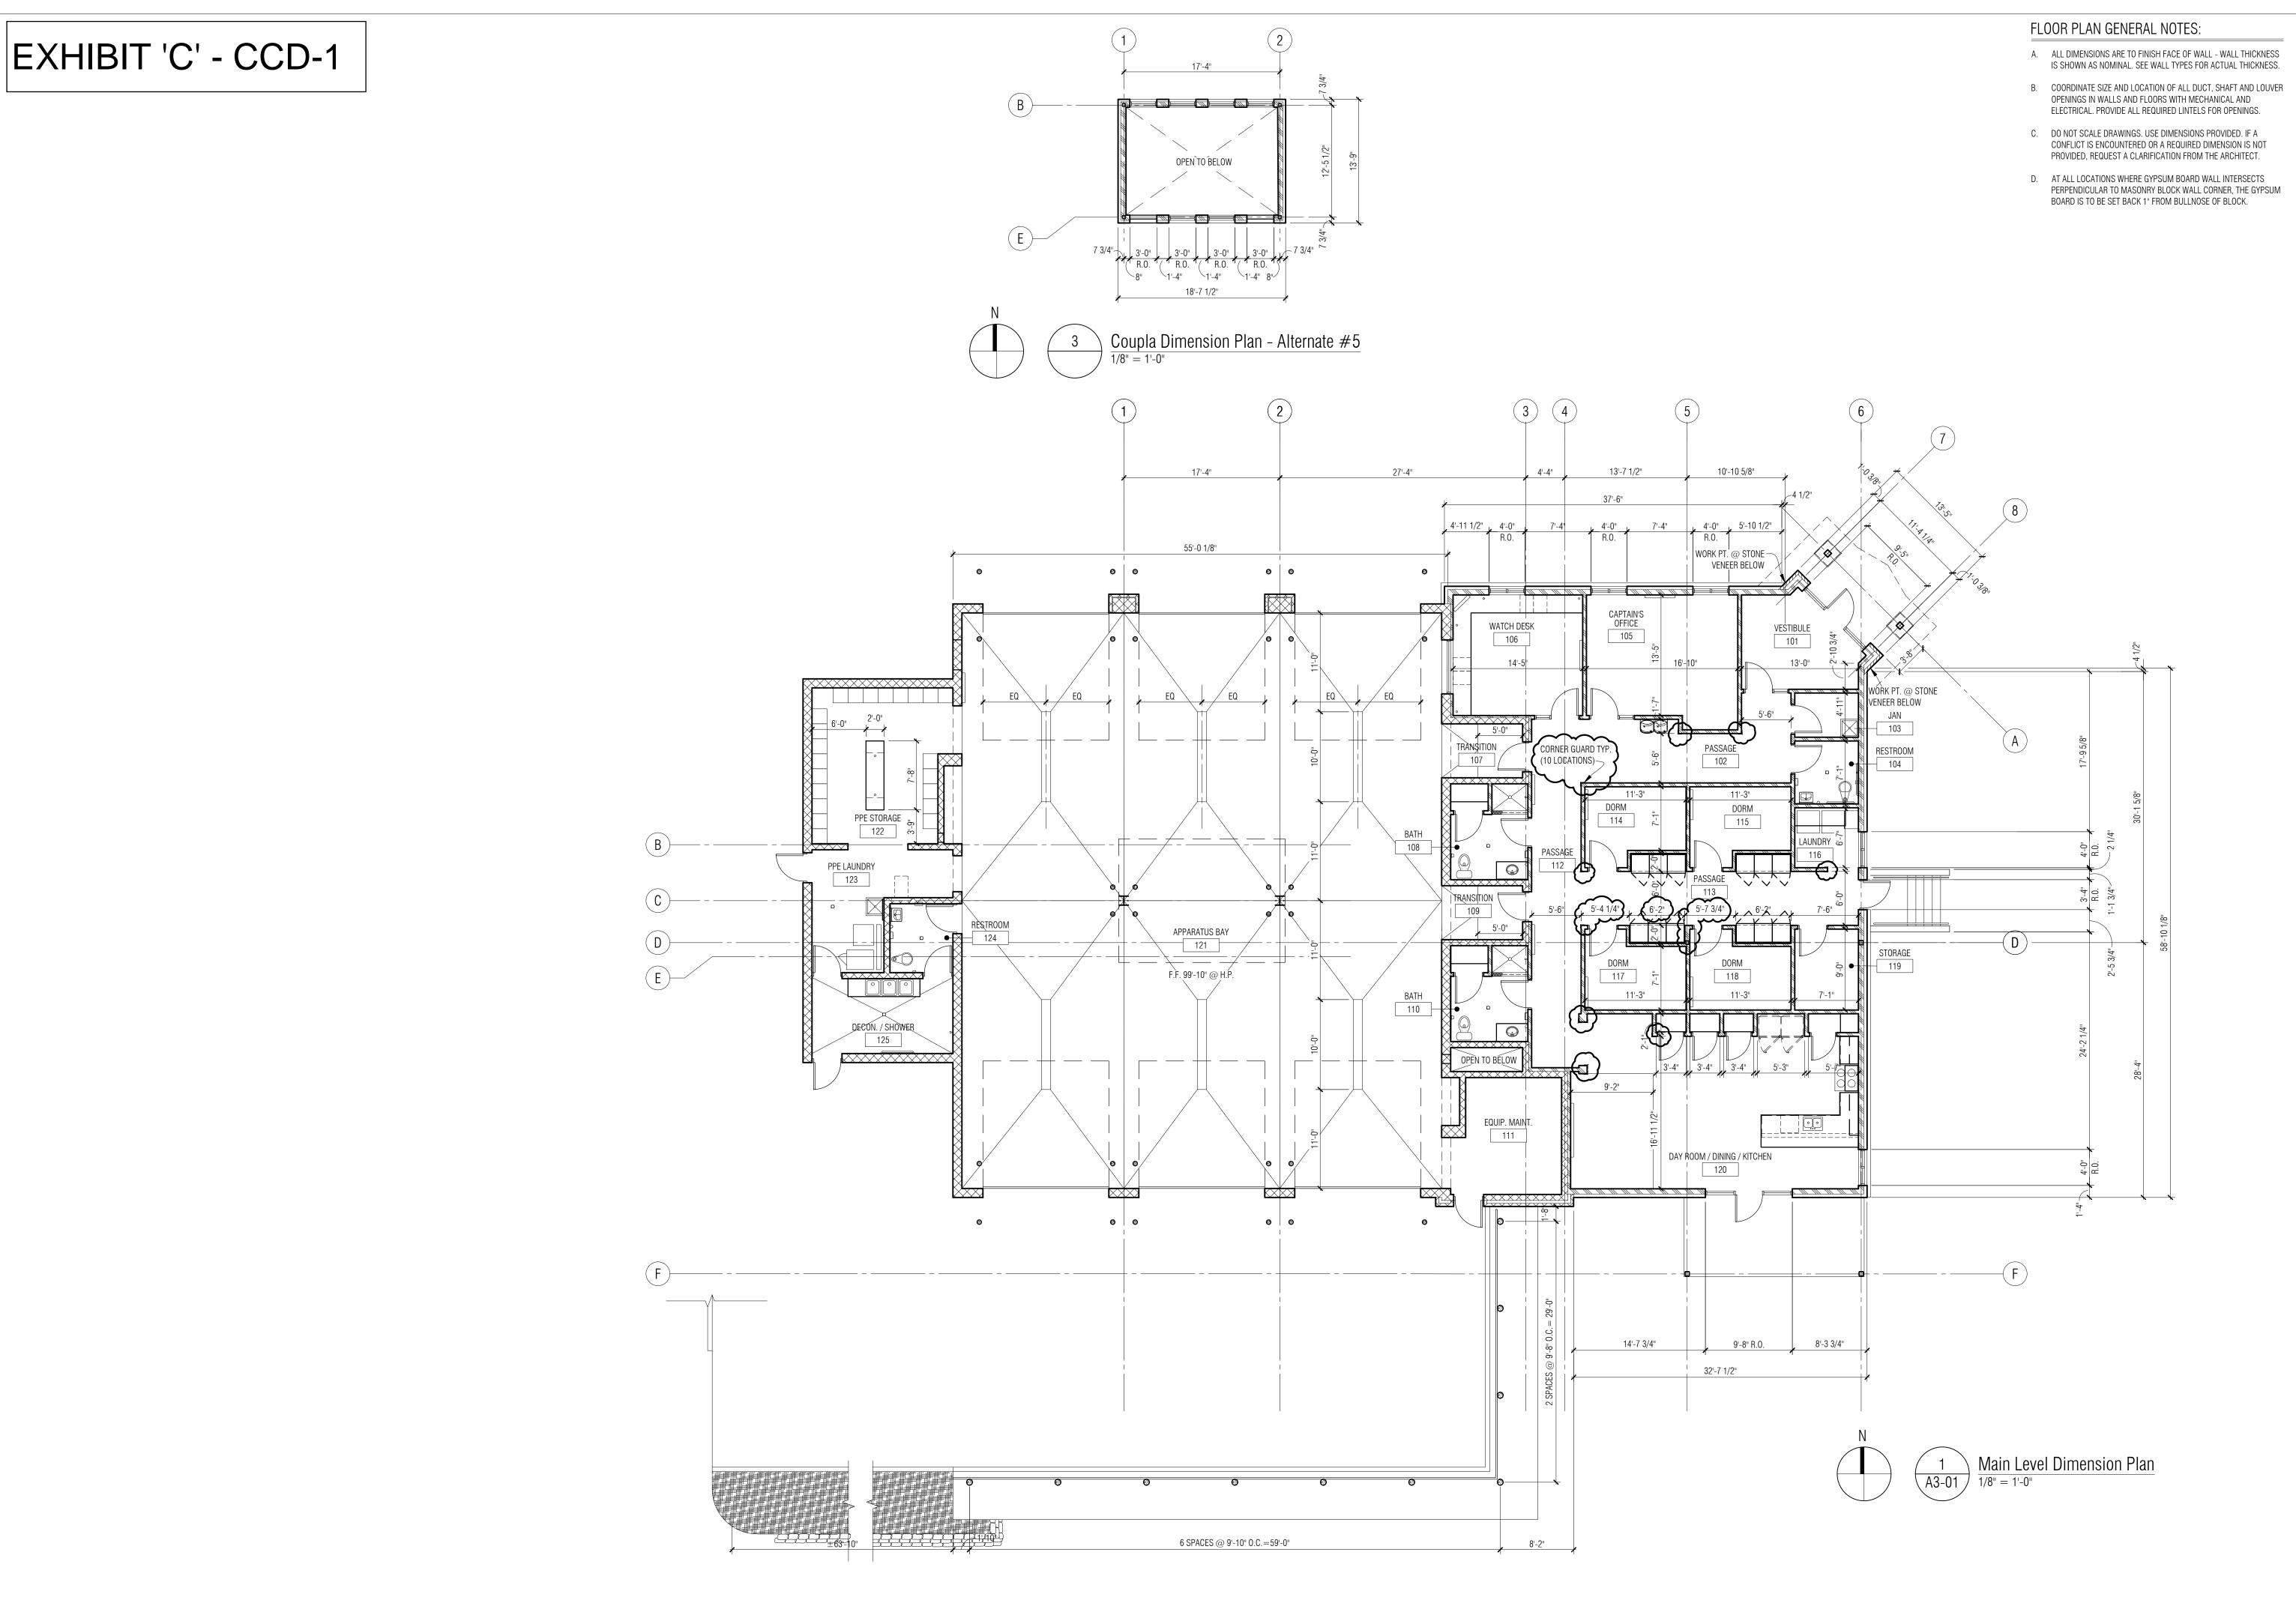





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65 MARKET STREET
MOUNT CLEMENS, MI 48043
P 586.469.3600

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Highland Township Fire Department

PROJECT NAME

Highland Township Fire Station No. 2

2550 E. Wardlow Rd. Highland, MI 48356

PROJECT NO.

18-122B

ISSUES / REVISIONS

 Bidding / Construction
 08/27/2020

 Addendum #1
 09/10/2020

 Rebidding / Construction 12/08/2020

 CCD-1
 07/09/2021

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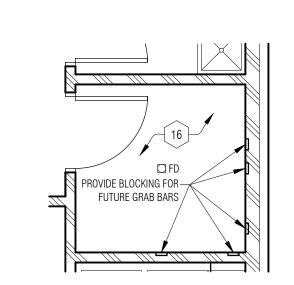
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APPROVED BY


DWG

SHEET NAME
DIMENSION PLANS


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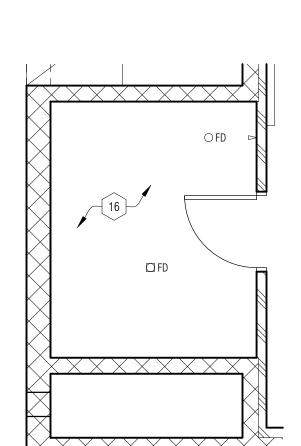




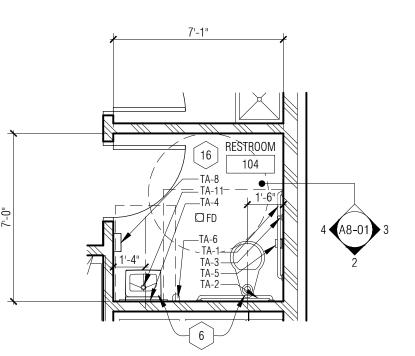


6 A3-01 Enlarged Plan - Restroom 104 - Base Bid




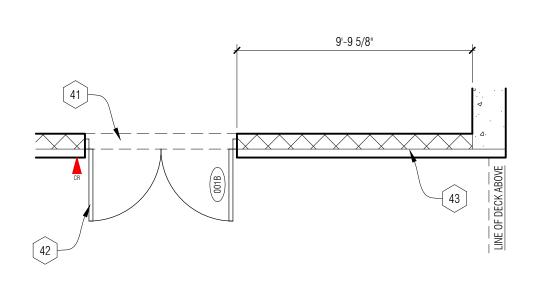




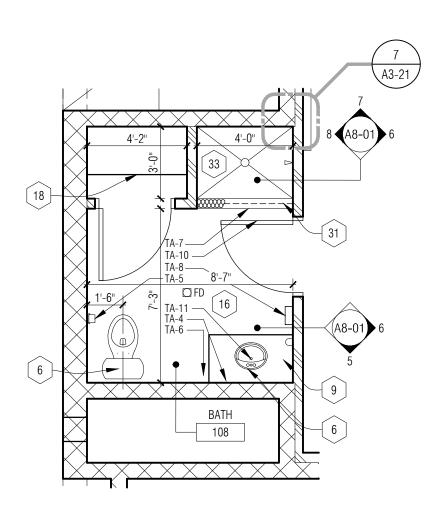

 $\underbrace{\begin{array}{c} 3 \\ \text{A3-01} \end{array}}_{\text{1/4"} = \text{1'-0"}} \underline{\text{Enlarged Plan - Bath 110 - Base Bid}}_{\text{1/4"} = \text{1'-0"}}$ 

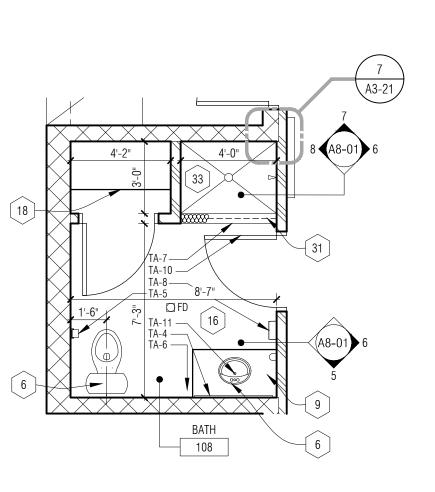



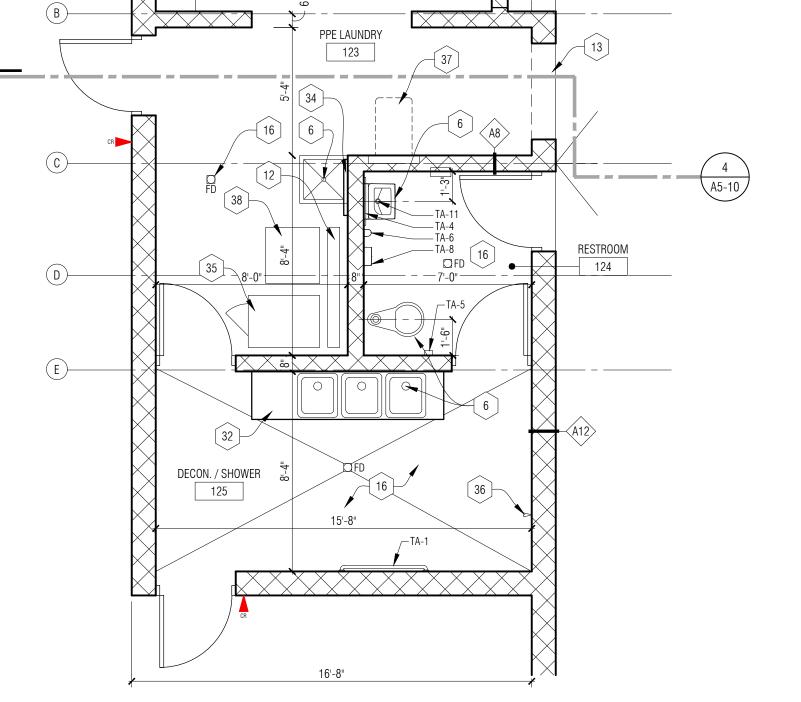



# GENERAL NOTES - TOILET ACCESSORIES

- A. REFER TO SPECIFICATION SECTION 102800 FOR DESCRIPTION OF TOILET ACCESSORIES.
- TOILET ACCESSORIES.
- B. REFER TO MECHANICAL PLANS FOR ALL PLUMBING FIXTURES.
- C. CENTER FLOOR DRAIN IN ROOM UON. ENSURE 1/8" PER FOOT SLOPE TOWARD FLOOR DRAINS. (TYP.)
- D. PROVIDE WD BLOCKING SUPPORT AT ALL GRAB BAR LOCATIONS PER GRAB BAR MANUFACTURER'S RECOMMENDATION.

# LEGEND - TOILET ACCESSORIES

- TA-1 42" GRAB BAR
- TA-2 36" GRAB BAR
- TA-3 18" GRAB BAR VERTICAL
- TA-4 WALL MOUNTED MIRROR (24" X 36'
- TA-5 TOILET TISSUE DISPENSER BY OWNER
- TA-6 SURFACE MOUNTED SOAP DISPENSER BY OWNER
- TA-7 SHOWER CURTAIN ROD & HOOKS
- TA-8 PAPER TOWEL DISPENSER BY OWNER
- TA-9 NOT USED
- TA-10 TOWEL HOOK
- TA-11 LAVATORY GUARD
- TA-12 FREE STANDING WASTE RECEPTACLE (NOT SHOWN-PROVIDE 1 AT EACH RESTROOM)

# FLOOR PLAN GENERAL NOTES:

- A. ALL DIMENSIONS ARE TO FINISH FACE OF WALL WALL THICKNESS IS SHOWN AS NOMINAL. SEE WALL TYPES FOR ACTUAL THICKNESS.
- B. COORDINATE SIZE AND LOCATION OF ALL DUCT, SHAFT AND LOUVER OPENINGS IN WALLS AND FLOORS WITH MECHANICAL AND ELECTRICAL. PROVIDE ALL REQUIRED LINTELS FOR OPENINGS.
- C. DO NOT SCALE DRAWINGS. USE DIMENSIONS PROVIDED. IF A CONFLICT IS ENCOUNTERED OR A REQUIRED DIMENSION IS NOT PROVIDED, REQUEST A CLARIFICATION FROM THE ARCHITECT.
- D. AT ALL LOCATIONS WHERE GYPSUM BOARD WALL INTERSECTS
  PERPENDICULAR TO MASONRY BLOCK WALL CORNER, THE GYPSUM
  BOARD IS TO BE SET BACK 1" FROM BULLNOSE OF BLOCK.

# FLOOR PLAN KEY NOTES:

- 1 UNDER COUNTER DISHWASHER PROVIDED BY OWNER
- 2 LINE OF STONE SKIRTING AND SILL BELOW REFER TO SECTIONS
- 3 TV BY OWNER REFER TO ELEC
- 4 WASHER/DRYER PROVIDED BY OWNER REFER TO MECH. & ELEC.
- WASHERY DITTER PROVIDED BY OWNER REPER TO WEGH. & ELE
- 5 LINE OF FLOOR MATERIAL CHANGE NO TRANSITION STRIP BETWEEN MATERIALS - REFER TO DETAIL T4 ON A0-14
- 6 PLUMBING FIXTURE REFER TO PLUMBING
- 7 WALL MOUNTED PPE STORAGE REFER TO SPECIFICATIONS
- 8 MONITOR BY OWNER REFER TO ELEC.
- 9 WOOD LOCKERS AT DORMS REFER TO SPECIFICATIONS
- 10 42" HIGH COUNTERTOP WITH BRACKETS
- (11) COMPOSITE WOOD FLOOR DECK ON WOOD TREATED FLOOR CONSTRUCTION REFER TO WALL SECTIONS AND STRUCTURAL.
- PRE-FABRICATED TRENCH DRAIN PROVIDE 2" CHASE WITH JOINT SEALANT AROUND PERIMETER REFER TO PLUMBING. (SET TOP OF GRATE AT 1" BELOW F.F. ELEVATION
- MASONRY OPENING REFER TO DIMENSION PLAN AND ELEVATIONS FOR OPENING SIZE
- 14 APPLIANCE PROVIDED & INSTALLED BY OWNER
- 6" Ø x 4'-0" HIGH CONCRETE FILLED GALVANIZED STEEL PIPE BOLLARD
- 16 | SLOPED FLOORING PITCH TO DRAIN -1" FROM F.F. TYP.
- [17] GROMMET IN COUNTERTOP OR SURFACE
- 18 (3) ADJUSTABLE SHELVING AT 24" DEPTH
- 19 LINE OF CLERESTORY ABOVE REFER TO DETAIL 3/A3-01
- 20 ELECTRICAL WATER COOLER REFER TO MECH. & ELEC
- 21 PPE CHARGING STATION REFER TO SECTION DETAIL 1/A6-12
- 22 TRANSITION RAMPED FLOOR 1/2" PER 1'-0" SLOPE
- TRANSITION FROM FULL BED DEPTH STONE TO A 2" VENEER AT
- EXTERIOR LINE OF BUILDING BELOW
- 24 LINE OF ENTRANCE SLAB REFER TO STRUCTURAL
- 25 WALL MOUNTED HOSE BIB REFER TO PLUMBING
- 26 LAUNDRY TUB REFER TO MECH
- 27 2'-0" x 2'-0" MOP SINK REFER TO PLUMBING
- [28] LINE OF RETAINING WALL REFER TO SECTIONS AND CIVIL
- 3'-0" x 3'-0" MECHANICAL LOUVER MANUALLY OPERATED REFER TO MECH.
- 30 KNOCK OUT PANEL W/ SOFT JOINTS FOR FUTURE OPENING 3'-4"W x 7'-4"H REFER TO STRUCTURAL FOR LINTEL SIZE.
- 31 SOLID SURFACE TRANSITION AT SHOWER REFER TO DETAIL T7 ON
- A0-14

  32 STAINLESS STEEL WORK SURFACE REFER TO SPECIFICATIONS
- PORCELAIN TILE SHOWER WITH SHOWER PAN AND FLOOR DRAIN.
  COORDINATE DEPRESSION IN CONCRETE FLOOR SLAB AS REQUIRED
  FOR FLUSH FLOOR FINISH
- 34 MOP RACK

✓ & ELEC.

- 235 EXTRACTOR TO BE RELOCATED FROM STATION 1 BASE MOUNTING DETAIL BY MANUFACTURER REFER TO MECH. & ELEC OWNER TO RELOCATE
- 36 WALL MOUNTED HOSE BIB REFER TO PLUMBING
- 37 EYE WASH STATION
- 38 STACKED WASHER/DRYER PROVIDED BY OWNER REFER TO MECH.
- 39 DASHED LINE OF BUILDING FOOTPRINT ABOVE
- ALTERNATE #3: REMOVE W-1 AND STRUCTURAL HEADER AT ROOM 116 REFER TO SPECS AND STRUCT.
- 41 REVISE CMU LINTEL FOR NEW SIZE OPENING REFER TO STRUCT.
- 42 REVISE DOOR 001B TO DOUBLE DOOR REFER TO DOOR SCHEDULE
- REMOVE OVERHEAD DOOR CMU LINTEL, AND ALL ASSOCIATED HARDWARE REFER TO DOOR SCHEDULE
- 44 LINTEL TO ACCOMMODATE MECH DUCT OPENINGS REFER TO
- CORNER GUARD TO BE PROVIDED AT ALL EXPOSED GYP. BD. WALL CORNERS TYP. REFER TO MATERIAL FINISH SCHEDULE
- 46 BOTH SIDES OF GYP. BD., AND SOUND ATTENUATION BATT. IF APPLICABLE, TO EXTEND TO BOTTOM OF DECK WITH STUD WALL TYP. REFER TO DETAIL 1/A0-03 FOR GYP. BD. WALLS THAT EXTEND TO DECK
- 47 STOVE HOOD REFER TO MECH. AND SPECIFICATIONS
- 48 LINE OF BOULDER RETAINING WALL REFER TO SECTIONS AND CIVIL
- SUGGESTED MULCH BED WITH DENSE CONIFEROUS PLANTINGS PROVIDED BY OWNER



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MOUNT CLEMENS, MI 48043

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KEY PLAN

OWNED

Highland Township Fire Department

PROJECT NAME

Highland Township Fire Station No. 2

Highland, MI 48356

2550 E. Wardlow Rd.

PROJECT NO.

18-122B

ISSUES / REVISIONS

Bidding / Construction 08/27/2020

 Rebidding / Construction 12/08/2020

 CCD-1
 07/09/2021

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AM / JV


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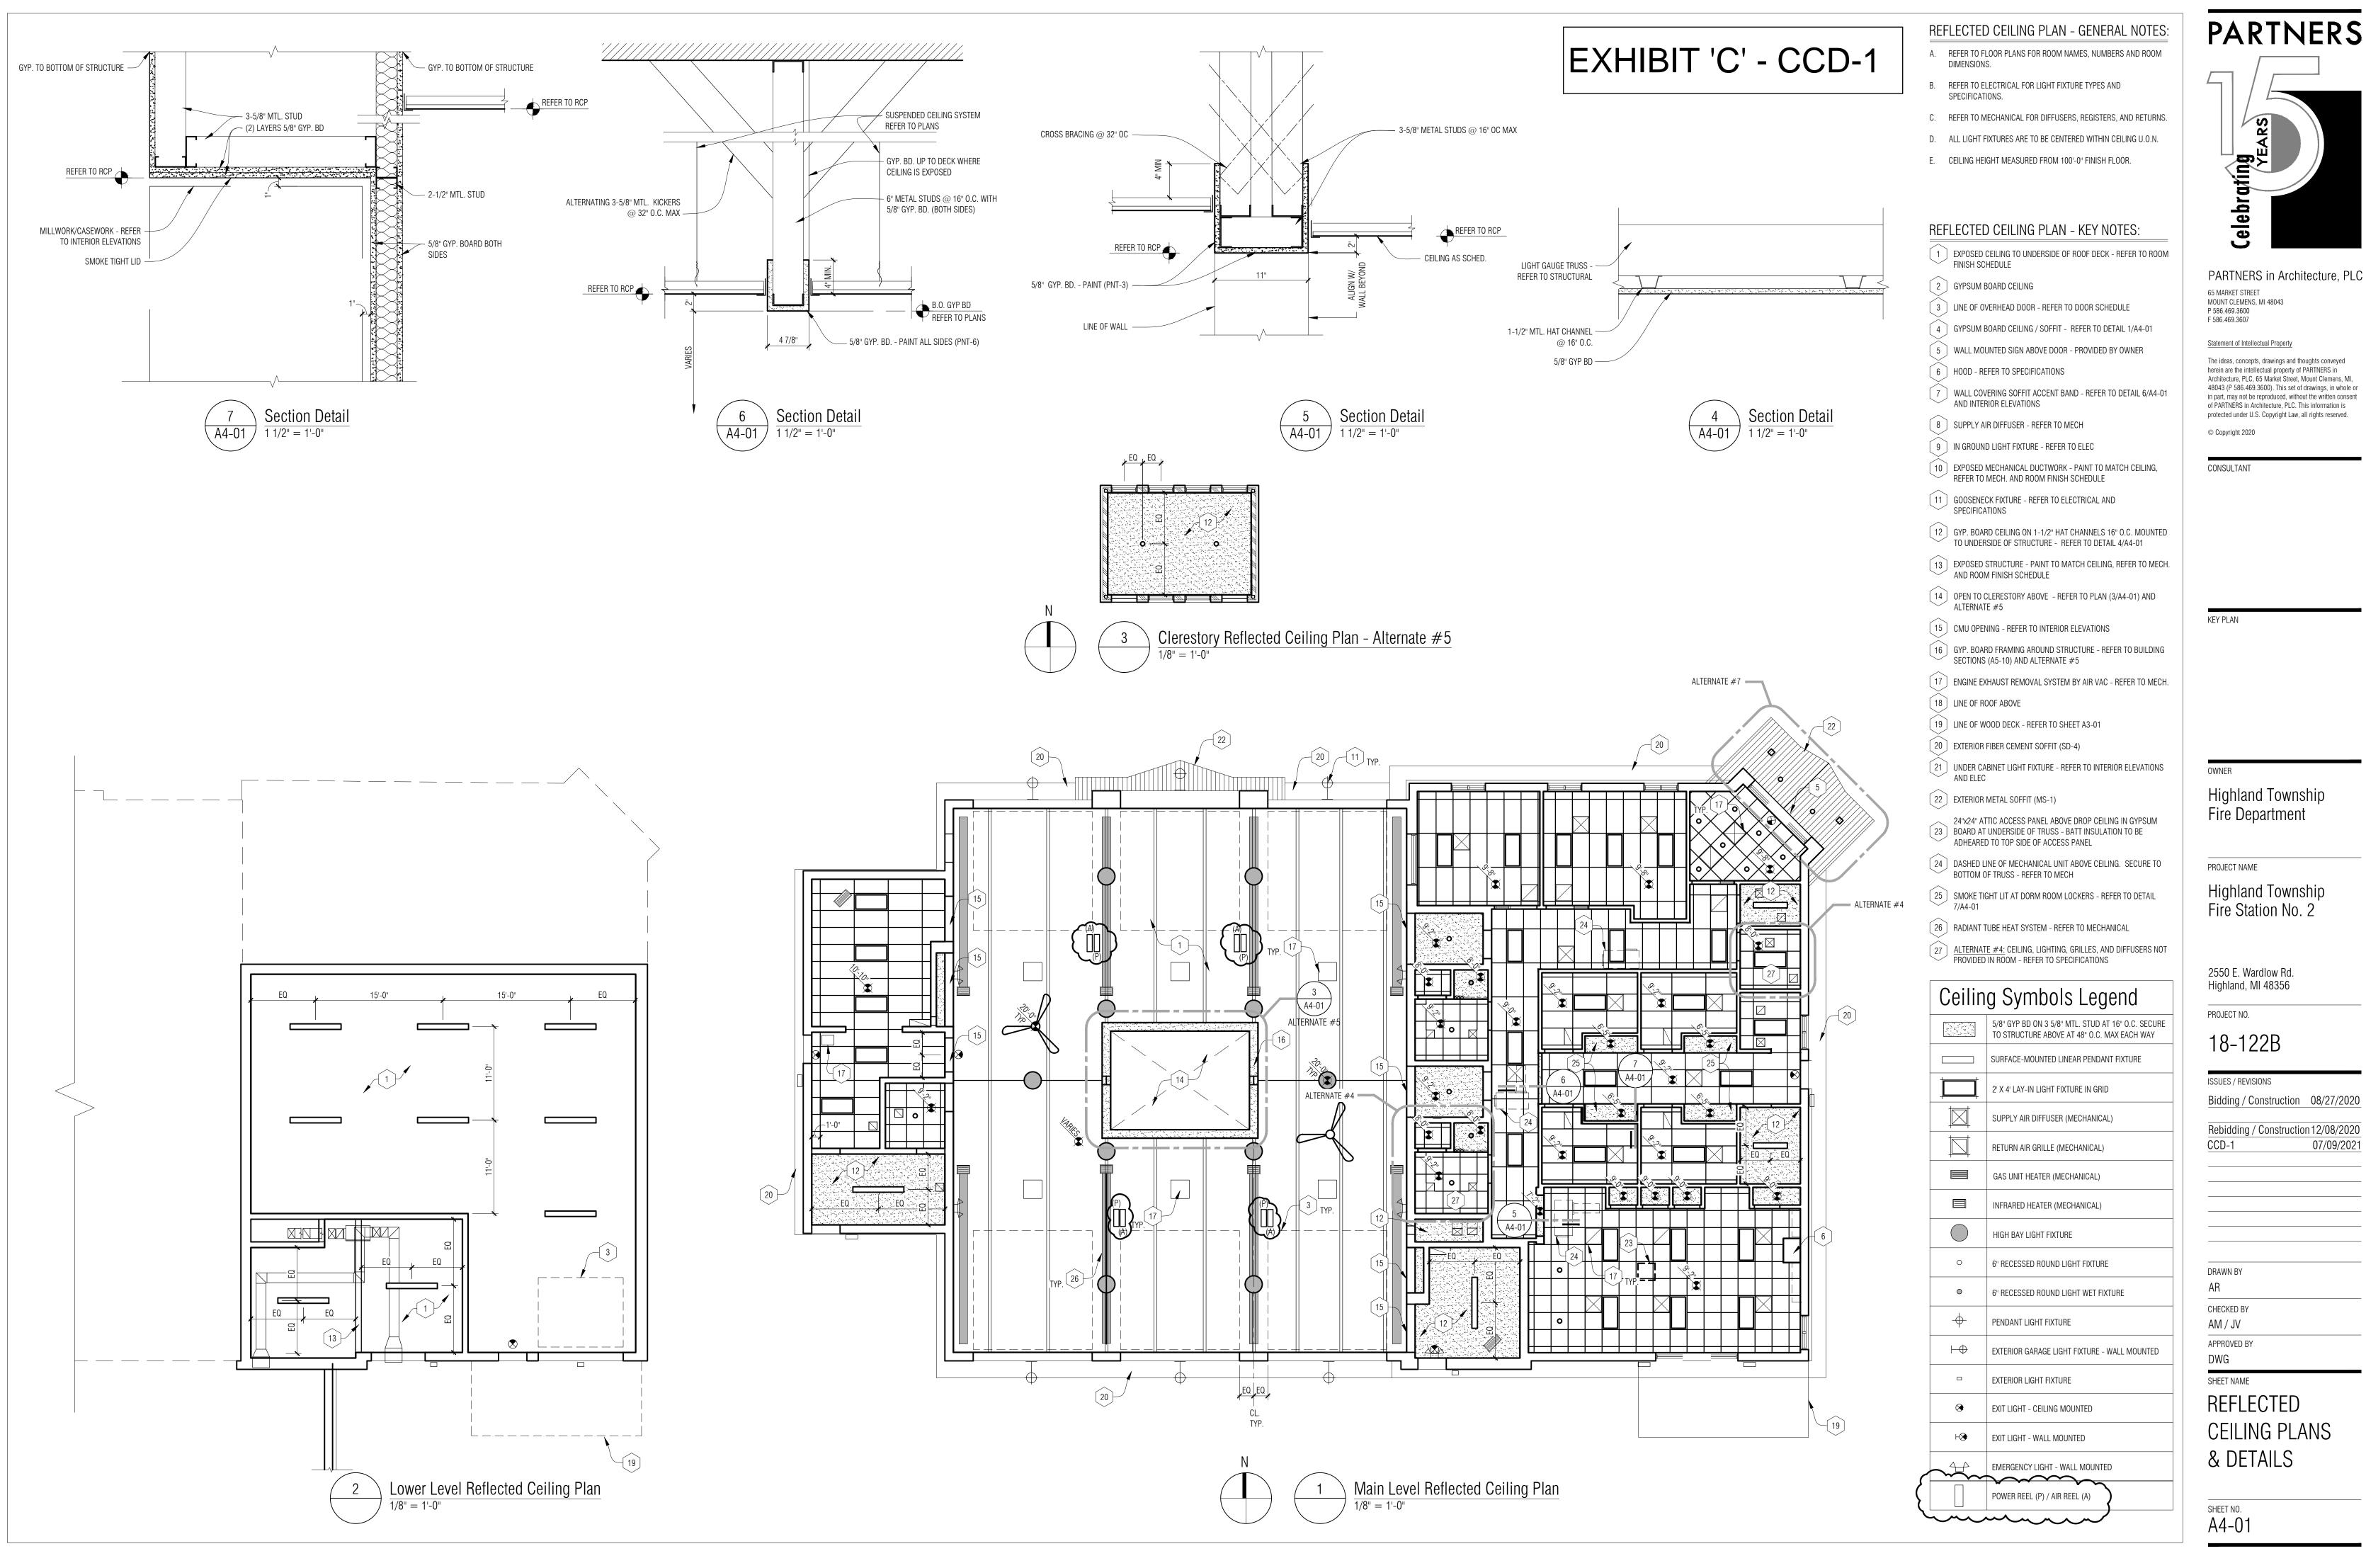
DWG
SHEET NAME

ENLARGED

FLOOR PLANS

SHEET NO. **A3-10** 



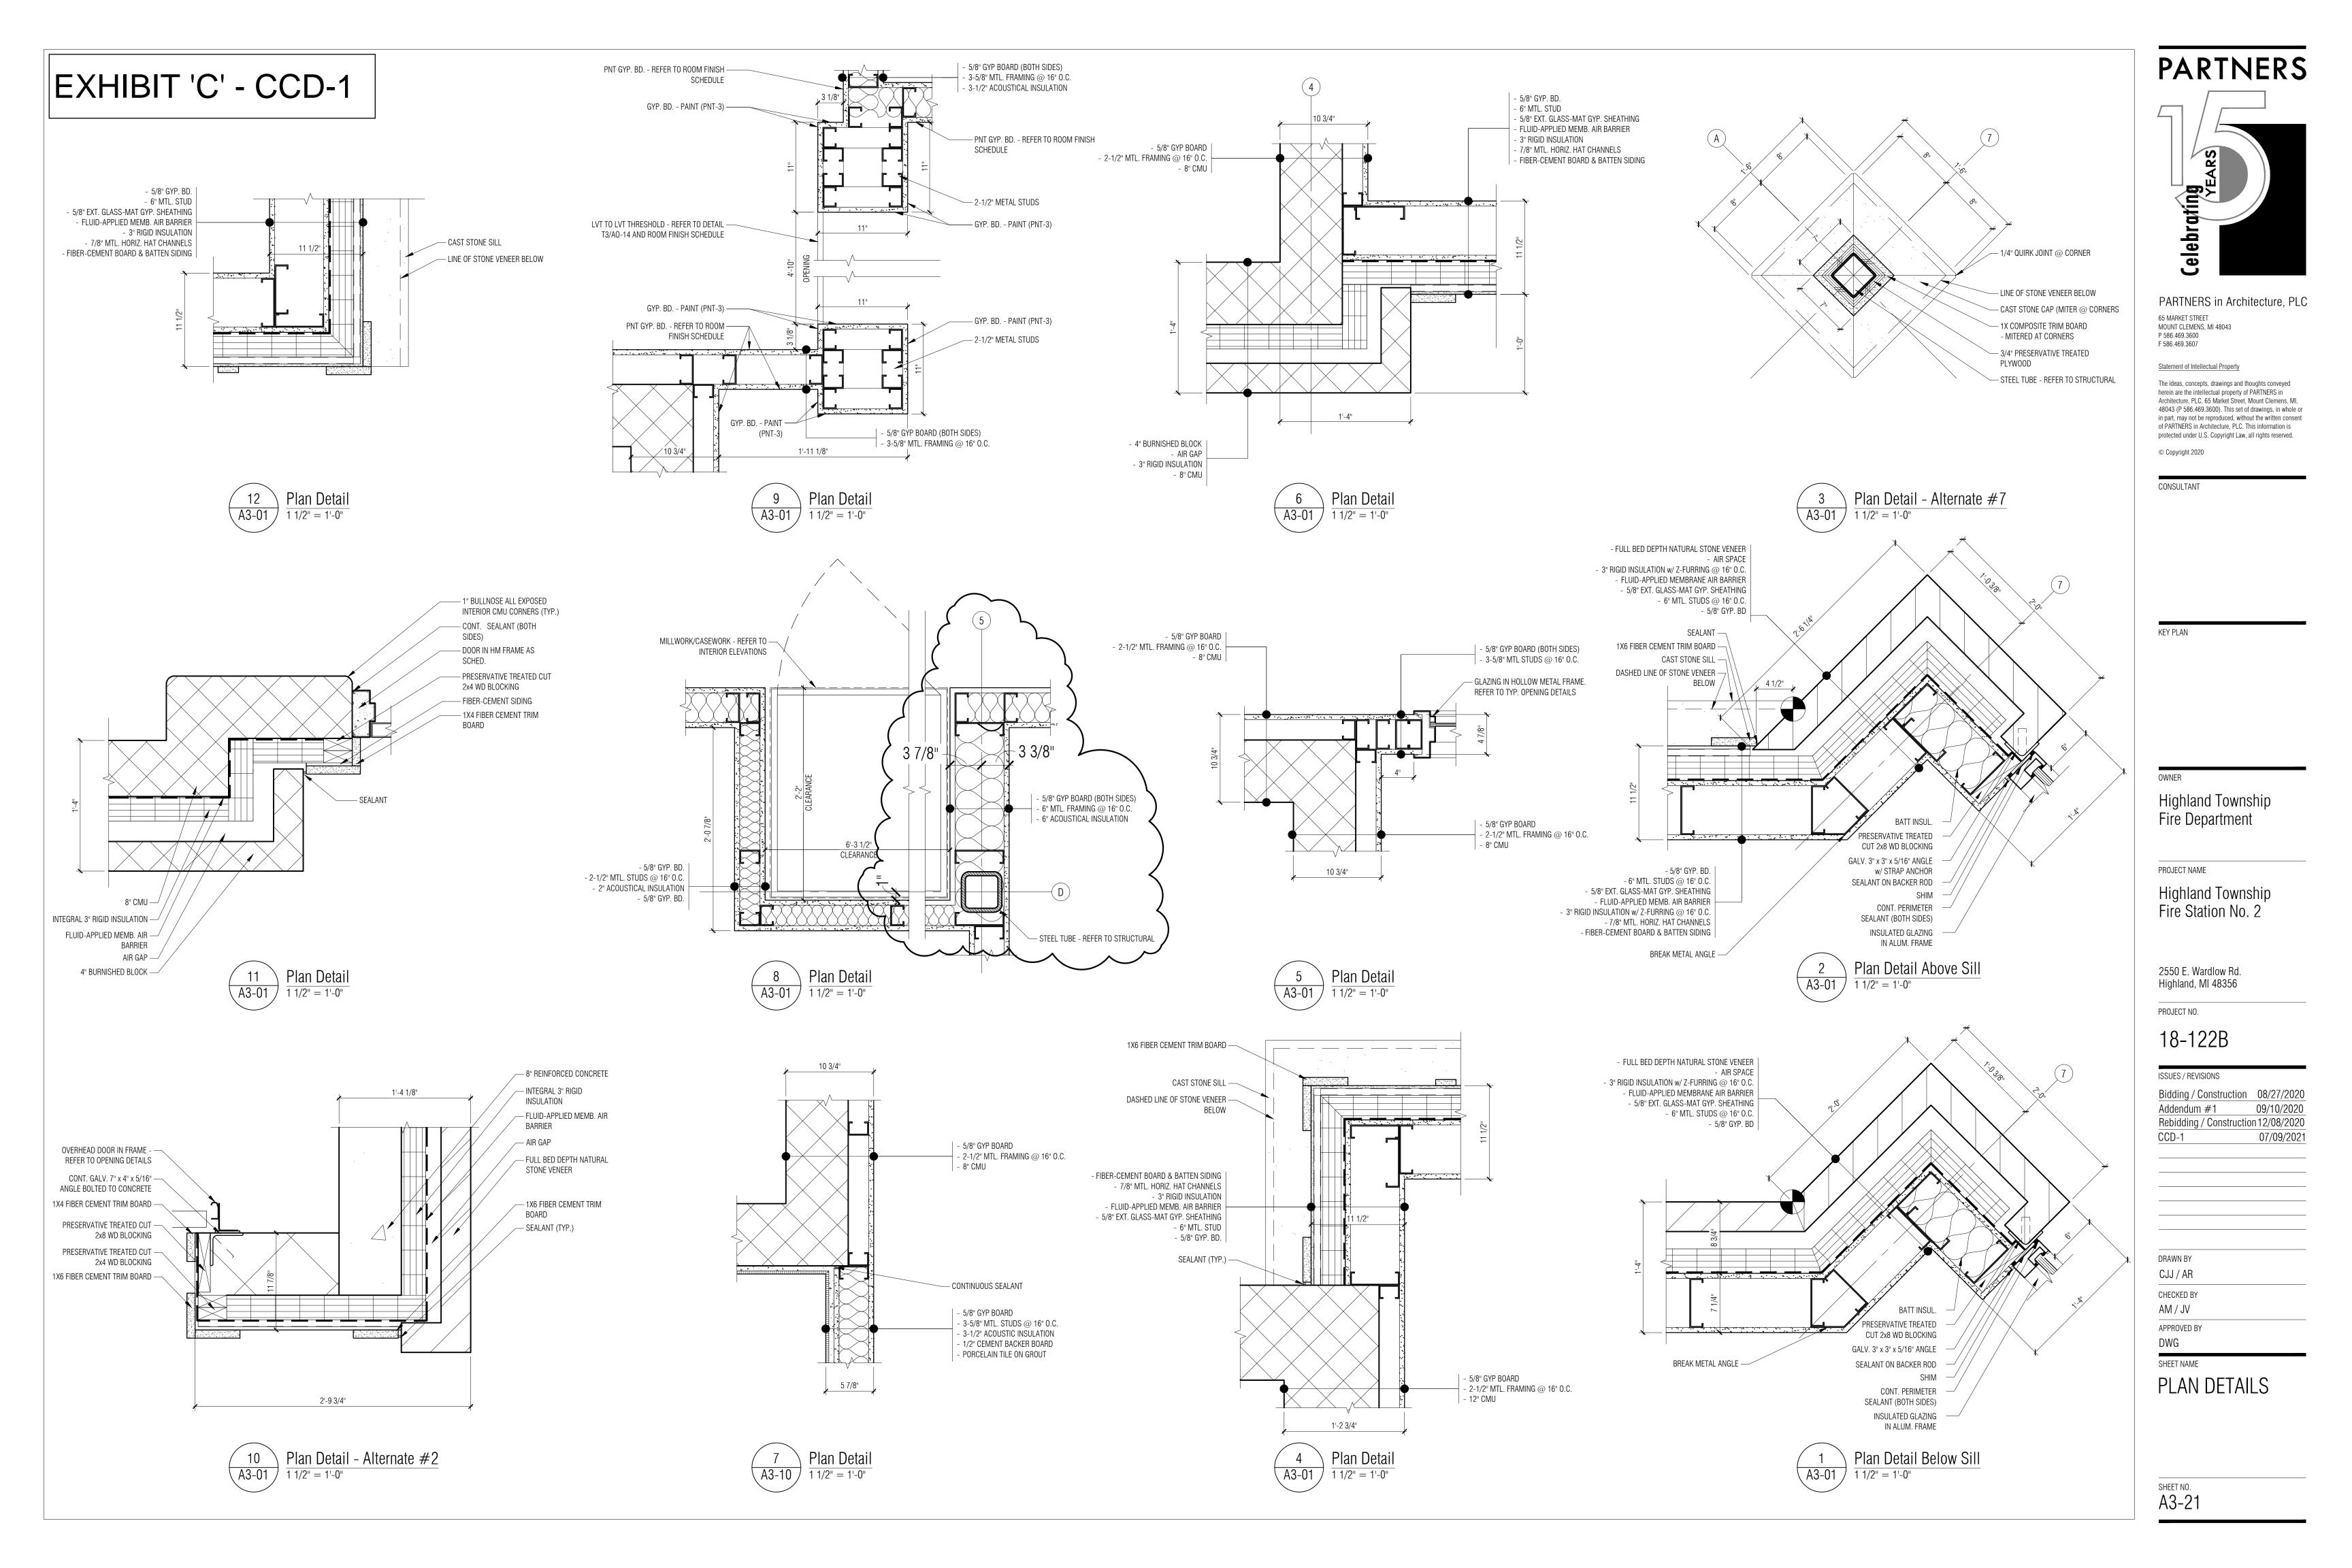




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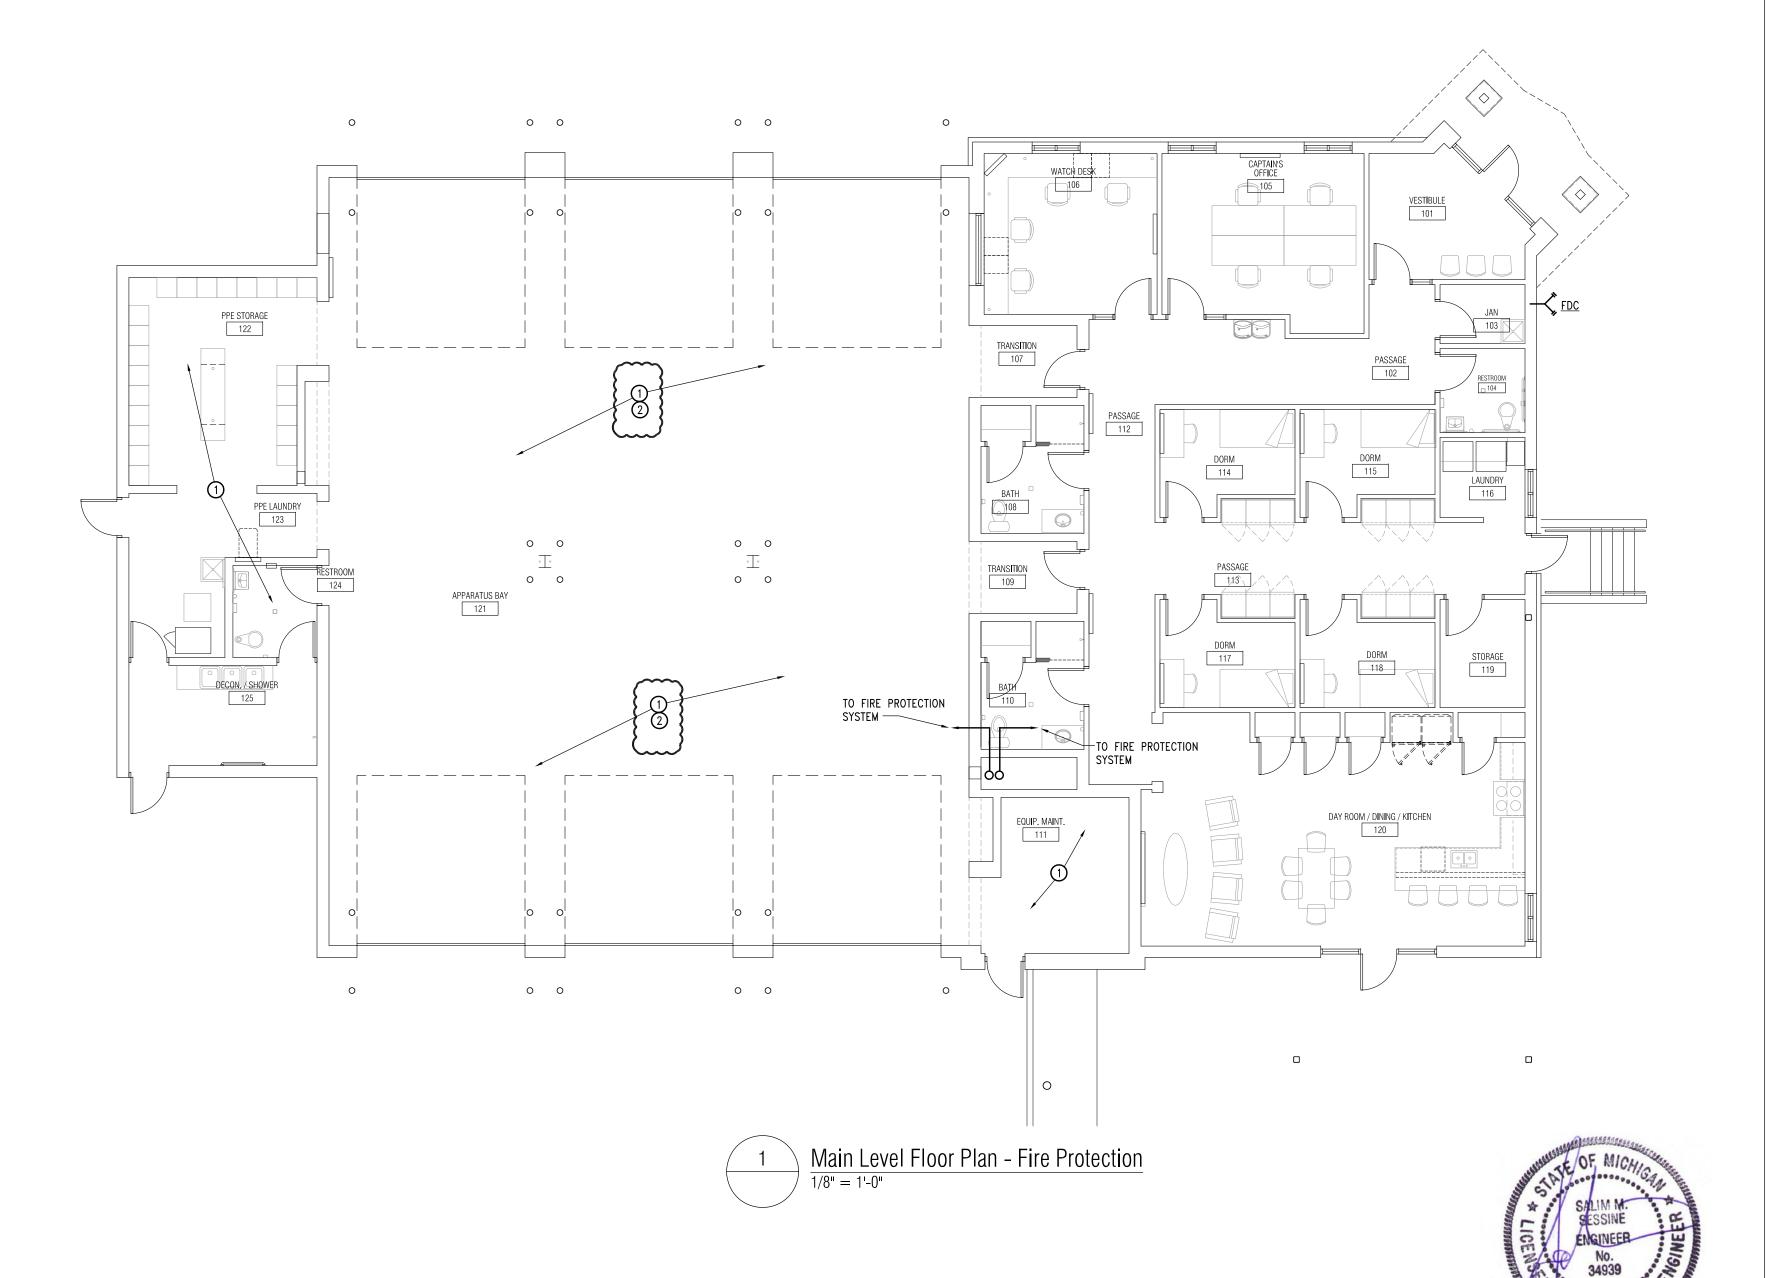
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07/09/2021


# FIRE PROTECTION GENERAL NOTES:

- A. COORDINATE ALL WORK WITH OTHER TRADES.
- B. BUILDING IS TO BE FULLY SPRINKLED. SPRINKLER SYSTEM DESIGN AND LAYOUT TO BE A HYDRAULICALLY DESIGNED SYSTEM IN COMPLIANCE WITH THE MICHIGAN BUILDING CODE, NFPA 13, OWNER'S UNDERWRITER AND AUTHORITY HAVING JURISDICTION. REFER TO SPECIFICATION FOR ADDITIONAL INFORMATION.
- C. DO NOT SCALE THE PLUMBING AND FIRE PROTECTION DRAWINGS FOR LOCATION OF CEILING MOUNTED SPRINKLER HEADS. ALL CEILING MOUNTED HEADS SHALL BE COORDINATED WITH ARCHITECTURAL CEILING PLANS, UNLESS OTHERWISE NOTED.
- D. ALL SPRINKLERS LOCATED IN LAY—IN CEILINGS SHALL BE CENTERED IN THE MIDDLE OF THE CEILING TILES UNLESS OTHERWISE INDICATED ON THE ARCHITECTURAL SERIES DRAWINGS.
- E. SPRINKLER HEADS IN AREAS WITH CEILINGS TO BE SIMILAR TO TYCO ROYAL FLUSH II UNLESS OTHERWISE INDICATED ON THE
- F. PRIOR TO START OF ANY CONSTRUCTION, SUBMIT DRAWINGS TO OWNER'S INSURANCE COMPANY AND LOCAL AUTHORITY HAVING JURISDICTION FOR APPROVAL.
- G. ALTHOUGH SOME PREFERRED LOCATIONS OF MAINS ARE SHOWN ADDITIONAL MAINS MAY BE REQUIRED.
- FIRE PROTECTION KEY NOTES:
- ALL FIRE PROTECTION PIPING IN EXPOSED AREAS TO BE ON LINEAR, EQUALLY SPACED, GRID PATTERN AND TO BE PAINTED RED. REFER TO ARCHITECTURAL CONSTRUCTION DOCUMENTS FOR FURTHER INFORMATION.
- 2 COORDINATE FIRE PROTECTION LINE WITH INFRARED HEATER.



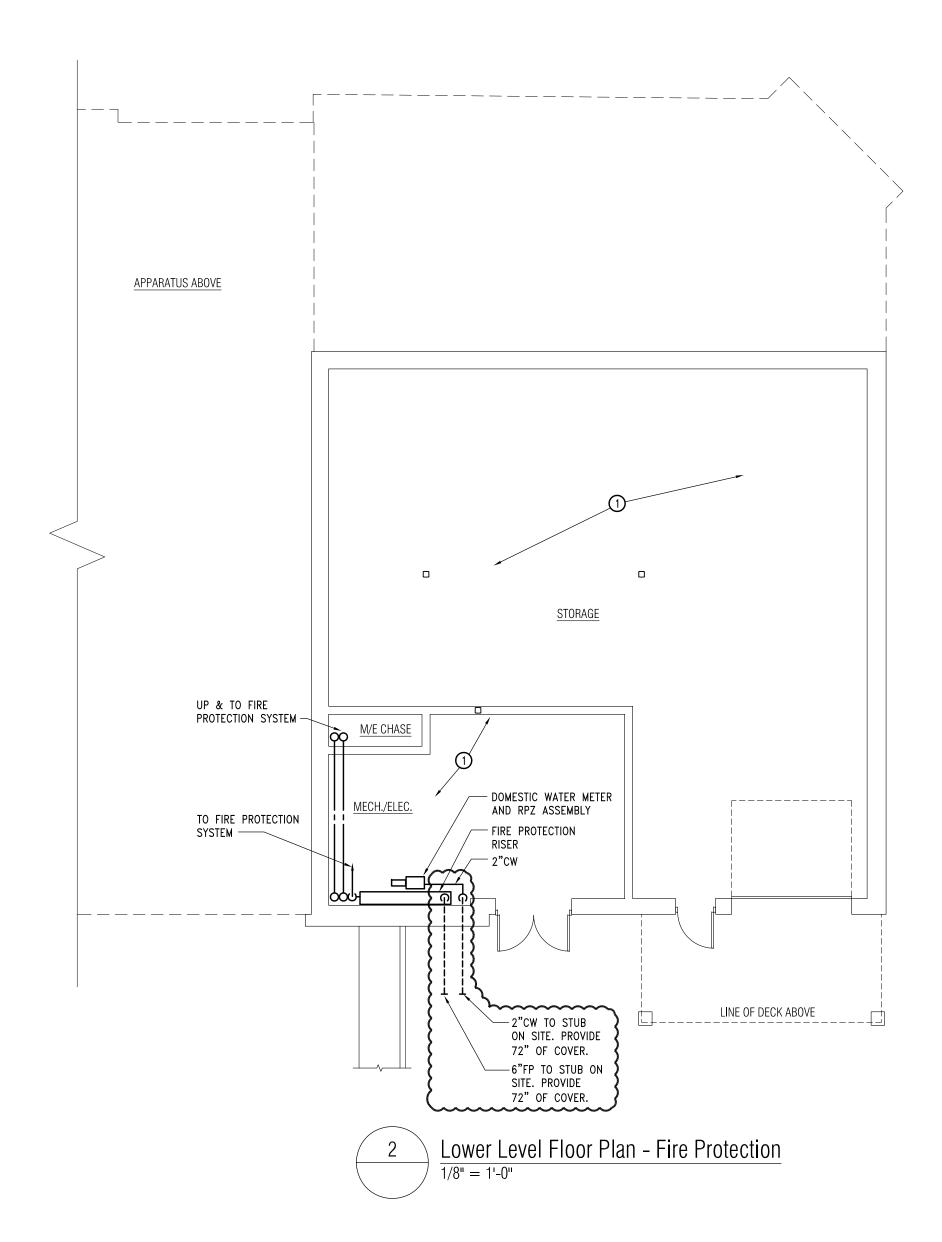

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KEV DLAN

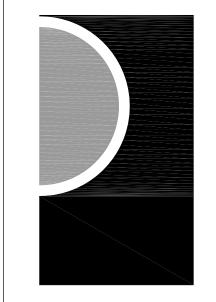OWN

Highland Township Fire Department

PROJECT NAME

Highland Township Fire Station No. 2

2550 E. Wardlow Rd. Highland, MI 48356

PROJECT NO.

18-122B

ISSUES / REVISIONS	
SCHEMATIC DESIGN	01-28-2020
90% CD	07-31-2020
100% CONSTRUCTION DOCUMENT	08-27-2020
ADDENDUM #1	09-09-2020
RE-BIDDING / CONSTRUCTION	12-08-2020
CCD-1	07-13-2021

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/18

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MS

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SHEET NAME

FLOOR PLANS - FIRE PROTECTION


SHEET NO.
FP0-01


KEY NOTES:

1) ALTERNATE #4: PROVIDE ROUGH-IN ONLY.


GENERAL NOTES:

1. FS-1: FLOOR SINK BY ZURN Z-1900, 12×12 SANI-FLOR RECEPTOR,
6"SUMP DEPTH. CAST IRON BODY AND SQUARE SLOTTED LIGHT
DUTY GRATE WITH WHITE ACID RESISTING POCELAIN ENAMEL
INTERIOR AND TOP. COMBINATION INVERTIBLE MEMBRANE CLAMP.
COMPLETE WITH WHITE ABS ANTI SPLASH INTERIOR BOTTOM DOME
STRAINER

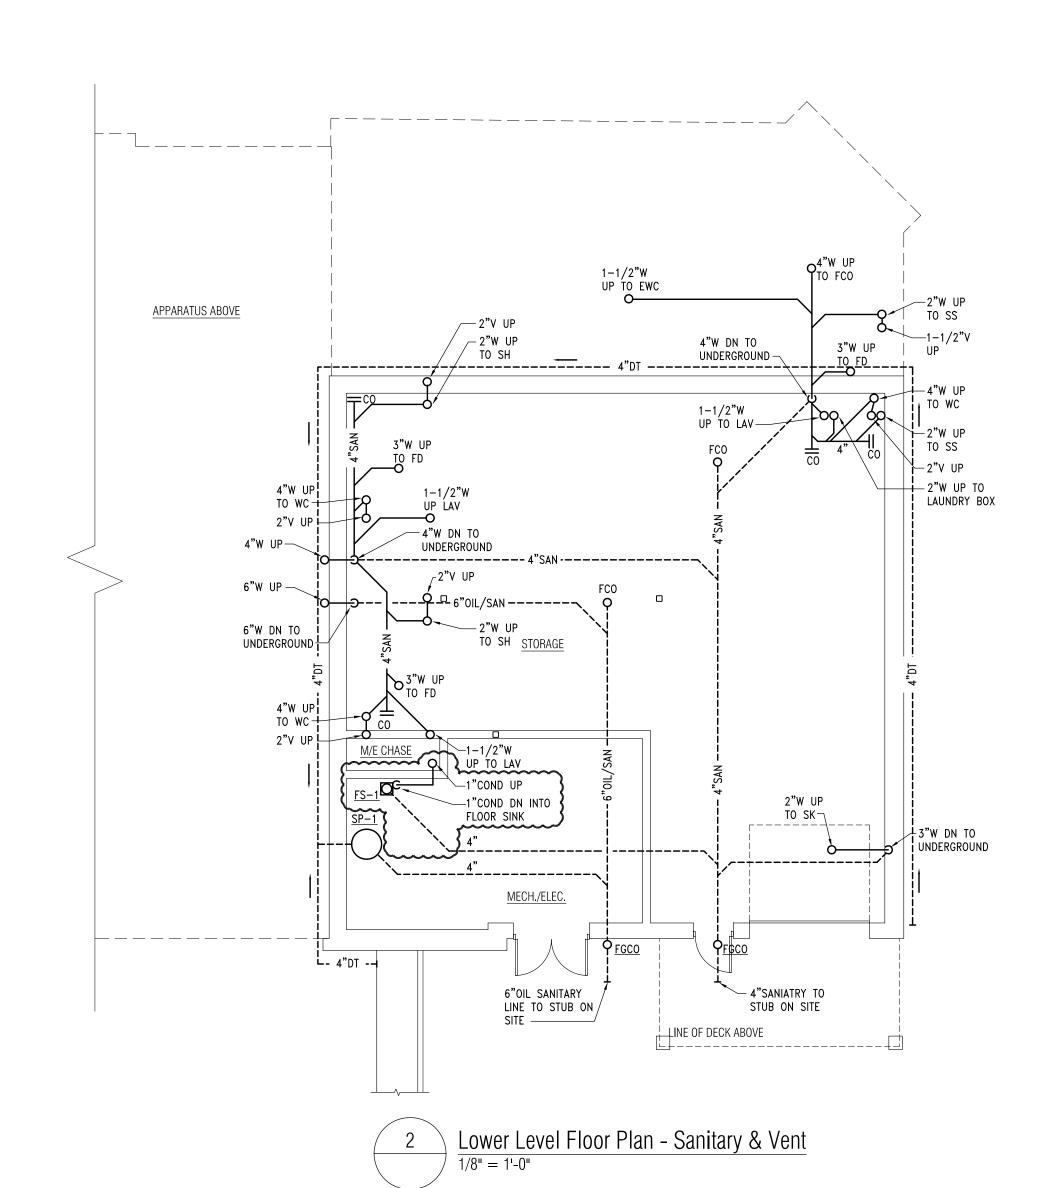

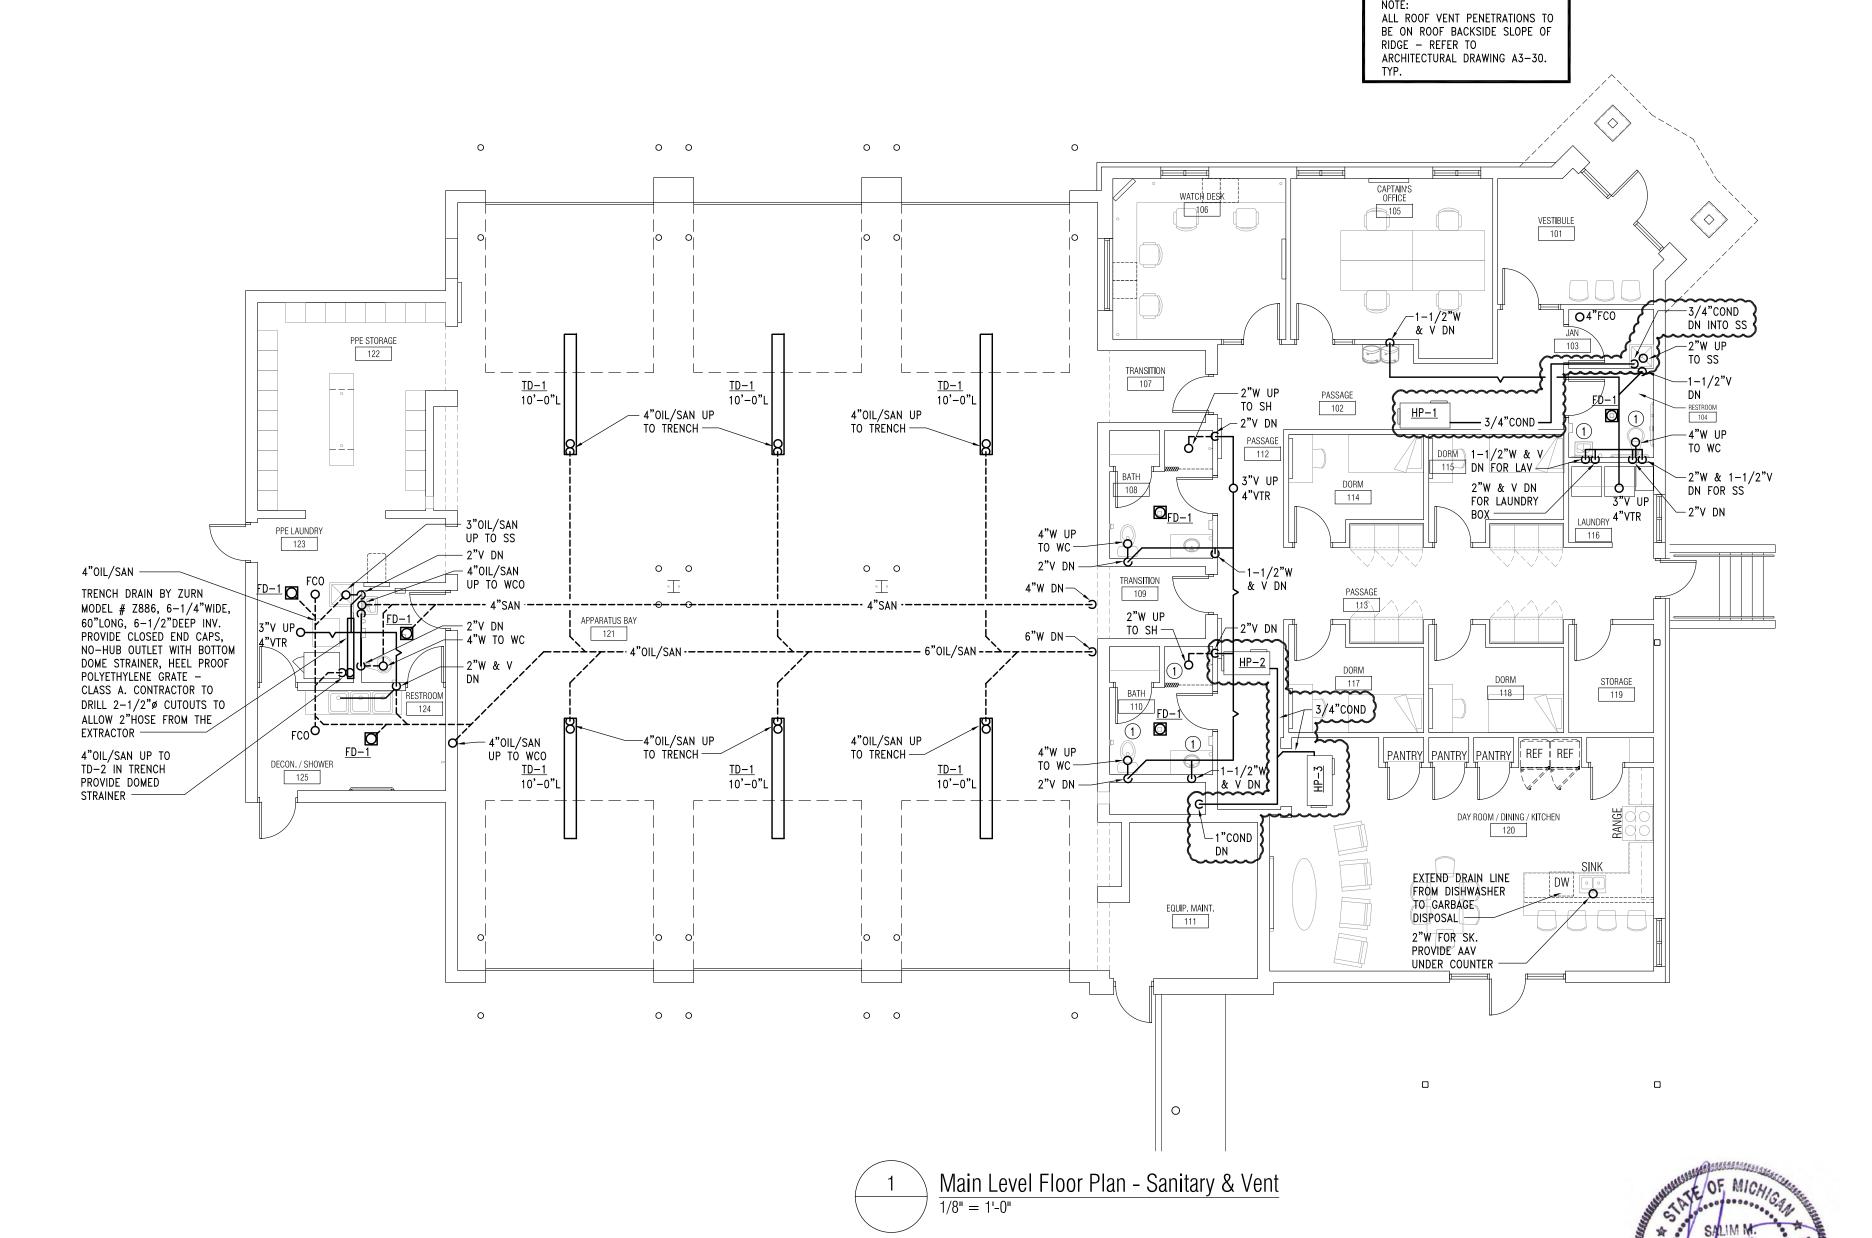

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KEY PLAN

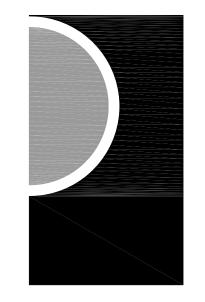OWNE

Highland Township Fire Department

PROJECT NAME

Highland Township Fire Station No. 2

2550 E. Wardlow Rd. Highland, MI 48356

PROJECT NO.

18-122B

01-28-202
07-31-202
08-27-202
09-09-202
12-08-202
07-13-202

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SHEET NAME


FLOOR PLANS -SANITARY & VENT


SHEET NO. M1-01

- **NEW WORK KEY NOTES:**
- 1) EXTEND DOMESTIC WATER IN WALL TO SINK. KEEP TIGHT TO INTERIOR OF WALL. PROVIDE MINIMUM 2" RIGID INSULATION BEHIND PIPE AN SEAL TO STUD AND ALL SEAMS.
- EXTEND 1/2"HOT WATER TO DISHWASHER. PROVIDE FINAL CONNECTION PER MANUFACTURERS RECOMMENDATION.
- 3 ½" COLD WATER DOWN TO REFRIGERATOR, PROVIDE ONE BACKFLOW PREVENTER APOLLO MODEL #4C-100 SERIES PER COLD WATER DROP ABOVE CEILING.
- 4) NOT USED
- (5) ALTERNATE #4: PROVIDE ROUGH—IN ONLY.

**GENERAL NOTES:** 

A. COORDINATE ALL WORK WITH OTHER TRADES.

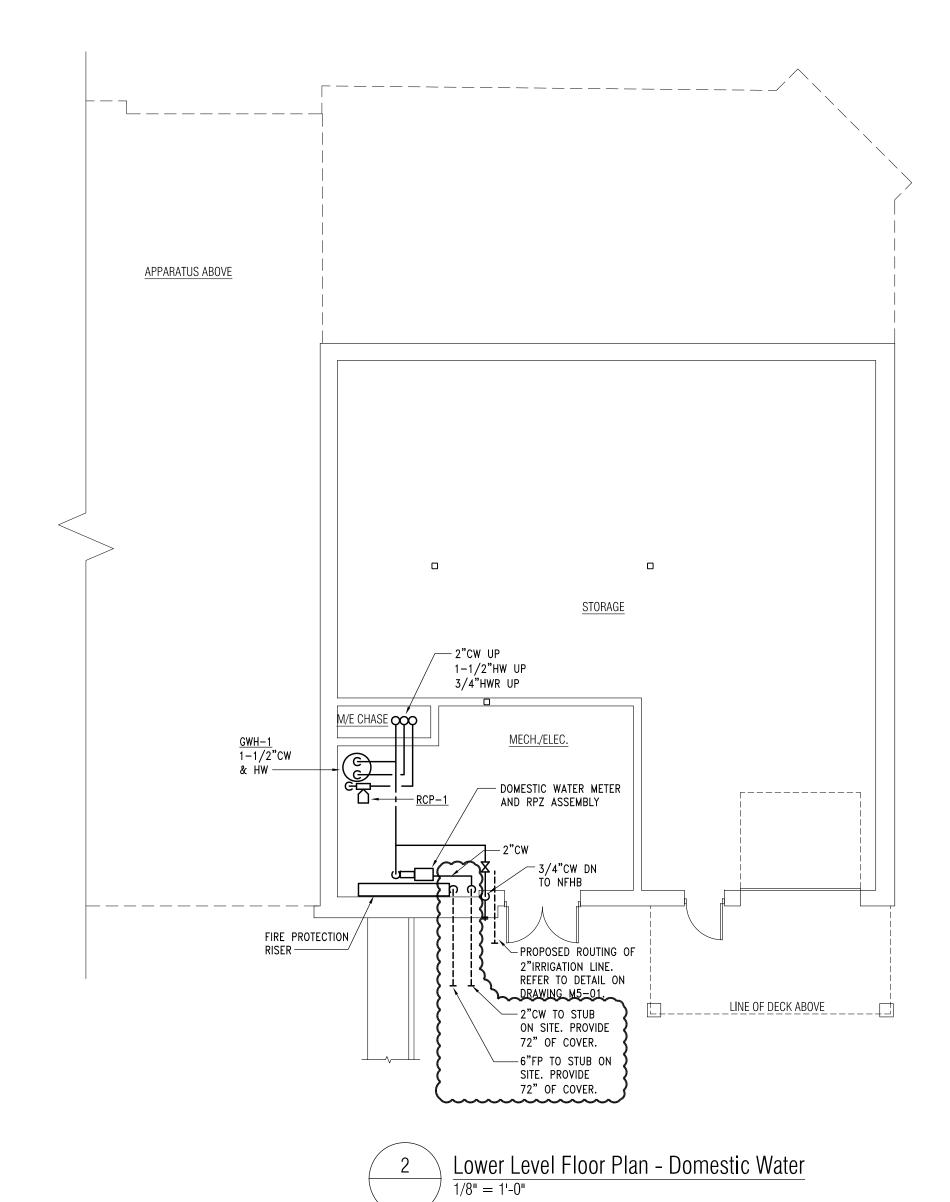


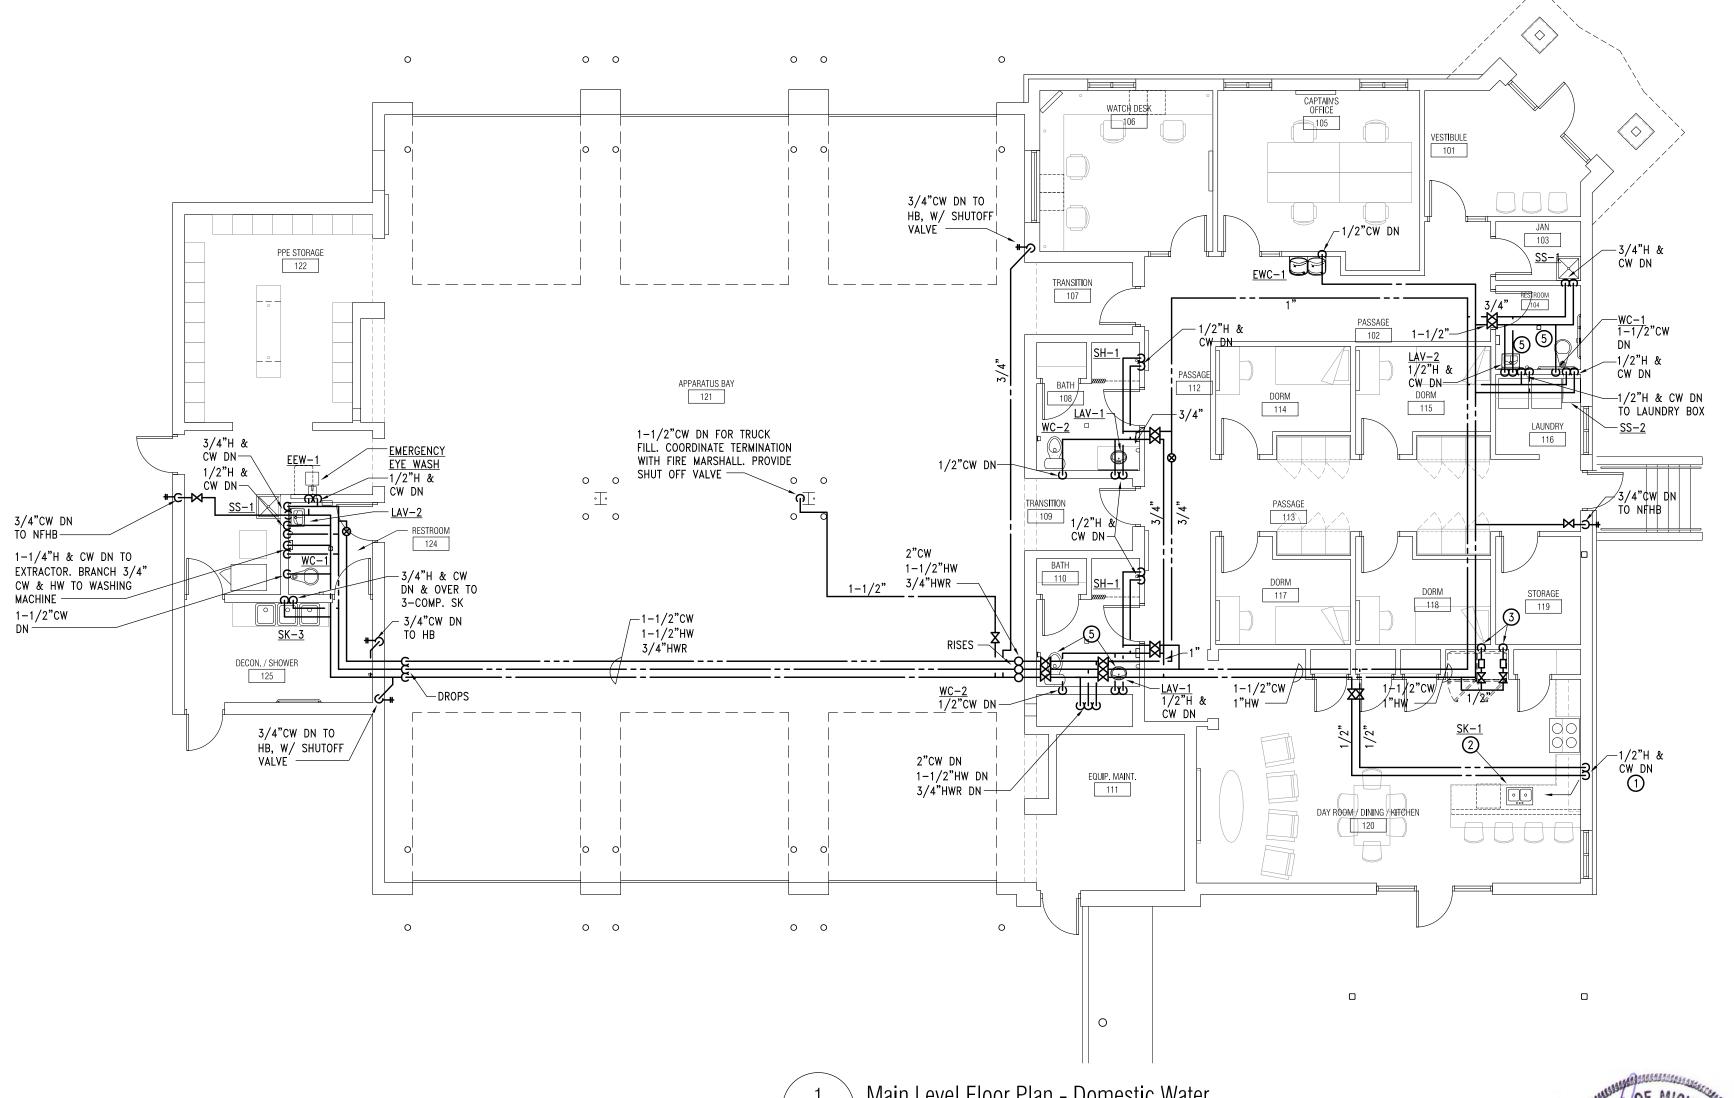





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P. 586, 469, 3600
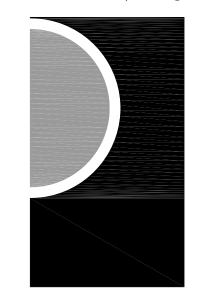
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OWNER

Highland Township Fire Department

PROJECT NAME

Highland Township Fire Station No. 2

2550 E. Wardlow Rd. Highland, MI 48356

PROJECT NO.

18-122B

ISSUES / REVISIONS	
SCHEMATIC DESIGN	01-28-202
90% CD	07-31-202
100% CONSTRUCTION DOCUMENT	08-27-202
ADDENDUM #1	09-09-202
RE-BIDDING / CONSTRUCTION	12-08-202
WRC PERMIT	06-03-202
CCD-1	07-13-202

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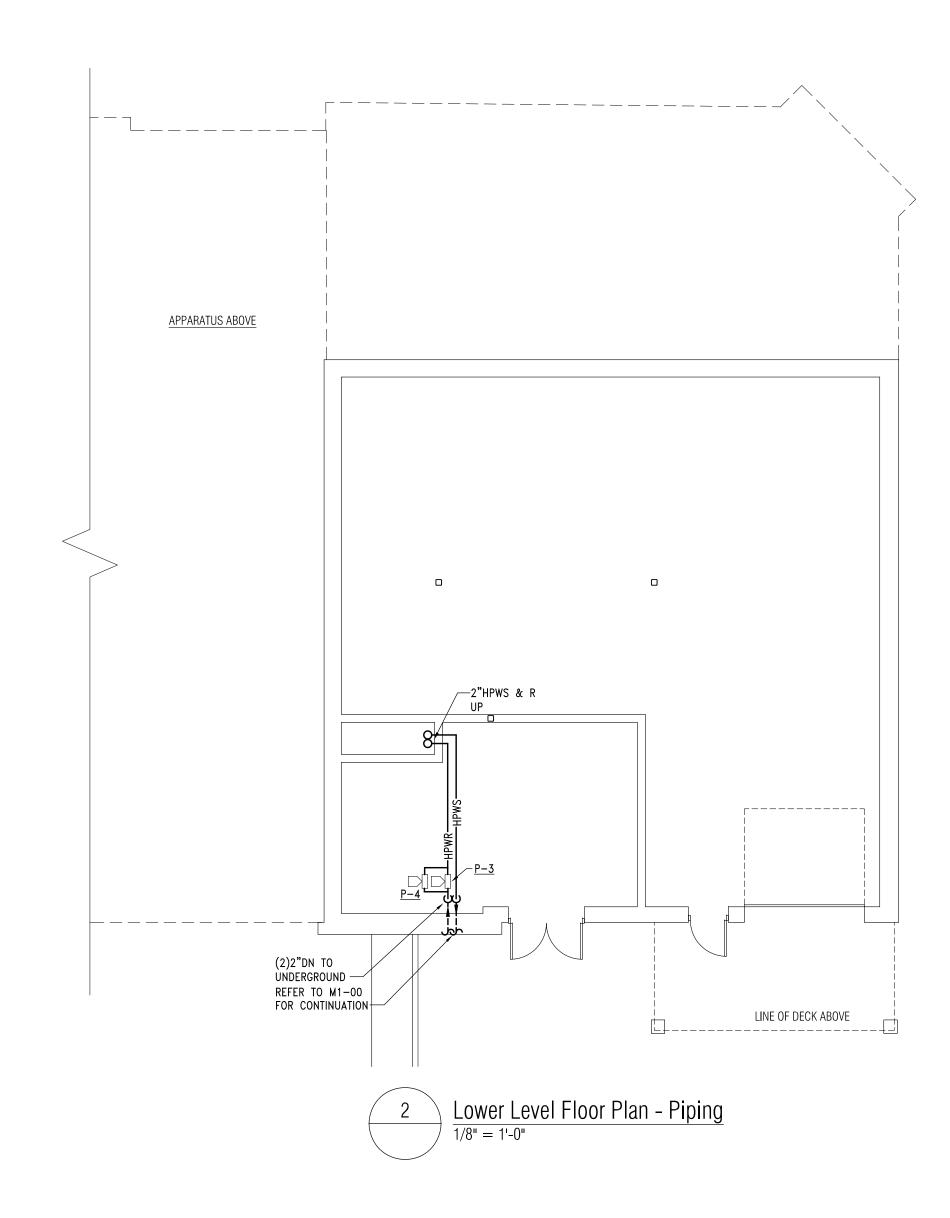
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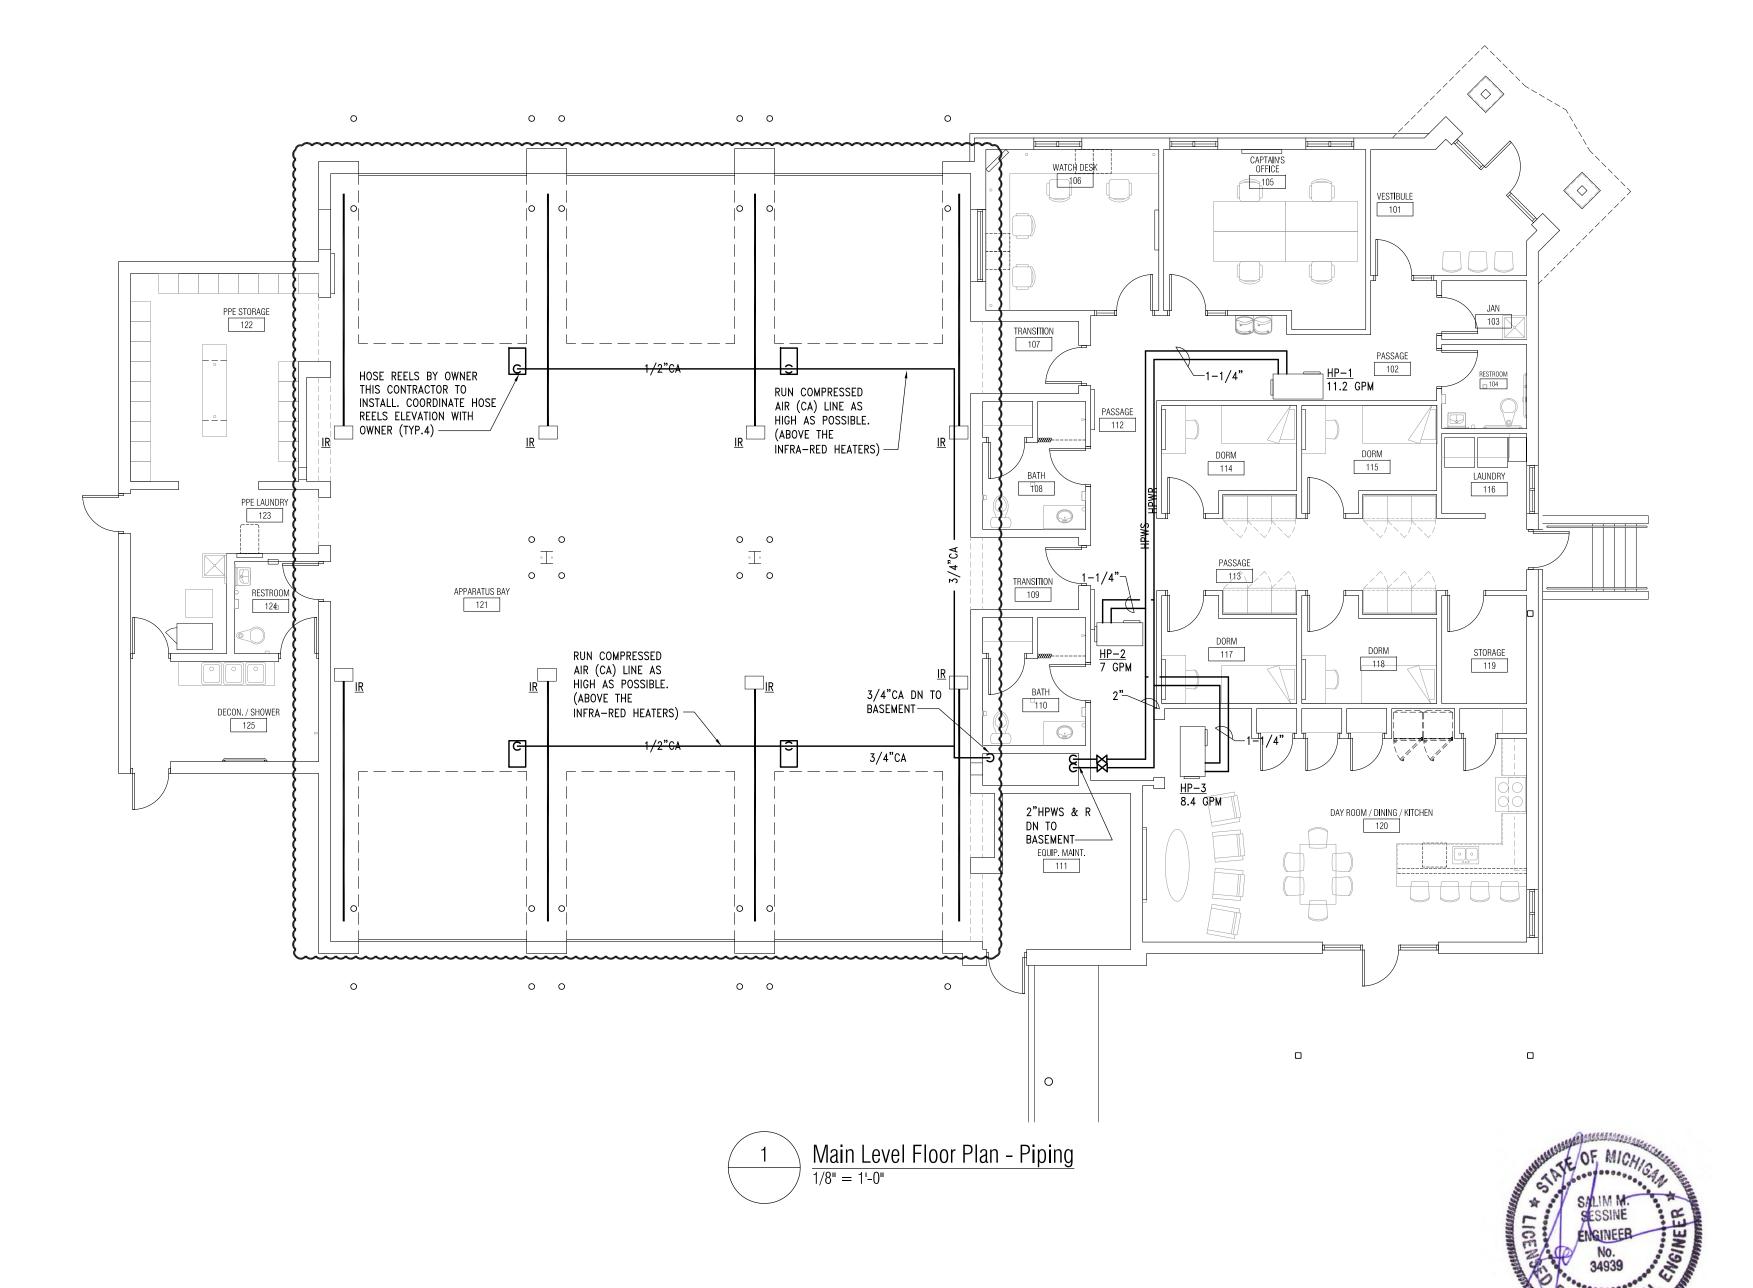
APPROVED BY

MS SHEET NAME


FLOOR PLANS -DOMESTIC WATER

SHEET NO.
M1-02





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KEY PLAN

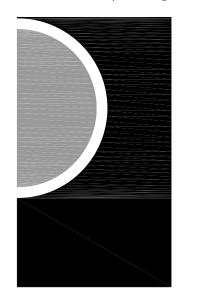OWNE

Highland Township Fire Department

PROJECT NAME

Highland Township Fire Station No. 2

2550 E. Wardlow Rd. Highland, MI 48356

PROJECT NO.

18-122B

ISSUES / REVISIONS	
SCHEMATIC DESIGN	01-28-202
90% CD	07-31-202
100% CONSTRUCTION DOCUMENT	08-27-202
ADDENDUM #1	09-09-202
RE-BIDDING / CONSTRUCTION	12-08-202
CCD-1	07-13-202

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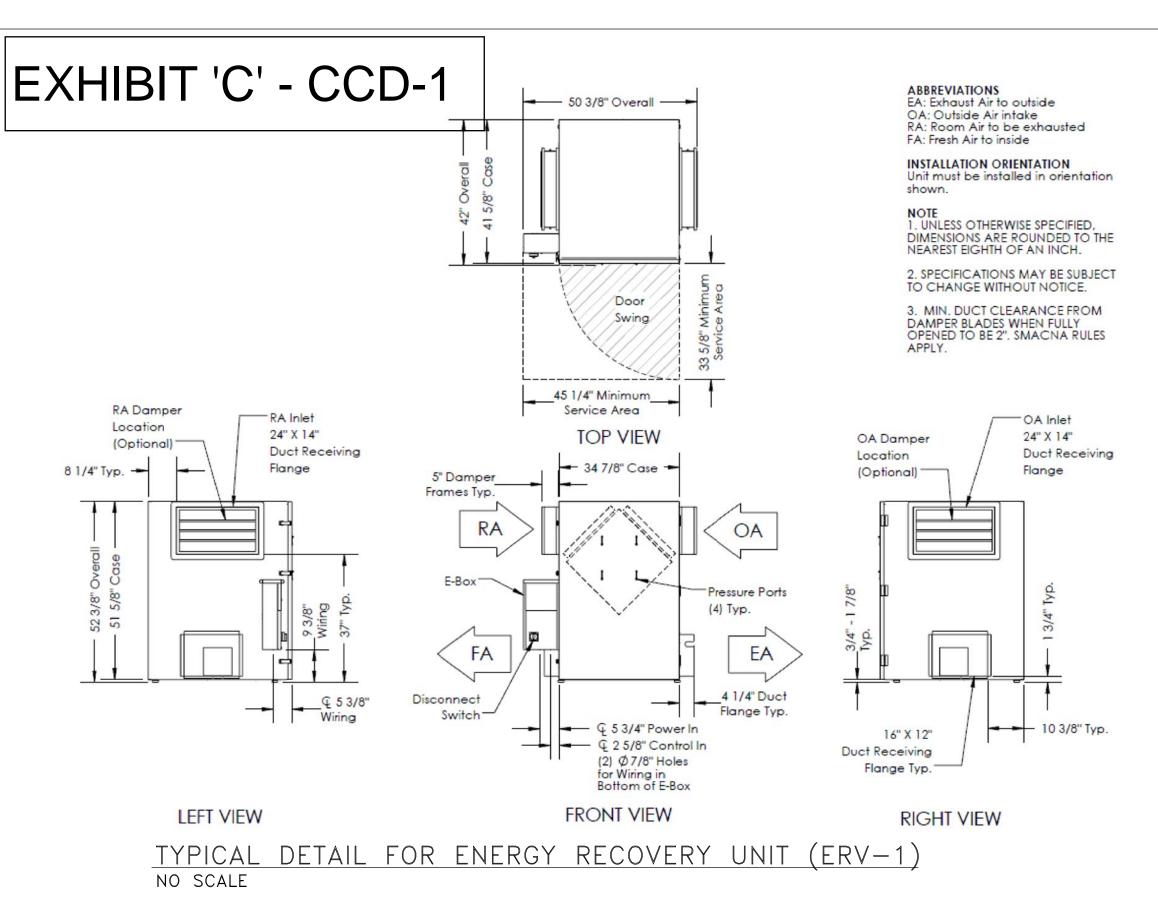
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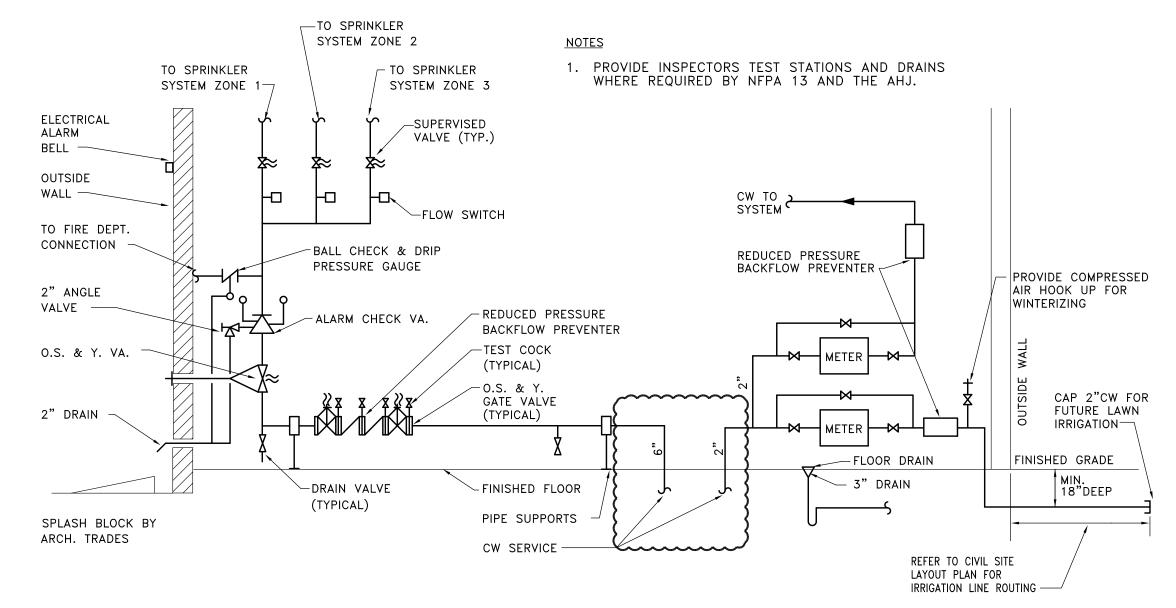
SHEET NAME

FLOOR PLANS -PIPING


SHEET NO.
M3-01




DIRT LEG -




TYPICAL AUTOMATIC SPRINKLER RISER & WATER METER DIAGRAM NO SCALE

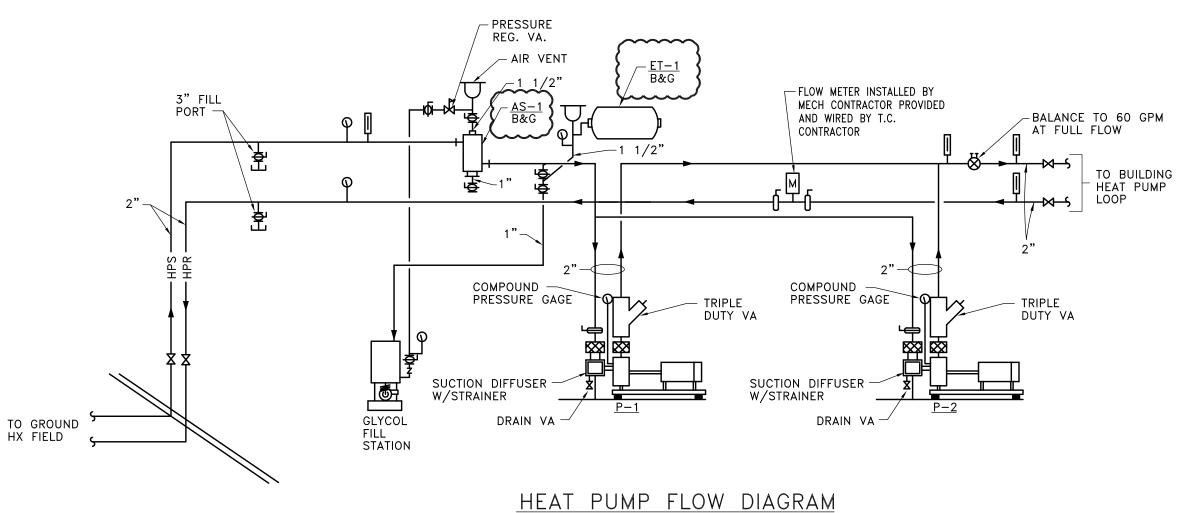


NO SCALE

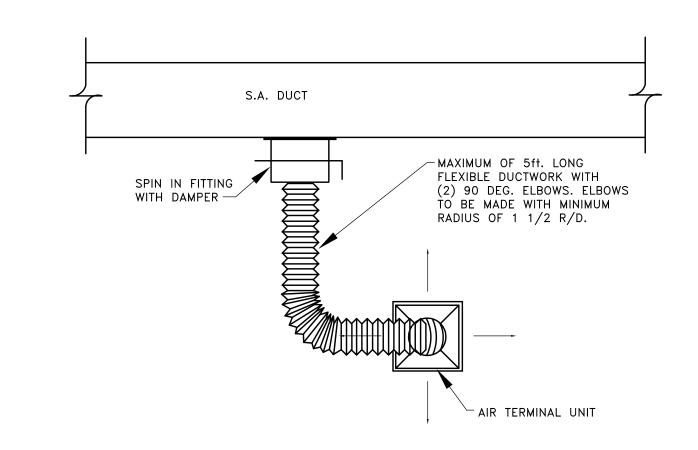


FLEXIBLE DUCT CONNECTION DETAIL NO SCALE

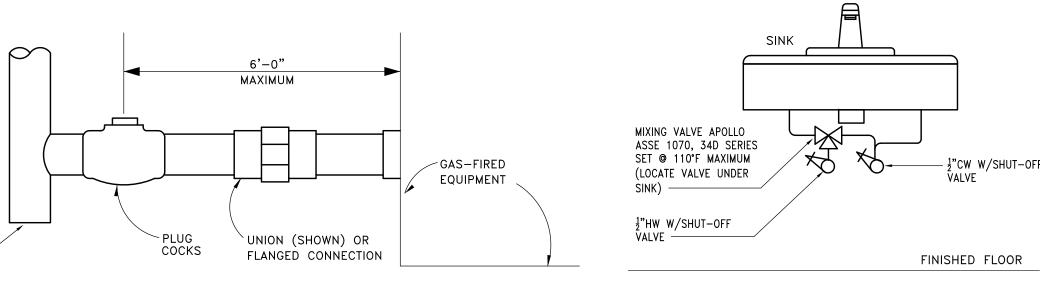


TYPICAL GAS PIPING CONNECTION NO SCALE

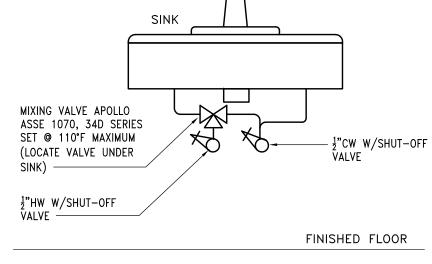


MIXING VALVE PIPING DETAIL NO SCALE

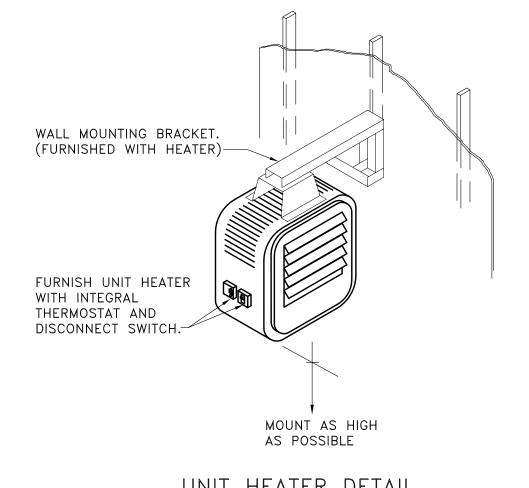



UNIT HEATER DETAIL NO SCALE

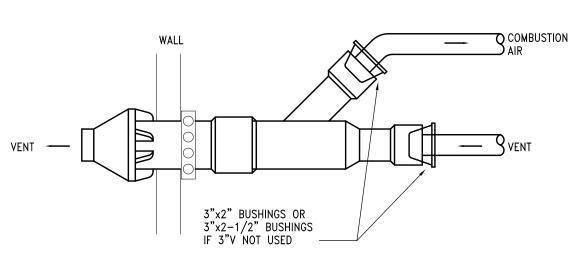


CONCENTRIC VENT KIT (WALL INSTALLATION) NO SCALE

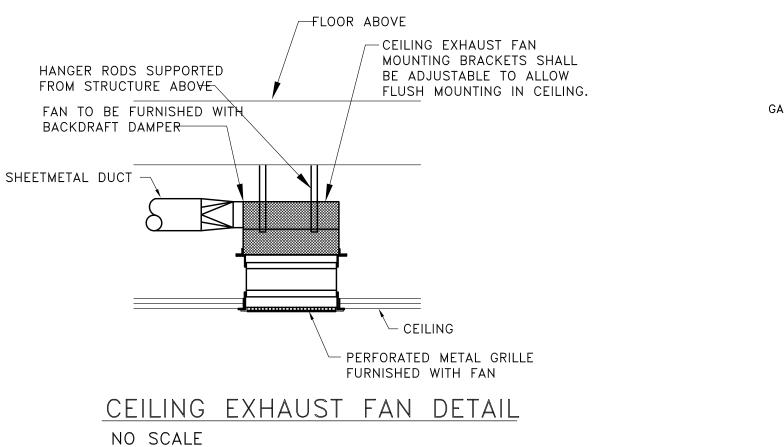

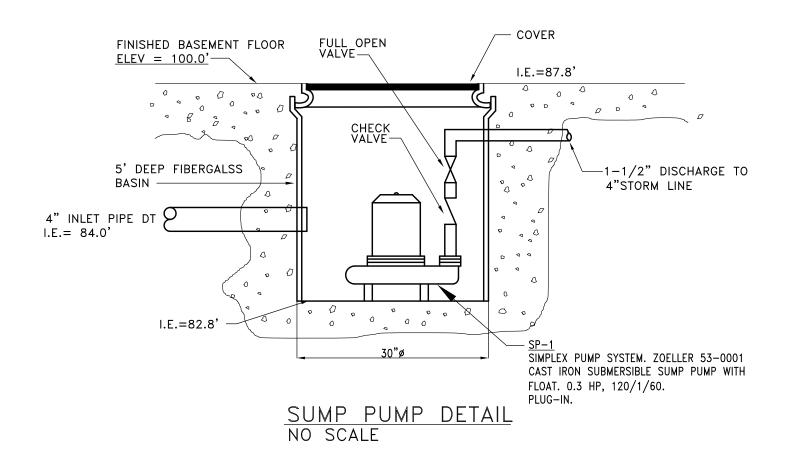


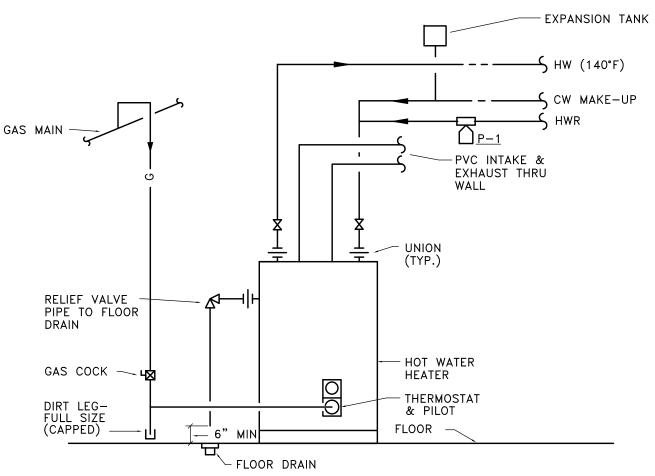


DOMESTIC WATER HEATER PIPING SCHEMATIC NO SCALE

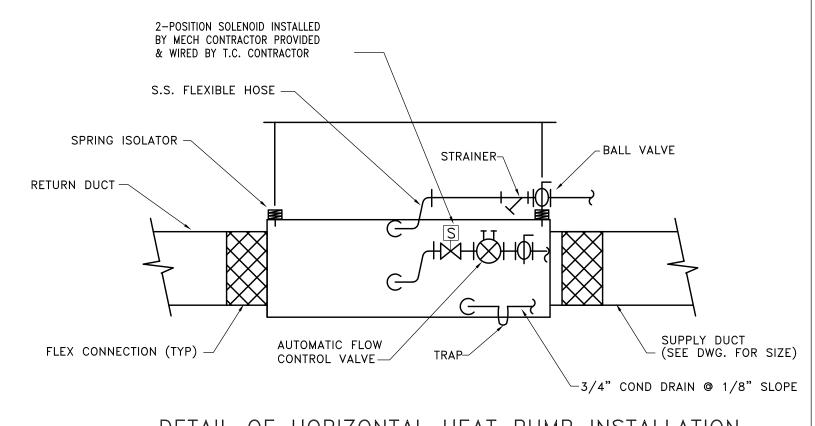

DETAIL OF HORIZONTAL HEAT PUMP INSTALLATION NO SCALE

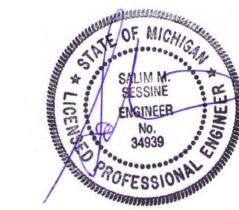

# **PARTNERS**

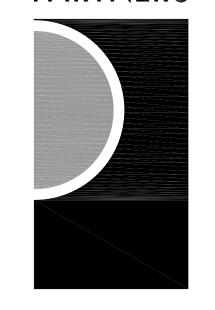

PARTNERS in Architecture, PLC 65 MARKET STREET

MOUNT CLEMENS, MI 48043 P 586.469.3600 F 586.469.3607

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KEY PLAN

Highland Township Fire Department

PROJECT NAME

Highland Township Fire Station No. 2

2550 E. Wardlow Rd.

Highland, MI 48356

PROJECT NO.

18-122B

ISSUES / REVISIONS	
SCHEMATIC DESIGN	01-28-2020
90% CD	07-31-2020
100% CONSTRUCTION DOC	UMENT 08-27-2020

CCD-1	07-13-2021

MERBIPDIRMOT/ CONSTRUCTION 08-08-2020

DRAWN BY

CHECKED BY

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SHEET NAME **MECHANICAL DETAILS** 

M5-01

# **KEYED POWER NOTES:**

- EXACT LOCATION AND REQUIREMENTS FOR EQUIPMENT TO BE COORDINATED WITH EQUIPMENT VENDOR, APPROVED SUBMITTALS AND NAMEPLATE DATA. INFORMATION INDICATED ON THESE PLANS IS FOR REFERENCE ONLY.
- 2 ALL RECEPTACLES LOCATED WITHIN 6'-0" OF A WATER SOURCE AND ALL IN THE KITCHENS SHALL BE GFR TYPE. PROVIDE GFR RECEPTACLES REGARDLESS OF SYMBOL USED ON PLAN FOR THESE LOCATIONS. FOR LOCATIONS THAT ARE NOT ACCESSIBLE, LOCATE BLANK PLATE GFR ABOVE THE RECEPTACLE AT +44"AFF OR NEAR ROOM WALL SWITCH(ES) OR PROVIDE GFCI BRANCH BREAKERS IN PANELBOARDS AS DIRECTED BY OWNER TO COMPLY WITH NEC 210.8.
- DUPLEX RECEPTACLES AND DATA OUTLETS FOR FLAT SCREEN TV SHALL BE MOUNTED AT 5'-0"AFF UNLESS OTHERWISE NOTED, COORDINATE WITH ARCHITECT/OWNER FOR EXACT QUANTITIES, LOCATIONS AND MOUNTING HEIGHTS.
- $\langle 4 \rangle$  EXACT LOCATIONS FOR ALL FLOOR OUTLETS TO BE COORDINATED WITH ARCHITECT/OWNER.
- $\langle 5 \rangle$  NOT USED. 6 COORDINATE WITH MECHANICAL FOR EXACT REQUIREMENTS FOR FIRE PROTECTION SYSTEM,
- INCLUDING NUMBER OF FLOW/TAMPER SWITCHES.
- PROVIDE POWER FOR DRY PIPE SYSTEM COMPRESSOR, COORDINATE EXACT LOCATION AND REQUIREMENTS WITH FIRE SUPPRESSION CONTRACTOR. LOCATION INDICATED ON PLAN IS FOR
- 8 EXACT LOCATIONS FOR FIRE ALARM CONTROL AND ANNUNCIATOR PANELS AND SECURITY SYSTEM PANELS TO BE COORDINATED WITH ARCHITECT/OWNER. PROVIDE FLUSH MOUNTING FOR ALL, UNLESS LOCATED IN UNFINISHED SPACES.
- 9 EXACT LOCATIONS FOR ALL ELECTRICAL EQUIPMENT TO BE COORDINATED, REFER TO GENERAL NOTE-F.
- 10 INDOOR AC UNIT IS FED FROM THE OUTDOOR ACCU UNIT, COORDINATE WITH MECHANICAL FOR COMPLETE INSTALLATION REQUIREME NTS, INCLUDING INTERWIRING OF THE UNIT.
- FOR ALL CARD READERS PROVIDE DOUBLE GANG J-BOX WITH SINGLE MUD RING @48" AFF FOR CARD READER, RUN 1/2"C FROM CARD READER OR STRIKE ACTUATOR FOR LOW VOLTAGE WIRING. PROVIDE 120V POWER IN THE CEILING FOR STRIKE AS INDICATED, FOR MORE DETAILS REFER TO SHEET E5-01. ALSO PROVIDE REQUIRED WIRING FOR INTERCOM REMOTE UNLOCK SYSTEM COORDINATE WITH DOOR INSTALLER.

  REFER TO ARCHITECTURAL PLANS AND DOOR HARDWARE SCHEDULES FOR EXACT LOCATIONS AND REQUIREMENTS. COORDINATE ALL WORK WITH ARCHITECT AND SECURILTY/ACCESS CONTROL SYSTEM PROVIDER
- \$\langle 12 \rangle Provide red mushroom emergency power on/off button and all required branch circuit TRANSFORMER, CONTACTORS, BOXES ETC. TO SHUT-OFF GAS RANGE SOLENOID VALVE, INTERLOCK GAS SOLENOID SHUT-OFF VALVE WITH FIRE ALARM SYSTEM, COORDINATE ALL REQUIREMENTS.
- FOR ALL ELECTRICAL DEVICES AT MILLWORK COORDINATE EXACT LOCATIONS, ROUTING OF CONDUITS, ETC. WITH ARCHITECT AND MILLWORK VENDOR.
- $\langle 14 \rangle$  ALL INSTALLATION IN THE DECON/SHOWER ROOM TO BE NEMA 3R WET LOCATION RATED.

BEST MOUNTING LOCATIONS BETWEEN BAYS.

- (15) PROVIDE GFCI BRANCH CIRCUIT FOR LOCKERS, WIRE 4-5 LOCKERS TO ONE DEDICATED 20A/1P BRANCH CIRCUIT.
- (16) PROVIDE BUZZER AT ENTRY DOOR, CONNECT TO PA SYSTEM, EXACT LOCATIONS AND DESIGNATED ALERT LOCATION TO BE COORDINATED WITH ARCHITECT/OWNER.
- $\langle 17 \rangle$  EXACT LOCATIONS AND REQUIREMENTS FOR PA AND RADIO SYSTEM TO BE COORDINATED, REFER TO
- GENERAL NOTE-M THIS SHEET. (18) COORDINATE PLACEMENT OF JB'S FOR ELECTRICAL REEL IN APPARATUS BAY TO ALLOW FOR THEIR

\_\_\_\_\_


# GENERAL POWER NOTES

WATCH DESK

- A. REFER TO SHEET E.001 FOR ELECTRICAL LEGEND.
- B. PROVIDE COMPLETE ADDRESSABLE FIRE ALARM SYSTEM FOR THE BUILDING. FIRE ALARM SYSTEM SHALL INCLUDE ALL CONTROL, MONITORING, POWER SUPPLIES, INITIATING DEVICES, INDICATING APPLIANCES, CONTROL MODULES AND WIRING AS REQUIRED BY AUTHORITIES HAVING JURISDICTION FOR AN APPROVED INSTALLATION, REFER TO SPECIFICATIONS. SYSTEM SHALL BE LAYED OUT ON A PERFORMANCE BASIS, DEVICES INDICATED ON PLANS ARE FOR REFERENCE ONLY.
- C. PROVIDE FIRE STOPPING SYSTEM WHERE REQUIRED TO MAINTAIN THE FIRE RESISTANCE RATING OF THE ASSEMBLIES.
- D. EXACT LOCATIONS AND REQUIREMENTS FOR ALL EQUIPMENT SHALL BE VERIFIED WITH ARCHITECT/OWNER AND EQUIPMENT SUPPLIER PRIOR TO INSTALLATION.
- COORDINATE EXACT LOCATIONS, MOUNTING HEIGHTS & REQUIREMENTS FOR ALL DEVICES WITH LATEST ARCHITECTURAL FURNITURE & EQUIPMENT LAYOUTS & ELEVATIONS.
- F. COORDINATE EXACT LOCATIONS FOR ALL ELECTRICAL EQUIPMENT, PANELBOARDS, DISCONNECTS, STARTERS, CONTROL PANELS, ETC. WITH ARCHITECTURAL PLANS AND ALL OTHER TRADES INCLUDING MECHANICAL TO MAINTAIN REQUIRED WORKING CLEARANCES AND DEDICATED EQUIPMENT SPACE. DETERMINE EXACT LOCATIONS AND VERIFY WITH ALL OTHER TRADES PRIOR TO BEGINNING OF CONSTRUCTION TO AVOID INTERFERENCES WITH MECHANICAL, STRUCTURAL, ETC.
- G. MAINTAIN A MINUMUM OF 24" HORIZONTAL SEPARATION BETWEEN BOXES INSTALLED ON OPPOSITE SIDES OF FIRE RATED WALLS TO COMPLY WITH NEC 300.21. H. ALL WIRING DEVICES SHALL BE OF TAMPER RESISTANT CONSTRUCTION AND WITH AFCI PROTECTION.
- I. ALL DEVICES AT COUNTER LOCATIONS TO BE MOUNTED ABOVE THE COUNTER AT +42"AFF
- OR AS NOTED ON THESE PLANS. COORDINATE WITH ARCHITECT/OWNER AND MILLWORK CONTRACTOR FOR EXACT LOCATIONS.
- J. LOCATE DISCONNECT SWITCHES FOR MECHANICAL AND BUILDING EQUIPMENT TO MAINTAIN WORKING CLEARANCES. LOCATIONS ON THESE PLANS ARE FOR REFERENCE ONLY.
- K. GROUND FAULT PROTECTION FOR DEVICES INSTALLED AT LOCATIONS NOT READILY ACCESSIBLE, PROVIDE GROUND FAULT BLANK FACE DEVICE AT ACCESSIBLE LOCATION OR PROVIDE GFCI BRANCH BREAKER IN PANELBOARD. L. ALL ROOF MOUNTED EQUIPMENT TO BE NEMA 3R WEATHERPROOF RATED, INCLUDING STARTERS, DISCONNECTS, ETC.
- M. PUBLIC ADDRESS (PA) AND DISPATCH RADIO ALARM SYSTEMS ARE PROVIDED BY OWNER. PROVIDE BACK BOXES, RACEWAYS AND 120V BRANCH CIRCUITS FOR ALL SYSTEMS COMPONENTS AS REQUIRED. EXACT QUANTITIES, LOCATIONS AND REQUIREMENTS TO BE COORDINATED WITH OWNER. INFORMATION INDICATED ON THESE PLANS ARE FOR REFERENCE ONLY FOR INFRASTRUCTURE PRICING PURPOSES.
- N. REFER TO SHEET E2-00 FOR LIST OF ALTERNATES.

# GUH-3 1 COMPRESSORS (SEE RISER) LINE OF DECK ABOVE




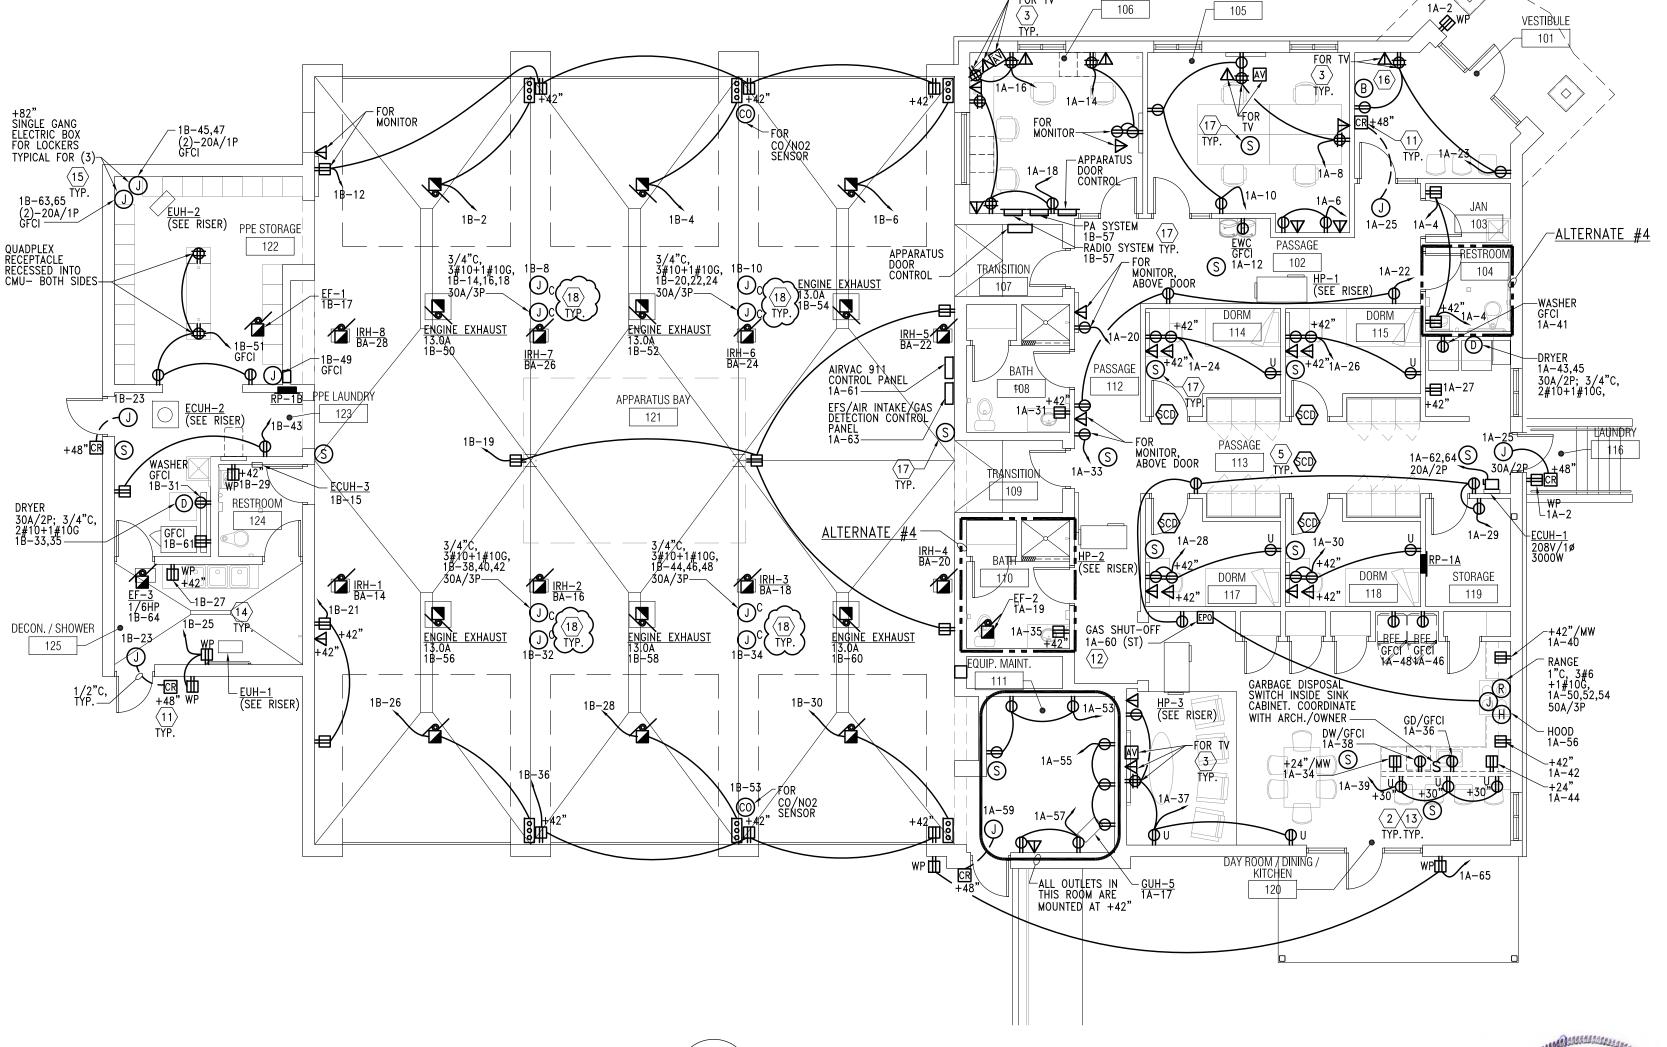





# **PARTNERS**

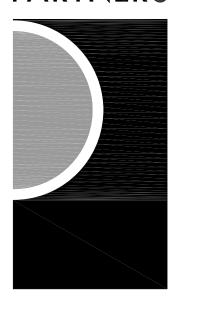

PARTNERS in Architecture, PLC

65 MARKET STREET MOUNT CLEMENS, MI 48043

P 586.469.3600 F 586.469.3607

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CONSULTANT



KEY PLAN

Highland Township Fire Department

PROJECT NAME

Highland Township Fire Station No. 2

2550 E. Wardlow Rd. Highland, MI 48356

PROJECT NO.

18-122B

ISSUES / REVISIONS	
SCHEMATIC DESIGN	01-28-2020
90% CD	07-31-2020
100% CONSTRUCTION DOCUMENT	08-27-2020
ADDENDUM #1	09-09-2020
RE-BIDDING / CONSTRUCTION	12-08-2020
CCD-1	07-13-2021

DRAWN BY

CHECKED BY

APPROVED BY

SHEET NAME

FLOOR PLANS -**POWER** 

SHEET NO. E3-00

