



AIA[®] Document G714[™] – 2017

Construction Change Directive

PROJECT: *(name and address)*
Highland Township Fire Station 1 PIA
18-122A

CONTRACT INFORMATION:
Contract For: General Construction

Date:

CCD INFORMATION:
Directive Number: 001

Date: June 4, 2020

OWNER: *(name and address)*
Highland Township
250 W. Livingston Road
Highland, MI 48357

ARCHITECT: *(name and address)*
PARTNERS in Architecture, PLC
65 Market Street
Mount Clemens, MI 48043

CONTRACTOR: *(name and address)*
Axiom Construction Services Group, LLC
10638 Rushton Road
South Lyon, MI 48178

The Contractor is hereby directed to make the following change(s) in this Contract:
(Insert a detailed description of the change and, if applicable, attach or reference specific exhibits.)

Refer to attached Electrical and Mechanical Exhibits for description of work.

PROPOSED ADJUSTMENTS

- The proposed basis of adjustment to the Contract Sum or Guaranteed Maximum Price is:
 - ☐ Lump Sum decrease of \$0.00
 - ☐ Unit Price of \$ per
 - ☐ Cost, as defined below, plus the following fee:
(Insert a definition of, or method for determining, cost)
 - ☒ As follows: These changes will result in a credit to the contract. The final amount is to be determined. An adjustment will be made to the contract amount, afterwards, via Change Order.
- The Contract Time is proposed to remain unchanged. The proposed adjustment, if any, is (0 days).

NOTE: *The Owner, Architect and Contractor should execute a Change Order to supersede this Construction Change Directive to the extent they agree upon adjustments to the Contract Sum, Contract Time, or Guaranteed Maximum price for the change(s) described herein.*

When signed by the Owner and Architect and received by the Contractor, this document becomes effective IMMEDIATELY as a Construction Change Directive (CCD), and the Contractor shall proceed with the change(s) described above.

Contractor signature indicates agreement with the proposed adjustments in Contract Sum and Contract Time set forth in this CCD.

PARTNERS in Architecture, PLC

Highland Township

Axiom Construction Services Group, LLC

ARCHITECT *(Firm name)*

OWNER *(Firm name)*

CONTRACTOR *(Firm name)*



SIGNATURE

Joseph Valeri, Sr. Project Architect

PRINTED NAME AND TITLE

6/4/2020

DATE

SIGNATURE

Ken Chapman, Fire Chief

PRINTED NAME AND TITLE

DATE

SIGNATURE

Deib Mougrabi, Director of Field Operations

PRINTED NAME AND TITLE

DATE

EXHIBIT 'A'

References

Architectural: Sheet A3-30 – Mechanical unit with continuous roof curb, and guard rail to be removed.

Mechanical: Sheet M1-02, M2-01, M2-02, M3-01, M4-01, M5-01, M5-02, M6-01, and M6-02 - MAU unit with all associated ducting and accessories to be removed. Gas Infrared heaters with all associated piping, venting, and other accessories to be added.




Electrical: Sheet E0-02, E0-04, and E3-00 - All electrical associated with MAU unit and ducting to be revised for Gas Infrared heaters with all associated piping, venting, and other accessories.

ROOF PLAN GENERAL NOTES:


- A. REFER TO SPECIFICATION FOR ADDITIONAL INFORMATION FOR ROOF RELATED ITEMS.
- B. TAPERED INSULATION SHALL SLOPE 1/4" PER 1'-0" TOWARDS ROOF SUMP UNLESS OTHERWISE NOTED. SLOPE VALUES ARE APPROXIMATE. IF SLOPE CANNOT BE ACHIEVED, CONTACT ARCHITECT BEFORE PROCEEDING FURTHER. ARROWS SHOWN REPRESENT DOWN SLOPE OF ROOF.
- C. REFER TO ROOF DETAILS FOR ALL PIPE PENETRATIONS - COORDINATE LOCATIONS AND QUANTITIES W/ MECHANICAL.
- D. DO NOT PENETRATE SHINGLE ROOF - REFER TO MECHANICAL AND ELECTRICAL FOR ALL THRU ROOF PENETRATIONS. FLASH AND SEAL ALL PENETRATIONS IN ACCORDANCE WITH THE ROOF MANUFACTURER'S SPECIFICATIONS AND DETAILS TO ENSURE WARRANTY & DETAILS.

ROOF PLAN KEY NOTES:

- 1 ASPHALT SHINGLE ROOF. ALL VENTING AND EXHAUST TO BE IN ROOF WELL WALL / RIDGE OR SOFFT. NO VENTING OR ANY M.E.P. PENETRATIONS THROUGH SHINGLE ROOF ON SOUTH SIDE
- 2 SINGLE-PLY MEMBRANE ROOFING ON R-15 MIN TAPERED INSULATION
- 3 6" K-STYLE METAL GUTTER (MRS-2)
- 4 LINE OF FACE OF WALL BELOW, TYPICAL (DASHED LINE)
- 5 WRAP ROOF MEMBRANE OVER SIDING. TWO-PIECE ALUMINUM GUTTER AND FASCIA SYSTEM APPLIED OVER MEMBRANE WRAP
- 6 PARAPET FLASHING MEMBRANE ON BOTH SIDES OF ROOF CUT-OUT. PROVIDE METAL FLASHING W/ DRIP EDGE AT SHINGLES SEE SIM. DETAIL 4/A3-31
- 7 SHADED AREA OF ICE AND WATER SHIELD SYSTEM - EXTEND 3'-0" MIN. PAST WALL BELOW AND VALLEYS.
- 8 CONTINUOUS INTAKE VENT. INSTALL PER MANUFACTURERS INSTRUCTIONS
- 9 CONTINUOUS RIDGE VENT - REFER TO DETAIL 2/A3-31
- 10 ROOF VENT - REFER TO MECH. & DETAIL 1/A3-31
- 11 NOT USED
- 12 LINE OF ROOF BELOW
- 13 METAL DOWNSPOUT DRAIN (MRS-2)
- 14 PROVIDE ICE AND WATER SHIELD AT ALL VALLEYS AND RIDGES (DETAIL 5/A3-21) AND EXTEND 3'-0" BEYOND INTERIOR FACE OF EXTERIOR WALLS (DETAIL 6/A3-21)
- 15 PROVIDE FLASHING AT SIDEWALL TO ROOF TRANSITION - SEE DETAIL (4/A3-21)
- 16 WINDOW BELOW ROOF DORMER, REF A0-04: WINDOW SCHEDULE AND WINDOW TYPES
- 17 LINE OF TRAINING DECK BELOW - ALTERNATE #3
- 18 ROOF ACCESS HATCH
- 19 PROVIDE FLASHING AT ASPHALT SHINGLE ROOF TO SINGLY-PLY MEMBRANE ROOF TRANSITION
- 20 NOT USED
- 21 CONTINUOUS RIDGE VENT SLOPE TO HIGH WALL - REFER TO SPECIFICATIONS
- 22 NO SHEATHING BELOW DORMER FOR CONTINUOUS ATTIC ATMOSPHERE

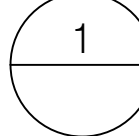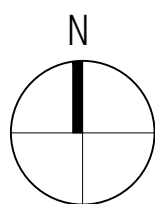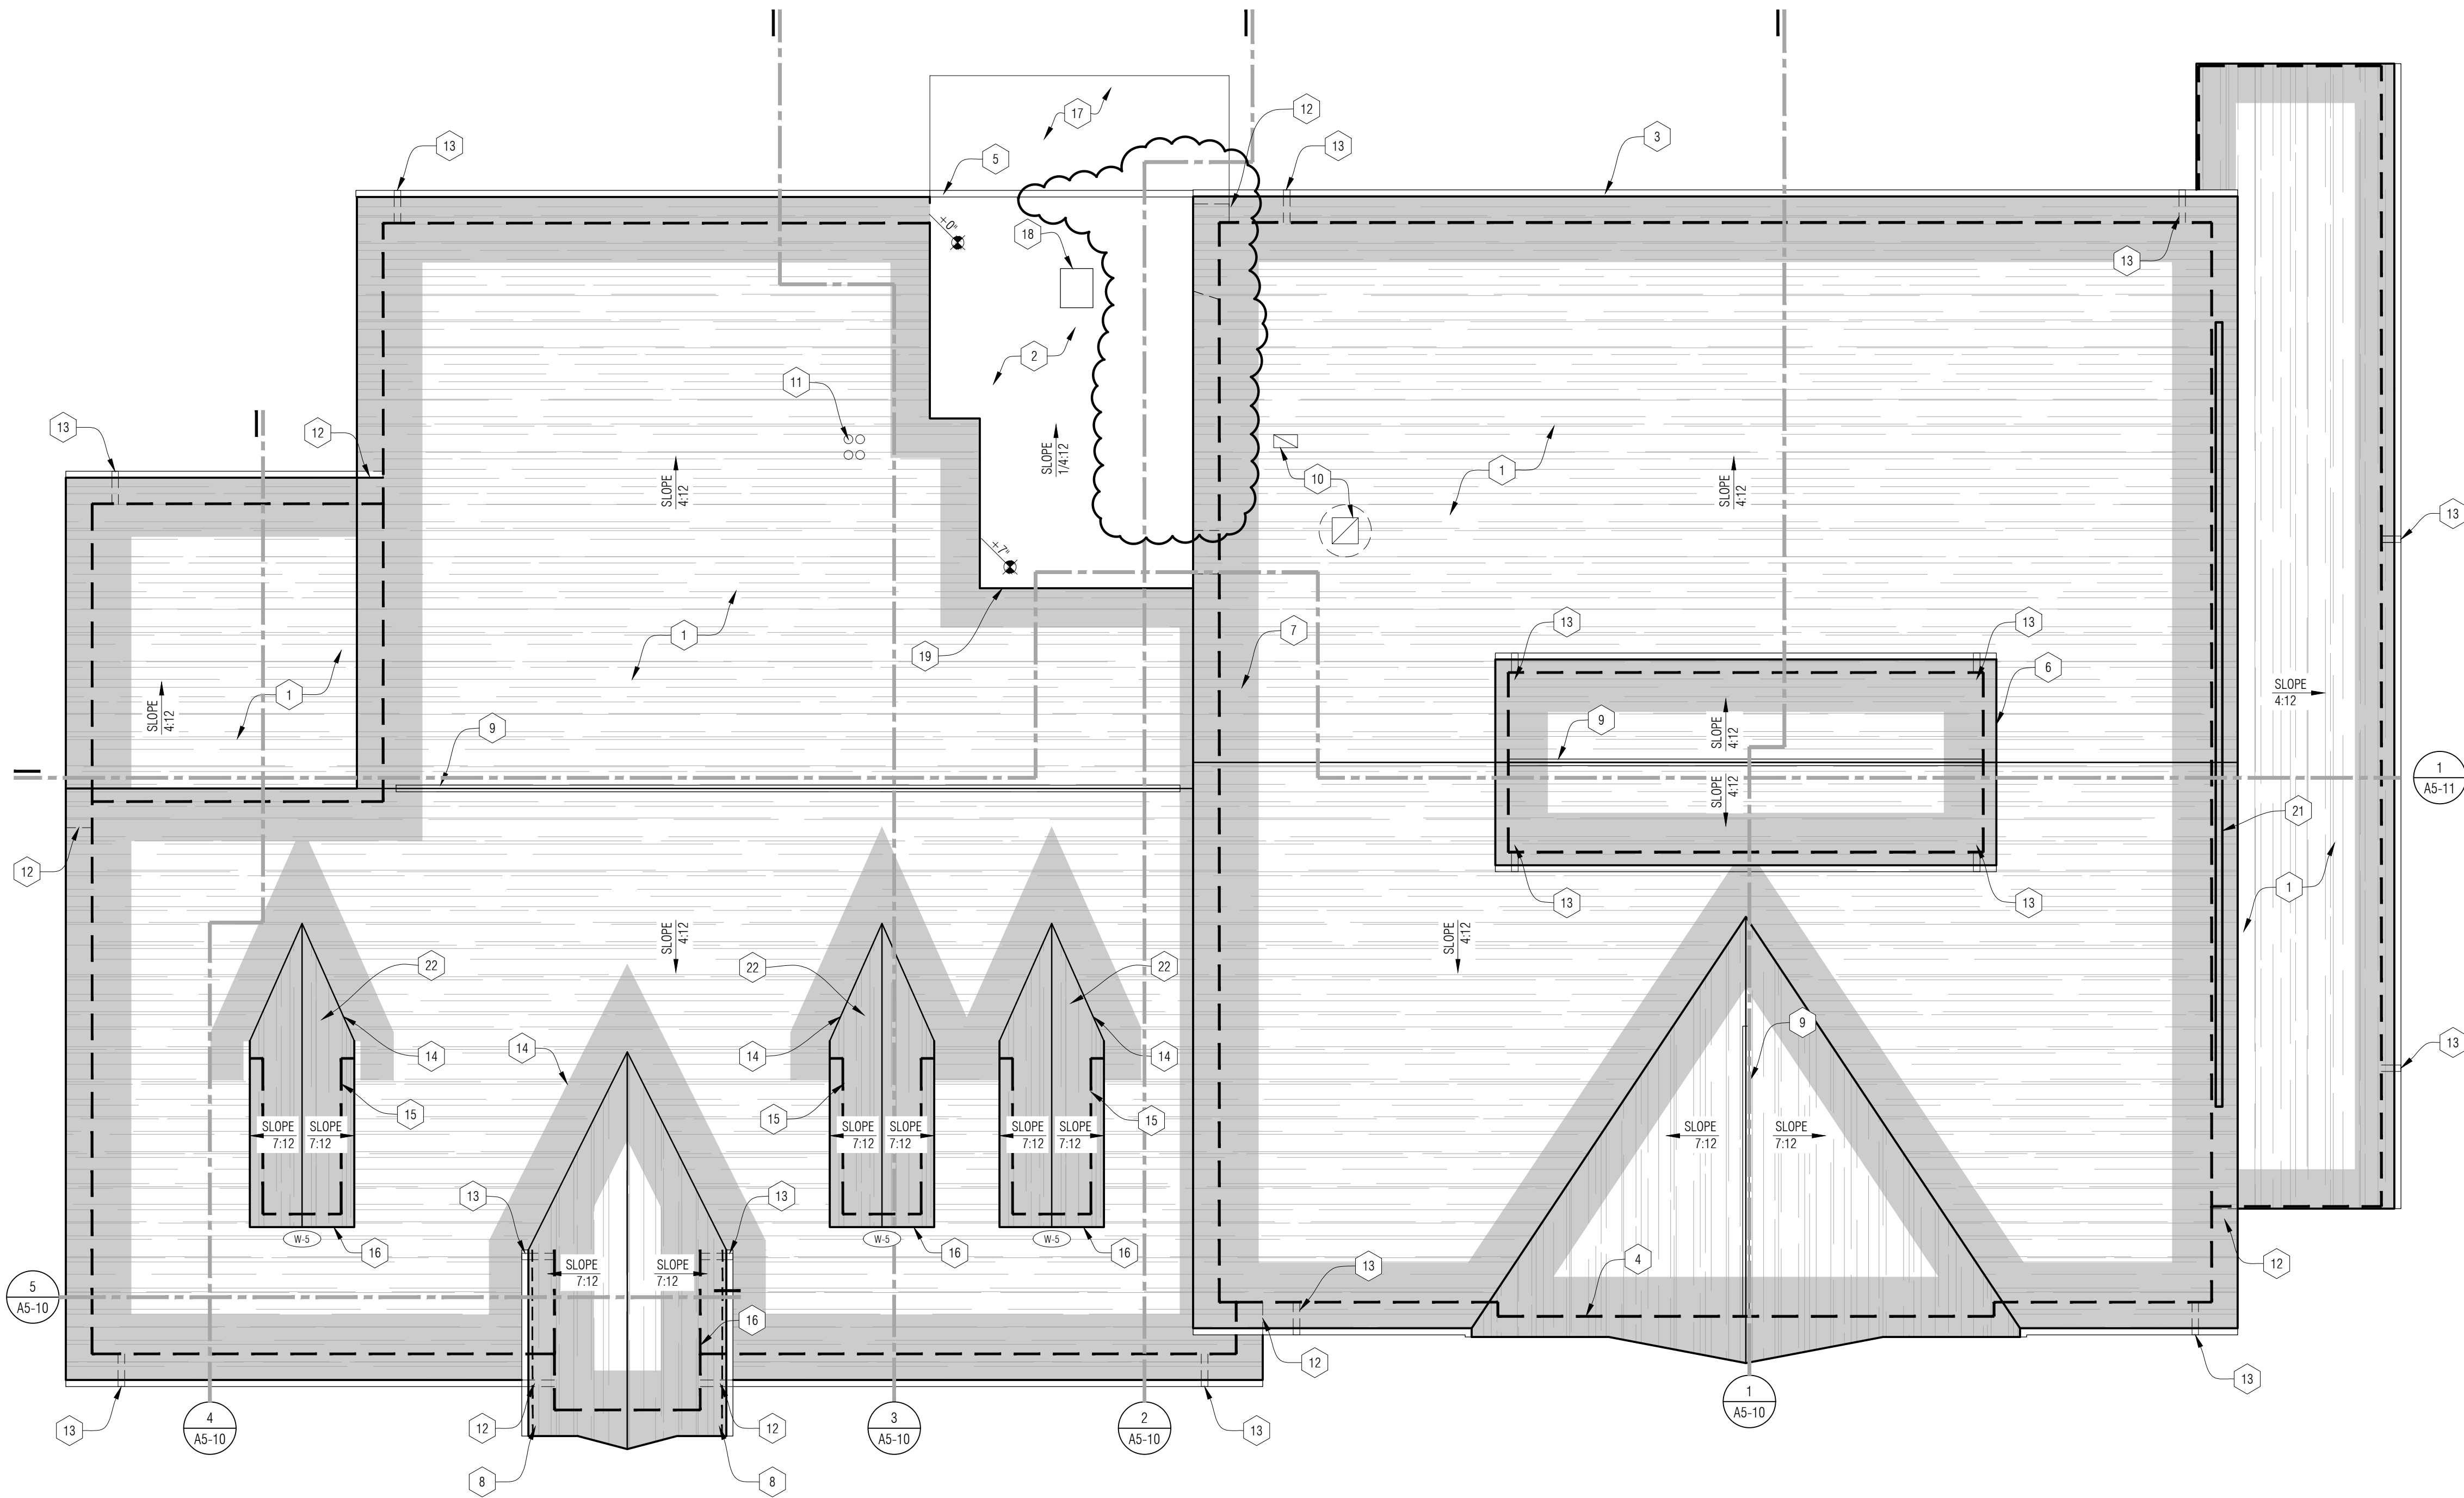

Roof Plan
1/8" = 1'-0"

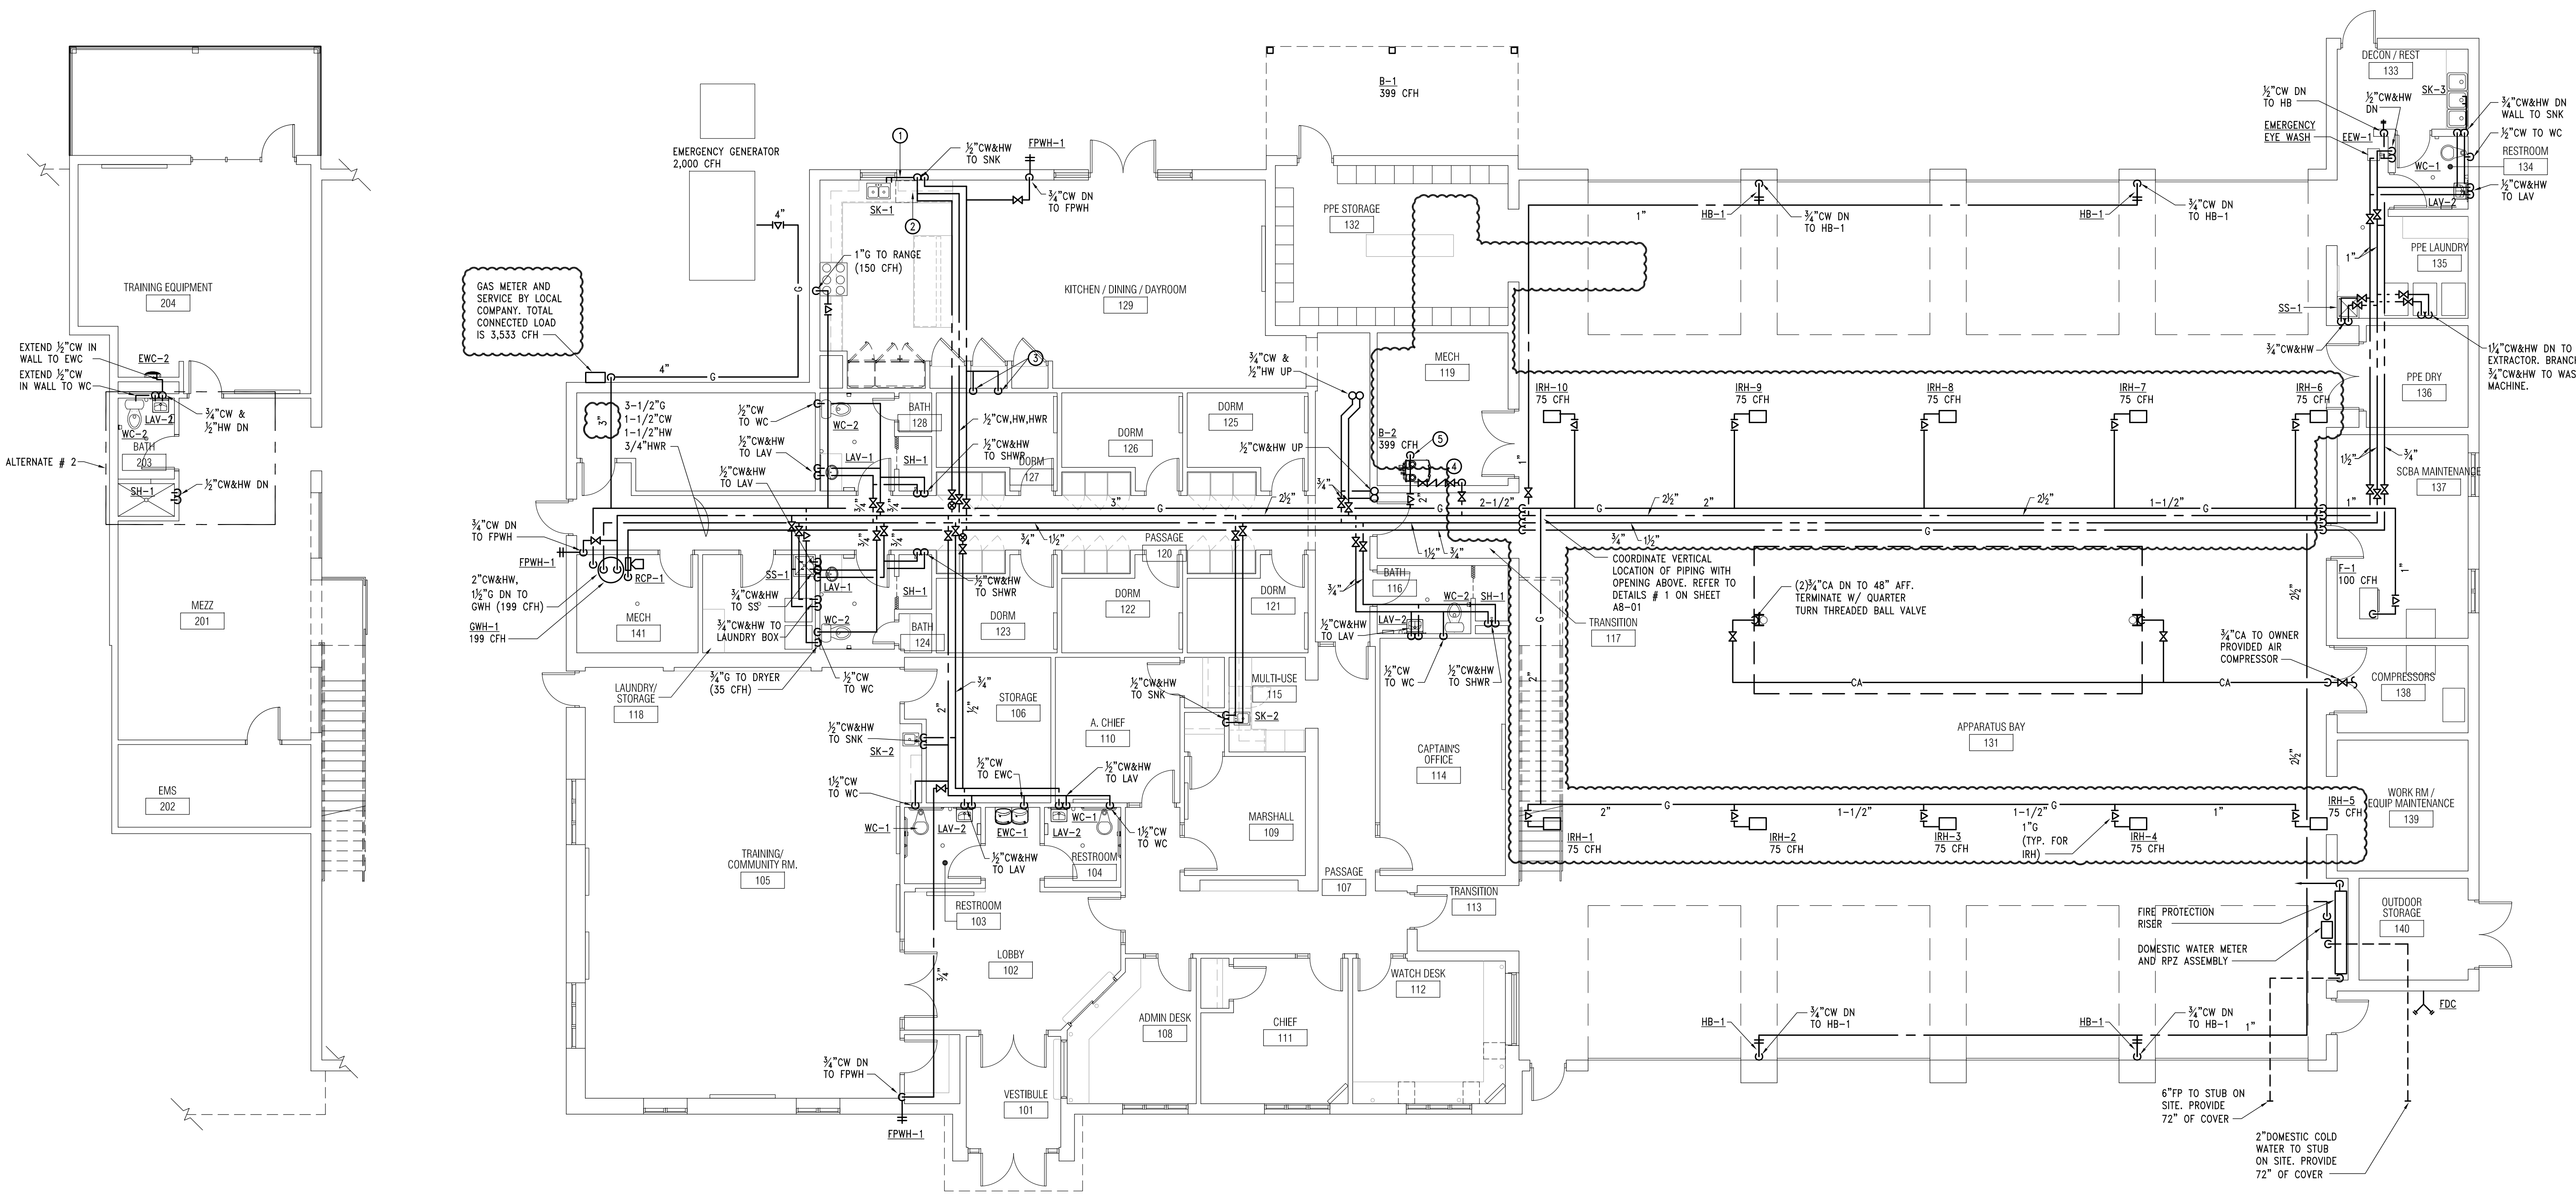

2 Mezzanine Level Floor Plan - Domestic Water & gas
1/8" = 1'-0"

1 Main Level Floor Plan - Domestic Water & Gas
1/8" = 1'-0"


NATURAL GAS LOAD SUMMARY	
EQUIPMENT	INPUT (CFH)
GWH-1	199
IRH-1 THRU 10	(10x75) 750
B-1	399
GAS RANGE (ALLOCATED)	150
GAS DRYER (ALLOCATED)	35
GENERATOR (ALLOCATED)	2000
F-1	100
TOTAL	= 3,533 CFH
PIPE DESIGN BASED ON 7"W.C. @ 250' LINEAR FT. WITH 0.3"W.C. ALLOWABLE PRESSURE DROP.	

NEW WORK KEY NOTES:


- EXTEND DOMESTIC WATER IN WALL TO SINK. KEEP TIGHT TO INTERIOR OF WALL. PROVIDE MINIMUM 2" RIGID INSULATION BEHIND PIPE AN SEAL TO STUD AND ALL SEAMS.
- EXTEND HOT WATER TO DISHWASHER. PROVIDE FINAL CONNECTION PER MANUFACTURERS RECOMMENDATION.
- 1/2" COLD WATER DOWN TO REFRIGERATOR. PROVIDE ONE BACKFLOW PREVENTER APOLLO MODEL #4C-100 SERIES PER COLD WATER DROP ABOVE CEILING. ROUTE DEVICE DRAIN TO SERVICE SINK.
- 1" COLD WATER TO MECHANICAL EQUIPMENT. PROVIDE RPZ AND PIPE "SPIT" TO FLOOR DRAIN.
- 2" GAS DOWN TO BOILER. PROVIDE SHUT-OFF IN VERTICAL. (399 CFH EA)
- BOILER # 1 (IN FLOOR HEAT) IS AN ALTERNATE # 5.

GENERAL NOTES:

- COORDINATE ALL WORK WITH OTHER TRADES.

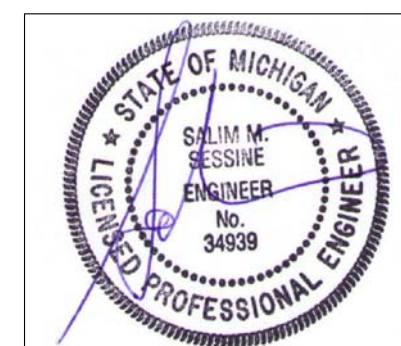

PARTNERS

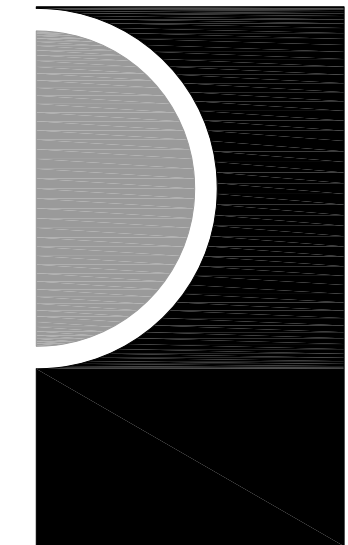

PARTNERS in Architecture, PLC

65 MARKET STREET
MOUNT CLEMENS, MI 48043
P 586.469.3600
F 586.469.3607

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CONSULTANT



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SCHEMATIC DESIGN	01-28-2020
BIDDING-CONSTRUCTION	03-27-2020
ADDENDUM # 1	04-20-2020
CONSTRUCTION	05-04-2020
CDD # 1	06-03-2020

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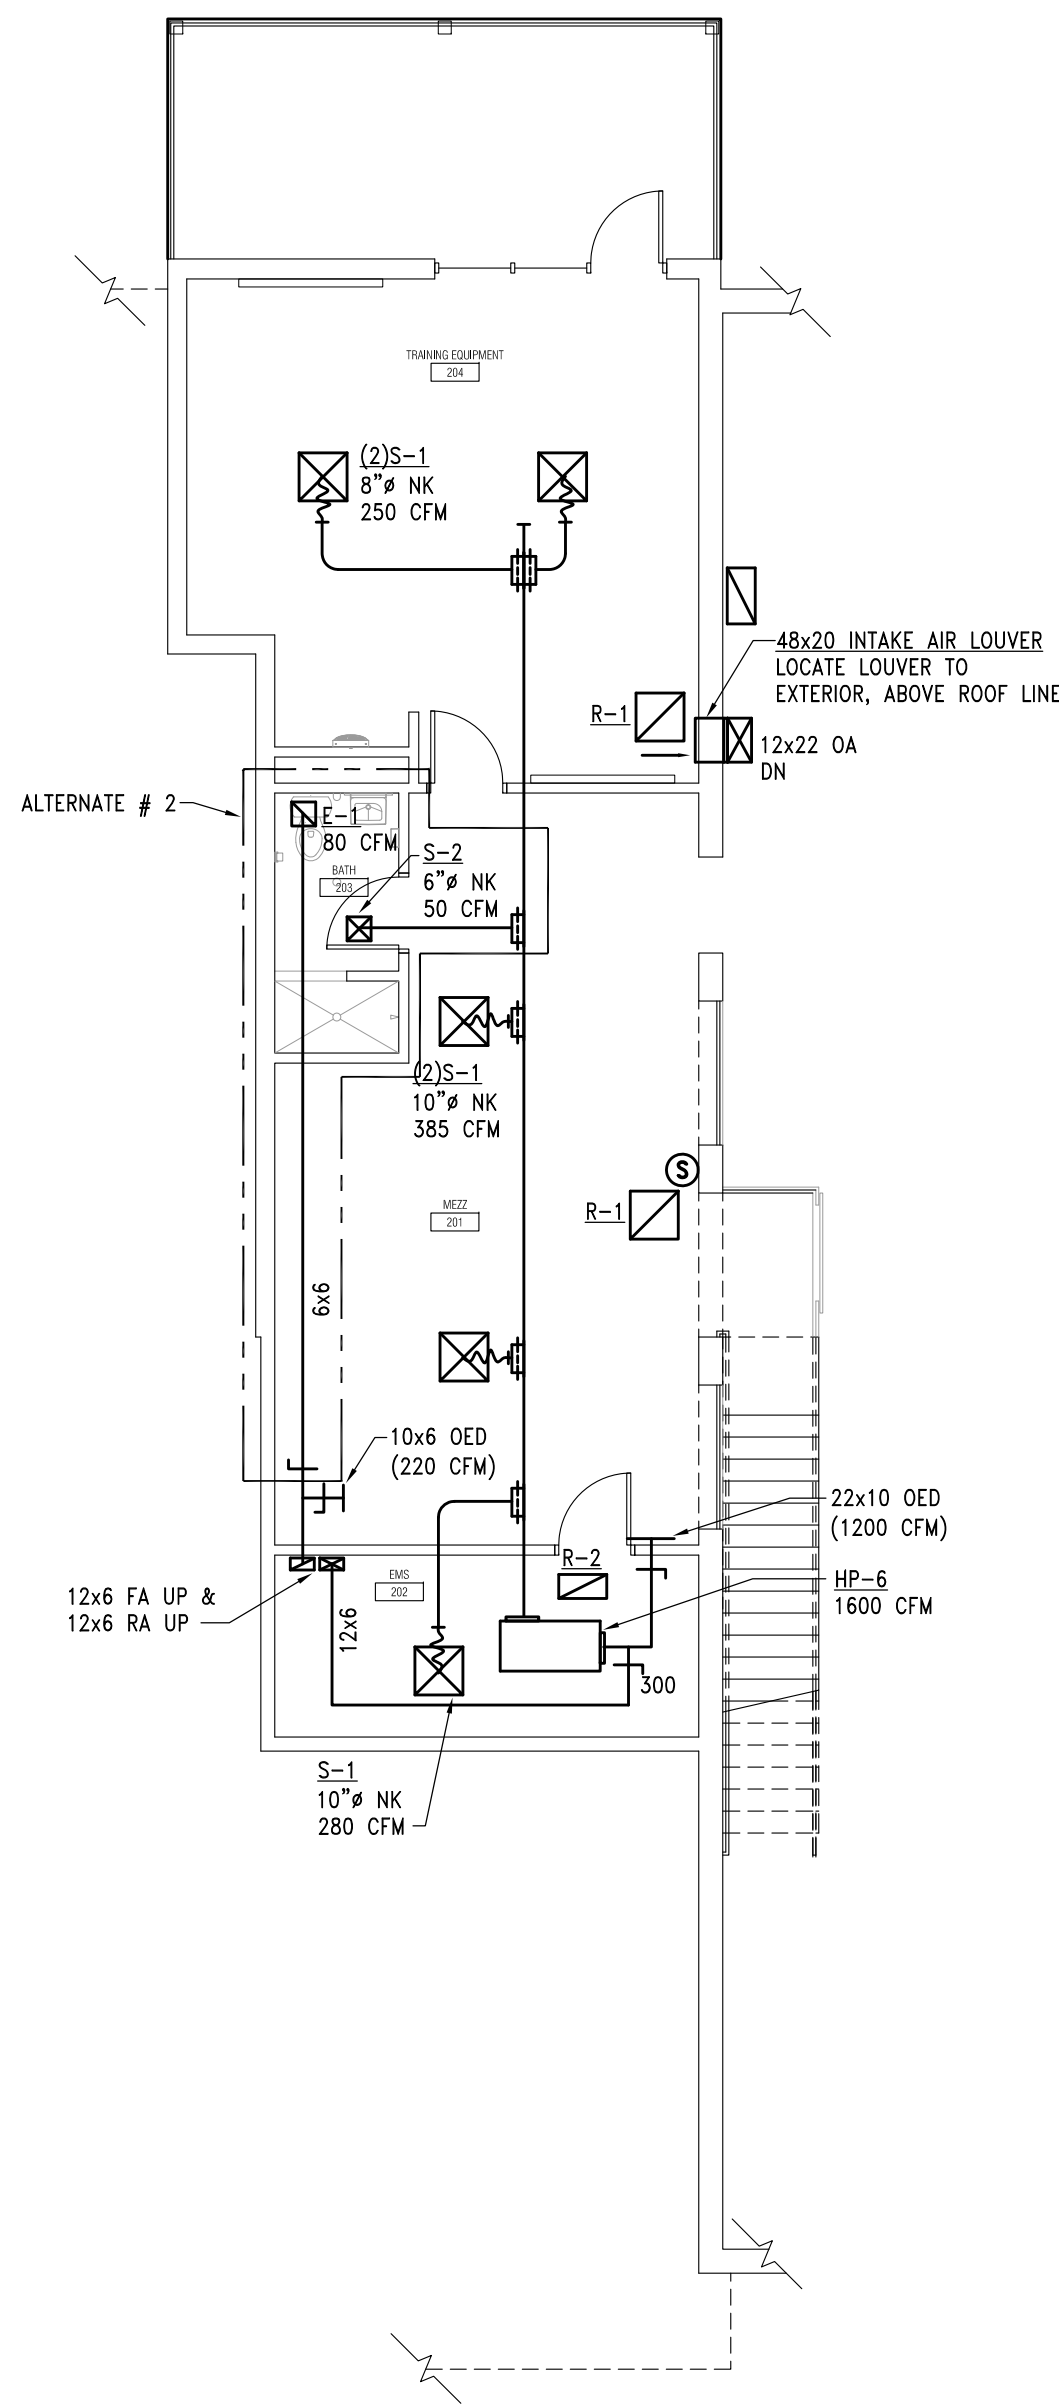
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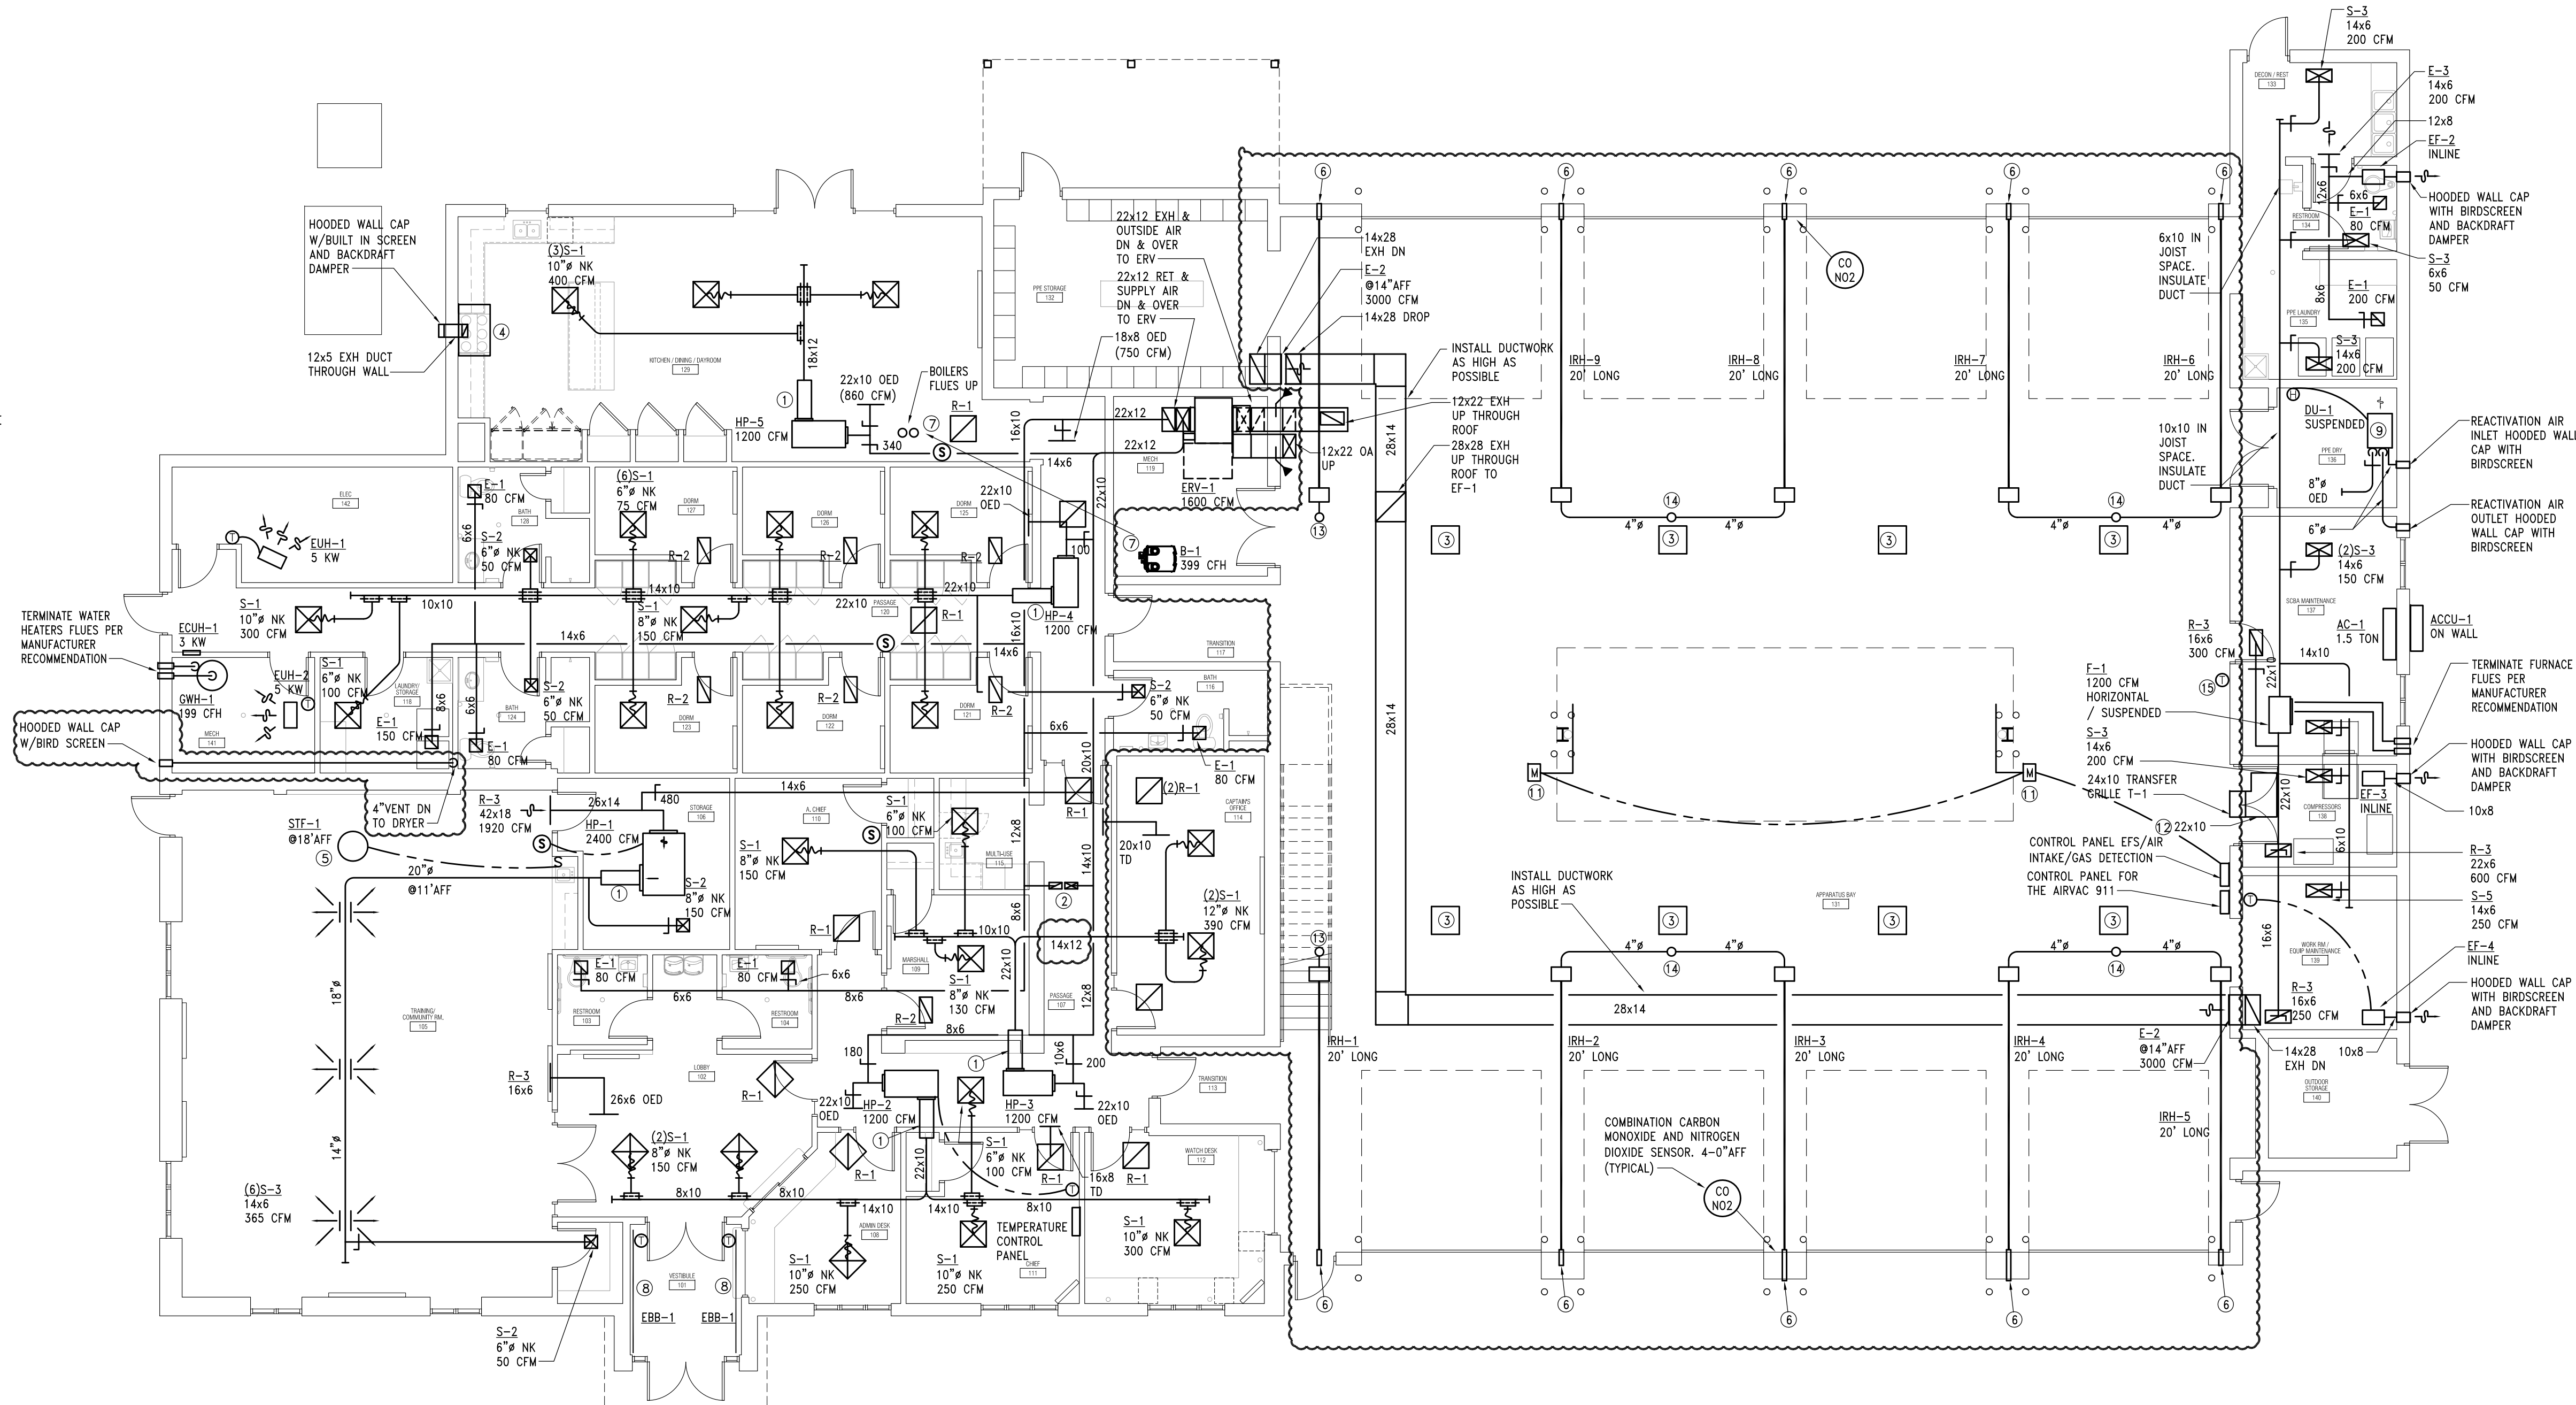
FLOOR PLANS -
DOMESTIC WATER
AND GAS

SHEET NO.

M1-02




2 Mezzanine Level Floor Plan - HVAC
1/8" = 1'-0"




1 Main Level Floor Plan - HVAC
1/8" = 1'-0"

- HVAC KEY NOTES:**
- 1 PROVIDE CIRCULAR MEDIUM VELOCITY SILENCER BY PRICE MANUFACTURER MODEL CM24 SERIES.
 - 2 12x6 FA UP & 12x6 RA UP. (300 CFM).
 - 3 ENGINE EXHAUST REMOVAL SYSTEM BY AIR VAC 911, 120/1, 3/4" HP, 13 AMPS. PROVIDE COMPLETE SYSTEM: WALL GAS DETECTORS, OVERRIDE SWITCH, CONTROL PANEL. INSTALL BOTTOM OF THE UNIT AT 25" AFF.
 - 4 KITCHEN HOOD BY ACCUREX MODEL XRRS-W-36-R, INTEGRAL FAN, REAR DISCHARGE, 500 CFM.
 - 5 DE-STRATIFICATION (STF-1) FAN BY AIR-ROW FANS MODEL AF-22, 120/1, 1170 CFM, 23 WATTS.
 - 6 4" VENT THROUGH WALL. TERMINATE WITH HORIZONTAL (WALL) CONCENTRIC KIT AND PER MANUFACTURER RECOMMENDATION.
 - 7 PROPOSED FLUES ROUTING SERVING THE BOILER. CONTRACTOR TO CONSULT WITH THE MANUFACTURE INSTALLATION MANUAL FOR INSTALLATION.
 - 8 PEDestal MOUNTED ELECTRIC BASEBOARD BY MARKEL MODEL # DBF, 9' LONG, 2250 WATTS, 208/1.
 - 9 DRYER UNIT, SEE SCHEDULES. INSTALL PER MANUFACTURER RECOMMENDATION.
 - 10 NOT IN USE.
 - 11 PROVIDE MOTORIZED DAMPER TO CONTROL (OPEN/CLOSE) THE COPULA LOUVERS. LOUVERS BY ARCHITECT.
 - 12 LINED TRANSFER DUCT FOR SOUND.
 - 13 4" INTAKE UP THROUGH ROOF. TERMINATE WITH PITCH ROOF CAP AND PER MANUFACTURER RECOMMENDATION. PROVIDE BIRDSCREEN.
 - 14 6" INTAKE UP THROUGH ROOF. TERMINATE WITH GOOSENECK AND PER MANUFACTURER RECOMMENDATION. PROVIDE BIRDSCREEN.
 - 15 CONNECT ALL IRH TO THIS THERMOSTAT.

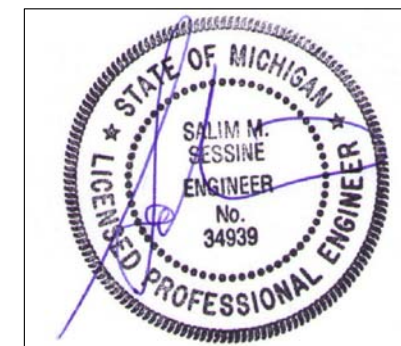

PARTNERS

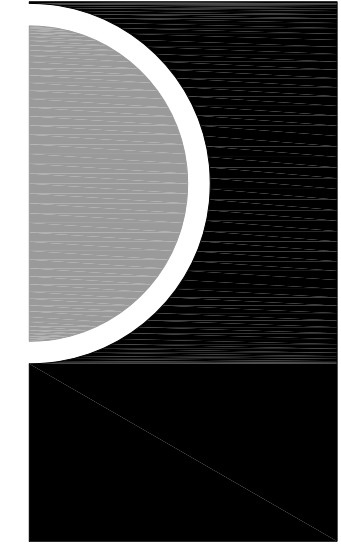

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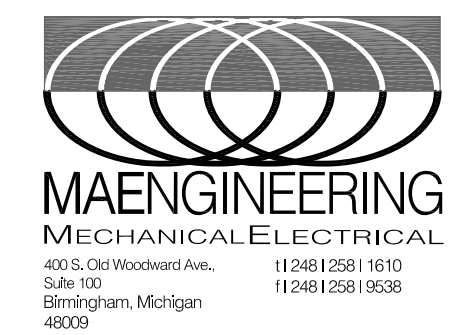
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MOUNT CLEMENS, MI 48043
P 586.469.3600
F 586.469.3607

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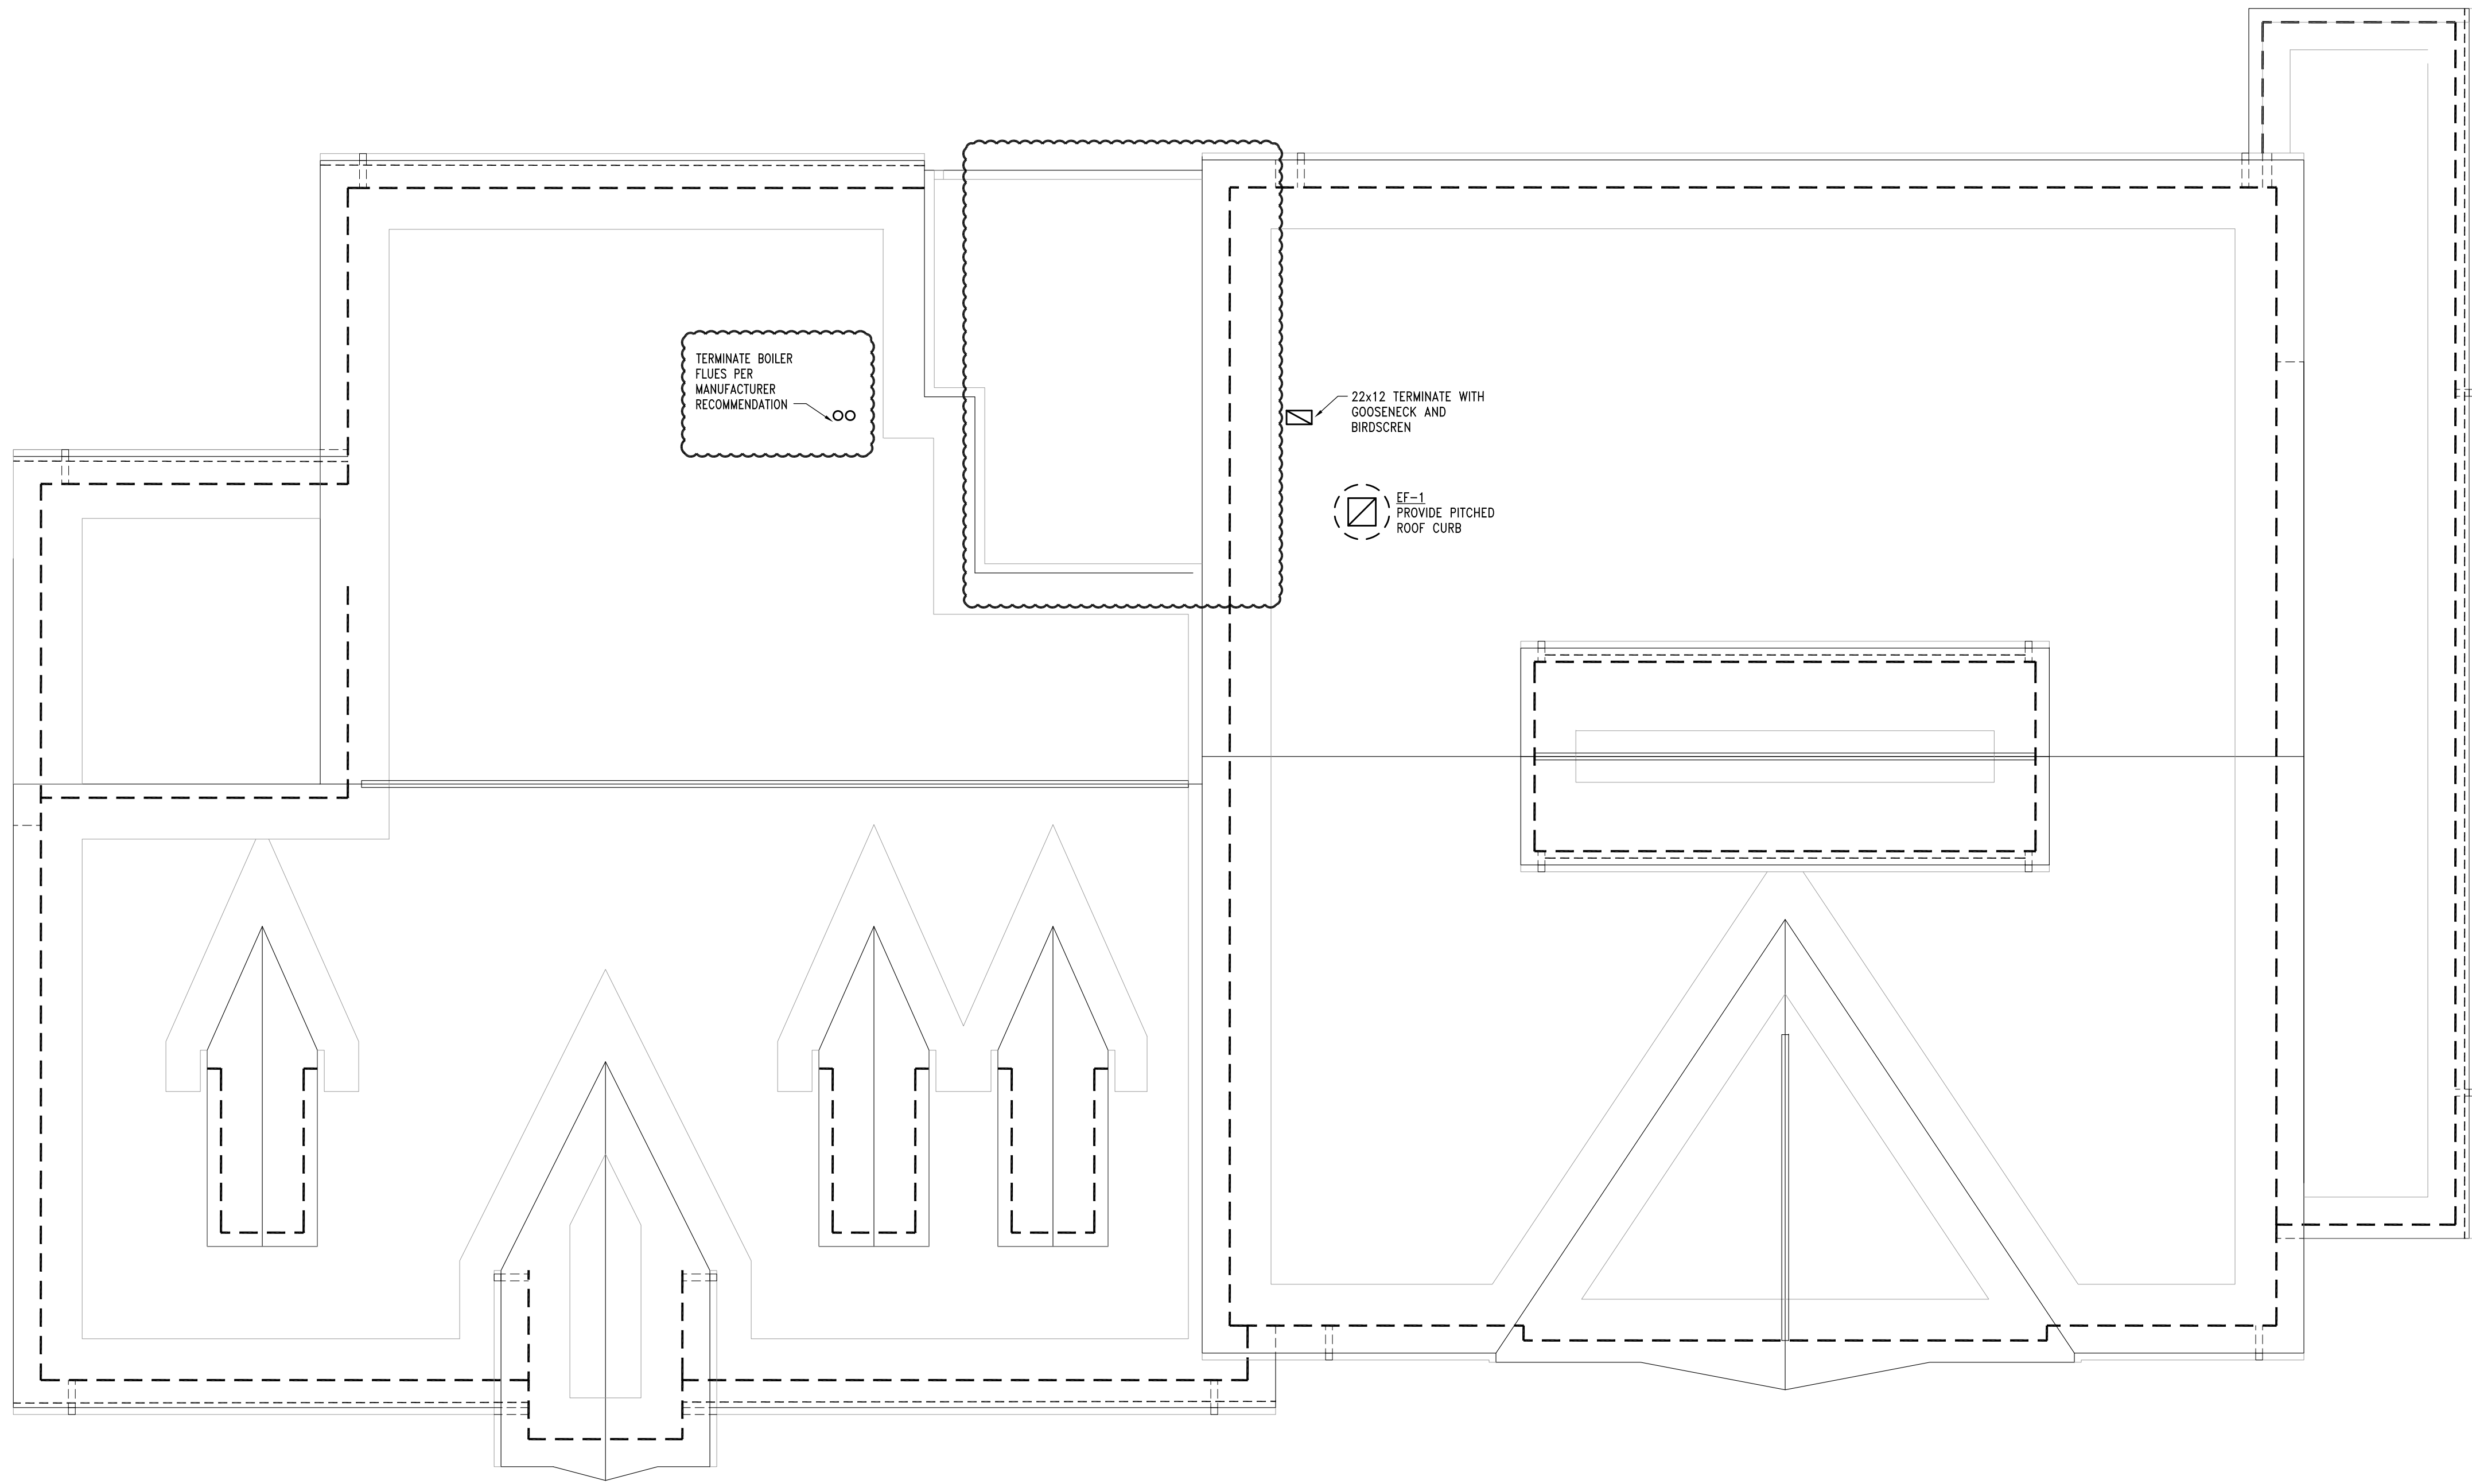
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SHEET NAME

FLOOR PLANS -
HVAC

SHEET NO.


M2-01




1 Roof Plan - HVAC
1/8" = 1'-0"

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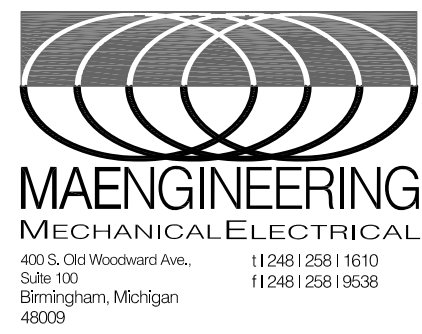
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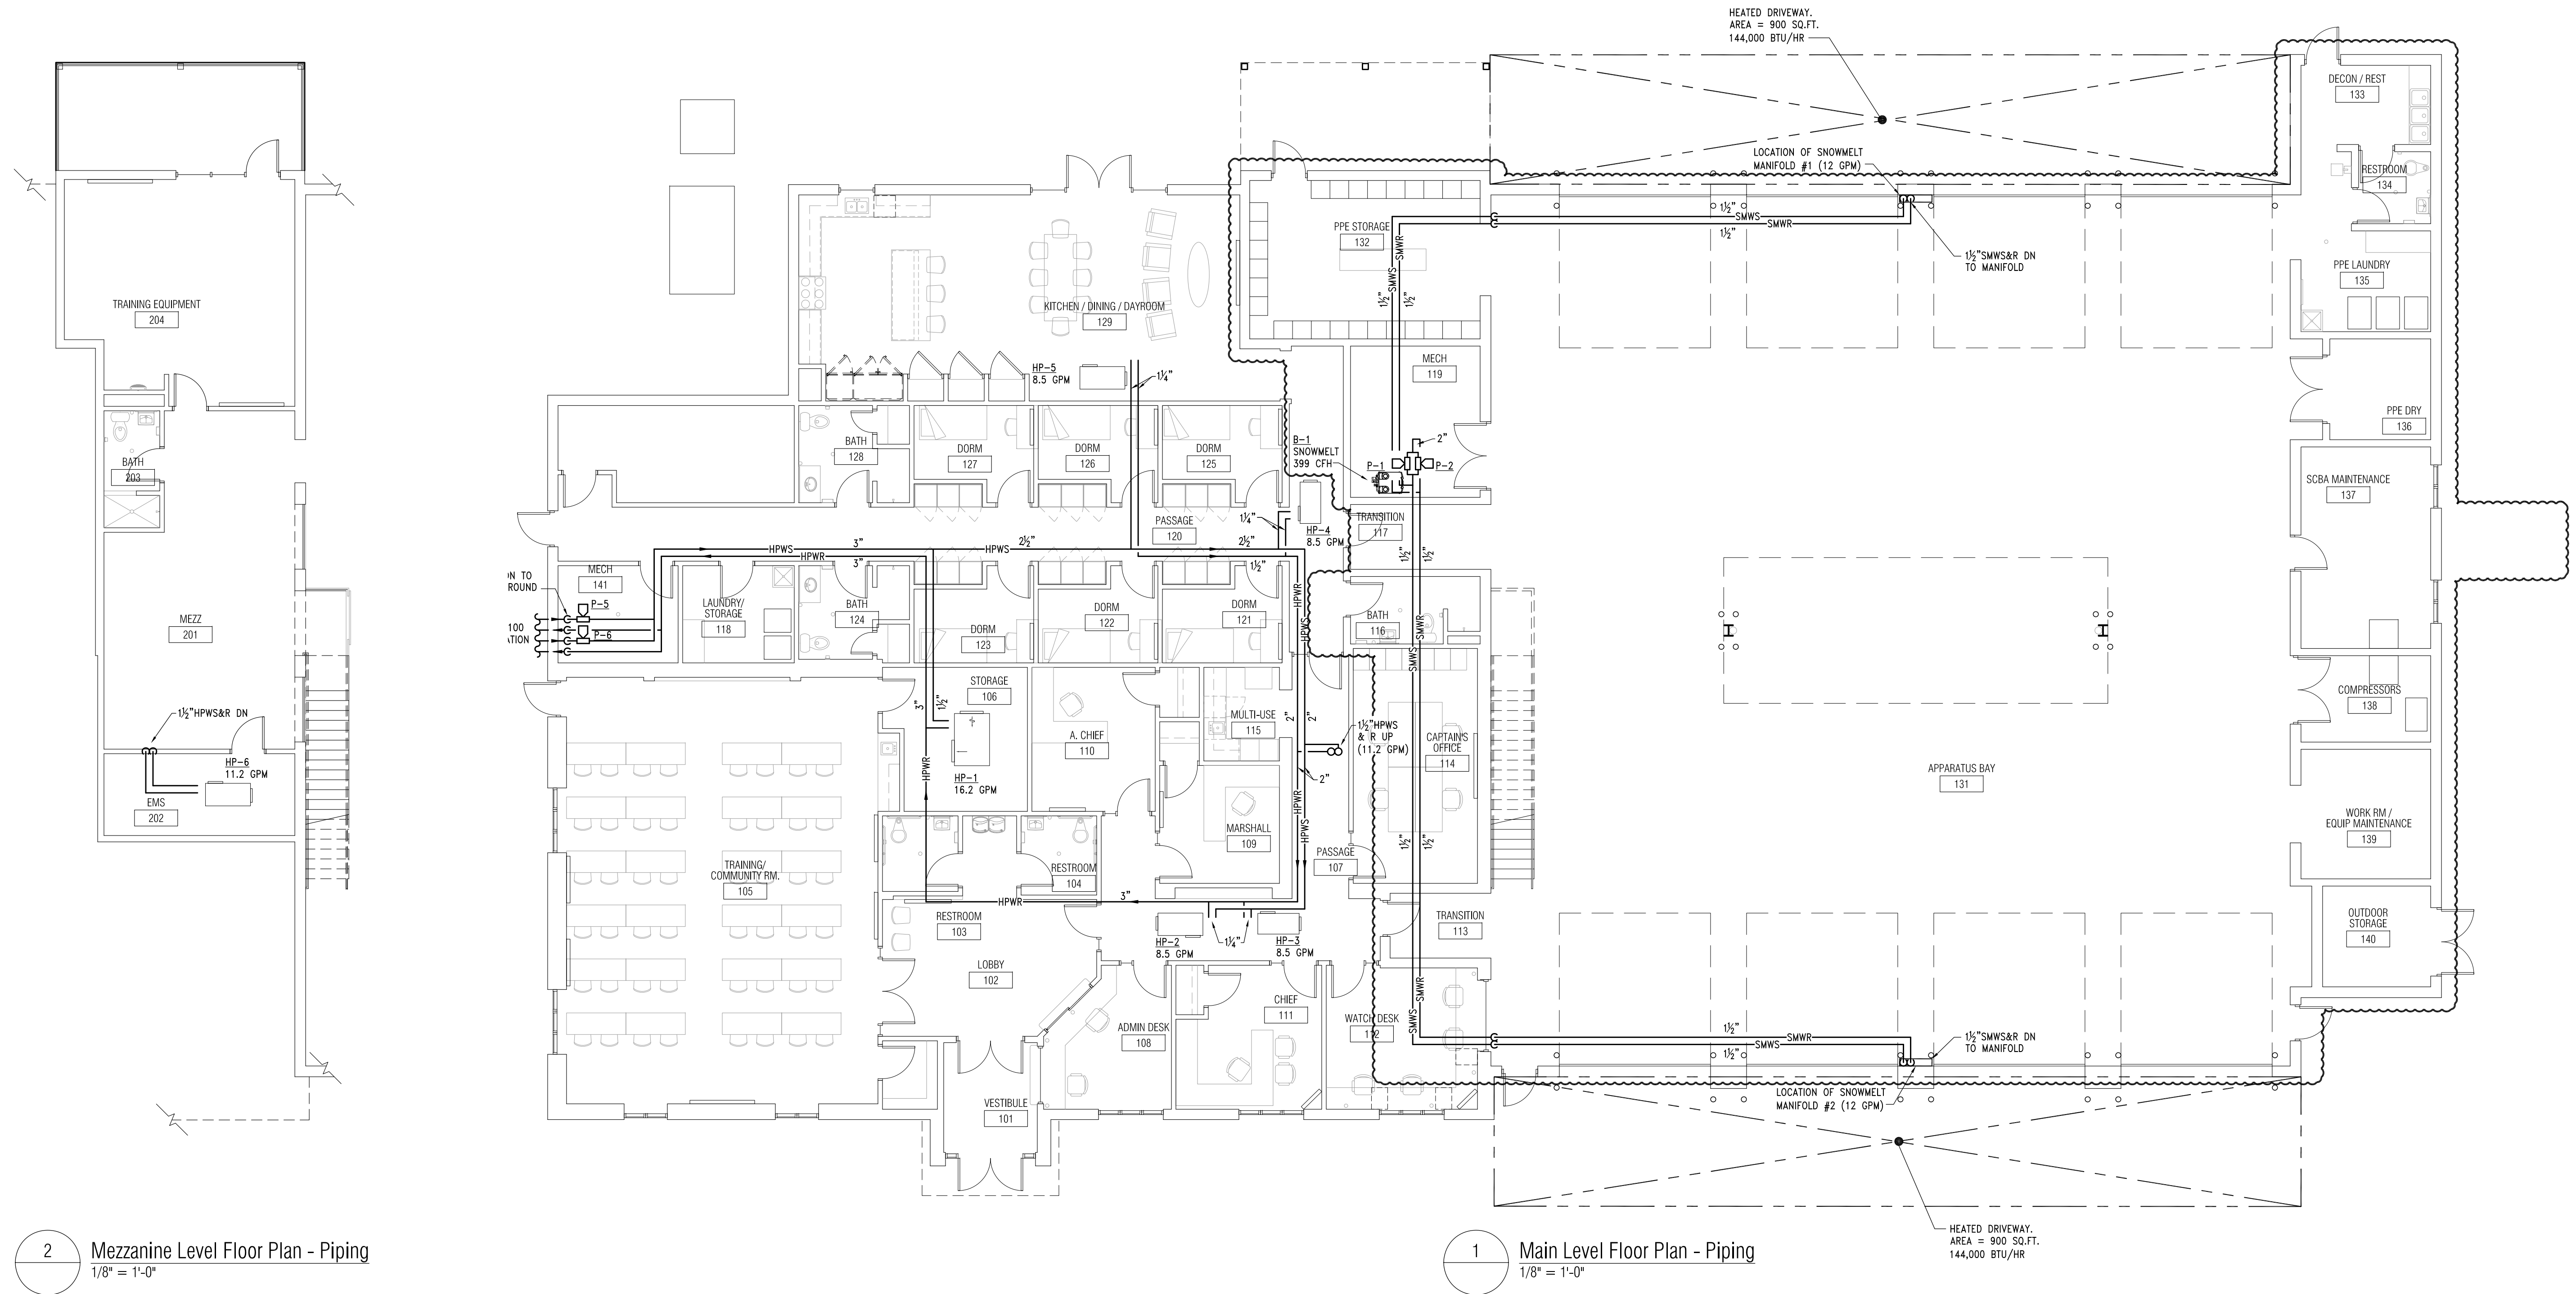
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SHEET NAME

ROOF PLAN - HVAC

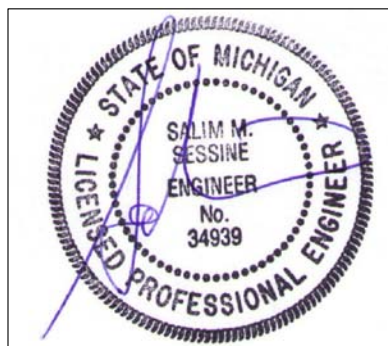
SHEET NO.

M2-02

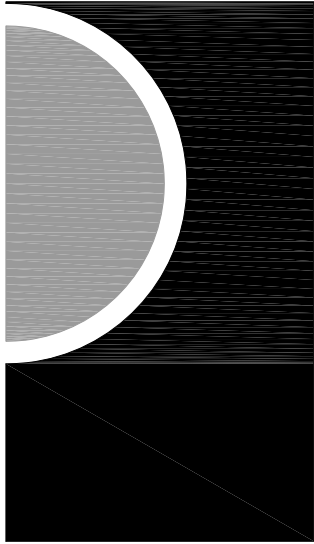


① NOT USED.

1. NOT USED

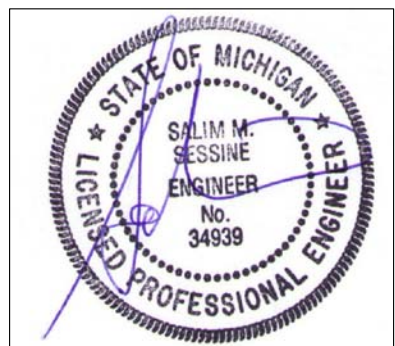

RENEWAIRE
ERV-1 SCHEDULE WITH ELECTRIC HEATER

PROVIDE DEDICATE CIRCUIT FOR ELECTRIC HEATER
PROVIDE DISCONNECT FOR ERV AND ELECTRIC HEATER

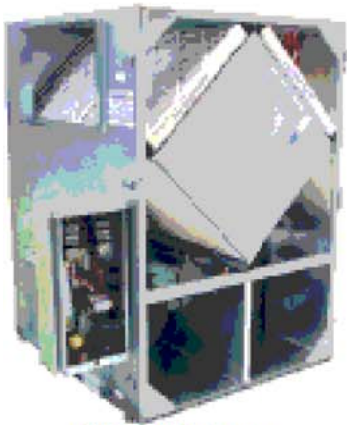

HE2XINV shown


Specifications

Ventilation Type:	Static plate, heat, and humidity transfer
Typical Airflow Range:	500-2,200 CFM
AHRI 1060 Certified Core:	Two L125-G5
OA Filters:	Total Qty. 2, MERV 8: 20" x 20" x 2"
RA Filters:	Total Qty. 2, MERV 8: 20" x 20" x 2"
Unit Weight:	363-583 lbs. (varies by option)

Configuration

Unit Tag	erv-1
Model	[HE-2X] HE-2X
Core Type	[J] G5
Installation Location	[IN] Indoor Unit
Airflow Orientation	[V] Orientation V
Wall	[S] Single (Standard)
Electrical Service	[35] 208-230V / 3 Phase / 60 HZ
Fresh Air Motor	[V] TEFC Belt Drive - 2 HP
Exhaust Air Motor	[V] TEFC Belt Drive - 2 HP
Flow Control	[-] No Dampers (Standard)
Unit Control	[A] Motor Starters & Contactors (Standard)
Shaft Grounding Rings	No
Disconnect	[N] Non Fused (Standard)
Control Option	[3] Enhanced Controls with BACnet Factory Activation
Filter Monitor	[-] Filter monitors are included with controls
Paint	[-] None
Safety Listing	[L] Listed

Airflow Orientation

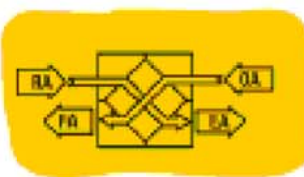

Unit Accessories and Service Parts

Type	Part Number	Description	Quantity
Electric Heater	EK-1414008SCCHR--23-15V-N	EK-1414008SCCHR--23-15V-N	1

Fans

	CFM	ESP	Filters	Fan RPM	BHP	Elevation	Motors Protected by Motor Starters Qty @ HP	FLA	Motors Protected by VFDs Qty @ HP	FLA
FA1600	1	2"	MERV-8	1382	1.05	627	2@2.0	6.6-5.8	None	-
EA1636	1	2"	MERV-8	1394	1.08					

Unit Electrical Data

Volts	Hertz	Phase	MCA	MOP
208-230	60	3	14.8	20

Specifications

Heater Type:	Electric Duct Heater
Standard Features:	A disconnecting magnetic control contactor per stage or each 48 Amp circuit within a stage Open-coil element Control terminal board Grounding lugs Automatic limit switch for primary overtemperature protection Manual reset limit switch for secondary overtemperature protection Non-adjustable airflow switch Disconnect switch

Configuration

Heater Tag	edh-1
Heater Series	[EK] EK Electric Duct Heater
Width	[14] Width
Height	[14] Height
Heater Capacity	[008] Capacity
Mount	[S] Slip-In (Standard)
Element Style	[C] Open Coil (Standard)
Element Material	[C] 60-20-20 Ni-Cr-Fe with Nickel-Plate Terminal Pins (Standard)
Airflow Orientation	[H] Horizontal
Control Box Offset	[R] Right Hand
Control Box Recessed	[-] None
Control Box Dust Tight	[-] None
Electrical Service	[23] 208V / 3 Phase / 60 HZ
Power Fusing	[-] None
Stage	[1] Single Stage
Control Voltage	[5] 24VAC
Control Type	[V] SCR with Thermostat and Sensor
Pilot Light	[N] None

Unit Accessories and Service Parts

No accessories for this unit

Performance

CFM	Temp In	Temp Out	kW	Volts	Hertz	Phase	FLA	MCA	MOPD
1600	48°F	63.75°F	8	208V	60	3	22.21	27.76	30

DOMESTIC WATER HEATER SCHEDULE

TAG	MANUFACTURER & MODEL No.	LOCATION	CAPACITIES			(2)PVC PIPE INTAKE/EXHAUST Ø	BTU	NOTES/ACCESSORIES
			STORAGE	RECOVERY	TD °F			
GWH-1	A.O. SMITH BTH-199	BOILER ROOM	100	288	100	4"	199,000	A B C D E F G H

NOTES AND ACCESSORIES DESIGNATION

A	P & T RELIEF TO FD	E	EXPANSION TANK
B	FLOOR MOUNTED	F	NATURAL GAS
C	POWER VENTED	G	120V/1Ø, DISCONNECT SWITCH
D	BMS CONTACT FOR REMOTE MONITORING	H	CP-1 BY BELL&GOSSETT MODEL # EROIRC XL55-45 ALL BRONZE. 20 GPM, 30" OF HEAD, 208/1Ø, .5 HP. INTERLOCK W/AQUASTAT (SET AT 110°F)

FAN SCHEDULE

TAG	MANUFACTURER & MODEL NO.	SERVICE	LOCATION	CFM	ESP °WC	FAN KEY	WHEEL TYPE	ELECTRICAL		WEIGHT POUND	NOTES/ACCESSORIES
								VOLTS /Ø	HP		
EF-1	GREENHECK CUBE-200-15	APPERATUS BAY	PITCHED ROOF	6000	0.8	RMC	BI	208/3	2	180	A B C D E
EF-2	GREENHECK SQ-95-VG	DECON REST	INLINE DUCT	480	.4	ILC	BI	120/1	1/10	45	C F H
EF-3	GREENHECK SQ-95-VG	COMPRESSOR RM	INLINE DUCT	600	.4	ILC	BI	120/1	1/10	60	G H
EF-4	GREENHECK SQ-95-VG	WORK RM	INLINE DUCT	800	.4	ILC	BI	120/1	3/4	64	G H

RMC - ROOF MOUNTED CENTRIFUGAL CLG - CEILING MOUNT ILC - INLINE CENTRIFUGAL SW - SIDE WALL	FAN KEY: FC - FORWARD CURVED BI - BACKWARD INCLINED	WHEEL KEY: FC - FORWARD CURVED BI - BACKWARD INCLINED
--	---	---

NOTES AND ACCESSORIES DESIGNATION

A	14"H PITCH ROOF CURB	G	INTERLOCK WITH THERMOSTAT THERMOSTAT SHALL BE ADJUSTABLE
B	GRAVITY BACKDRAFT DAMPER	H	VIRATION ISOLATOR HANGING KIT
C	FACTORY MOUNTED & WIRED DISCONNECT SWITCH	E	INTERLOCK WITH BMS / MAU-1
D	BIRDSCREEN	F	ON ALL THE TIME

GRILLE, REGISTER & DIFFUSER SCHEDULE

TAG	MANUFACTURER & MODEL No.	SERVICE	MOUNTING	OVERALL SIZE	NECK SIZE	NOTES/ACCESSORIES
S-1	TITUS OMNI	SAD	LAY-IN	24x24	SEE PLAN	A
S-2	TITUS OMNI	SAD	SURFACE	12x12	SEE PLAN	A
S-3	TITUS 25RL	SAD	SURFACE	SEE PLAN	SEE PLAN	A B
S-4						NOT USED
R-1	TITUS 50F	RAR	LAY-IN	24x24	----	A
R-2	TITUS 50F	RAR	LAY-IN	12x24	----	A
R-3	TITUS 25RL	RAR	SURFACE	SEE PLAN	----	A
E-1	TITUS 25RL	RAR	SURFACE	SEE PLAN	----	A
T-1	TITUS 350 RL	TAG	SURFACE	SEE PLAN	----	A

KEY:	SAD - CEILING SUPPLY DIFFUSER TAG - CEILING OR WALL TRANSFER GRILLE	RAG - CEILING OR WALL RETURN GRILLE EAG - CEILING OR WALL EXHAUST GRILLE
------	---	--

NOTES AND ACCESSORIES DESIGNATION

A	COLOR BY ARCHITECT
---	--------------------

WATER SOURCE HEAT PUMP SCHEDULE

TAG	MANUFACTURER & MODEL No.	MOUNTING	CFM	EXT. SP IN	ECM FAN HP	COOLING				HEATING			GPM	ELECTRICAL DATA				EER	NOTES/ACCESSORIES
						MBH TOTAL	MBH SENS	EWTD DEG F	LWTD DEG F	MBH	EWTD DEG F	LWTD DEG F		VOLT	ELECTRIC HEAT (KW)	MCA	MOCP		
HP-1	TRANE EXH-070	HORIZONTAL	2090	0.4	1	76.7	57.2	45	55.4	63.3	45	38.9	16.2	208/3	6.5	32.3	50	36.4	A B C D E F G
HP-2	TRANE EXH-036	HORIZONTAL	1200	0.4	3/4	41.9	31.6	45	55.8	34.1	45	38.6	8.4	208/3	5	22	25	42.2	A B C D E F G
HP-3	TRANE EXH-036	HORIZONTAL	1200	0.4	3/4	41.9	31.6	45	55.8	34.1	45	38.6	8.4	208/3	5	22	25	42.2	A B C D E F G
HP-4	TRANE EXH-036	HORIZONTAL	1200	0.4	3/4	41.9	31.6	45	55.8	34.1	45	38.6	8.4	208/3	5	22	25	42.2	A B C D E F G
HP-5	TRANE EXH-036	HORIZONTAL	1200	0.4	3/4	41.9	31.6	45	55.8	34.1	45	38.6	8.4	208/3	5	22	25	42.2	A B C D E F G
HP-6	TRANE EXH-048	HORIZONTAL	1500	0.4	3/4	55.6	41.6	45	55.9	45.0	45	38.6	11.2	208/3	6.5	28.9	30	24.2	A B C D E F G

NOTES AND ACCESSORIES DESIGNATION

A	FACTORY MOUNTED CONTROL	D	2" FILTER
B	PROVIDE VIBRATION ISOLATION HANGER	E	BUILT-IN DISCONNECT SWITCH
C	DRAIN CONDENSATE THRU OUTSIDE WALL	F	30% PROPYLENE GLYCOL
		G	BACNET CARD

GAS FIRED BOILER SCHEDULE

94.1 THERMAL EFFICIENCY (%)

TAG	MANUFACTURER & MODEL NO.	SERVICE	LOCATION	TYPE	INPUT CFH MIN/MAX	OUTPUT MBH	SUPPLY °F	TD °F	ELECTRICAL		NOTES/ACCESSORIES
									VOLTS	FLA	
B-1	THERMAL SOLUTIONS APX425C	SNOW MELT	MECH ROOM	HOT WATER	80/399	375	160	30	120/1	10	A B C D E F G H I K

NOTES AND ACCESSORIES DESIGNATION

A	CONDENSING TYPE	F	4"CONCRETE PAD	K	DISCONNECT SWITCH
B	RELIEF VALVE DRAIN TO FD	G	4 VENT, 4 INTAKE; AL29-4C MATERIALS	L	ALTERNATE # 5
C	BOILER PUMP SEE SCHEDULE (BP-1) FOR EACH BOILER	H	CONDENSATE NEUTRALIZER DRAIN		
D	PROVIDE SINGLE POWER CONNECTION	I	BACNET CARD		
E	5:1 TURNDOWN	G	30% PROPYLENE GLYCOL		

PUMP SCHEDULE

TAG	MANUFACTURER & MODEL No.	LOCATION	SYSTEM SERVED	TYPE	IMPELLER IN	CAPACITIES		MOTOR DATA			NOTES/ACCESSORIES
						GPM	HEAD	HP	VOLTS	RPM	
P-1 P-2	BELL & GOSSETT E-90-1.5AB	MECH ROOM	SNOW MELT	IN LINE	5.5	24	30	3/4	120/1	3250	A B C D
P-3 P-6	BELL & GOSSETT E-90-1.5AAB	LAUNDRY STORAGE	GEO-THERMAL HEAT PUMP	IN LINE	5	61	100	5	208/3	3600	A C D E F
BP-1	BELL & GOSSETT PL-55	MECH ROOM	B-2	IN LINE	--	25	20	2/5	120/1	3250	A B C D

NOTES AND ACCESSORIES DESIGNATION


A	30% PROPYLENE GLYCOL	D	BACNET CARD
B	INTERLOCK WITH BOILER	E	VFD
C	DISCONNECT SWITCH	F	SUSPEND FROM STRUCTURE

GAS INFRARED HEATER SCHEDULE


TAG	MANUFACTURER & MODEL No.	AREA SERVED	REFLECTIVE PATTERN ANGLE	INTAKE/FLUE SIZE	LENGTHS (FT)	GAS DATA			ELECTRICAL		NOTES/ACCESSORIES
						TYPE	MBH HIGH	MBH LOW	VOLTS	AMPS	
IRH-1 THRU IRH-10	RE-VERBER-RAY HLS-20-75	APPARATUS BAY	30	4"	20	NAT	75	50	120	4.8	A B C D E F G

NOTES AND ACCESSORIES DESIGNATION

A	TWO STAGE OPERATION	F	4"SIDE WALL VENT KIT
B	LOW INTENSITY	G	MOUNTING CHAIN KIT
C	ONE THERMOSTAT FOR ALL		
D	MOUNTING @ 16' AFF		
E	UNIT MOUNTED DISCONNECT		

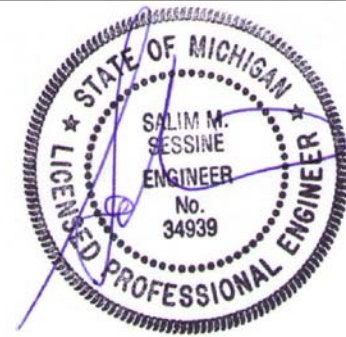

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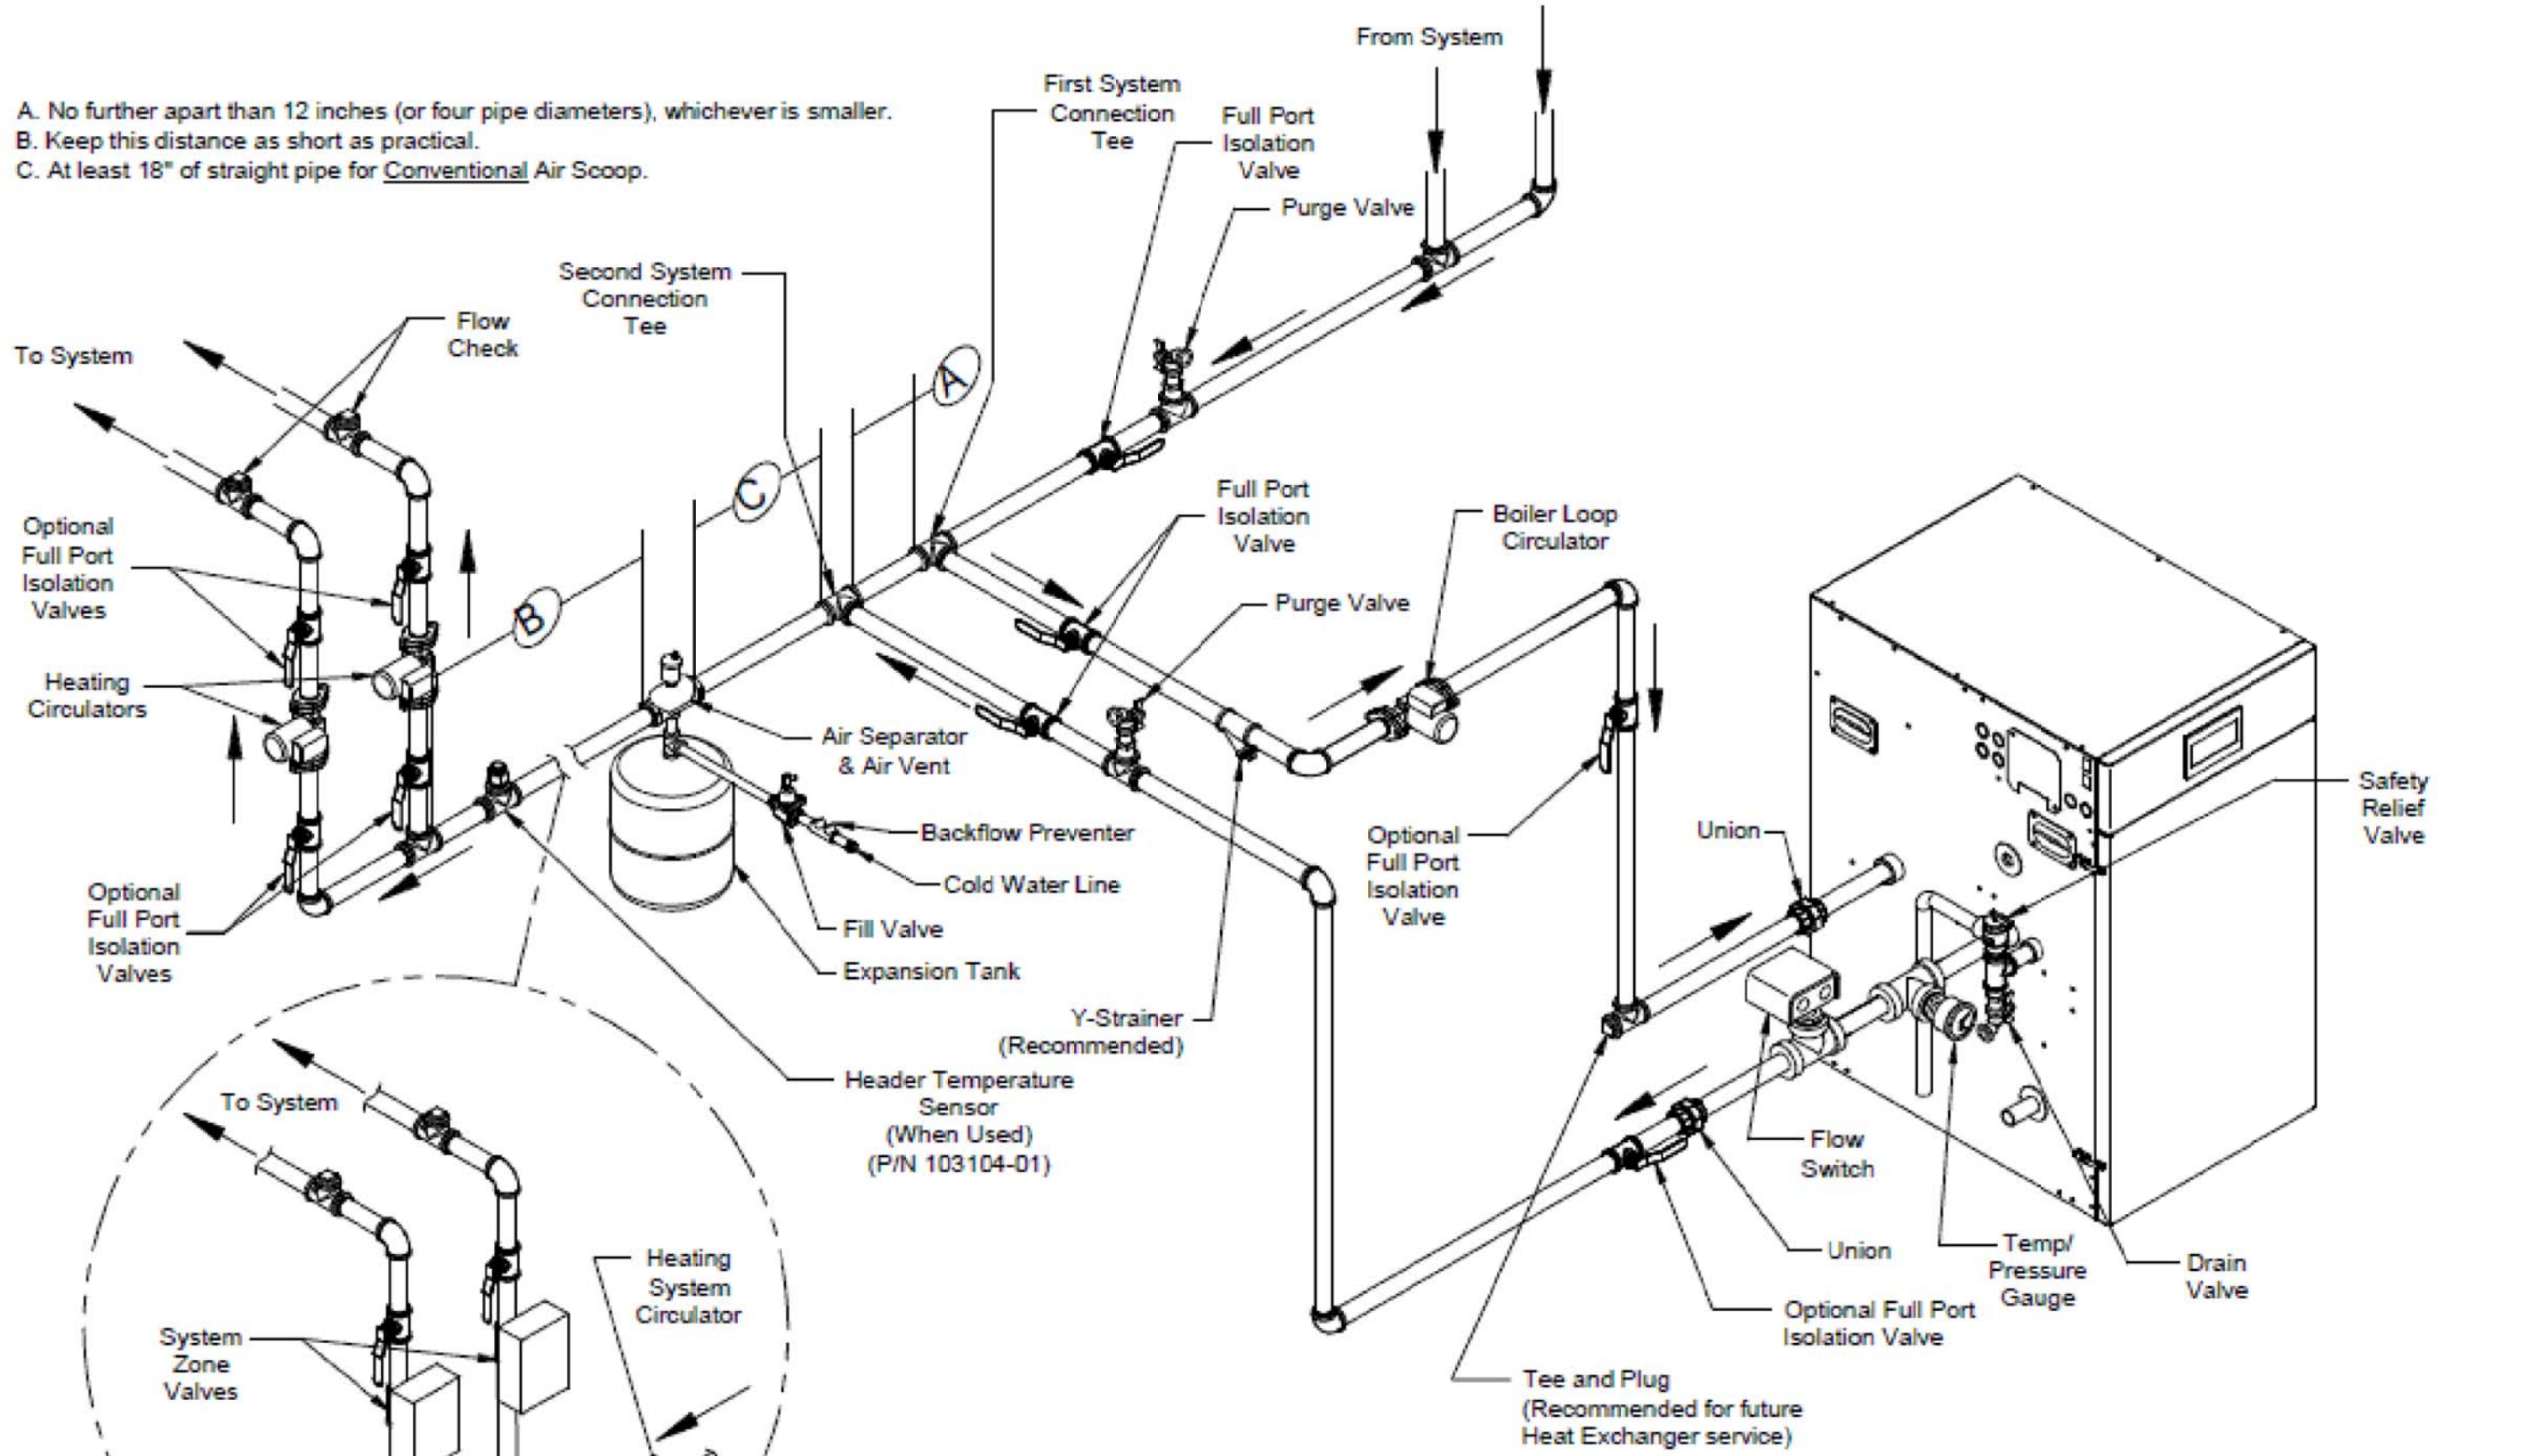
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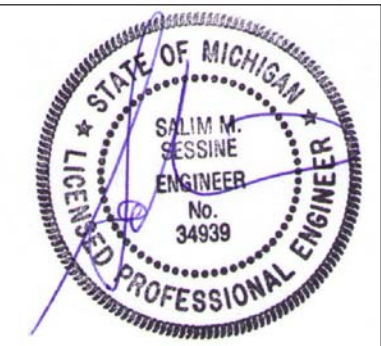
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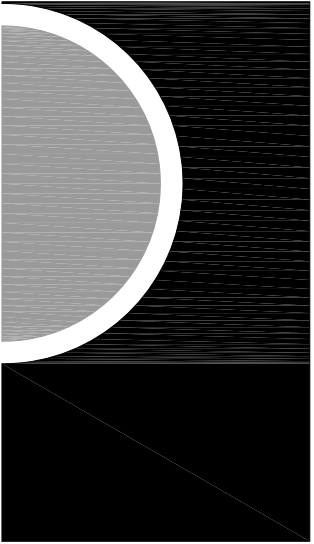
NOTES:
1. THIS DRAWING IS USED ON MULTIPLE FIGURES IN THE APEX(TS) MANUAL.
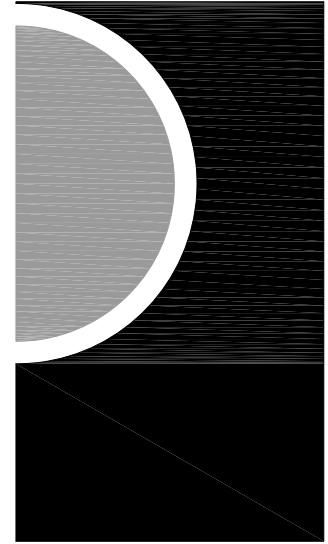
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APEX(TS)			TILE			
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LANCASTER, PA 17604-3244			DRAWING NUMBER	SCALE	DWG SIZE	SHEET
			TS-83-150	NONE	C	1 OF 1

SNOW MELT SYSTEM SCHEMATIC



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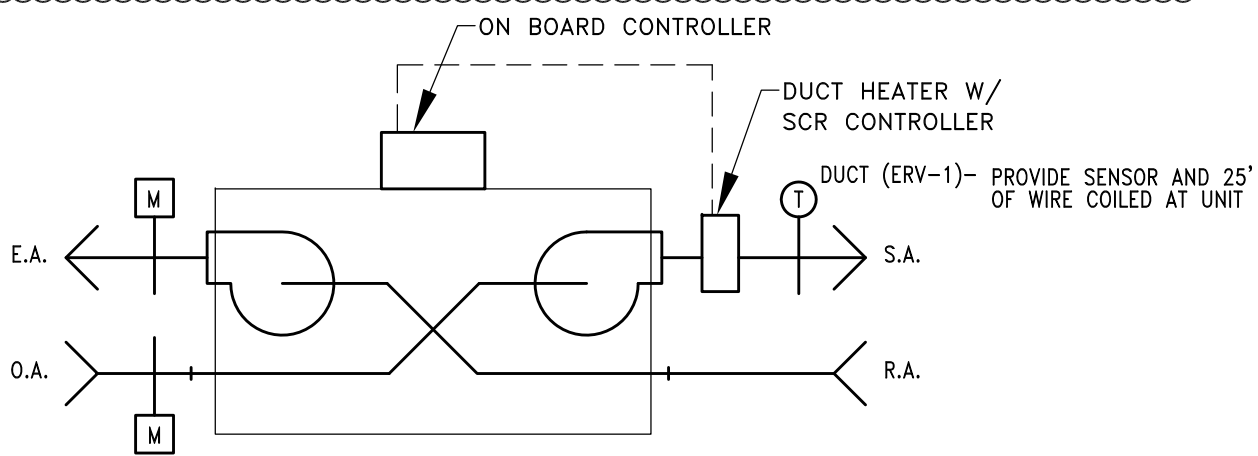
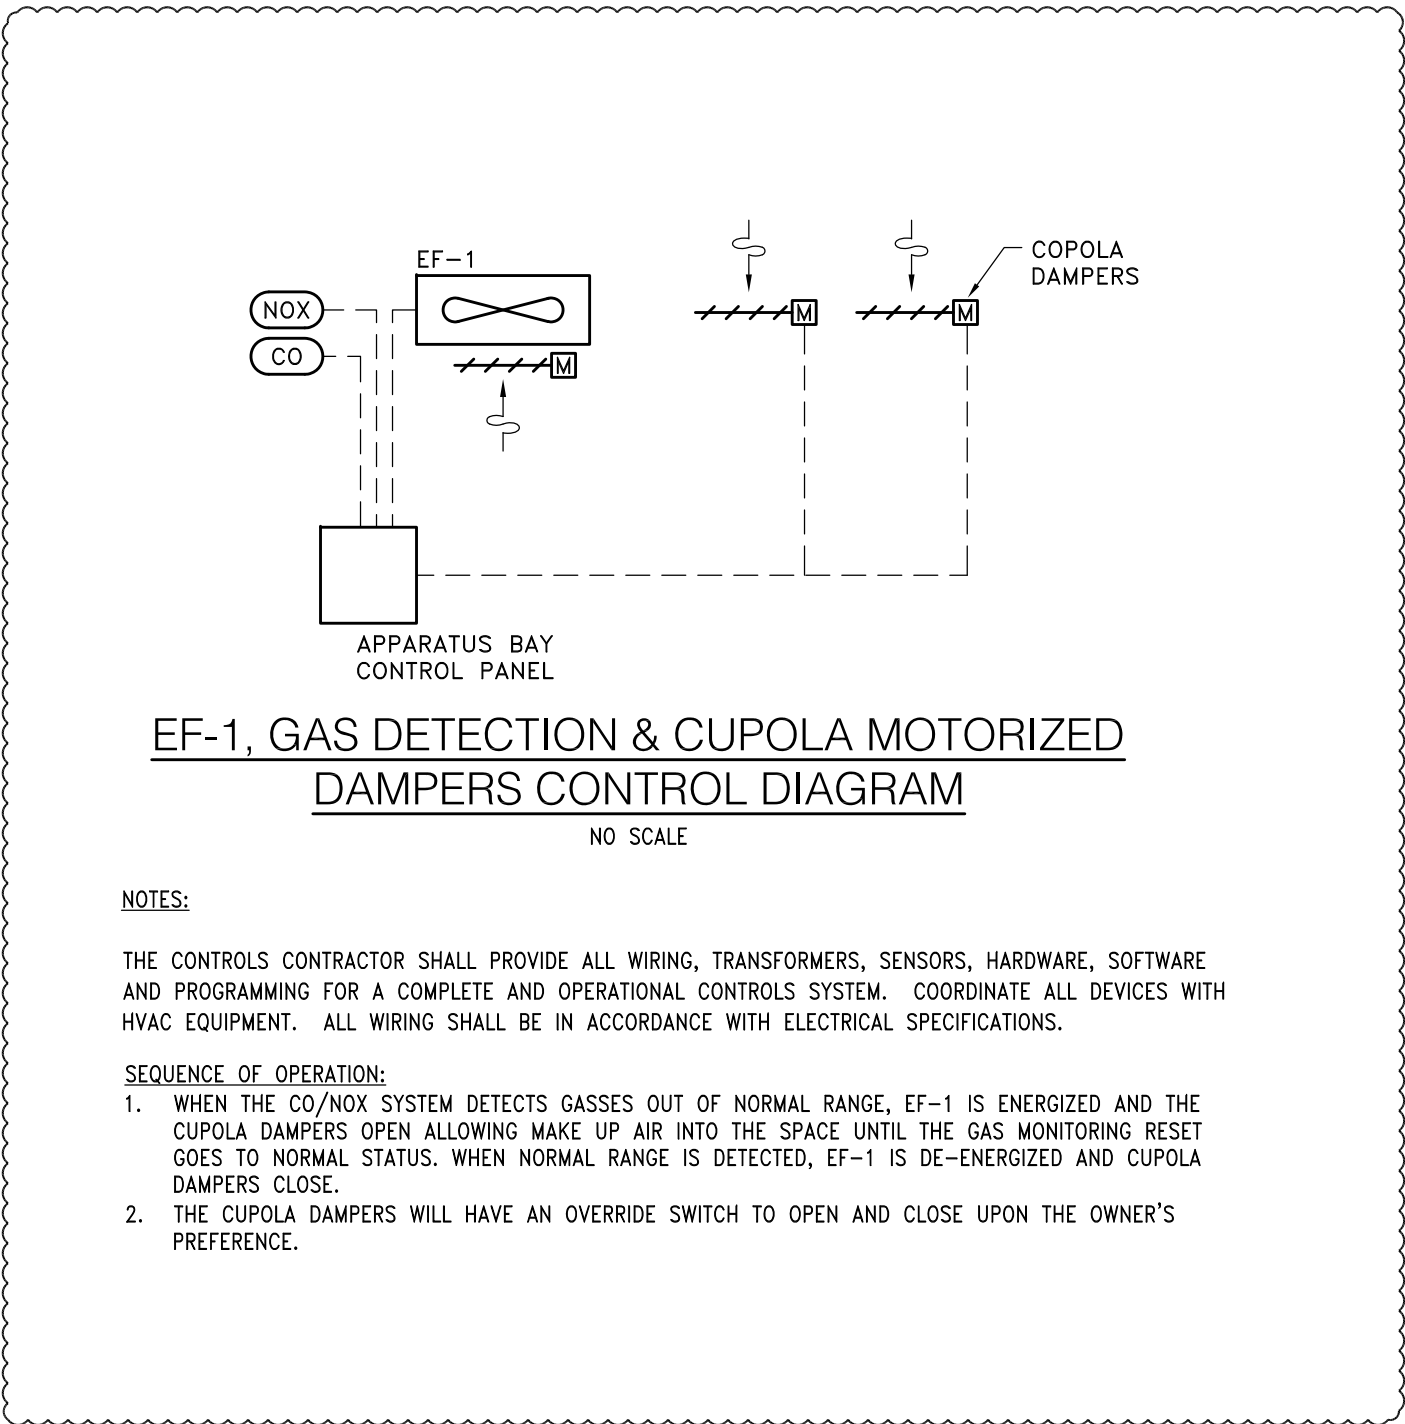
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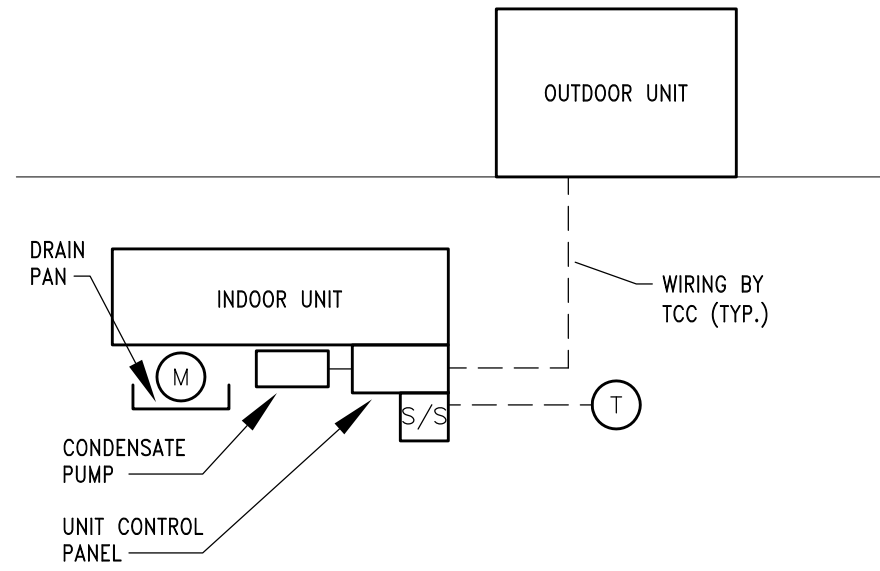
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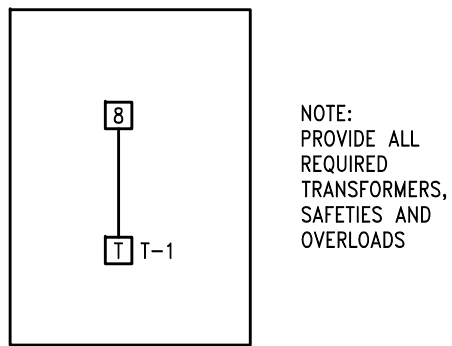
- SEQUENCE OF CONTROLS
- ERV IS STARTED THROUGH AN ON BOARD MICROPROCESSOR CONTROL.
 - DUCT HEATER SCR CONTROLLER MODULATES TO MAINTAIN SET DISCHARGE.

ERV-1 CONTROL DIAGRAM
NO SCALE




PACKAGED SPLIT SYSTEM CONTROL DIAGRAM
NO SCALE

- NOTES:
- TEMPERATURE CONTROLS CONTRACTOR (TCC) SHALL PROVIDE FIELD WIRING BETWEEN INDOOR UNIT CONTROLS AND THE REMOTE OUTDOOR UNIT. REFER TO MECH FLOOR PLANS FOR LOCATION OF UNITS.
 - TC CONTRACTOR SHALL COORDINATE WITH MANUFACTURER FOR EXACT TERMINATIONS AND WIRING REQUIREMENTS.
 - CONDENSATE PUMP HAS SELF CONTAINED LEVEL CONTROL. PUMP RECEIVES INDEPENDENT POWER.




ELECTRIC UNIT HEATER CONTROL DIAGRAM
NO SCALE

- SEQUENCE OF OPERATION:
- LOW VOLTAGE THERMOSTAT STARTS FAN AND HEATER WHEN CALLED FOR.

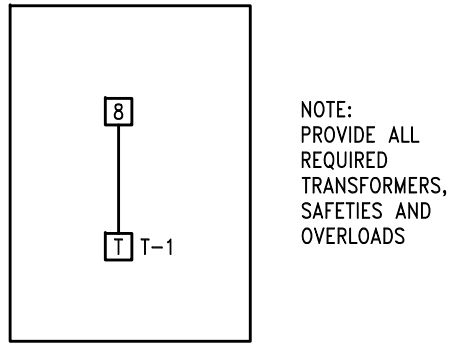


ELECTRIC CABINET UNIT HEATER CONTROL DIAGRAM
NO SCALE

- SEQUENCE OF OPERATION:
- LOW VOLTAGE THERMOSTAT STARTS FAN AND HEATER WHEN CALLED FOR.

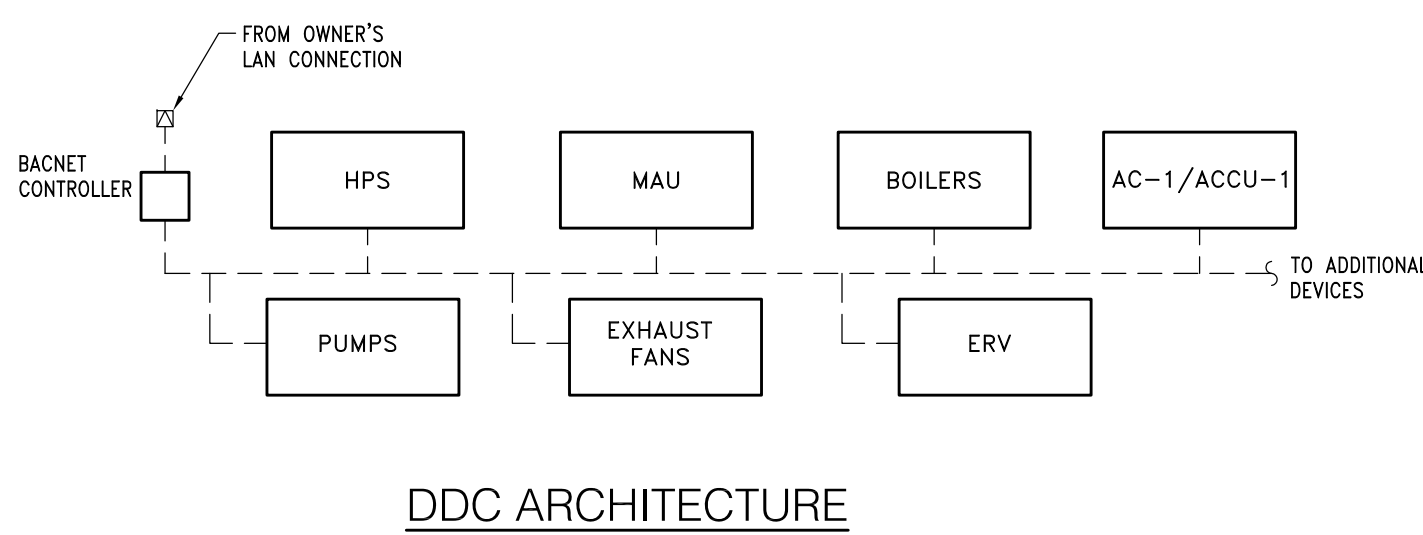


DDC ARCHITECTURE

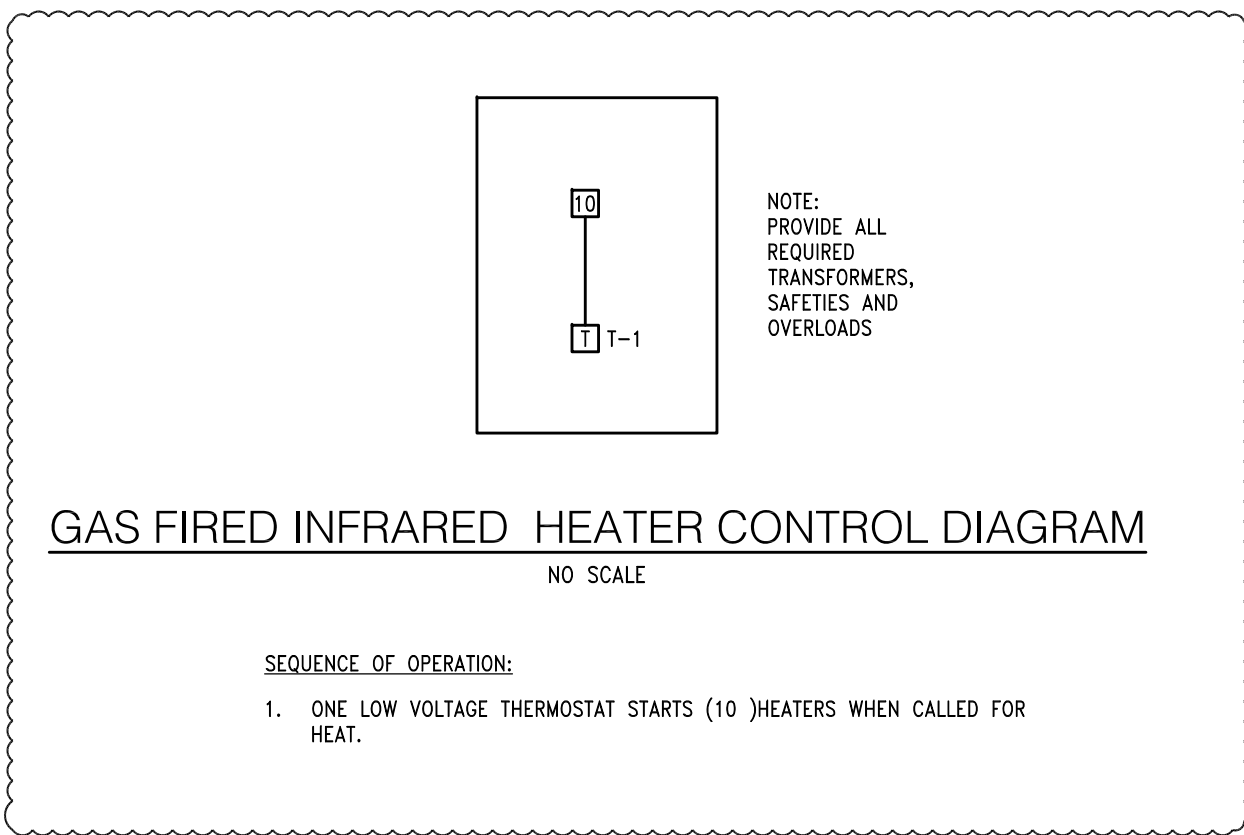


GAS FIRED INFRARED HEATER CONTROL DIAGRAM
NO SCALE

- SEQUENCE OF OPERATION:
- ONE LOW VOLTAGE THERMOSTAT STARTS (10)HEATERS WHEN CALLED FOR HEAT.

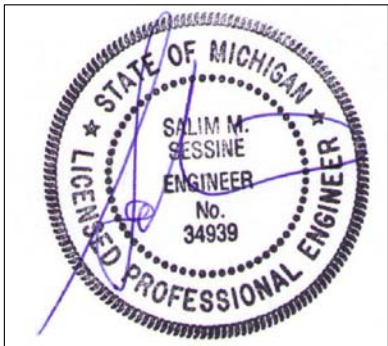

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HOT WATER HEATING SEQUENCE OF OPERATION:

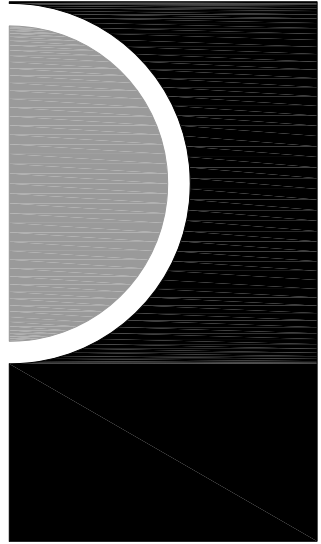NOTE: ALL SETPOINTS AND TIME INTERVALS SETPOINTS DESCRIBED IN THE SEQUENCE SHALL BE ADJUSTABLE BY SYSTEM OPERATORS (CREATE REQUIRED VIRTUAL POINTS).

HOT WATER HEATING SYSTEM CIRC PUMPS (P-1 & P-2) / (P-3 & P-4) SHALL HAVE START/STOP CAPABILITY FROM THE DDC SYSTEM. THE HAND-OFF-AUTO SWITCH SHALL BE KEPT IN THE "AUTO" POSITION. WHEN OA TEMP IS 55°F OR BELOW, ONE OF TWO SECONDARY PUMPS SHALL BE ACTIVATED BY THE DDC TO OPERATE CONTINUOUSLY. THE OTHER WILL SERVE AS STANDBY.

THE DIFFERENTIAL PRESSURE SENSOR (DPT-1) THRU THE DDC MODULATES THE ACTIVE PUMP VARIABLE SPEED DRIVE TO MAINTAIN THE DESIRED SYSTEM DIFFERENTIAL PRESSURE AS DETERMINED DURING SYSTEM BALANCING.

DDC SHALL ALTERNATE PUMP OPERATION BASED ON RUNTIME HOURS OR AT THE BEGINNING OF EACH MONTH -- OPERATOR SELECTABLE.

DDC SHALL MONITOR OPERATING STATUS OF EACH PUMP THRU ITS RESPECTIVE CURRENT SWITCH, UPON PUMP FAILURE, DDC SHALL ACTIVATE A FAILURE ALARM AND AUTOMATICALLY START THE STANDBY PUMP.

THE DDC SYSTEM ENABLES THE MASTER SEQUENCING PANEL WHEN THE OA TEMP IS 55°F OR BELOW. ABOVE 55°F THE DDC DISABLES THE SYSTEM.

THE MASTER SEQUENCING PANEL SHALL ACTIVATE OR DEACTIVATE BOILERS AND BOILER STAGES AS REQUIRED TO MAINTAIN HHW SUPPLY TEMP (T-1) SETPOINT.


THE MASTER SEQUENCING PANEL SHALL INCLUDE OPERATOR SELECTABLE BOILER LEAD/LAG OPERATION OR FIRST ON/FIRST OFF OPERATION.

WHENEVER A BOILER CIRCUIT IS ACTIVATED, ITS RESPECTIVE PRIMARY CIRCULATION PUMP SHALL BE ACTIVATED BY FACTORY WIRED PUMP RELAY. WHENEVER A BOILER IS DEACTIVATED, A TIME DELAY RELAY SHALL KEEP THE PUMP RUNNING FOR 10 MINUTES (ADJUSTABLE) TO DISSIPATE HEAT FROM THE DEACTIVATED BOILER.


WHEN A BOILER IS ACTIVATED, BOTH SETS OF COMBUSTION AIR DAMPERS SHALL BE OPENED THRU HARDWIRED INTERLOCK. WHEN THE DAMPERS OPEN, END SWITCHES MAKE, AND THE BOILERS ARE ALLOWED TO START.

DDC SHALL MONITOR BOILER RUN STATUS AND BOILER FAILURE ALARM AT EACH BOILER THROUGH DRY CONTACTS AVAILABLE IN THE BOILER CONTROL PANEL. BOILER FAILURE MONITORING SHALL INCLUDE "LOW WATER" AND "FLAME FAILURE".

THE EMERGENCY STOP PUSH BUTTON(S), LOCATED AT EACH BOILER ROOM DOOR(S), DEACTIVATES EACH BOILER WHENEVER THE PUSH BUTTON IS ACTIVATED. THE BOILERS REMAIN DE-ACTIVATED UNTIL THE PUSH BUTTON(S) IS MANUALLY RESET.

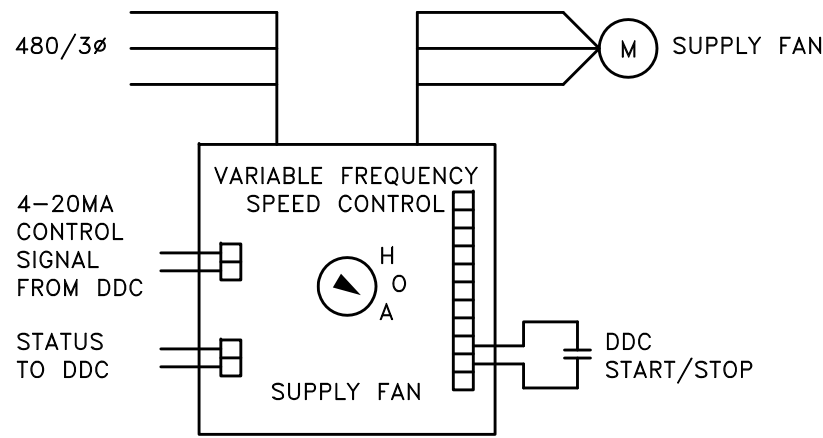

TYPICAL PUMP VFD
ELECTRIC SCHEMATIC
NO SCALE

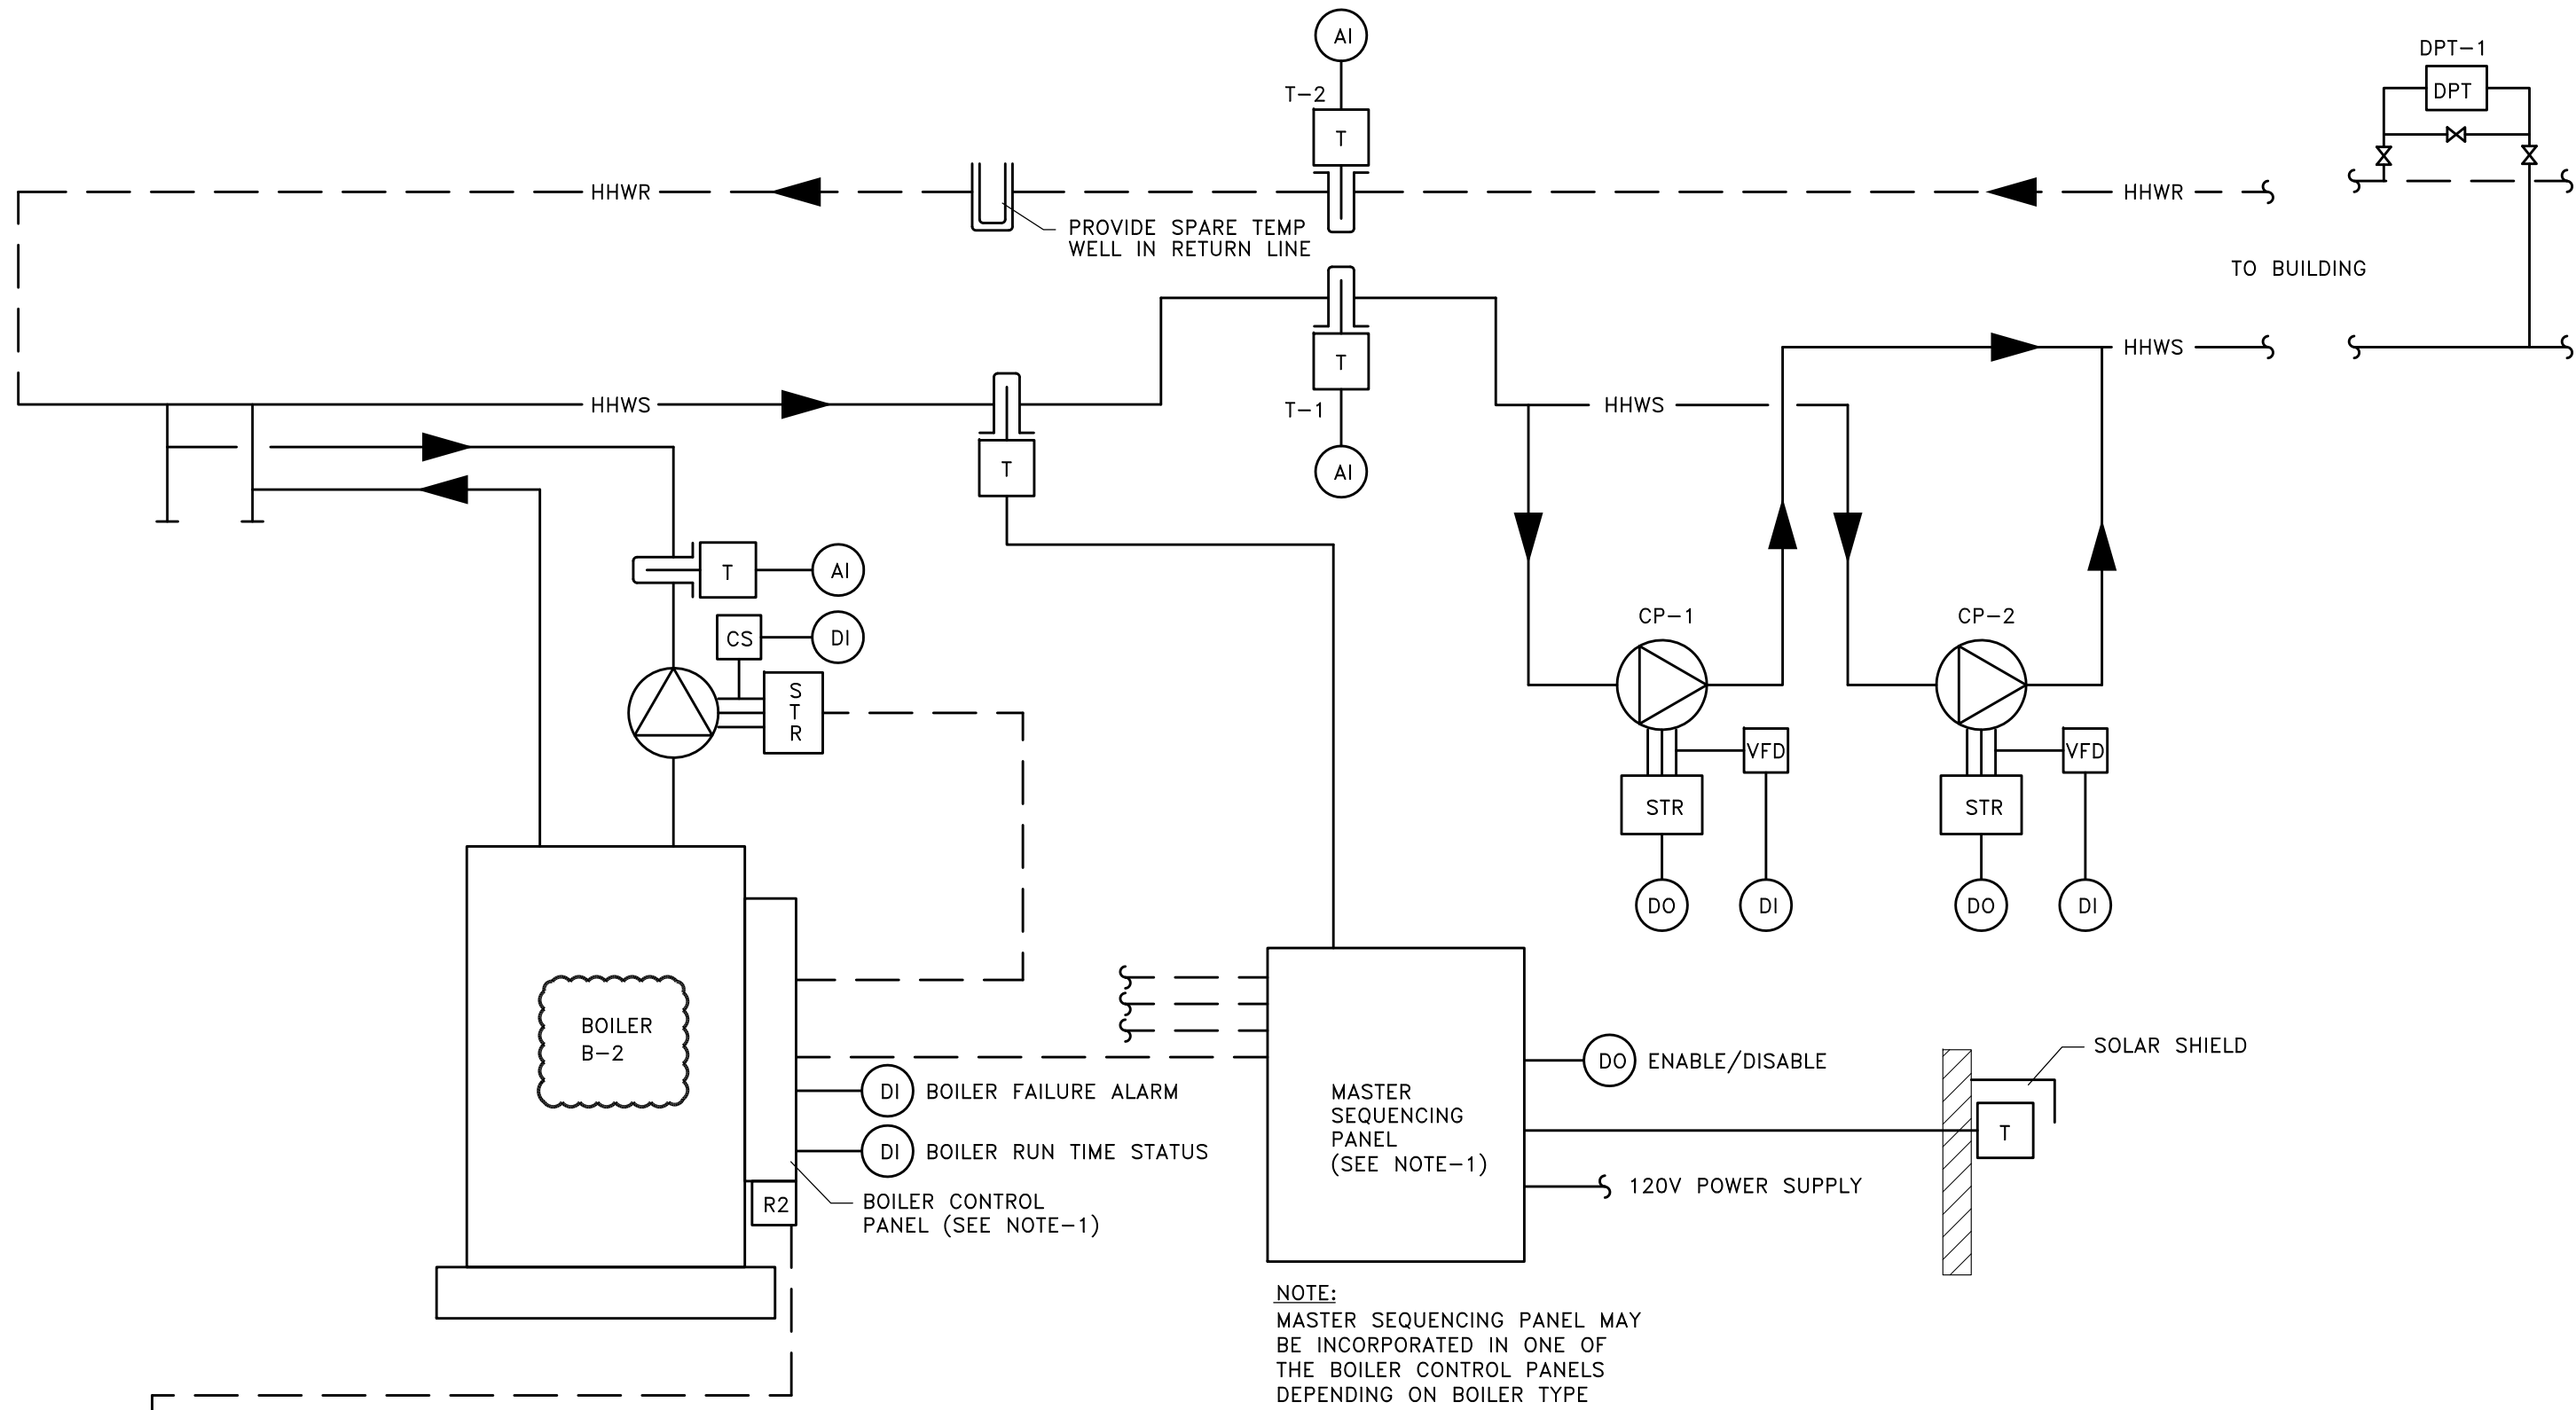

NOTE:
MASTER SEQUENCING PANEL MAY
BE INCORPORATED IN ONE OF
THE BOILER CONTROL PANELS
DEPENDING ON BOILER TYPE

HHWS TEMP. RESET SCHEDULE	
OUTSIDE AIR TEMP	HOT WATER SUPPLY TEMPERATURE
≤ 0° F	180° F
≥ 60° F	130° F

RESET SCHEDULE SHALL BE ADJUSTABLE

NOTE:
1. FURNISHED BY BOILER MANUFACTURER.


TYPICAL EMERGENCY STOP
PUSH BUTTON LOCATED AT
EACH BOILER ROOM DOOR

	HARDWARE								SOFTWARE									
	OUTPUT				INPUT													
	DIGITAL		ANALOG		DIGITAL		ANALOG											
	CONTROL RELAY	POSITION ADJUSTMENT	4-20ma	CONTACT CLOSURE	TEMPERATURE	% RELATIVE HUMIDITY	PSIG, PSIA, PSID, IN, H2O	FLOW	CO2	SCHEDULED S/S	ECONOMIZER	ENTHALPY	RUN TIME	DAY/NIGHT SET BACK	WARM UP CYCLE	SMOKE CONTROL	TREND LOG CAPABILITY	SYSTEM GRAPHICS
HEATING SYSTEM																		◆
PRIMARY PUMP				4								◆						
BOILER FAILURE ALARM				4														
BOILER RUN STATUS				4									◆					
BOILER DISCH TEMP					4												◆	
SECONDARY PUMP	4			4						◆		◆						
TERTIARY PUMP	2			2						◆		◆						
TERTIARY VFD FAULT				2														
GLYCOL WATER S TEMP					1												◆	
GLYCOL WATER R TEMP					1												◆	
HHWS TEMP					1												◆	
HHWR TEMP					1												◆	
BOILER E-STOP				1														

ROOFTOP UNIT POINTS ARE OBTAINED VIA BACNET WORKS INTERFACE.
COORDINATE WITH RTU MANUFACTURER.

GENERAL NOTES

- 120 VOLT POWER FROM STARTER TRANSFORMER
- DENOTES TERMINAL AT STARTER
- DENOTES TERMINAL AT CONTROL PANEL
- DENOTES FIELD WIRING
- DENOTES WIRING IN STARTER OR IN CONTROL PANEL
- DENOTES TERMINAL AT DEVICE

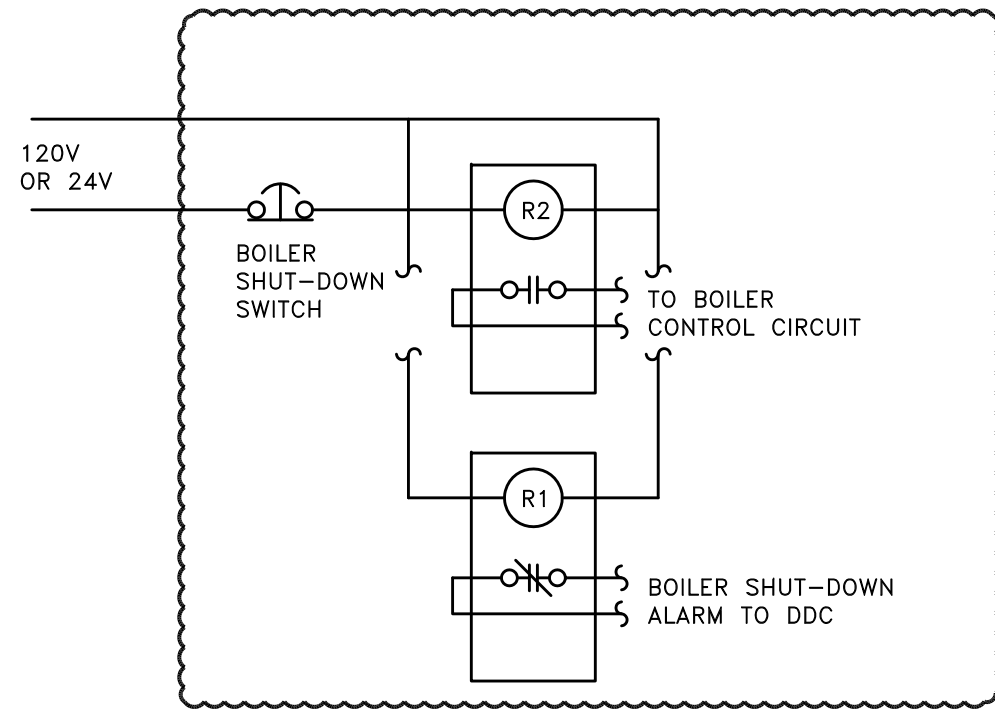

REMOTE BOILER EMERGENCY SHUTDOWN WIRUNG
NO SCALE


NOTES:

- LOCATE A SWITCH AT EACH ENTRANCE JUST INSIDE BOILER ROOM. REFER TO FLOOR PLANS FOR QUANTITY AND LOCATION OF ROOM ENTRANCES. COORDINATE SWITCH LOCATION WITH ALL OTHER TRADES.
- TEMPERATURE CONTROLS (TCC) SHALL PROVIDE SIGN (NAME PLATE) TO BE PLACED DIRECTLY ABOVE OR BELOW EACH PUSH BUTTON SWITCH THAT READS: "EMERGENCY BOILER SHUTDOWN".
- TCC SHALL SUPPLY POWER TO CONTROL RELAY FROM EMERGENCY POWER CIRCUIT. REFER TO ELECTRICAL PANEL SCHEDULES AND COORDINATE WITH ELECTRICAL CONTRACTOR AS NECESSARY.
- TCC SHALL WIRE BOILERS' CONTROL CIRCUITS (POWER FROM SECONDARY SIDE OF CONTROL TRANSFORMERS) THRU NORMALLY OPEN RELAY CONTACTS. TCC SHALL COORDINATE EXACT WIRING AND TERMINATION REQUIREMENTS WITH BOILER MANUFACTURER.
- TCC SHALL MOUNT SHUTDOWN CONTROL RELAYS AT RESPECTIVE BOILER CONTROL PANELS.
- TCC SHALL PROVIDE PUSH BUTTON SWITCH (PUSH TO LATCH - TURN KEY OR PULL TO RELEASE) WITH MUSHROOM HEAD OPERATOR AND NORMALLY CLOSE (NC) CONTACTS. PROVIDE WITH PROPER ENCLOSURE.


SEQUENCE OF OPERATION:

UNDER NORMAL OPERATING CONDITIONS THE CIRCUIT SHALL BE ENERGIZED AND THE RELAYS NORMALLY OPEN (NO) CONTACTS SHALL BE CLOSED. WHEN A SWITCH IS PUSHED (LATCHED) THE RELAY CONTACTS SHALL OPEN AND INTERRUPT EVERY BOILER'S CONTROL CIRCUIT. WHEN SWITCH IS RELEASED, THE RELAY SHALL BE ENERGIZED AND ITS NORMALLY OPEN CONTACTS SHALL CLOSE, ENERGIZING EVERY BOILER'S CONTROL CIRCUIT.

DDC SHALL ACTIVATE AN ALARM WHEN REMOTE SWITCH HAS BEEN PUSHED.

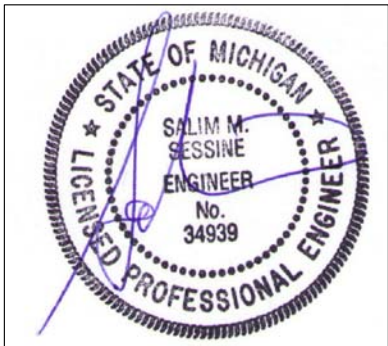

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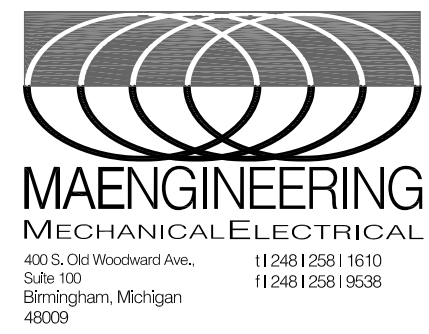
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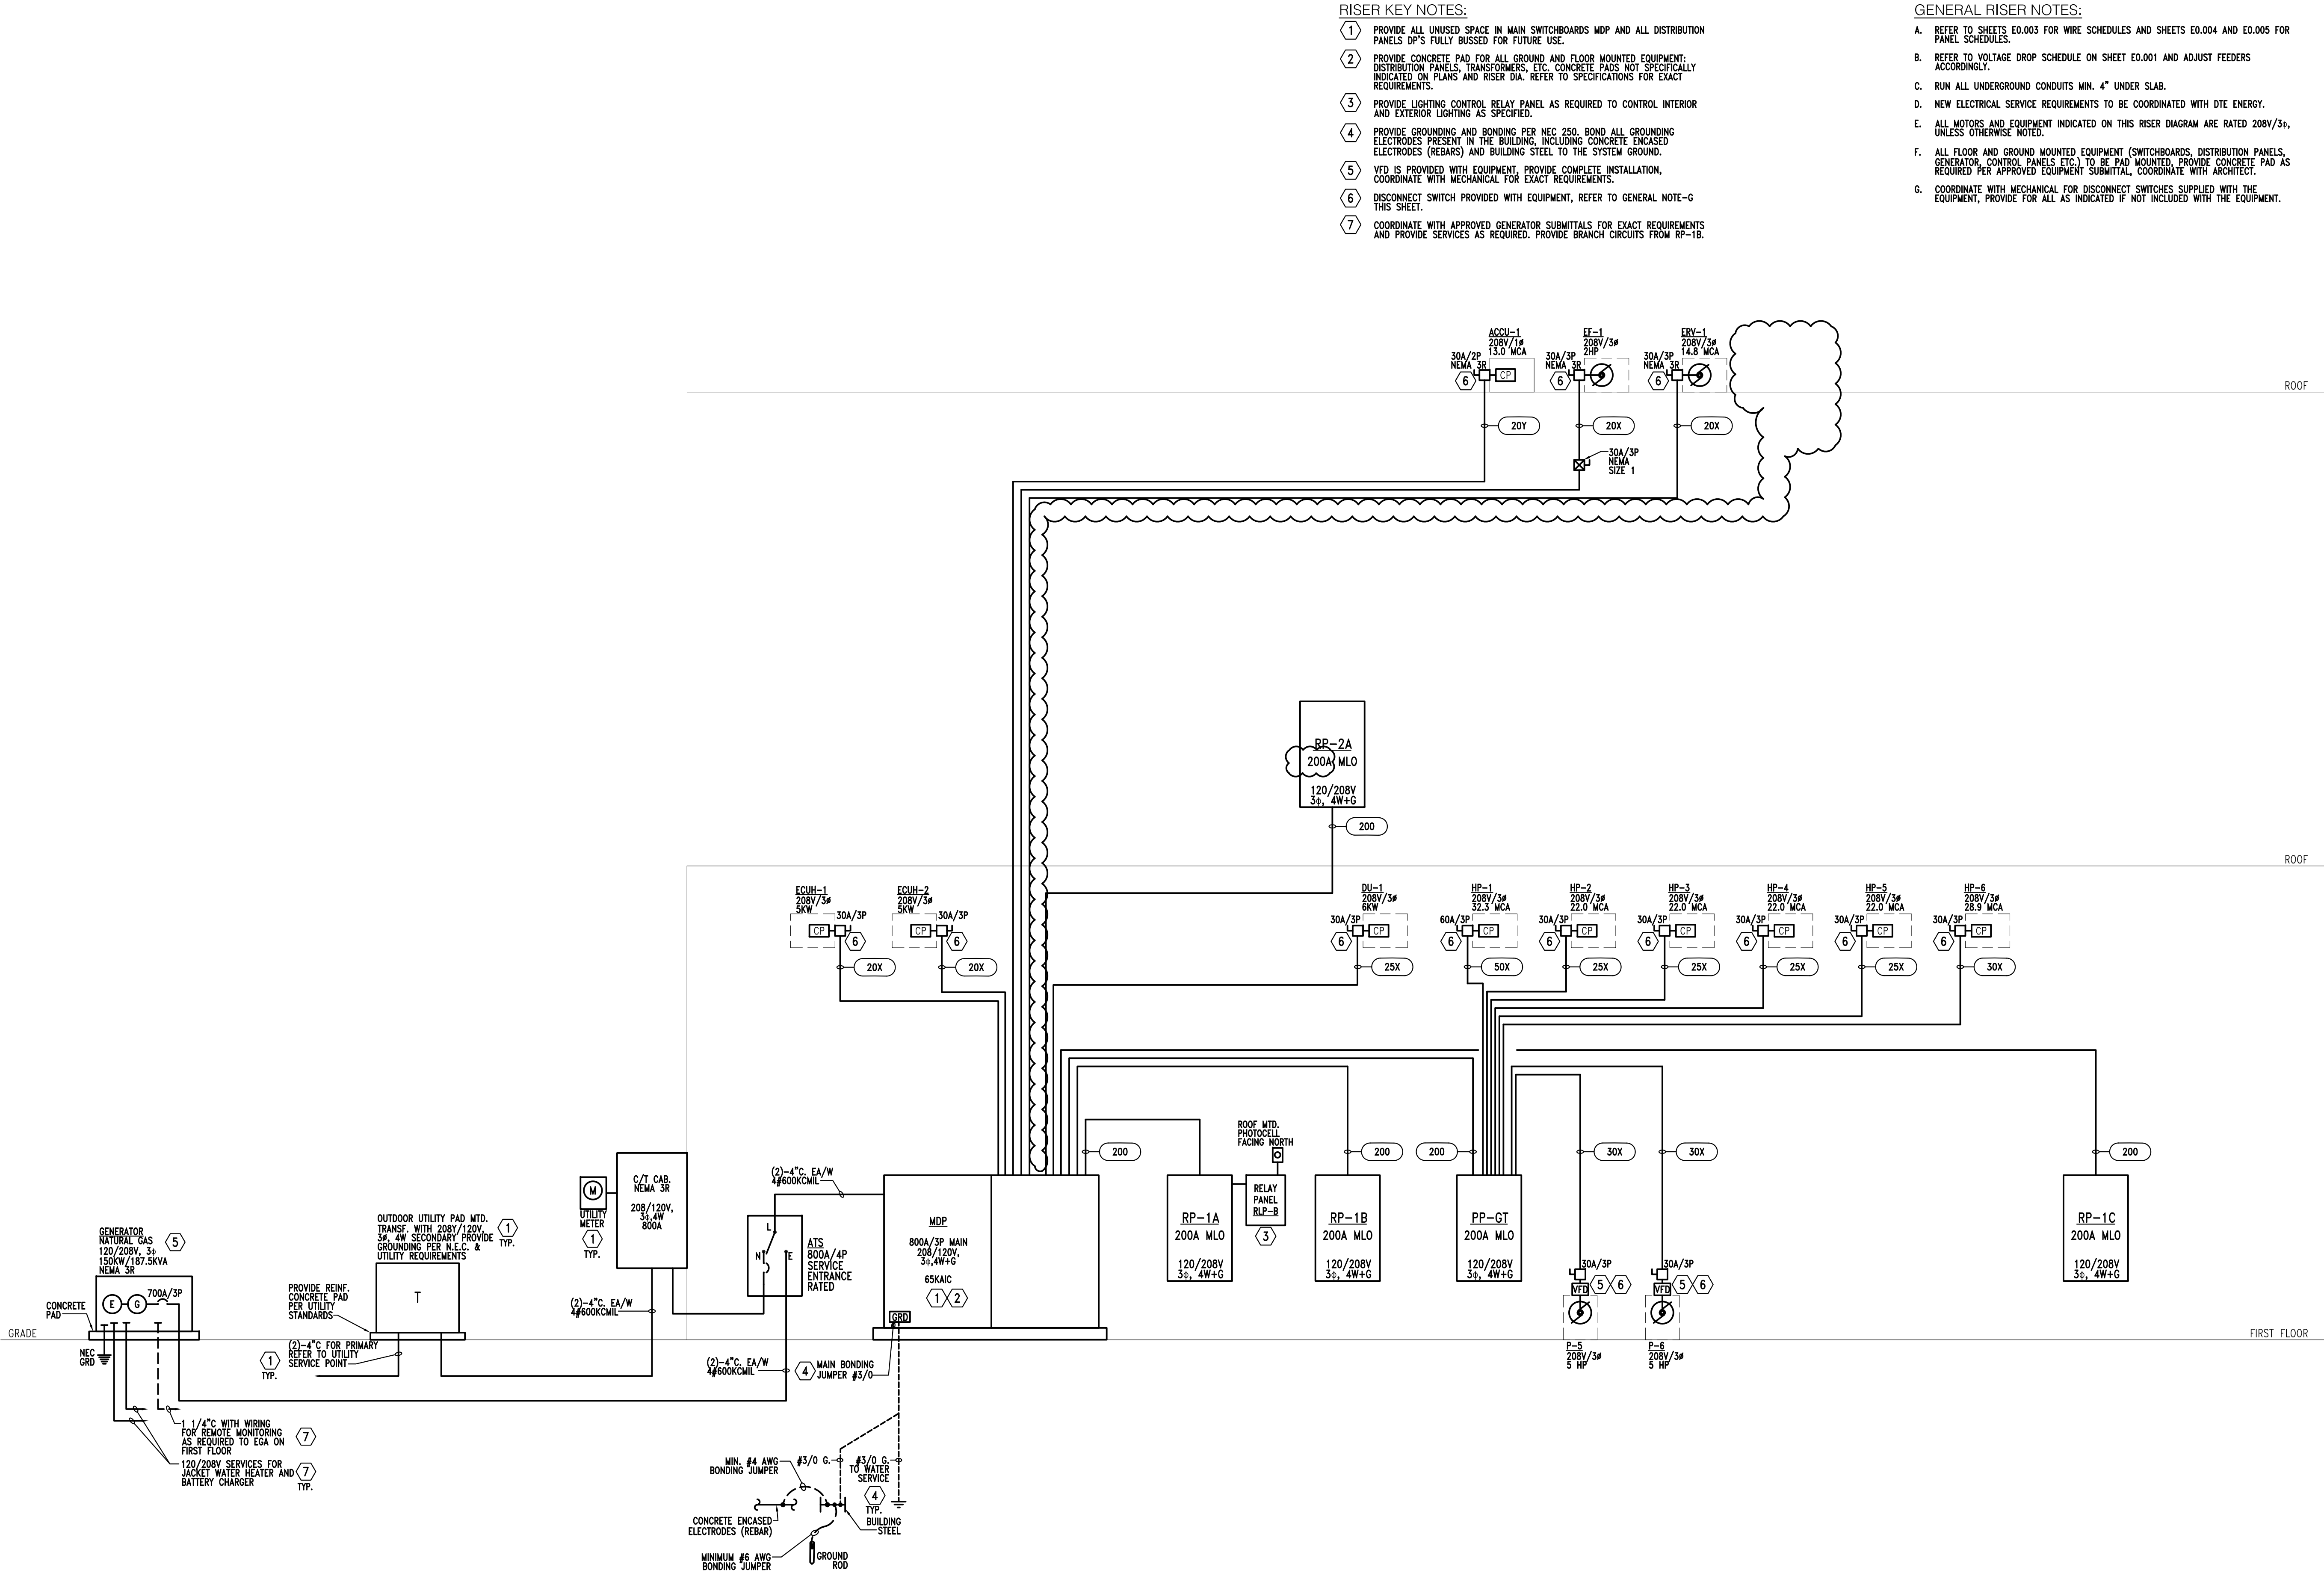
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TEMPERATURE
CONTROLS

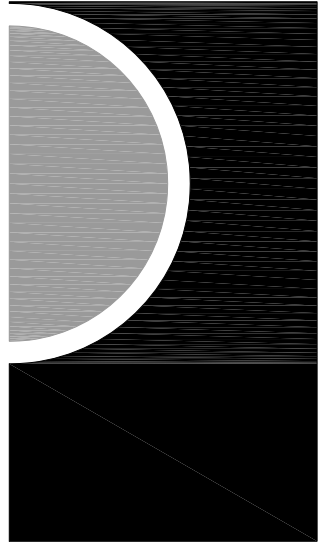SHEET NO.


M6-02



1
E0-02
ELECTRICAL RISER DIAGRAM
Scale: No Scale



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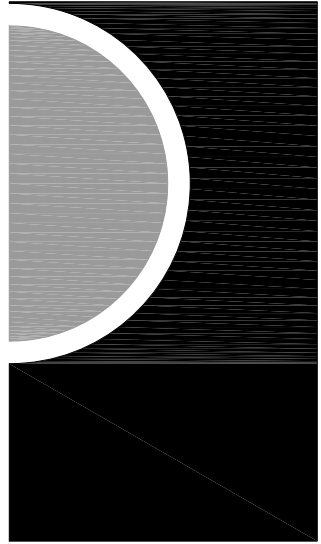
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ELECTRICAL RISER
DIAGRAM
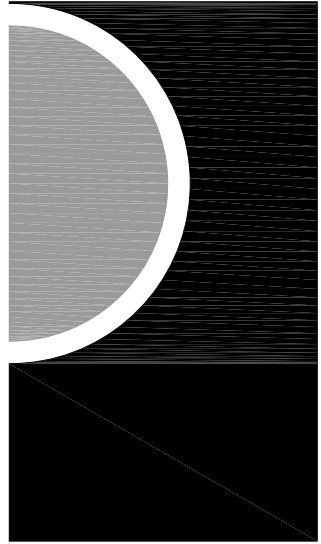
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65 MARKET STREET
MOUNT CLEMENS, MI 48043
P 586.463.3600
F 586.463.3607

Statement of Intellectual Property

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CONSULTANT



KEY PLAN

OWNER

Highland Township
Fire Department

PROJECT NAME

Highland Township
Fire Station No. 11600 W. Highland Rd.
Highland, MI 48357

PROJECT NO.

18-122A

ISSUES / REVISIONS

SCHEMATIC DESIGN 01-28-2020

BIDDING-CONSTRUCTION 03-27-2020

CONSTRUCTION 05-04-2020

CCD #1 06-03-2020

DRAWN BY

NH

CHECKED BY

EK

APPROVED BY

EK


SHEET NAME

ELECTRICAL PANEL
SCHEDULES

SHEET NO.


E0-04

PROJECT:		HIGHLAND TWP FS-1			200A		MLO		CLASS:		208/120V,3PH,4W+G.		PANEL:		
PROJ NO:		75810		DATE		VA		06/04/20		MOUNTING:		SURFACE		PP-GT	
BRANCH CIRCUIT		NO.		POLES		BKR		BUS A		BUS B		BUS C		REMARKS	
1		3						3325		3325		3325		HP-1	
3		3								3325				32.6 MCA	
5		3		50										HP-2	
7		3				2244								22.0 MCA	
9		3						2244		2244				22.0 MCA	
11		3		25				2244						HP-3	
13		3				2244				2244				22.0 MCA	
15		3						2244						HP-4	
17		3		25				2244		2244				22.0 MCA	
19		3				2244								HP-5	
21		3		25						2244				22.0 MCA	
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2 Mezzanine Level Floor Plan - Power
1/8" = 1'-0"

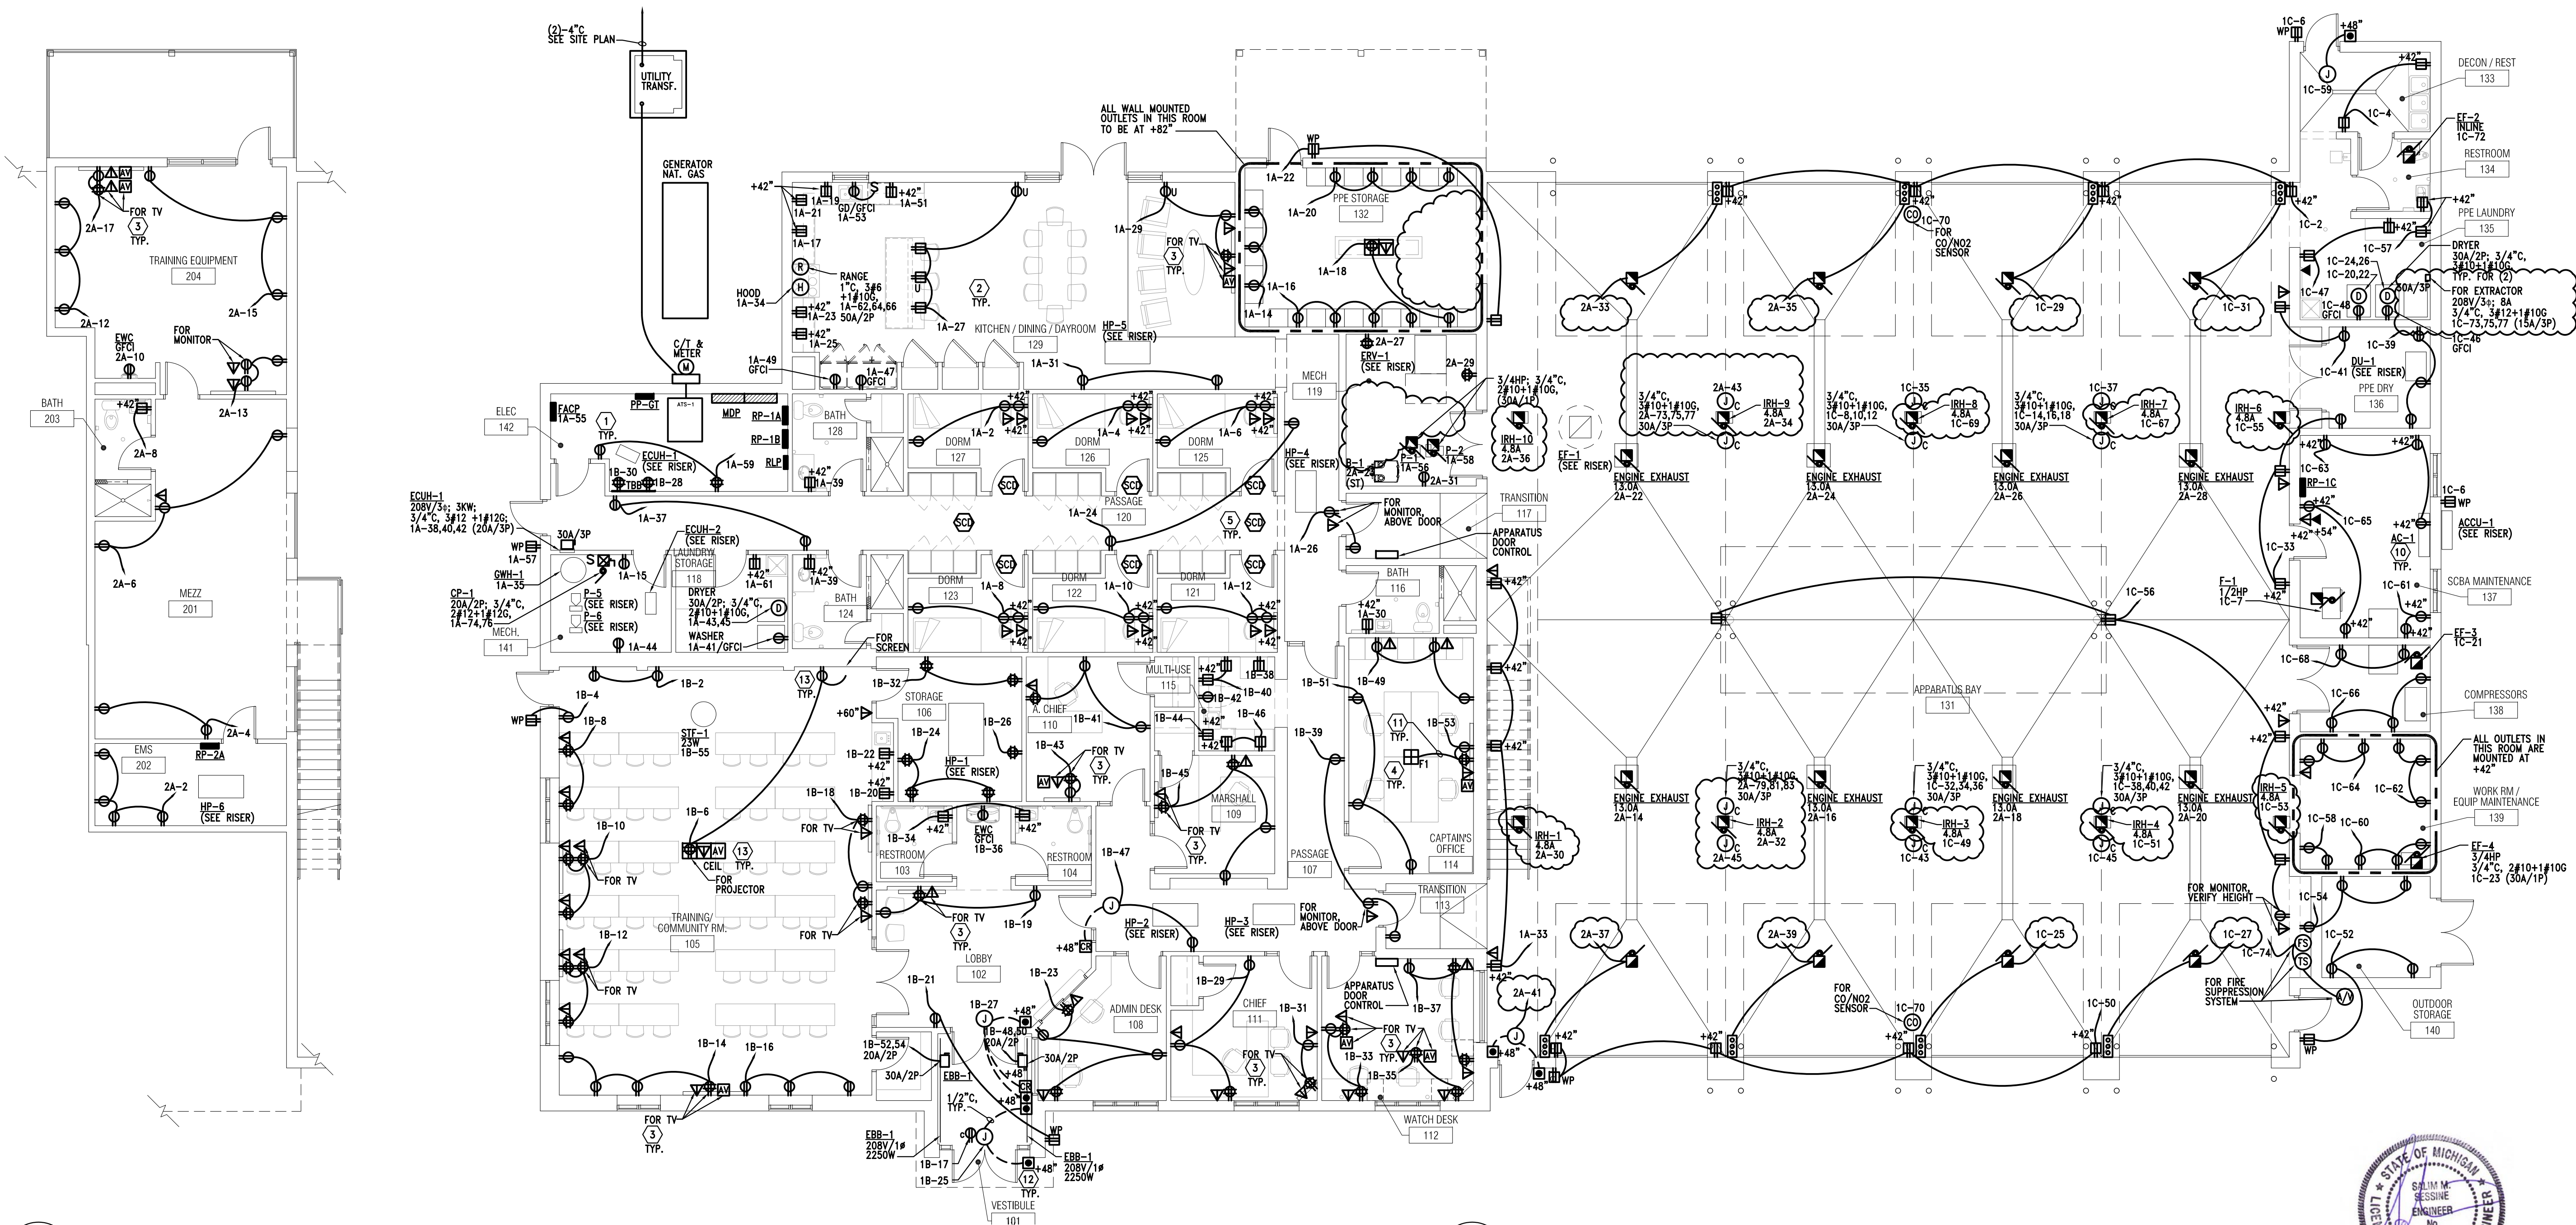1 Main Level Floor Plan - Power
1/8" = 1'-0"




KEYED POWER NOTES:

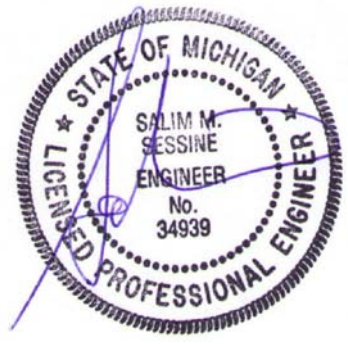- 1 EXACT LOCATION AND REQUIREMENTS FOR EQUIPMENT TO BE COORDINATED WITH EQUIPMENT VENDOR. APPROVED SUBMITTALS AND NAMEPLATE DATA. INFORMATION INDICATED ON THESE PLANS IS FOR REFERENCE ONLY.
- 2 ALL RECEPTACLES LOCATED WITHIN 6'-0" OF A WATER SOURCE AND ALL IN THE KITCHENS SHALL BE GFI TYPE. PROVIDE GFI RECEPTACLES REGARDLESS OF SYMBOL USED ON PLAN FOR THESE LOCATIONS. FOR LOCATIONS THAT ARE NOT ACCESSIBLE, LOCATE BLANK PLATE GFI ABOVE THE RECEPTACLE AT +42" AFF OR NEAR ROOM WALL SWITCH(ES) OR PROVIDE GFI BRANCH BREAKERS IN PANELBOARDS AS DIRECTED BY OWNER TO COMPLY WITH NEC 210.8.
- 3 DUPLEX RECEPTACLES AND DATA OUTLETS FOR FLAT SCREEN TV SHALL BE MOUNTED AT 5'-0" AFF UNLESS OTHERWISE NOTED. COORDINATE WITH ARCHITECT/OWNER FOR EXACT QUANTITIES, LOCATIONS AND MOUNTING HEIGHTS.
- 4 EXACT LOCATIONS FOR ALL FLOOR OUTLETS TO BE COORDINATED WITH ARCHITECT/OWNER.
- 5 PROVIDE (2)-20A/1P, 120V DEDICATED BRANCH CIRCUITS FOR ALL FIRE/SMOKE DAMPERS, WIRE TO RP-1A-** REFER TO PANEL SCHEDULES, COORDINATE AND REFER TO MECHANICAL DRAWINGS FOR EXACT LOCATIONS AND QUANTITIES. NOT ALL FIRE/SMOKE DAMPERS ARE INDICATED ON THESE PLANS.
- 6 COORDINATE WITH MECHANICAL FOR EXACT REQUIREMENTS FOR FIRE PROTECTION SYSTEM, INCLUDING NUMBER OF FLOW/TAMPER SWITCHES.
- 7 PROVIDE POWER FOR DRY PIPE SYSTEM COMPRESSOR, COORDINATE EXACT LOCATION AND REQUIREMENTS WITH FIRE SUPPRESSION CONTRACTOR. LOCATION INDICATED ON PLAN IS FOR REFERENCE ONLY.
- 8 EXACT LOCATIONS FOR FIRE ALARM CONTROL AND ANNUNCIATOR PANELS AND SECURITY SYSTEM PANELS TO BE COORDINATED WITH ARCHITECT/OWNER. PROVIDE FLUSH MOUNTING FOR ALL, UNLESS LOCATED IN UNFINISHED SPACES.
- 9 EXACT LOCATIONS FOR ALL ELECTRICAL EQUIPMENT TO BE COORDINATED, REFER TO GENERAL NOTE-F.
- 10 INDOOR AC UNIT IS FED FROM THE OUTDOOR ACCU UNIT, COORDINATE WITH MECHANICAL FOR COMPLETE INSTALLATION REQUIREMENTS, INCLUDING INTERWIRING OF THE UNIT.
- 11 RUN 1 1/4" C FROM LOW VOLTAGE COMPARTMENT BETWEEN FLOOR BOX AND MONITOR BOX, RUN CONCEALED IN CEILING AND WALL. COORDINATE WORK WITH SUITE BELOW.
- 12 PROVIDE DOUBLE GANG J-BOX WITH SINGLE MUD RING 48" AFF FOR CARD READER AND DOOR PUSH BUTTON, RUN 1 1/2" C FROM CARD READER/PUSH BUTTON TO DOOR OPERATOR OR STRIKE ACTUATOR FOR LOW VOLTAGE WIRING. PROVIDE 120V POWER IN THE CEILING FOR DOOR OPERATOR OR STRIKE AS INDICATED. FOR MORE DETAILS REFER TO SHEET ES-01. ALSO PROVIDE REQUIRED WIRING FOR INTERCOM REMOTE UNLOCK SYSTEM COORDINATE WITH DOOR INSTALLER.
- 13 PROVIDE POWER, DATA/AV AND CONTROLS FOR PROJECTOR AND PROJECTION SCREEN. EXACT LOCATIONS AND REQUIREMENTS TO BE COORDINATED WITH ARCHITECT/OWNER.

GENERAL POWER NOTES:

- A. REFER TO SHEET E.001 FOR ELECTRICAL LEGEND.
- B. PROVIDE COMPLETE ADDRESSABLE FIRE ALARM SYSTEM FOR THE BUILDING. FIRE ALARM SYSTEM SHALL INCLUDE ALL CONTROL, MONITORING, POWER SUPPLIES, INITIATING DEVICES, INDICATING APPLIANCES, CONTROL MODULES AND WIRING AS REQUIRED BY AUTHORITIES HAVING JURISDICTION FOR AN APPROVED INSTALLATION. REFER TO SPECIFICATIONS. SYSTEM SHALL BE LAYED OUT ON A PERFORMANCE BASIS, DEVICES INDICATED ON PLANS ARE FOR REFERENCE ONLY.
- C. PROVIDE FIRE STOPPING SYSTEM WHERE REQUIRED TO MAINTAIN THE FIRE RESISTANCE RATING OF THE ASSEMBLIES.
- D. EXACT LOCATIONS AND REQUIREMENTS FOR ALL EQUIPMENT SHALL BE VERIFIED WITH ARCHITECT/OWNER AND EQUIPMENT SUPPLIER PRIOR TO INSTALLATION.
- E. COORDINATE EXACT LOCATIONS, MOUNTING HEIGHTS & REQUIREMENTS FOR ALL DEVICES WITH LATEST ARCHITECTURAL FURNITURE & EQUIPMENT LAYOUTS & ELEVATIONS.
- F. COORDINATE EXACT LOCATIONS FOR ALL ELECTRICAL EQUIPMENT, PANELBOARDS, DISCONNECTS, STARTERS, CONTROL, PANELS, ETC. WITH ARCHITECTURAL PLANS AND ALL OTHER TRADES INCLUDING MECHANICAL TO MAINTAIN REQUIRED WORKING CLEARANCES AND DEDICATED EQUIPMENT SPACE. DETERMINE EXACT LOCATIONS AND VERIFY WITH ALL OTHER TRADES PRIOR TO BEGINNING OF CONSTRUCTION TO AVOID INTERFERENCES WITH MECHANICAL, STRUCTURAL, ETC.
- G. MAINTAIN A MINIMUM OF 24" HORIZONTAL SEPARATION BETWEEN BOXES INSTALLED ON OPPOSITE SIDES OF FIRE RATED WALLS TO COMPLY WITH NEC 300.21.
- H. ALL WIRING DEVICES SHALL BE OF TAMPER RESISTANT CONSTRUCTION AND WITH AFCI PROTECTION.
- I. ALL DEVICES AT COUNTER LOCATIONS TO BE MOUNTED ABOVE THE COUNTER AT +42" AFF OR AS NOTED ON THESE PLANS. COORDINATE WITH ARCHITECT/OWNER AND MILLWORK CONTRACTOR FOR EXACT LOCATIONS.
- J. LOCATE DISCONNECT SWITCHES FOR MECHANICAL AND BUILDING EQUIPMENT TO MAINTAIN WORKING CLEARANCES. LOCATIONS ON THESE PLANS ARE FOR REFERENCE ONLY.
- K. GROUND FAULT PROTECTION FOR DEVICES INSTALLED AT LOCATIONS NOT READILY ACCESSIBLE. PROVIDE GROUND FAULT BLANK FACE DEVICE AT ACCESSIBLE LOCATION OR PROVIDE GFI BRANCH BREAKER IN PANELBOARD.
- L. ALL ROOF MOUNTED EQUIPMENT TO BE NEMA 3R WEATHERPROOF RATED, INCLUDING STARTERS, DISCONNECTS, ETC.

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CONSULTANT

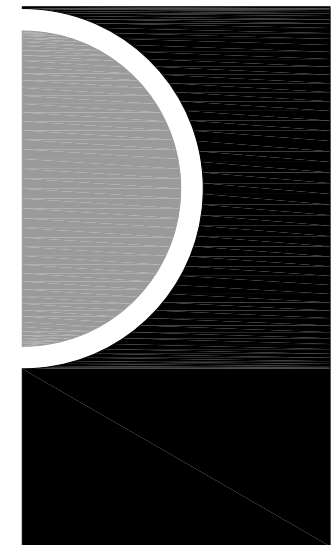

400 S. Old Woodward Ave.
Birmingham, Michigan
45203

KEY PLAN

OWNER

Highland Township
Fire Department

PROJECT NAME

Highland Township
Fire Station No. 1

1600 W. Highland Rd.
Highland, MI 48357

PROJECT NO.

18-122A

ISSUES / REVISIONS

SCHEMATIC DESIGN	01-28-2020
BIDDING-CONSTRUCTION	03-27-2020
ADDENDUM # 1	04-20-2020
CONSTRUCTION	05-04-2020
CCD #1	06-03-2020

DRAWN BY

NH

CHECKED BY

EK

APPROVED BY

EK

SHEET NAME

FLOOR PLANS -
POWER

SHEET NO.

E3-00