

IMMANUEL LUTHERAN CHURCH AND SCHOOL MMANUEL CLASSROOM AND GYMNASIUM ADDITION

47120 ROMEO PLANK ROAD, MACOMB, MI 48044

ISSUED FOR: BID PACKAGE 2

DATE: 03-10-17 PROJECT NO.: 141594

ARCHITECT:



WAKELY ASSOCIATES, INC./ARCHITECTS

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CIVIL:



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MECHANICAL/ELECTRICAL:





PETER BASSO ASSOCIATES, INC.


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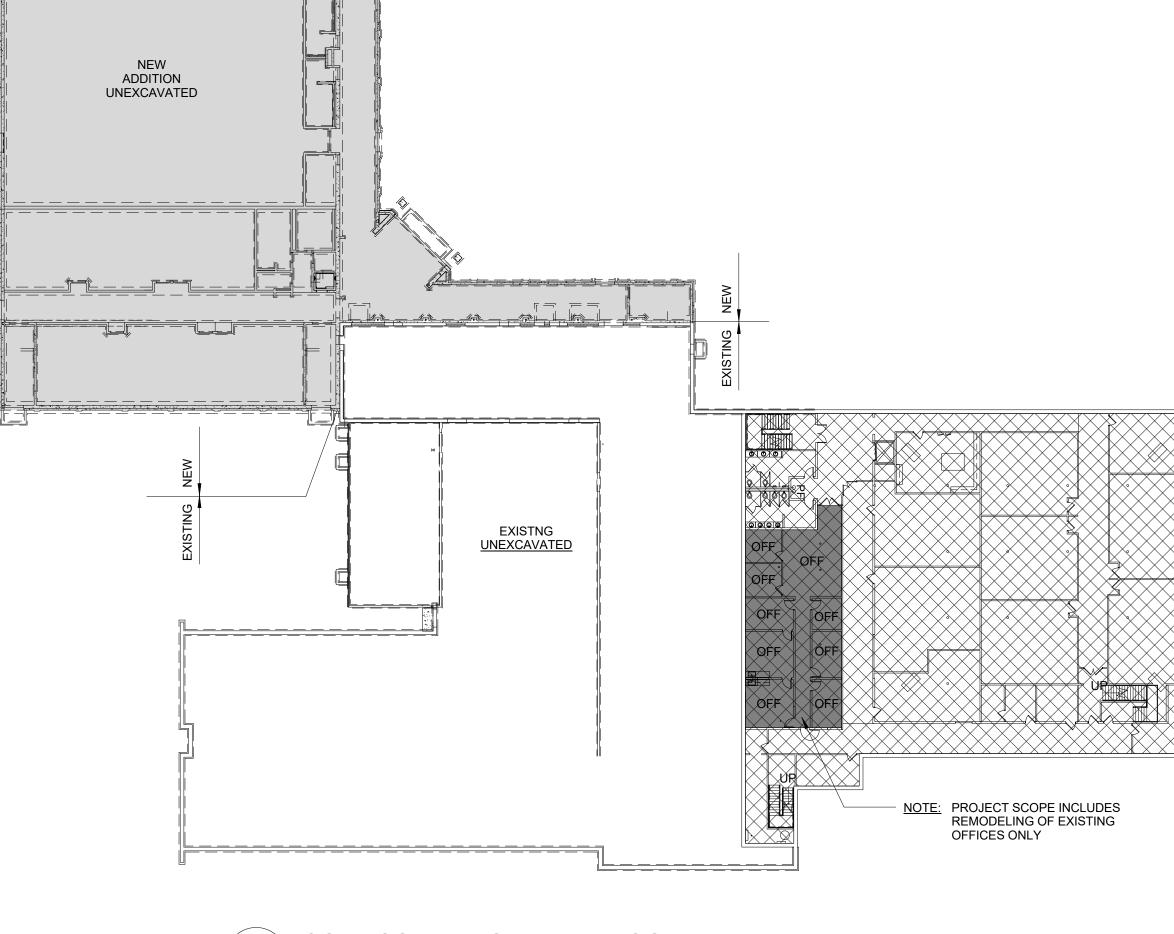




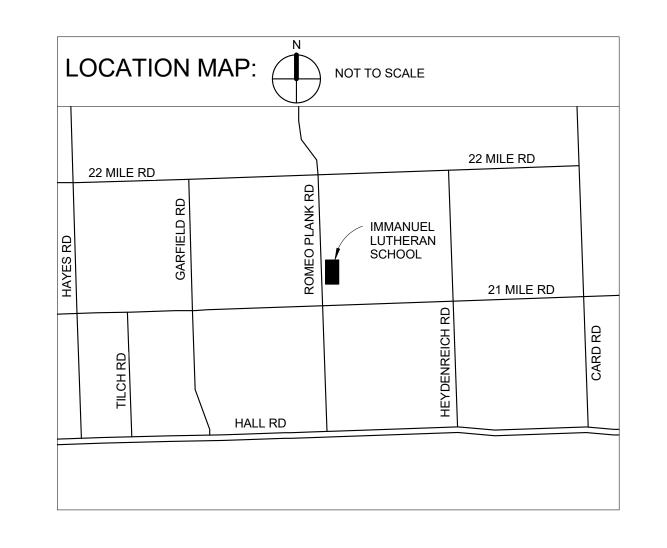

COMPOSITE FIRST FLOOR PLAN

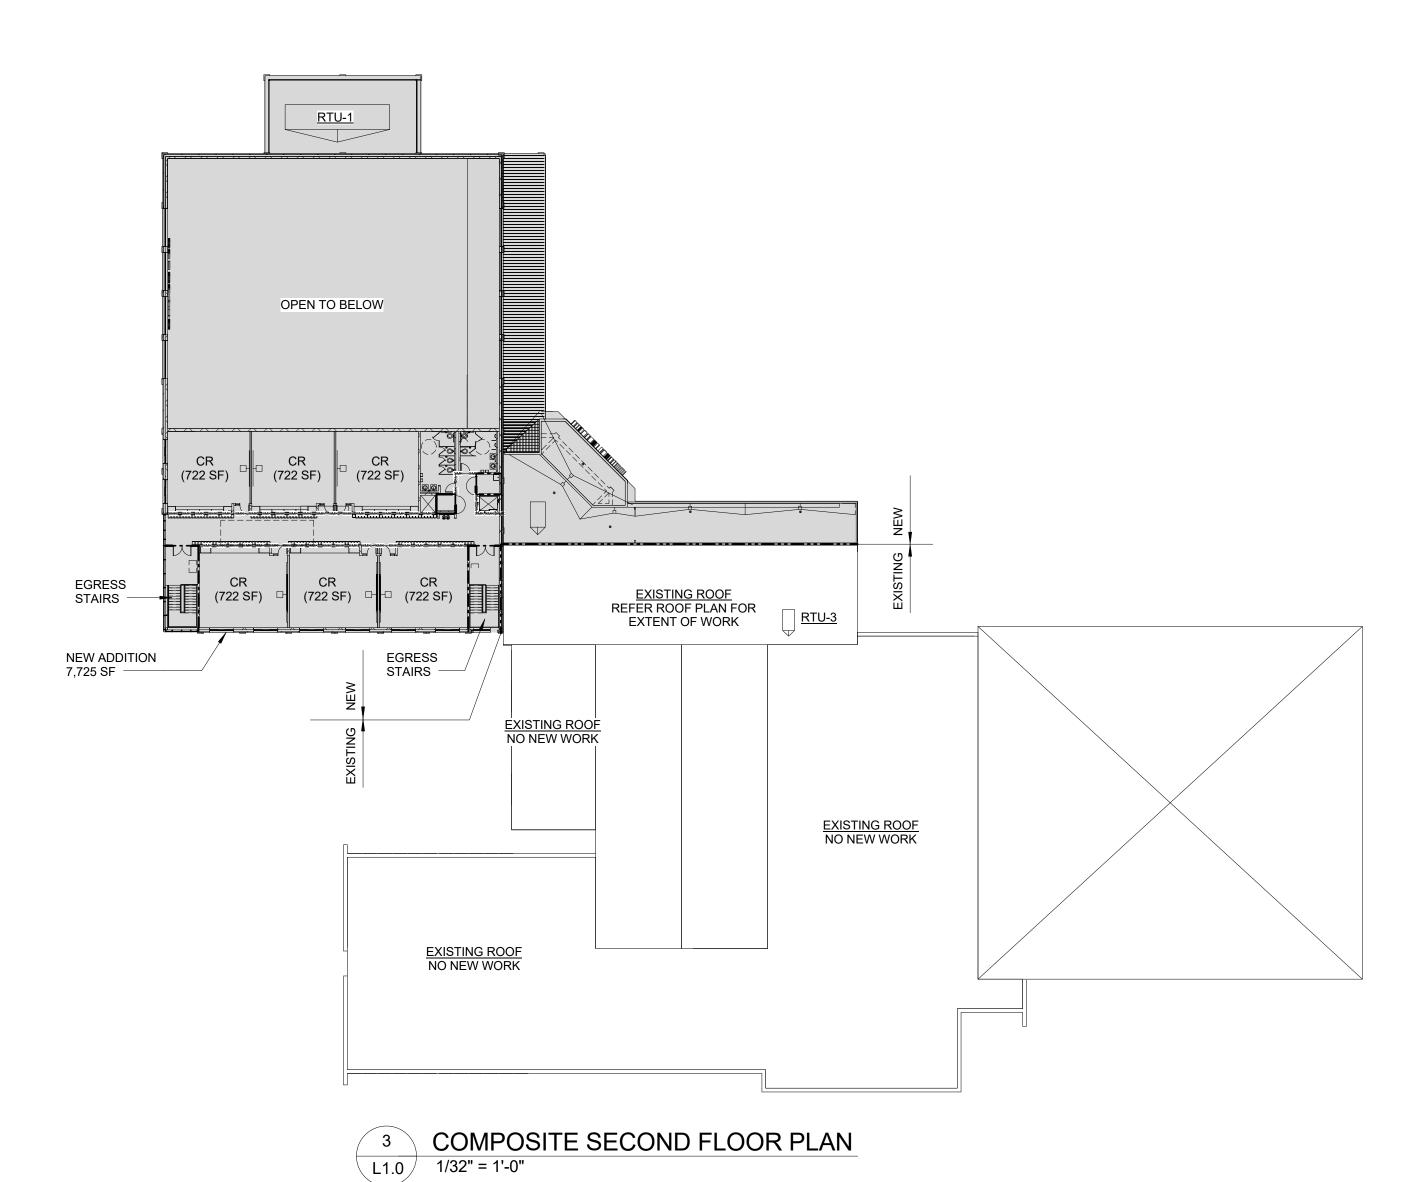L1.0 1/32" = 1'-0"

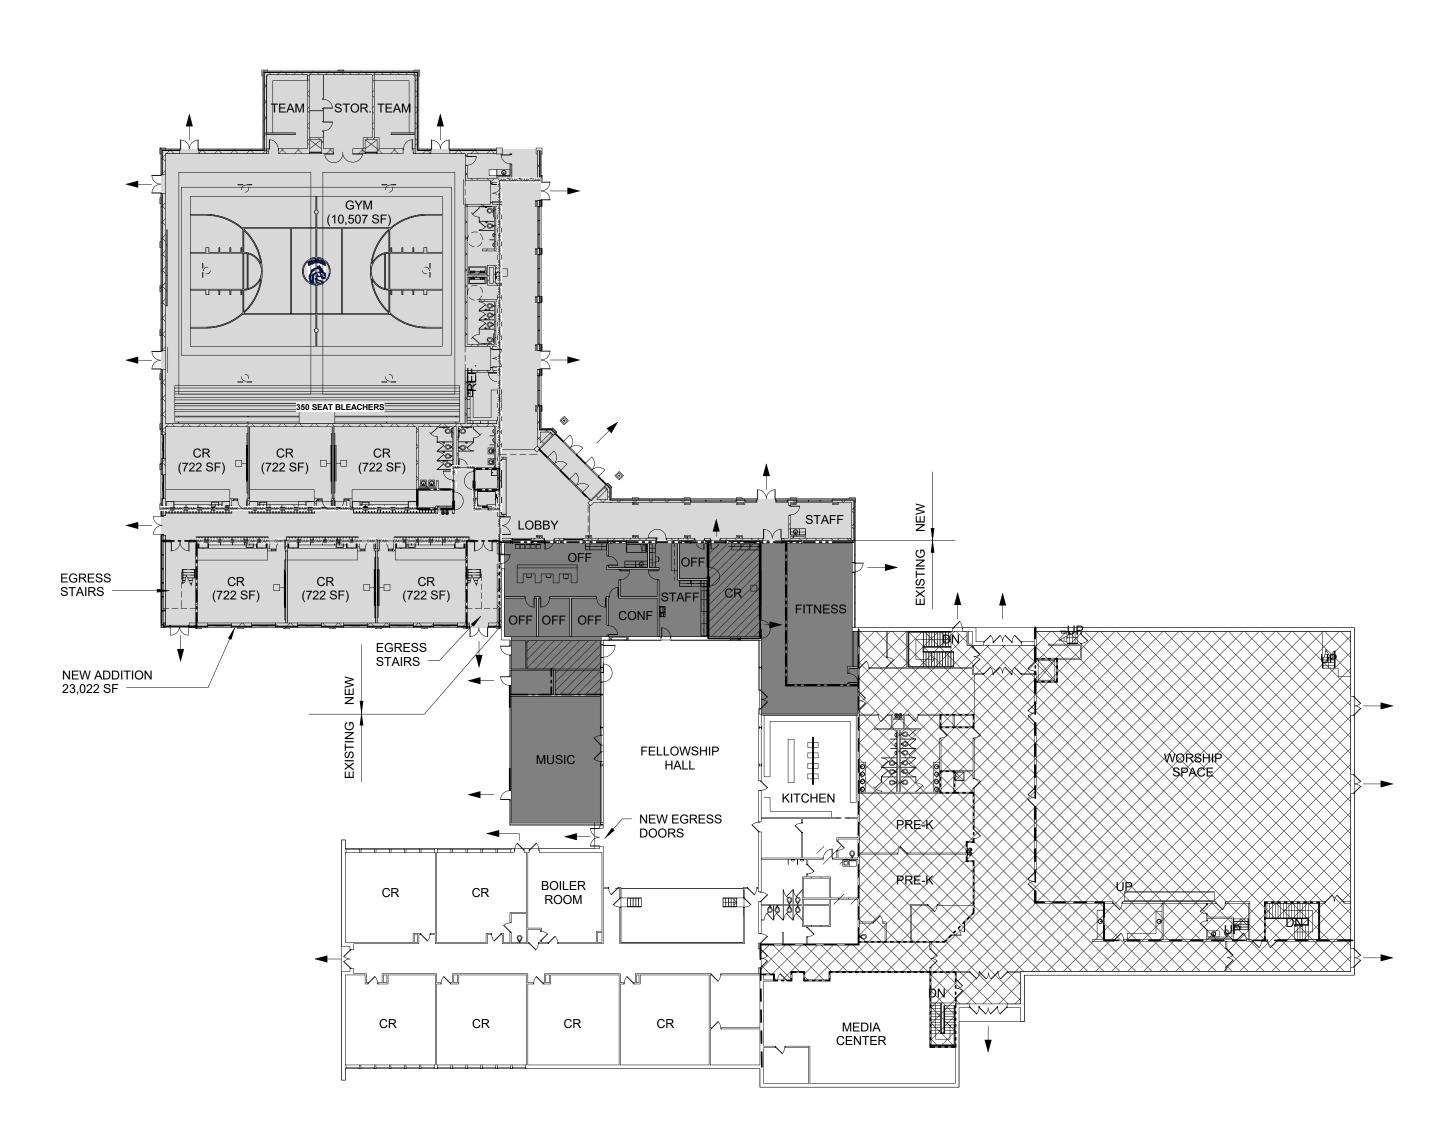

COMPOSITE BASEMENT FLOOR PLAN L1.0 1/32" = 1'-0"

BUILDING CODE SUMMARY

IMMANUEL LUTHERAN CHURCH AND SCHOOL

47120 ROMEO PLANK ROAD MACOMB, MI 48044 ADDRESS

PROPOSED USE: K-12 EDUCATIONAL FACILITY

RENOVATION: 2012 MICHIGAN REHABILITATION CODE

REFERENCE CODES: NFPA: 101 LIFE SAFETY CODE, 2012 EDITION BUILDING: 2012 MICHIGAN BUILDING CODE MECHANICAL: 2012 MICHIGAN BUILDING CODE PLUMBING: 2012 MICHIGAN BUILDING CODE ELECTRICAL: 2014 MICHIGAN ELECTRICAL CODE

BUILDING DATA

USE GROUP: E

() ASSEMBLY:___ () INSTITUTIONAL: 1-3 CONDITIONS IV () BUSINESS () MERCANTILE () RESIDENTIAL: () STORAGE-LOW HAZARD () FACTORY-INDUSTRIAL-LOW HAZARD () FACTORY-INDUSTRIAL-MODERATE () STORAGE-MODERATE HAZARD

CONSTRUCTION TYPE:

HAZARD () HIGH HAZARD:____

() TYPE 1A - PROTECTED () TYPE 3 - PROTECTED () TYPE 1B - PROTECTED () TYPE 3 - UNPROTECTED () TYPE 2A - PROTECTED () TYPE 4 - HEAVY TIMBER () TYPE 2B - PROTECTED () TYPE 5 - PROTECTED ☼ TYPE 2B - UNPROTECTED () TYPE 5 - UNPROTECTED

() UTILITY, MISCELLANEOUS

() MIXED CONSTRUCTION TYPE:_

SPRINKLED? () REQUIRED BUILDING HEIGHT PERMITTED: 30' (AT 2-STORY CR ADDITION) ACTUAL BUILDING HEIGHT: (AT GYM ROOF) 36' (AT MID-POINT OF GYM ROOF)

MEZZANINE: () YES HIGH RISE: () YES [X] NO

GROSS BUILDING AREA (EXISTING):

BASEMENT LEVEL: 18,211 S.F. GRADE LEVEL: 45,147 S.F. GROSS BUILDING AREA (NEW): GRADE LEVEL: 23,022 S.F.

SECOND LEVEL: 7,725 S.F.

NOTE: 2 FIREWALL CONSTRUCTION IS TO SEPARATE THE EXISTING BUILDING FROM THE NEW ADDITION. (MBC SECT. 706)

NEW ADDITION AREA (MBC TABLE 503) ALLOWED: 14,500 S.F. PER STORY ACTUAL: 23,022 S.F. GRADE LEVEL

AREA MODIFICATION APPLIED (MBC SECT. 506.1)

ACTUAL: 7,725 S.F. SECOND LEVEL

Aa = ALLOWABLE AREA Aa = At + [At x If] + [At x Is]

At = 14,500 S.F. If = (NOT USED IN THIS CALCULATION) Is = 200% INCREASE FOR 2-STORY BUILDING, FULLY FIRE SUPPRESSED

Aa = 14,500 S.F. + [14,500 S.F. x 0] + [14,500 S.F. x 200%] Aa = 14,500 S.F. + 0 S.F. + 29,000 S.F. = 43,500 S.F. PER STORY

CONCLUSION:

NEW ADDITION GRADE LEVEL = 23,022 S.F. WHICH IS LESS THAN MAX ALLOWED OF 43,500 S.F. = ADDITION COMPLIES (ADDITION IS SEPARATED FROM EXISTING BUILDING BY 2-HOUR FIRE WALL CONSTRUCTION - MBC SECT. 706).

LIFE SAFETY SYSTEMS

ACTUAL: 14'

EMERGENCY LIGHTING AND EXIT SIGNS FIRE ALARMS (x) REQUIRED SMOKE DETECTION SYSTEMS REQUIRED (x) PROVIDED (X) PROVIDED PANIC HARDWARE FIRE SUPPRESSION SYSTEM (x) PROVIDED (்) REQUIRED STANDPIPE SYSTEM

EXIT REQUIREMENTS - NEW ADDITION: DEAD END LIMIT - MAXIMUM CONDITION (MBC SECT. 1018.4): ALLOWED: 50' = MBC; 20' = NFPA 101

TRAVEL DISTANCE TO EXIT - MAXIMUM CONDITION (MBC TABLE 1016.2): ALLOWED: 250' ACTUAL: 130'

COMMON PATH OF TRAVEL (MBC SECT. 1014.3): ALLOWED: 75' ACTUAL: 33'

NUMBER OF EXITS (MBC SECT. 1021): REQUIRED: 2 PROVIDED: 11

STAIR CONSTRUCTION (MBC SECT. 1009.3.1.2) CONSTRUCTION IS 1-HOUR FIRE RATED WITH 60 MIN DOOR OPENING PROTECTION

ESCAPE WINDOW REQUIREMENT (MBC SECT. 1029) ALLOWED: ADDITION IS FULLY SPRINKLED (SECT. 1029.1 - EXCEPTION NO. 1)

CORRIDOR FIRE RATING NO FIRE RATING REQUIRED IN FULLY SUPPRESSED

<u>DESIGN LOADS:</u> (SEE STRUCTURAL DRAWINGS)

BUILDING CODE PLAN LEGEND:

NEW 2 HOUR FIRE WALL SEPARATION (2012 MBC SECTION 706) WITH 90 MIN. DOOR OPENING PROTECTION ----- NEW 1 HOUR SMOKE TIGHT WALL UP TIGHT TO UNDERSIDE OF


ROOF DECK WITH 60 MIN. DOOR OPENING PROTECTION ••••• EXISTING 1 HOUR FIRE RATED SMOKE TIGHT WALL TO UNDERSIDE OF ROOF DECK

NEW WALLS SMOKE TIGHT TO UNDERSIDE OF ROOF DECK


NEW 2 HOUR FIRE RATED SEPARATION TO ENCLOSE NEW STUDENT OCCUPIED "WINDOWLESS ROOM" CREATED BY ADDITION. NEW ROOM IS TO BE FULLY SPRINKLED, BE SEPARATED FROM REMAINDER OF BUILDING BY 2 HOUR RATED CONSTRUCTION AND TO PROVIDE EXITS THRU 2 SEPARATE ATMOSPHERES TO COMPLY WITH BFS POLICY NUMBER 5-24

- - EXISTING 2 HOUR FIRE RATED SMOKE TIGHT WALL TO UNDERSIDE OF ROOF DECK

EXISTING BUILDING CONSTRUCTION TO BE REMODELED

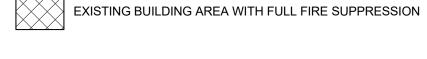

→ EGRESS DOOR LOCATION

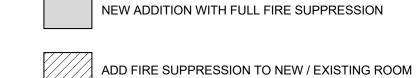


WAKELY ASSOCIATES, INC. ARCHITECTS 30500 VAN DYKE AVENUE SUITE M-7 WARREN, MICHIGAN 48093

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LIFE SAFETY PLANS PRELIMINARY DESIGN DEVELOPMENT CONSTRUCTION FINAL RECORD CHECKED BY: REVISIONS: Construction Set 04/25/17 DATE: 03/10/17 SHEET NO.:



EXISTING - NO NEW WORK

SHEET NO.: A0.1

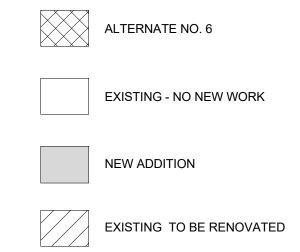BASEMENT FLOOR COMPOSITE PLAN

PRELIMINARY

CONSTRUCTION

FINAL RECORD

CHECKED BY:

Construction Set 04/25/17

DESIGN DEVELOPMENT

JOB NO.: 141594

BASEMENT COMPOSITE PLAN - NEW WORK
1/16" = 1'-0"



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FIRST FLOOR COMPOSITE PLAN

PRELIMINARY DESIGN DEVELOPMENT CONSTRUCTION FINAL RECORD DRAWN BY: CHECKED BY:

REVISIONS: Construction Set 04/25/17

SHEET NO.: A0.2



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PRELIMINARY
DESIGN DEVELOPMENT
CONSTRUCTION
FINAL RECORD

DRAWN BY:
CHECKED BY:
BJS

REVISIONS:
Construction Set
04/25/17

JOB NO.: 141594

A0.3

DATE: SHEET NO.:



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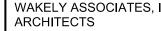
COMPOSITE ROOF PLAN

PRELIMINARY DESIGN DEVELOPMENT CONSTRUCTION FINAL RECORD DRAWN BY: CHECKED BY:

REVISIONS: Construction Set 04/25/17


03/10/17 SHEET NO.:

A0.4



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ROOF DETAILS

PRELIMINARY

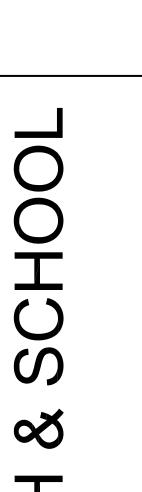CONSTRUCTION

FINAL RECORD

DRAWN BY _

REVISIONS

DATE:


SHEET NO.

03/10/17

CHECKED BY_

DESIGN DEVELOPMENT



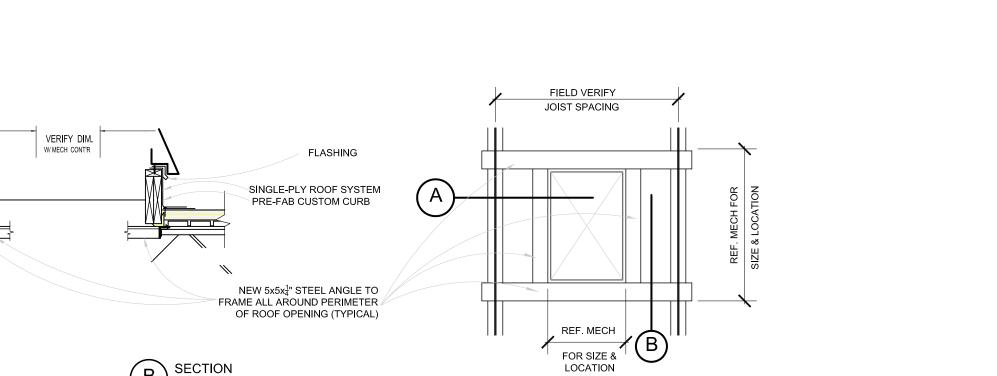

Rectangular penetration


_prefabricated

custom curb

flashing



TYP. ROOF CURB DETAIL AT NEW ROOF OPENINGS NO SCALE

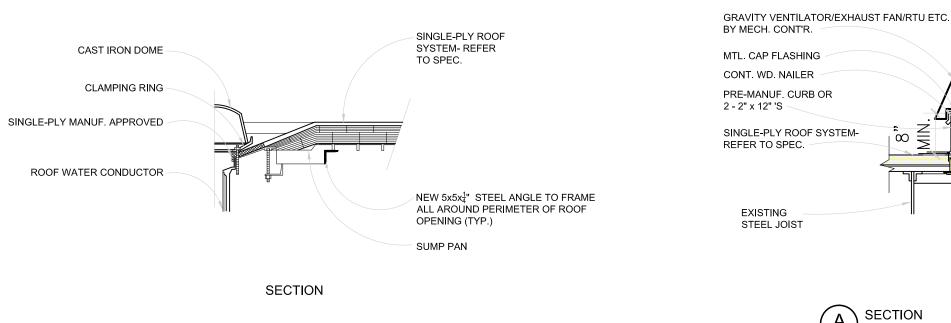

TYP. SCUPPER DETAIL NO SCALE

NEW $1\frac{1}{2}$ " INSULATION

OVER EXISTING ROOFING


BACKER ROD AIR

-GUTTER AND

DOWNSPOUT

SEAL ALL (4) FLANGES



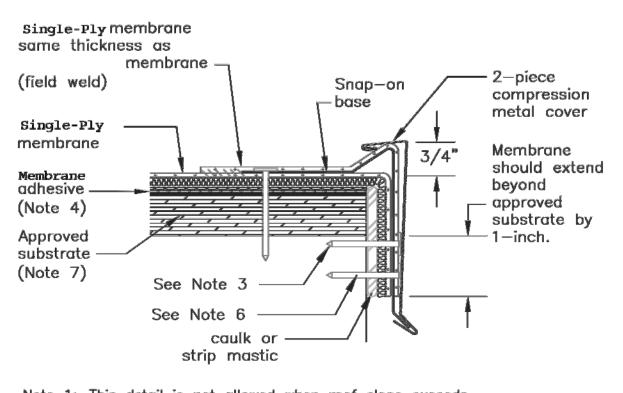

Note 1: This detail is not allowed when roof slope exceeds 2-inch per 12-inch.

Note 2: A wood nailer is required if one or more inches of insulation is used. Top of wood nailer is to be flush with top of insulation. Wood nailer must extend at least 1/2-inch beyond the horizontal edge of

Note 3: The fasteners used to attach the snap—on base and the membrane to the nailer or into an approved structural surface must be spaced no greater than 6-inches on center. When installing within 10-feet of an outside corner the fastening pattern is 3-inches on

Note 4: For approved adhesives refer to the membrane Roofing System specification.


Note 5: Allow for 1/8-inch expansion gap between 10-foot lengths of snap—on base. Overlap the snap—on covers by 2—inches between


Note 6: When installing this detail with a 6 to 13-inch wide metal cover, fasteners must be located within 2-inches of the kick-out.

ROOF PARAPET DETAIL

Note 7: For substrate options see the membrane Roofing System specification.

NO SCALE

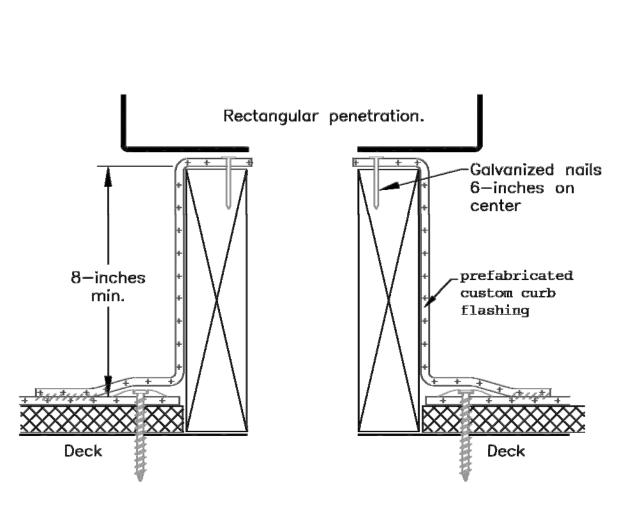

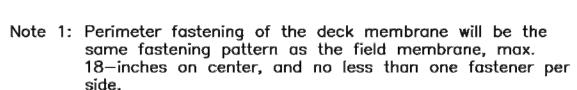

Note 2: All termination bar to have a fastener 1-inch max. from


NO SCALE

NEW ROOF CURB DETAIL

Perimeter fastening of the deck membrane will be the same

center, and no less than one fastener per side.

fastening pattern as the field membrane, max. 18—inches on

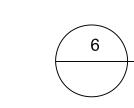

Fasten

6-inches

on center

8-inches


each corner.

NO SCALE

Deck

EXISTING ROOF CURB DETAIL

— Canopy

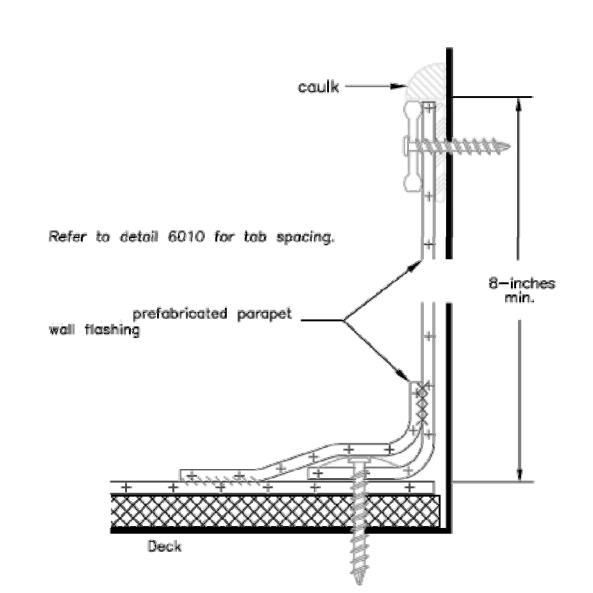

Note 1: Fascia bar and cover may be used in place of the termination bar.

Note 2: The substrate must be free and clear of debris at and below the termination point.

Note 3: When attaching the parapet flashing to the substrate, t appropriate fastener must be used. The fastener for th wall flashing may be different than the fastener used a the horizontal roof decking.

NO SCALE



ROOF FLASHING-

SEALANT ----

BAR & SEALANT-

METAL SLEEVE -

SEALANT (ALL

AROUND) ---

REMOVE / REINSTALL VENEER AS

NEW THRU-WALL FLASHING -RUN

VERTICAL 8" MIN. IN CAVITY

NEW WEEPS AND CAVITY

DRAINAGE MATERIAL

NEW METAL COUNTER

SINGLE-PLY ROOFING -SEE

FLASHING WITH-

TURNED UP


DETAIL 4

EDGE AT CMU

REQUIRED

ROOF FLASH'G-

SOLDER OR SEALANT—

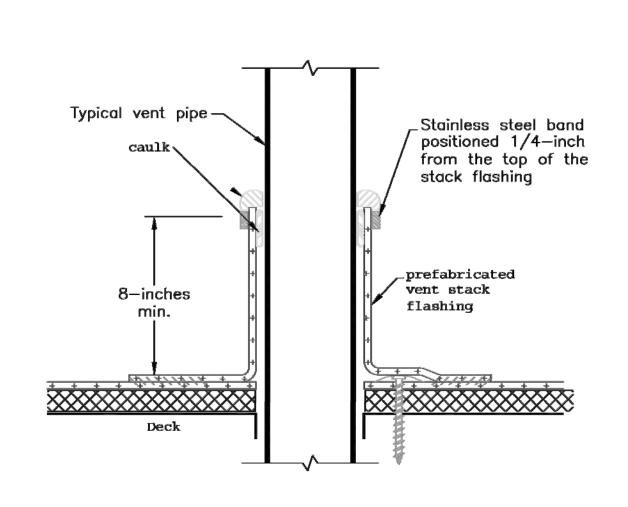


SECTION DETAIL AT NEW FLASHING/ WEEPS

SCALE: 1 1/2" = 1'-0"

removed before a stack flaashingis installed. Note 2: Membrane attachment around the penetration will be the

Note 1: If a lead flashingis present on the pipe, it must be

same as the deck membrane, max. 18-inches on center, and a minimum of one plate/fastner per flashing.

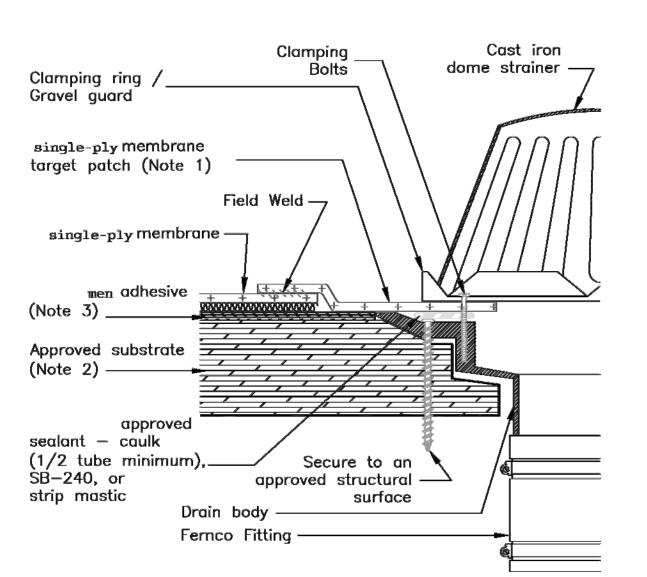


Note 1: Target patch must extend beyond drain sump so that no hot—air welding is done within the sump. If no sump is present the target patch must extend beyond the drain assembly a minimum of 12 inches in all directions. The target patch must be the same mil thickness as the roof memebrane.

Note 2: For substrate options refer to of the membrane Roofing System specification. Note 3: For approved adhesives refer to

Roofing System specification.

ROOF SUMP DETAIL NO SCALE


of the membrane

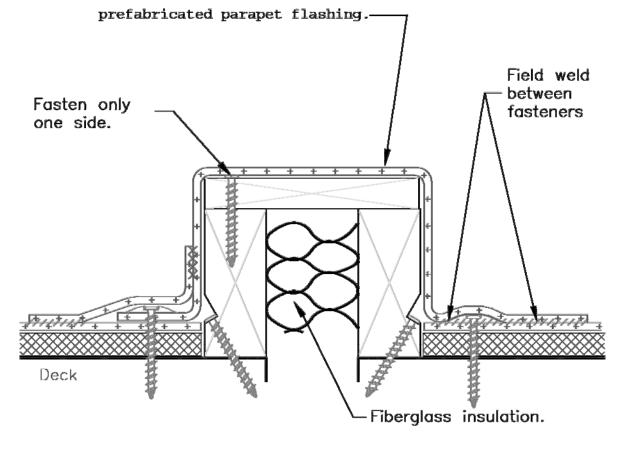

Note 1: Tabs that are parallel to the expansion joint must be mechanically fastened with the same fastening pattern used on the membrane in the field area.

Note 2: Leave the membrane covering the expansion joint loose enough to allow for movement of the building on either side of the joint.




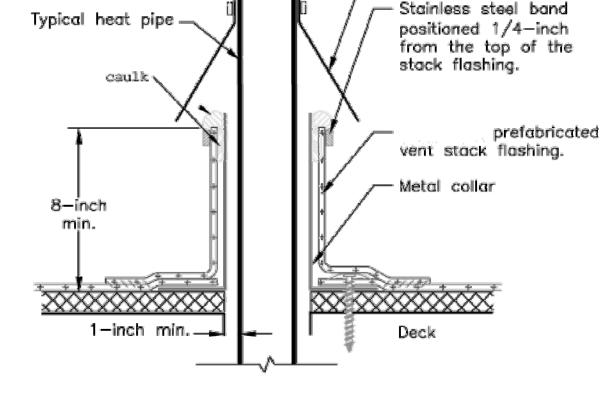

Note 1: Membrane attachment around the penetration will be the same as the deck membrane, max. 18-inches on center, and a minimum one plate/fastener per flashing.

Note 2: This detail required around pipes that exceed 120°F, including all insulated chimney pipes.

Note 3: A minimum of 1-inch air space is required between collar and hot pipes having temperatures greater than 120° F. Position canopy to allow air flow above termination.

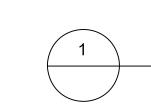

PIPE DETAIL NO SCALE







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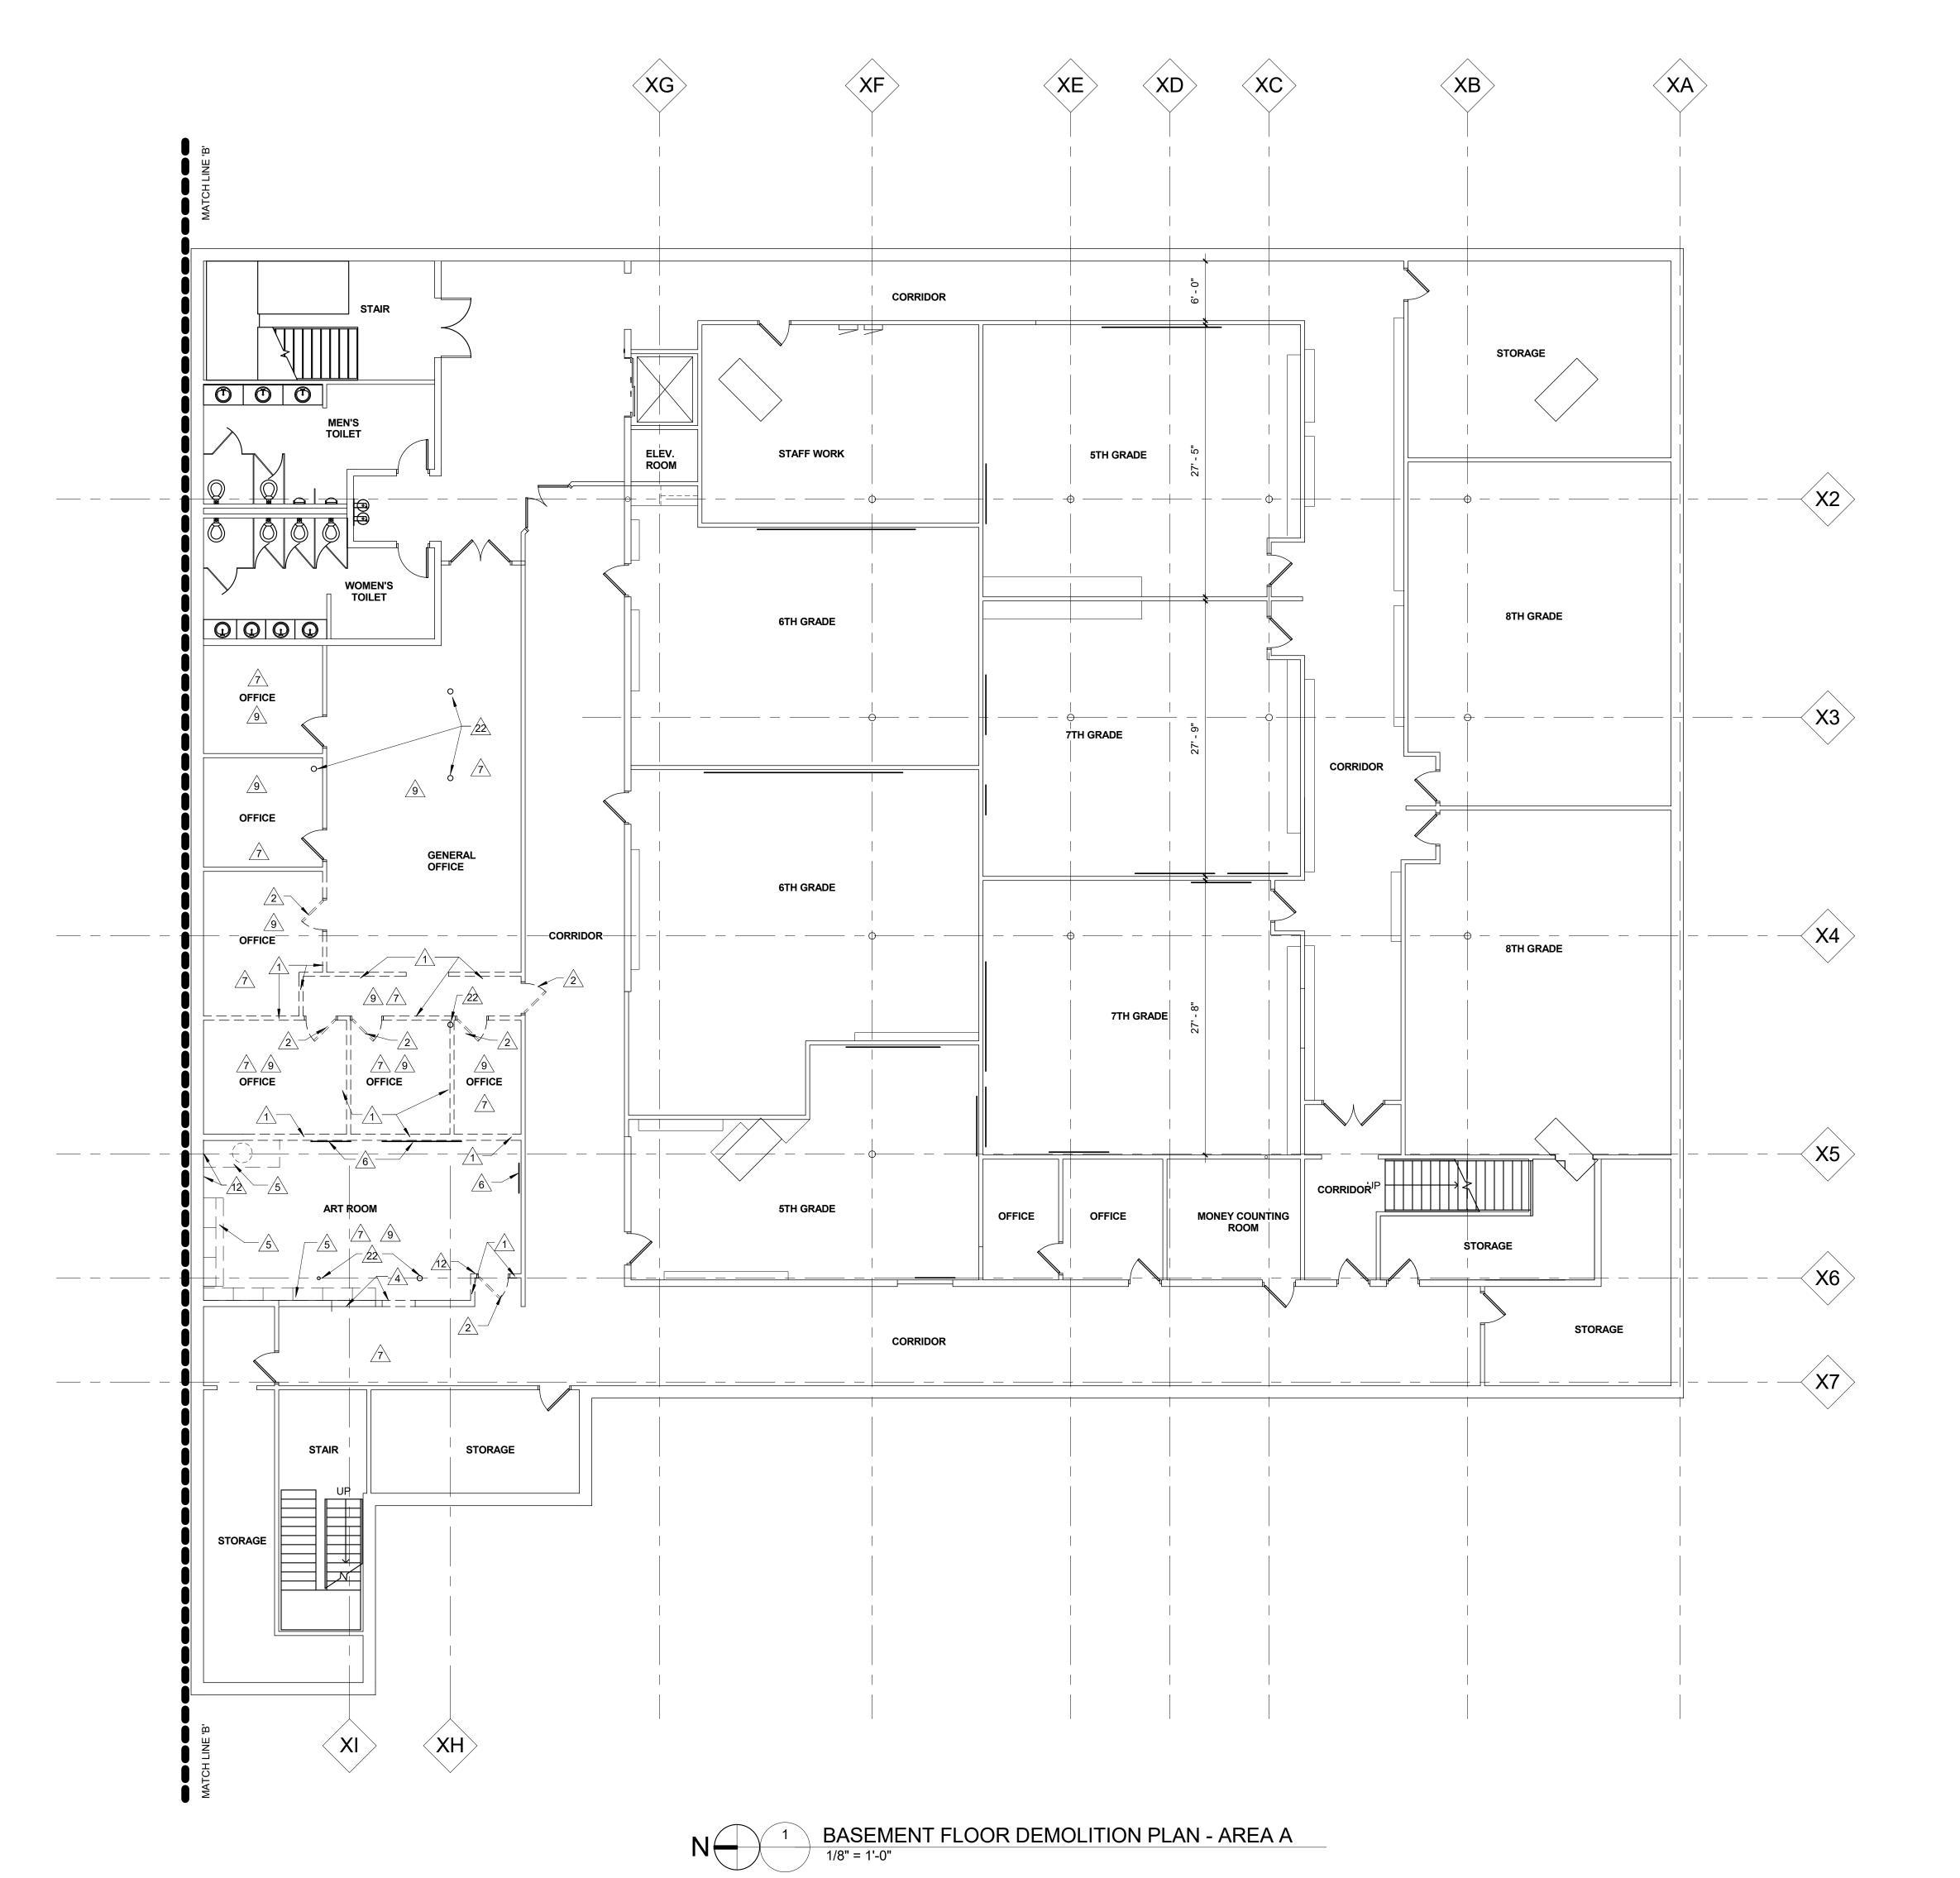
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DEMOLITION PLAN NOTES:

- WALLS FLUSH AND FLOORS LEVEL. EXISTING COLUMNS TO REMAIN U.N.O.
- REMOVE EXISTING DOOR, FRAME AND HARDWARE COMPLETE.
- REMOVE PORTION OF EXISTING WALL SHOWN DASHED FOR NEW DOOR OPENING.
 PATCH FLOOR LEVEL TO MATCH EXISTING FINISH. PROVIDE NEW LINTELS FOR OPENING.
- REMOVE EXISTING BUILT-IN CABINETS COMPLETE. REINSTALL IN NEW LOCATION
- REMOVE EXISTING MARKER/TACK/CHALK BOARD COMPLETE ALONG ENTIRE WALL. HOLES - REMOVE GLUE PODS FROM WALLS AND REPAIR FLUSH AS REQUIRED.

- REMOVE EXISTING WALL MOUNTED COUNTERTOP COMPLETE. PATCH HOLES IN WALLS FLUSH.
- REMOVE EXISTING WALL MOUNTED METAL COAT RACK/SHELVING UNIT COMPLETE. PATCH HOLES IN WALL FLUSH.
- REMOVE / RELOCATE EXISTING RWC AND GYP. BD. WALL ENCLOSURE. CUT FLOOR AND PATCH AS REQUIRED FOR UNDERGROUND WORK. COORDINATE WITH
- PROVIDE NEW LINTEL AT OPENING.
- REMOVE EXISTING OVERHANG COMPLETELY.
- REMOVE EXISTING BRICK COMPLETELY. PREP WALL FOR NEW WORK.
- ALTERNATE 2 EXISTING METAL SIDING TO BE COVERED WITH NEW EIFS. REFER TO ELEVATIONS AND DETAILS.
- SAWCUT/REMOVE EXISTING CONCRETE FLOOR FOR NEW UNDERGROUND PLUMBING. FILL WITH NEW 4" CONC. ON COMP. FILL UPON COMPLETION OF WORK.
- 22 EXISTING STEEL COLUMNS TO REMAIN.
- REMOVE/REINSTALL LAY-IN CEILING SYSTEM AS REQUIRED FOR NEW O.H. PIPING INSTALLATION.
- REMOVE CONCRETE CURB FLUSH WITH CONC. FLOOR PATCH LEVEL AS REQUIRED.

REMOVE EXISTING WALL CONSTRUCTION COMPLETE SHOWN DASHED. PATCH ADJACENT

REMOVE EXISTING LOCKERS AND BASE COMPLETE. PATCH HOLES IN WALLS FLUSH. PATCH FLOORS LEVEL TO MATCH EXISTING FINSH.

AS DIRECTED BY OWNER IN FIELD.

TURN BOARDS OVER TO OWNER.

REMOVE EXISTING FLOORING + BASE COMPLETE IN ENTIRE ROOM. SCRAPE MASTIC FROM CONCRETE SUB FLOOR.

/8\ REMOVE EXISTING WINDOW SYSTEM COMPLETE.

/9\ REMOVE EXISTING CEILING SYSTEM COMPLETE.

REMOVE EXISTING BUILT-IN WALL CUBBIES COMPLETE. REINSTALL IN NEW LOCATION AS DIRECTED BY OWNER IN FIELD.

REMOVE EXISTING WALL MOUNTED PENCIL SHARPNER/PAPER TOWEL/SOAP DISPENSER COMPLETE. PATCH HOLES IN WALLS FLUSH.

REMOVE PORTION OF EXISTING WALL SHOWN DASHED FOR NEW WINDOW (4' H x 6' W) OPENING. PATCH ADJACENT WALLS TO MATCH EXISTING FINISH. PROVIDE NEW LINTEL AT OPENING.

REMOVE PORTION OF EXISTING WALL SHOWN DASHED FOR NEW WINDOW (FULL HEIGHT)
OPENING. PATCH FLOOR LEVEL AND ADJACENT WALLS TO MATCH EXISTING FINISH.

 $\cancel{\eta}$ REMOVE EXISTING WALL MOUNTED SHORT THROW PROJECTOR COMPLETE. REINSTALL IN NEW LOCATION AS DIRECTED BY OWNER IN FIELD.

BASEMENT DEMOLITION

PRELIMINARY DESIGN DEVELOPMENT CONSTRUCTION FINAL RECORD

CHECKED BY: REVISIONS:

Construction Set 04/25/17

AD1.0



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AANUEL LUTHERAN CHURCH & SCH(
SSROOM & GYMNASIUM ADDITION

Romeo Plank Road, Macomb, MI 48044


FIRST FLOOR DEMOLITION PLAN

PRELIMINARY
DESIGN DEVELOPMENT
CONSTRUCTION
FINAL RECORD
DRAWN BY: JAG
CHECKED BY: BJS

REVISIONS:
Construction Set
04/25/17

DATE: 03/10/ SHEET NO.:

AD1.1

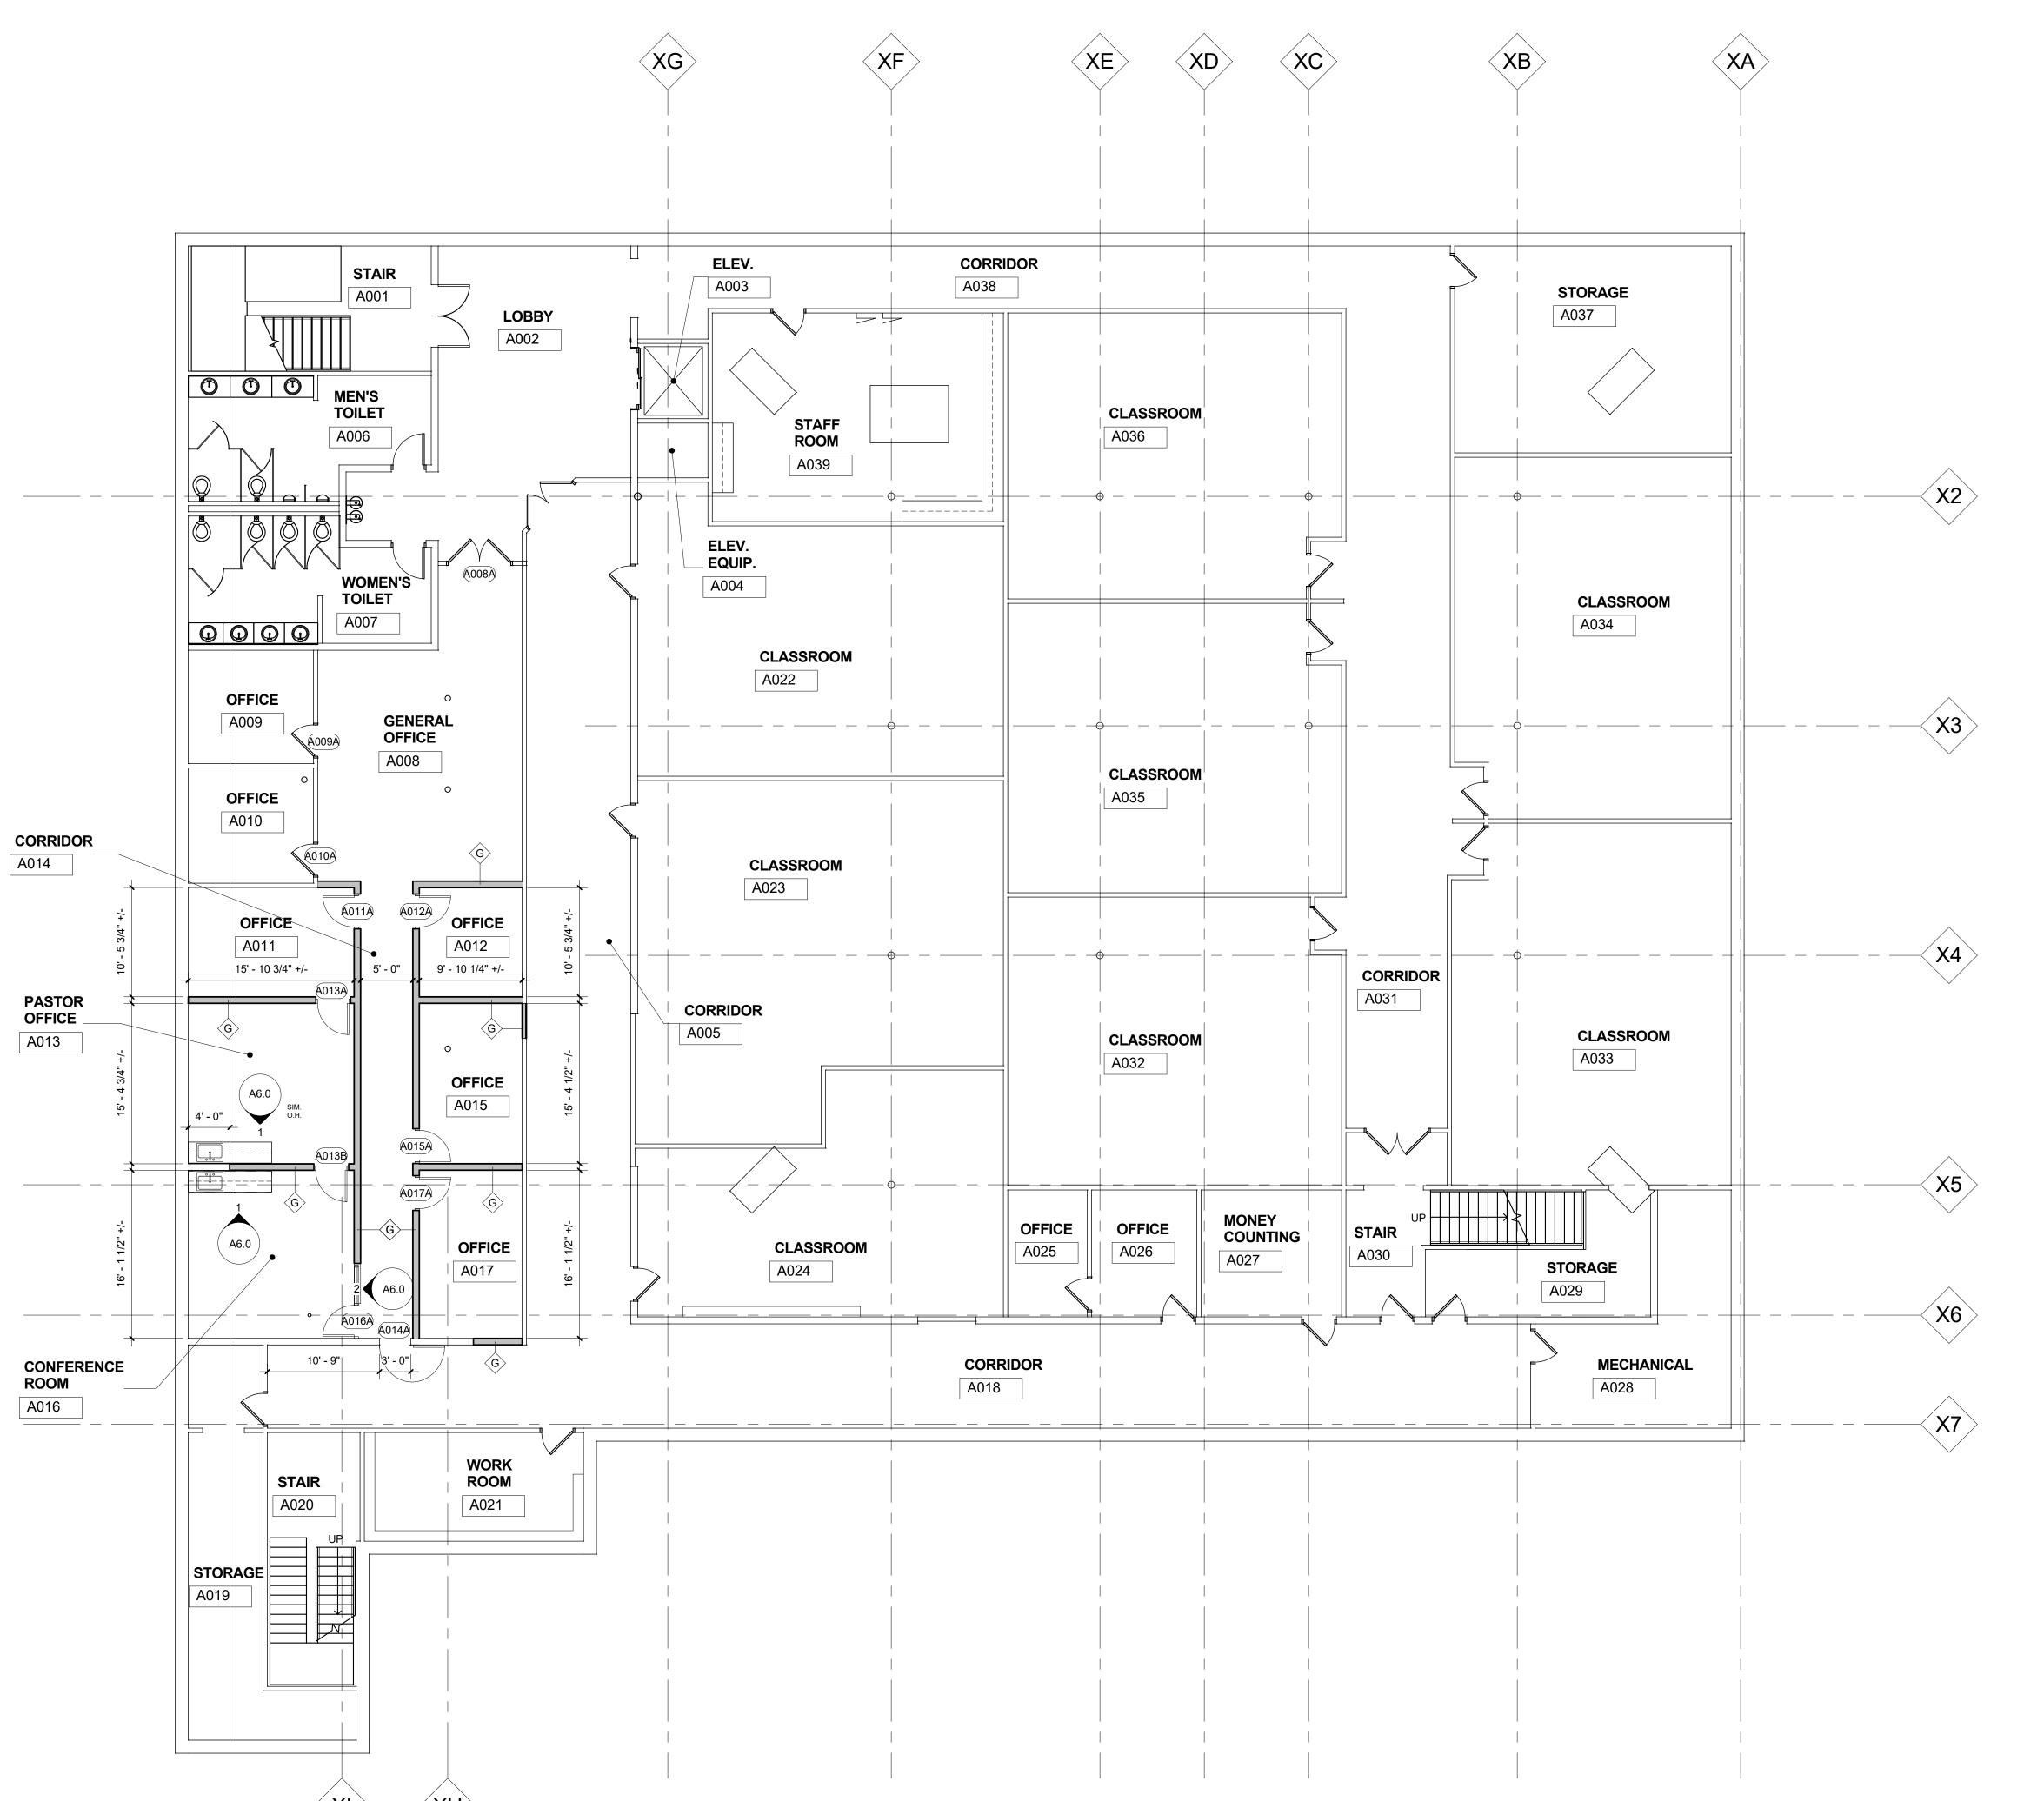

- 1. FLOOR PLANS ARE DIMENSIONED TO NOMINAL PARTITION THICKNESS (TYP). ALL WALLS TO BE CMU TO UNDERSIDE OF STRUCTURE ABOVE AND FIRE STOPPED WITHIN "FLUTES" OF METAL DECK SYSTEM, UNLESS OTHERWISE NOTED OR DETAILED. COPE AROUND STRUCTURE AND SEAL TIGHT ALL GAPS AND
- 3. PROVIDE BULLNOSE CMU ON ALL EXPOSED CMU CORNERS UNLESS OTHERWISE NOTED.
- VERIFY QUANTITY, SIZE AND LOCATION OF ALL FLOOR, ROOF AND WALL OPENINGS FOR MECHANICAL AND ELECTRICAL WORK WITH THE APPROPRIATE TRADE, PROVIDE ALL OPENINGS SHOWN OR REQUIRED FOR THE COMPLETION OF THE WORK.
- 5. REFER TO ___ SERIES DRAWINGS FOR CASEWORK AND INTERIOR ELEVATIONS.
- SEE EXTERIOR ELEVATIONS FOR LOCATIONS OF CONTROL JOINTS IN EXTERIOR WALLS.
- ALL EXPOSED STEEL COLUMNS AND MISCELLANEOUS METALS SHALL BE PRIMED AND
- 8. REFER TO LS1.0 FOR FIRE RATING OF WALLS.

WALL TYPES

- 1. ALL MASONRY AND/OR GYP. BD. PARTITION WALLS TO BE TIGHT TO UNDERSIDE OF DECK AND WITH IN FLUTES OF METAL DECK SYSTEM UNLESS OTHERWISE INDICATED. COPE AROUND STRUCTURE AND SEAL SMOKE TIGHT ALL GAPS AND PENETRATIONS. INTERSECTION BETWEEN RATED WALL SYSTEM AND DECK SYSTEM TO BE SEALED WITH
- APPROVED UL FIRE SPRAY MATERIAL. FIRE WALLS TO EXTEND CONTINUOUS THROUGH BUILDING WITHOUT INTERRUPTION. PROVIDE SOUIND ATTENUATING BLACKETS IN ALL VOIDS OF METAL STUD WALLS FULL HT.
- NOMINAL 4" CMU (ACTUAL WIDTH 3 5/8")
- NOMINAL 6" CMU (ACTUAL WIDTH 5 5/8")
- NOMINAL 8" CMU (ACTUAL WIDTH 7 5/8")
- NOMINAL 8" CMU (ACTUAL WIDTH 7 5/8") 1 HOUR FIRE-RATING (U.L. #905)
- NOMINAL 8" CMU (ACTUAL WIDTH 7 5/8") 2 HOUR FIRE-RATING (U.L. #905)
- NOMINAL 12" CMU (ACTUAL WIDTH 11 5/8")
- NOMINAL 12" CMU (ACTUAL WIDTH 11 5/8") W/FOAM INSULATION IN ALL CORES
- NOMINAL 16" CMU
- NOMINAL 16" CMU (ACTUAL WIDTH 15 1/4" 2 HOUR FIRE-RATING (U.L. #)
- 5/8" GYP. BD. ON EACH SIDE OF 6" LT. GA. METAL FRAMING AT 16" O.C. MAX.
- 5/8" TYPE 'X' GYP. BD. ON EACH SIDE OF 6" LT. GA. METAL FRAMING AT 16" O.C. MAX, 1 HOUR FIRE-RATING (U.L. #419)
- (2) LAYERS OF 5/8" TYPE "X" GYP. BD. ON EACH SIDE OF 6" LT. GA. MÉTAL FRAMING AT 16" O.C. MAX. 2 HOUR FIRE-RATING (U.L. #419)

FLOOR PLAN KEYNOTES:

- SEMI RECESSED FIRE EXTINGUISHER CABINET LOCATION (TOOTH-IN BLOCK OR BRICK AT EXIST WALL LOCATIONS IF ANY).
- CONCRETE SUPPORTED SLAB (SEE STRUCTURAL DRAWINGS)
- CONCRETE SUPPORTED SLAB FULL DEPTH OF SIDE WALLS x FULL WIDTH OF
- ELECTRIC WATER COOLER
- DISPLAY CASE. SEE SPEC.
- ELECTRIC WATER COOLER AND BOTTLE FILLET
- 2'-0" W x 6'-0" H SAFETY WALL PADS (20'-0" WIDE MIN)
- FULL WALK-OFF CARPET IN VESTIBULE
- SCORE BOARD LOCATION
- INFILL DOOR OPENING WITH BRICK / CMU FULL WIDTH AND HEIGHT OF OPENING (VERIFY TO MATCH EXIST WALL THICKNESS).
- TOOTH-IN BULLNOSE CMU AT BOTH JAMBS OF NEW DOOR OPENING
- RECESSED CABINET UNIT HEATER SEE MECHANICAL DRAWINGS
- CASEWORK SEE INTERIOR ELEVATIONS
- FORWARD FOLDING BACKSTOP SUSPENDED FROM ROOF FRAMING
- FOLDING BLEACHER SYSTEM
- VIDEO PLATFORM IN BLEACHER
- AIR INTAKE LOUVER BY MECH.
- COILING STAINLESS STEEL SHUTTER
- REFRIGERATOR (BY OWNER)
- RECEPTION COUNTER CUSTOM FABRICATED (SEE DETAILS)
- NEW ARCHITECTURAL LOUVER IN WINDOW OPENING (2)
- NEW CONCRETE BENCH IN TEAM ROOMS (TYP) NEW 10' MARKER BOARD
- MESH STORAGE GATE PARTITION W/ 4'-0" MAIN GATES
- GYM P.A. SYSTEM LOCATION
- 12'Hx22'W ELECTRICAL PROJECTION SCREEN SUSPENDED FROM TRUSSES (CENTER
- EXISTING WOOD MEZZANINE TO REMAIN
- 12"Dx12"Wx48"H METAL LOCKER ON 4" METAL BASE AND 4" SLOPED TOP
- 12"Dx12"Wx60"H METAL LOCKER ON 4" METAL BASE AND 4" SLOPED TOP


WAKELY ASSOCIATES, INC. ARCHITECTS

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NEW WORK PLANS - AREA A

PRELIMINARY DESIGN DEVELOPMENT CONSTRUCTION FINAL RECORD DRAWN BY:

A1.0

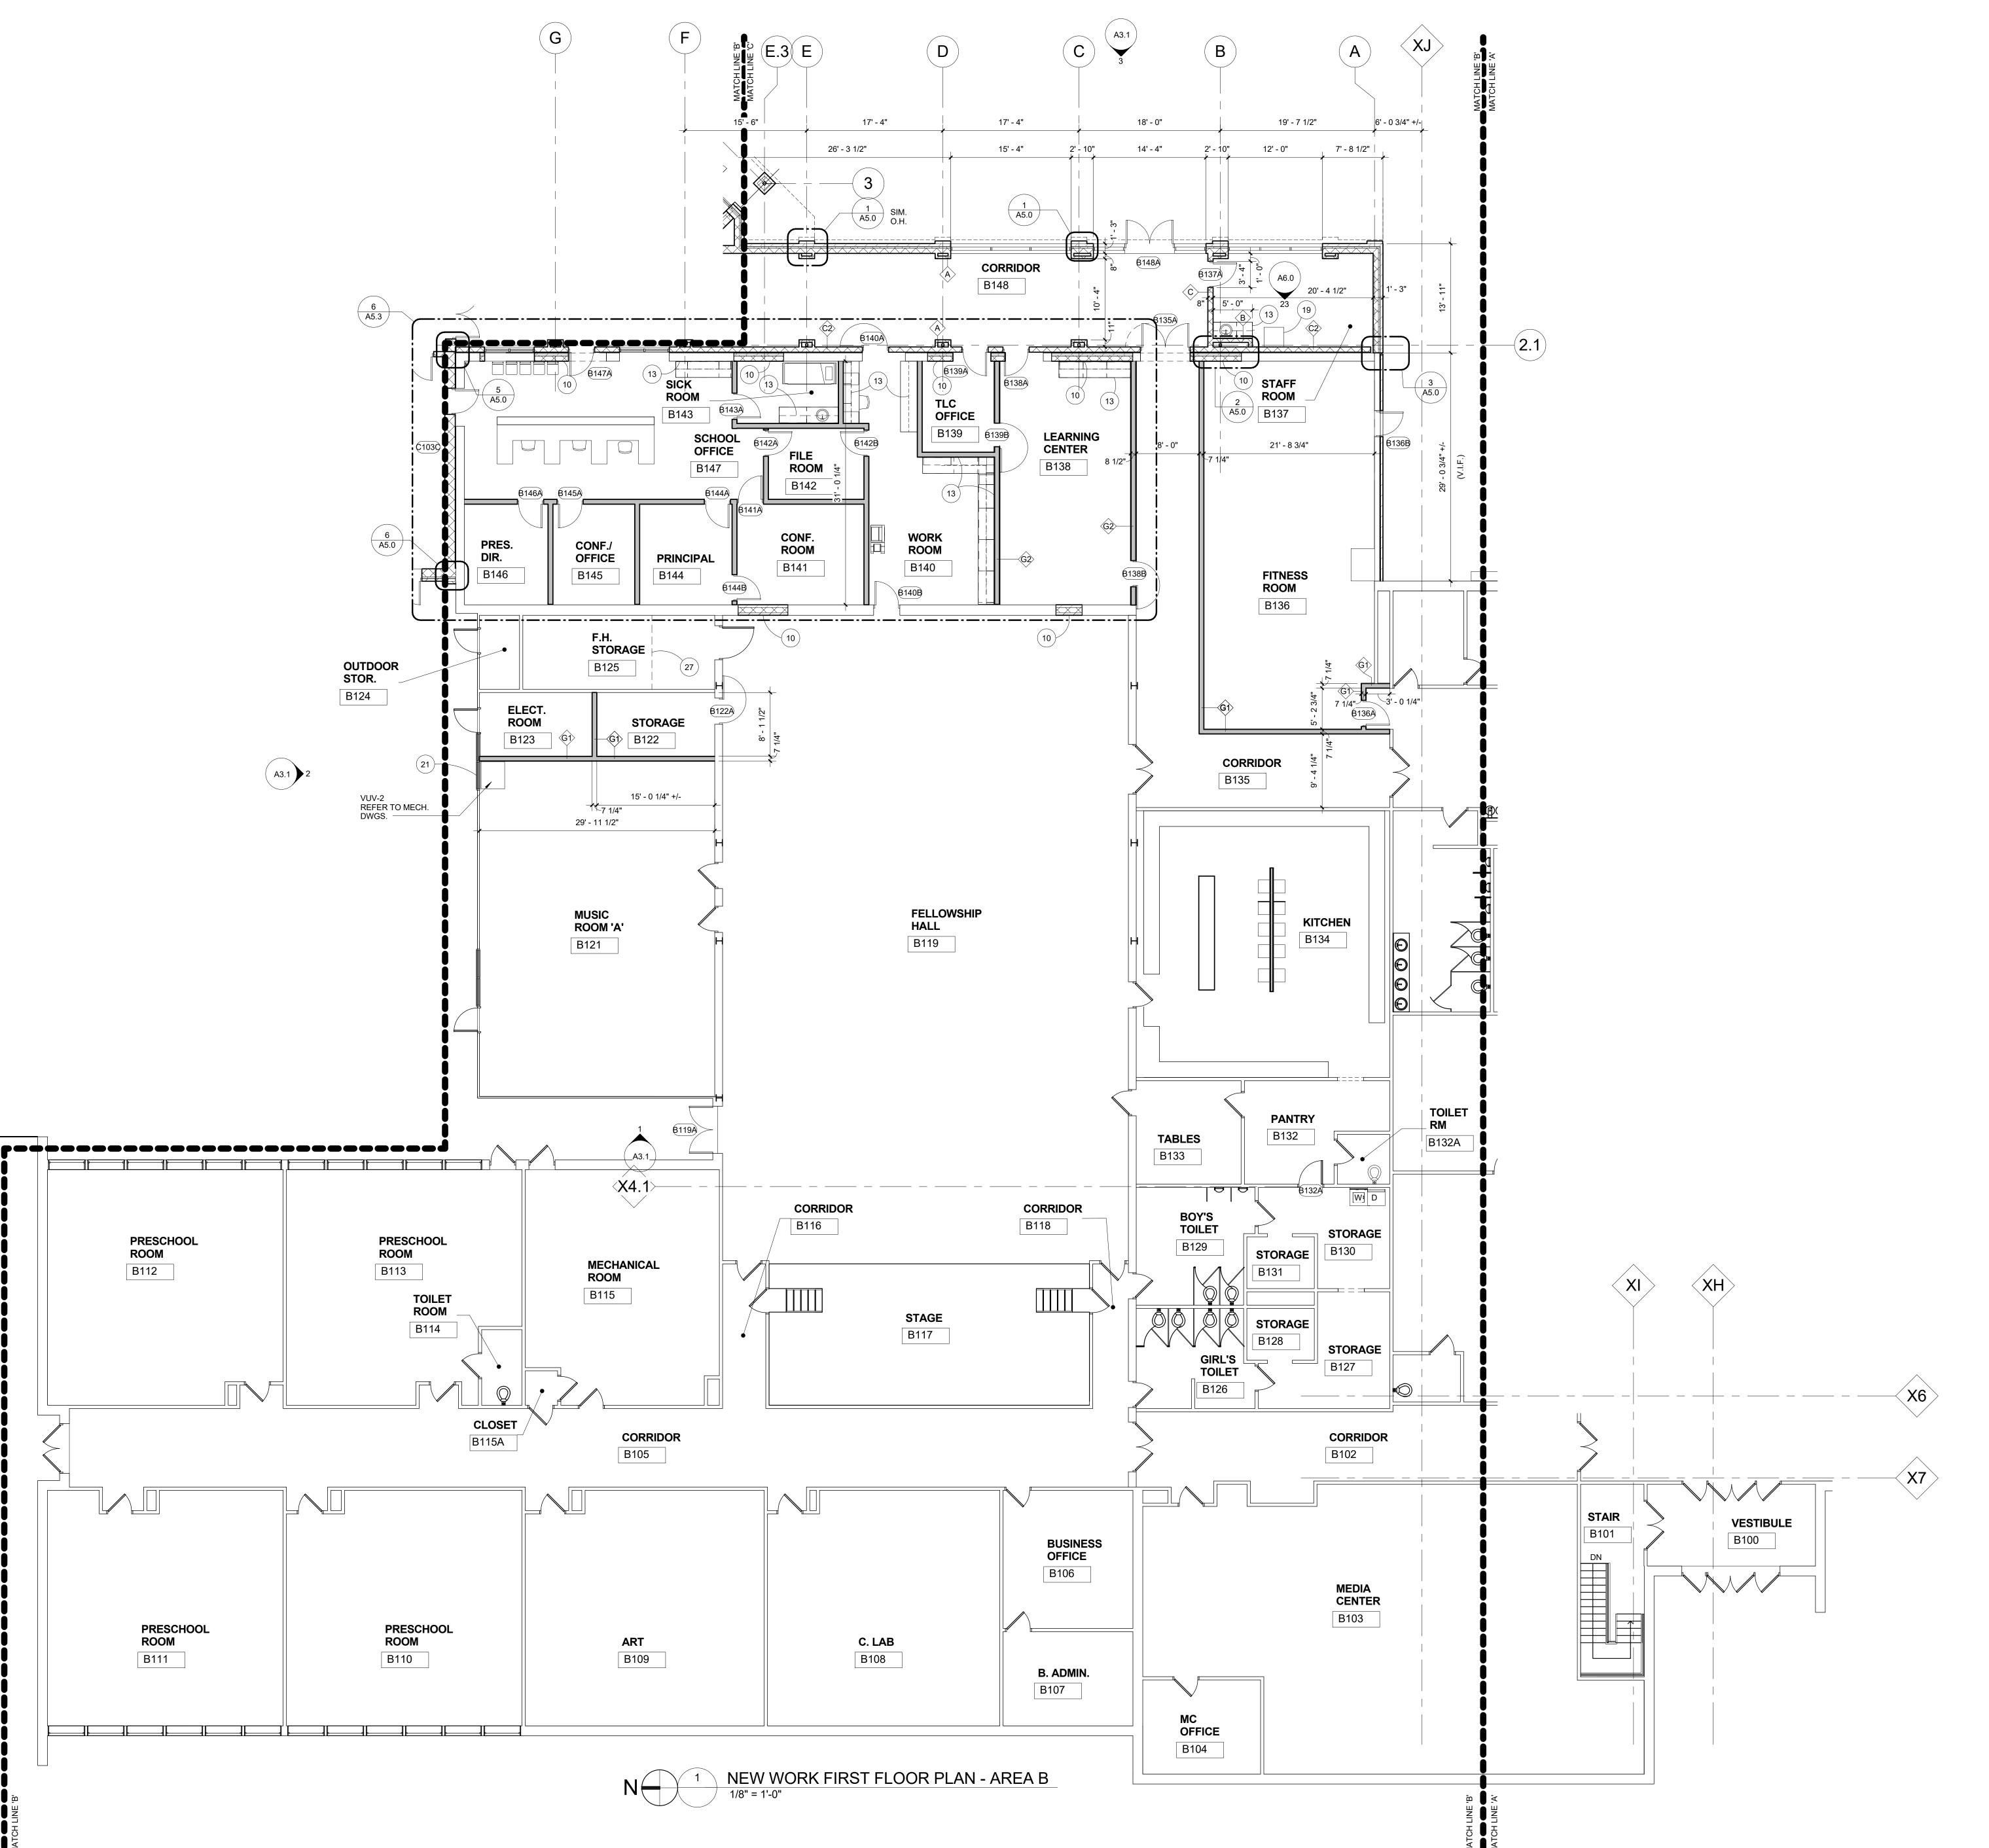

- FLOOR PLANS ARE DIMENSIONED TO NOMINAL PARTITION THICKNESS (TYP).
 ALL WALLS TO BE CMU TO UNDERSIDE OF STRUCTURE ABOVE AND FIRE STOPPED WITHIN "FLUTES" OF METAL DECK SYSTEM, UNLESS OTHERWISE NOTED OR DETAILED. COPE AROUND STRUCTURE AND SEAL TIGHT ALL GAPS AND
- PENETRATIONS.

 3. PROVIDE BULLNOSE CMU ON ALL EXPOSED CMU CORNERS UNLESS OTHERWISE NOTED.
 - VERIFY QUANTITY, SIZE AND LOCATION OF ALL FLOOR, ROOF AND WALL OPENINGS FOR MECHANICAL AND ELECTRICAL WORK WITH THE APPROPRIATE TRADE, PROVIDE ALL
 - OPENINGS SHOWN OR REQUIRED FOR THE COMPLETION OF THE WORK.

 5. REFER TO ___ SERIES DRAWINGS FOR CASEWORK AND INTERIOR ELEVATIONS.
- 6. SEE EXTERIOR ELEVATIONS FOR LOCATIONS OF CONTROL JOINTS IN EXTERIOR WALLS.
- ALL EXPOSED STEEL COLUMNS AND MISCELLANEOUS METALS SHALL BE PRIMED AND PAINTED
- 8. REFER TO LS1.0 FOR FIRE RATING OF WALLS.

WALL TYPES

NOTES:

 ALL MASONRY AND/OR GYP. BD. PARTITION WALLS TO BE TIGHT TO UNDERSIDE OF DECK AND WITH IN FLUTES OF METAL DECK SYSTEM UNLESS OTHERWISE INDICATED. COPE AROUND STRUCTURE AND SEAL SMOKE TIGHT ALL GAPS AND PENETRATIONS.
 INTERSECTION BETWEEN RATED WALL SYSTEM AND DECK SYSTEM TO BE SEALED WITH

- APPROVED UL FIRE SPRAY MATERIAL.

 3. FIRE WALLS TO EXTEND CONTINUOUS THROUGH BUILDING WITHOUT INTERRUPTION.

 4. PROVIDE SOUIND ATTENUATING BLACKETS IN ALL VOIDS OF METAL STUD WALLS FULL HT.
- NOMINAL 4" CMU (ACTUAL WIDTH 3 5/8")
- B NOMINAL 6" CMU (ACTUAL WIDTH 5 5/8")
- C NOMINAL 8" CMU (ACTUAL WIDTH 7 5/8")
- NOMINAL 8" CMU (ACTUAL WIDTH 7 5/8") 1 HOUR FIRE-RATING (U.L. #905)
- NOMINAL 8" CMU (ACTUAL WIDTH 7 5/8") 2 HOUR FIRE-RATING (U.L. #905)
- D NOMINAL 12" CMU (ACTUAL WIDTH 11 5/8")
- NOMINAL 12" CMU (ACTUAL WIDTH 11 5/8") W/FOAM INSULATION IN ALL CORES
- NOMINAL 16" CMU
- F2> NOMINAL 16" CMU (ACTUAL WIDTH 15 1/4" 2 HOUR FIRE-RATING (U.L. #)
- 5/8" GYP. BD. ON EACH SIDE OF 6" LT. GA. METAL FRAMING AT 16" O.C. MAX.
- G1> 5/8" TYPE 'X' GYP. BD. ON EACH SIDE OF 6" LT. GA. METAL FRAMING AT 16"
- (2) LAYERS OF 5/8" TYPE "X" GYP. BD. ON EACH SIDE OF 6" LT. GA. METAL FRAMING AT 16" O.C. MAX. 2 HOUR FIRE-RATING (U.L. #419)

O.C. MAX, 1 HOUR FIRE-RATING (U.L. #419)

FLOOR PLAN KEYNOTES:

- SEMI RECESSED FIRE EXTINGUISHER CABINET LOCATION (TOOTH-IN BLOCK OR BRICK AT EXIST WALL LOCATIONS IF ANY).
- 2 CONCRETE SUPPORTED SLAB (SEE STRUCTURAL DRAWINGS)
- 3 CONCRETE SUPPORTED SLAB FULL DEPTH OF SIDE WALLS x FULL WIDTH OF
- ELECTRIC WATER COOLER
- 5 DISPLAY CASE. SEE SPEC.
- ELECTRIC WATER COOLER AND BOTTLE FILLET
- 7 2'-0" W x 6'-0" H SAFETY WALL PADS (20'-0" WIDE MIN)
- FULL WALK-OFF CARPET IN VESTIBULE
- SCORE BOARD LOCATION
- INFILL DOOR OPENING WITH BRICK / CMU FULL WIDTH AND HEIGHT OF OPENING (VERIFY TO MATCH EXIST WALL THICKNESS).
- TOOTH-IN BULLNOSE CMU AT BOTH JAMBS OF NEW DOOR OPENING
- RECESSED CABINET UNIT HEATER SEE MECHANICAL DRAWINGS
- CASEWORK SEE INTERIOR ELEVATIONS
- FORWARD FOLDING BACKSTOP SUSPENDED FROM ROOF FRAMING
- FOLDING BLEACHER SYSTEM
- VIDEO PLATFORM IN BLEACHER
- AIR INTAKE LOUVER BY MECH.
- COILING STAINLESS STEEL SHUTTER
- 9 REFRIGERATOR (BY OWNER)
- RECEPTION COUNTER CUSTOM FABRICATED (SEE DETAILS)
- NEW ARCHITECTURAL LOUVER IN WINDOW OPENING (2)
- NEW CONCRETE BENCH IN TEAM ROOMS (TYP)
- NEW 10' MARKER BOARD
- MESH STORAGE GATE PARTITION W/ 4'-0" MAIN GATES
- 25 GYM P.A. SYSTEM LOCATION
- 12'Hx22'W ELECTRICAL PROJECTION SCREEN SUSPENDED FROM TRUSSES (CENTER TO GYM FLOOR
- EXISTING WOOD MEZZANINE TO REMAIN
- 12"Dx12"Wx48"H METAL LOCKER ON 4" METAL BASE AND 4" SLOPED TOP
- 9 12"Dx12"Wx60"H METAL LOCKER ON 4" METAL BASE AND 4" SLOPED TOP

WAKELY ASSOCIATES, INC. ARCHITECTS

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INIMAINOEL LOIDERAN CIONOE & VICLASSROOM & GYMNASIUM ADDITION
47120 Romeo Plank Road, Macomb, MI 48044

FIRST FLOOR NEW WORK PLAN - AREA B

PRELIMINARY
DESIGN DEVELOPMENT
CONSTRUCTION
FINAL RECORD


DRAWN BY: JAG
CHECKED BY: BJS

REVISIONS:
Construction Set
04/25/17

DATE: 03/
SHEET NO.:

A1.1

NO.: 141594

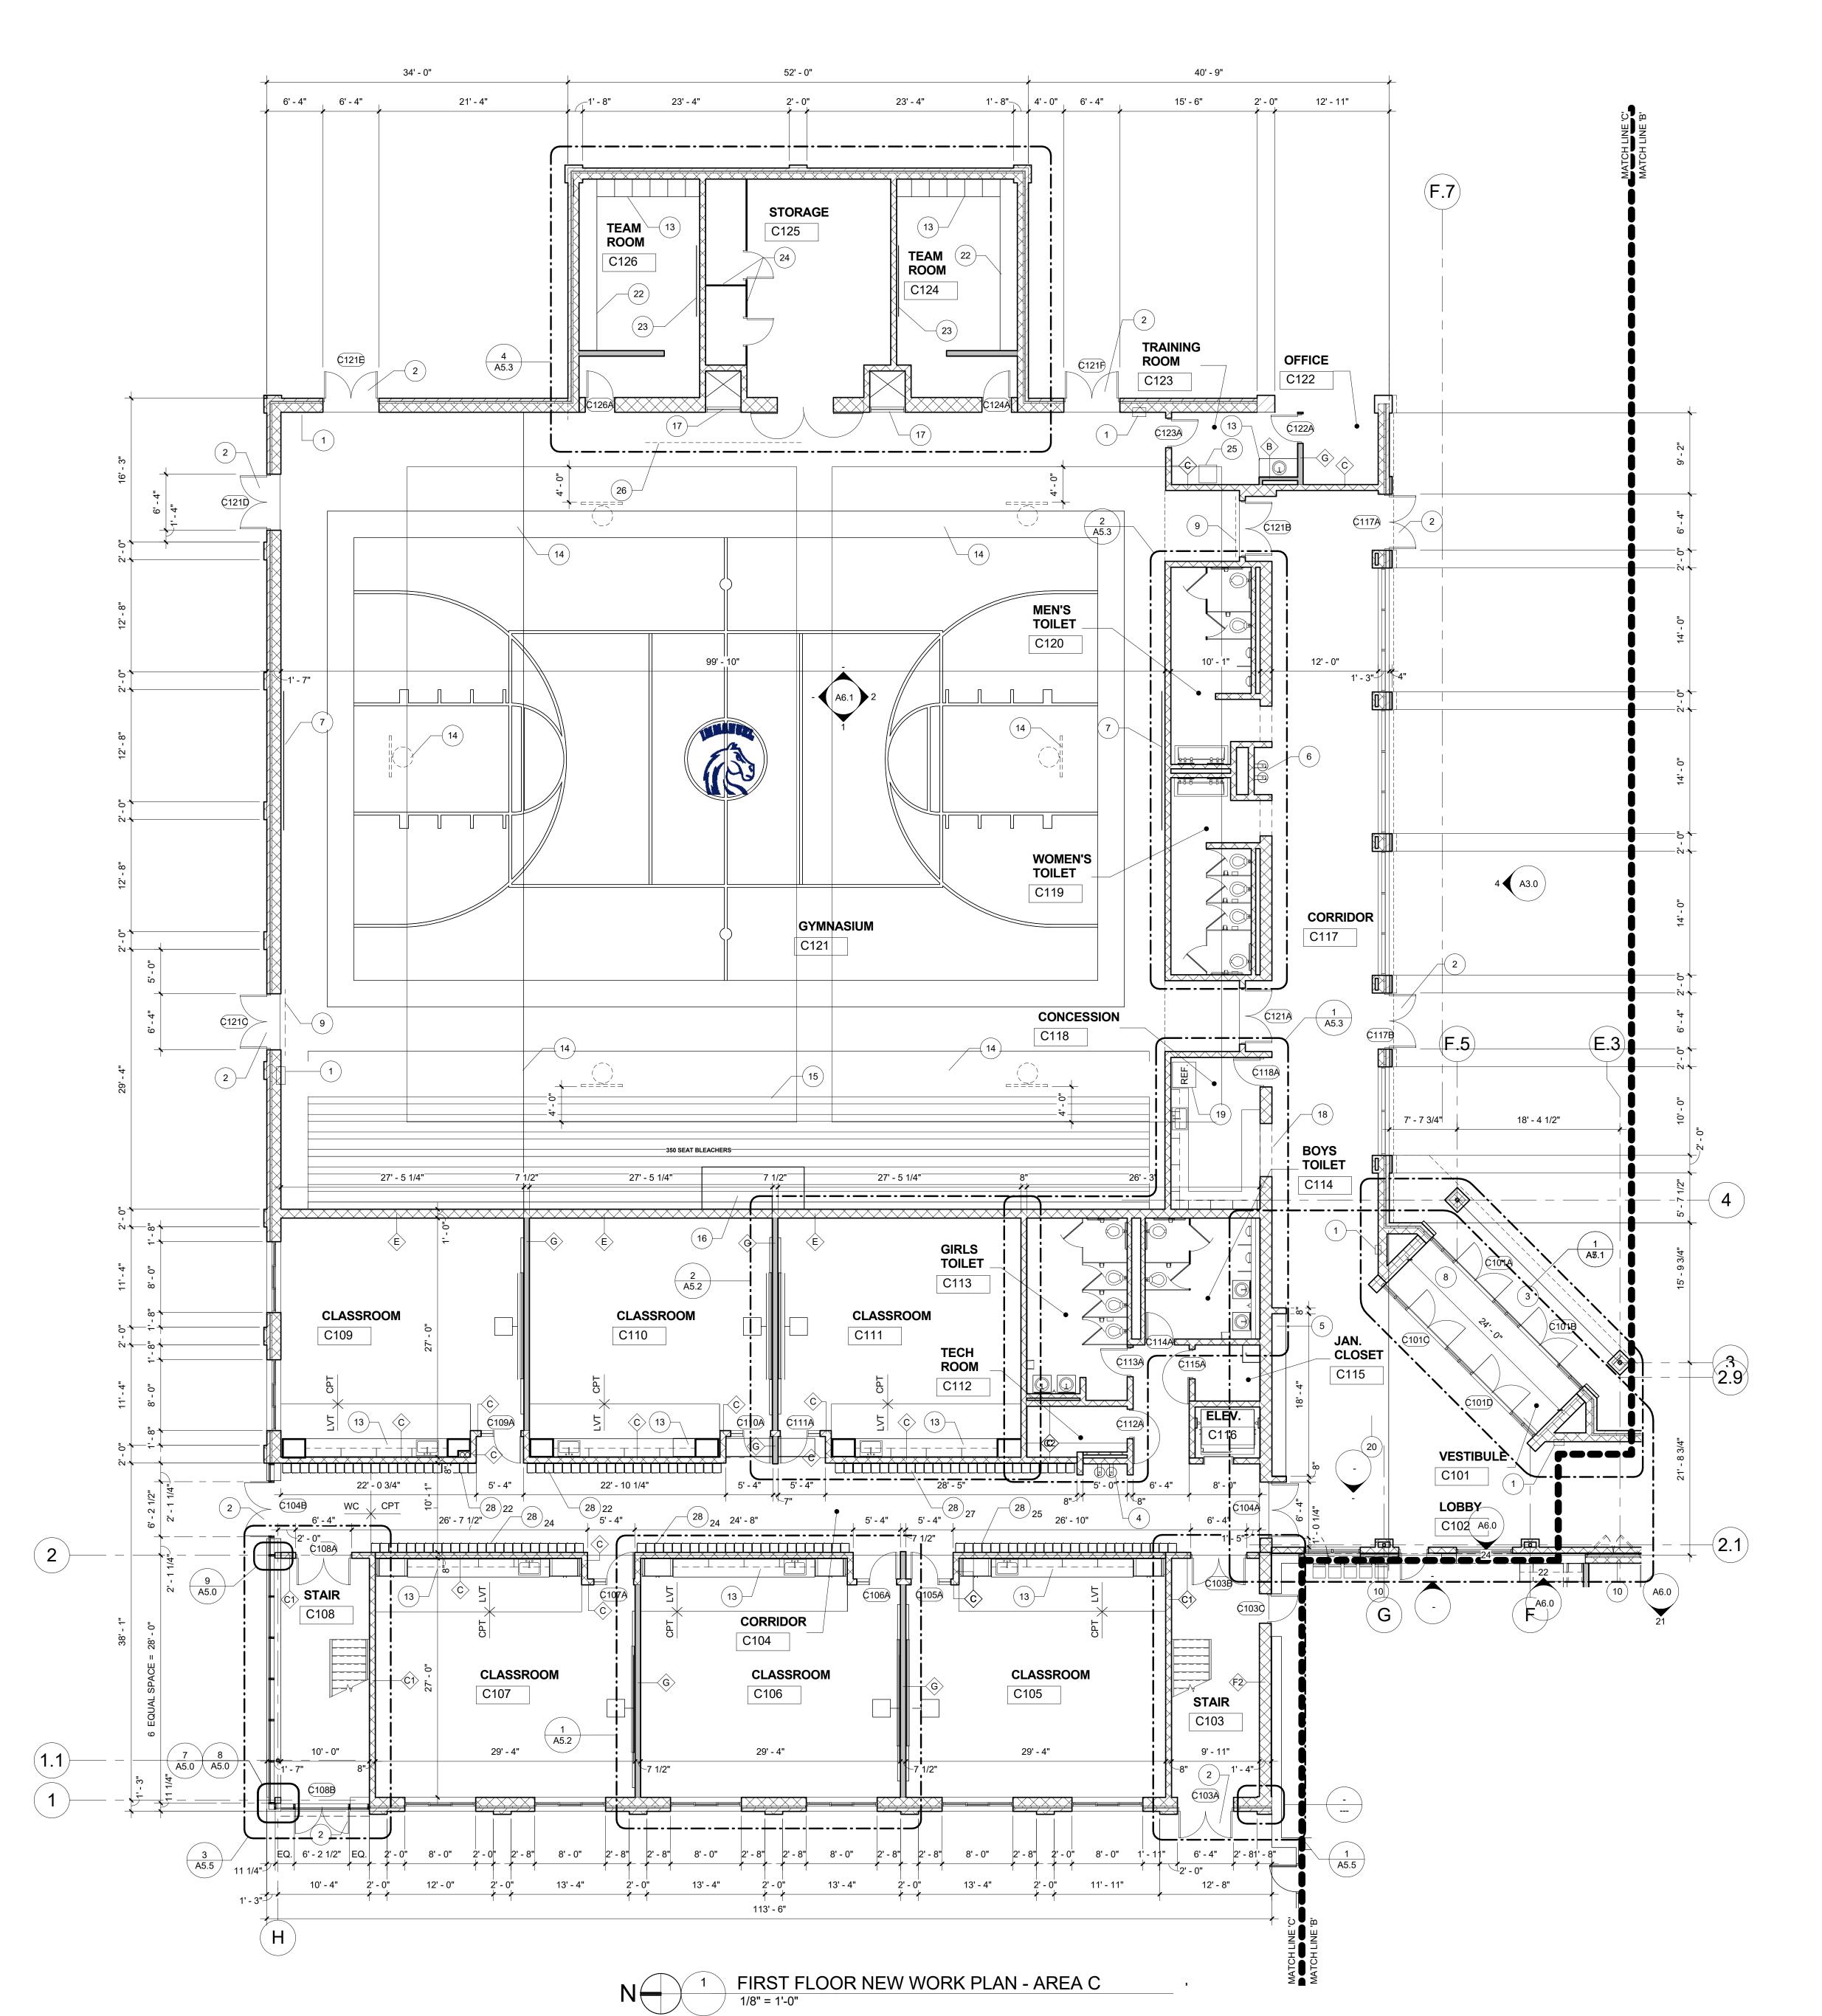

- FLOOR PLANS ARE DIMENSIONED TO NOMINAL PARTITION THICKNESS (TYP).
 ALL WALLS TO BE CMU TO UNDERSIDE OF STRUCTURE ABOVE AND FIRE STOPPED WITHIN "FLUTES" OF METAL DECK SYSTEM, UNLESS OTHERWISE NOTED OR
- DETAILED. COPE AROUND STRUCTURE AND SEAL TIGHT ALL GAPS AND PENETRATIONS.

 3. PROVIDE BULLNOSE CMU ON ALL EXPOSED CMU CORNERS UNLESS OTHERWISE NOTED.
- 4. VERIFY QUANTITY, SIZE AND LOCATION OF ALL FLOOR, ROOF AND WALL OPENINGS FOR MECHANICAL AND ELECTRICAL WORK WITH THE APPROPRIATE TRADE, PROVIDE ALL OPENINGS SHOWN OR REQUIRED FOR THE COMPLETION OF THE WORK.
- 5. REFER TO ___ SERIES DRAWINGS FOR CASEWORK AND INTERIOR ELEVATIONS.
- 6. SEE EXTERIOR ELEVATIONS FOR LOCATIONS OF CONTROL JOINTS IN EXTERIOR WALLS.
 7. ALL EXPOSED STEEL COLUMNS AND MISCELLANEOUS METALS SHALL BE PRIMED AND
- ALL EXPOSED STEEL COLUMNS AND MISCELLANEOUS METALS SHALL BE PRIME PAINTED
- 8. REFER TO LS1.0 FOR FIRE RATING OF WALLS.

WALL TYPES

NOTES:

- ALL MASONRY AND/OR GYP. BD. PARTITION WALLS TO BE TIGHT TO UNDERSIDE OF DECK AND WITH IN FLUTES OF METAL DECK SYSTEM UNLESS OTHERWISE INDICATED. COPE AROUND STRUCTURE AND SEAL SMOKE TIGHT ALL GAPS AND PENETRATIONS.
- APPROVED UL FIRE SPRAY MATERIAL.

 3. FIRE WALLS TO EXTEND CONTINUOUS THROUGH BUILDING WITHOUT INTERRUPTION.

 4. PROVIDE SOUIND ATTENUATING BLACKETS IN ALL VOIDS OF METAL STUD WALLS FULL HT.

INTERSECTION BETWEEN RATED WALL SYSTEM AND DECK SYSTEM TO BE SEALED WITH

- A NOMINAL 4" CMU (ACTUAL WIDTH 3 5/8")
- B NOMINAL 6" CMU (ACTUAL WIDTH 5 5/8")
- C NOMINAL 8" CMU (ACTUAL WIDTH 7 5/8")
- NOMINAL 8" CMU (ACTUAL WIDTH 7 5/8") 1 HOUR FIRE-RATING (U.L. #905)
- NOMINAL 8" CMU (ACTUAL WIDTH 7 5/8") 2 HOUR FIRE-RATING (U.L. #905)
- NOMINAL 12" CMU (ACTUAL WIDTH 11 5/8")
- NOMINAL 12" CMU (ACTUAL WIDTH 11 5/8") W/FOAM INSULATION IN ALL CORES
- F NOMINAL 16" CMU
- F2> NOMINAL 16" CMU (ACTUAL WIDTH 15 1/4" 2 HOUR FIRE-RATING (U.L. #)
- G 5/8" GYP. BD. ON EACH SIDE OF 6" LT. GA. METAL FRAMING AT 16" O.C. MAX.
- G1> 5/8" TYPE 'X' GYP. BD. ON EACH SIDE OF 6" LT. GA. METAL FRAMING AT 16" O.C. MAX, 1 HOUR FIRE-RATING (U.L. #419)
- (2) LAYERS OF 5/8" TYPE "X" GYP. BD. ON EACH SIDE OF 6" LT. GA. METAL FRAMING AT 16" O.C. MAX. 2 HOUR FIRE-RATING (U.L. #419)

FLOOR PLAN KEYNOTES:

- SEMI RECESSED FIRE EXTINGUISHER CABINET LOCATION (TOOTH-IN BLOCK OR BRICK AT EXIST WALL LOCATIONS IF ANY).
- 2 CONCRETE SUPPORTED SLAB (SEE STRUCTURAL DRAWINGS)
- 3 CONCRETE SUPPORTED SLAB FULL DEPTH OF SIDE WALLS x FULL WIDTH OF
- 4 ELECTRIC WATER COOLER
- DISPLAY CASE. SEE SPEC.
- 6 ELECTRIC WATER COOLER AND BOTTLE FILLET
- 2'-0" W x 6'-0" H SAFETY WALL PADS (20'-0" WIDE MIN)
- FULL WALK-OFF CARPET IN VESTIBULE
- SCORE BOARD LOCATION
- INFILL DOOR OPENING WITH BRICK / CMU FULL WIDTH AND HEIGHT OF OPENING (VERIFY TO MATCH EXIST WALL THICKNESS).
- TOOTH-IN BULLNOSE CMU AT BOTH JAMBS OF NEW DOOR OPENING
- RECESSED CABINET UNIT HEATER SEE MECHANICAL DRAWINGS
- CASEWORK SEE INTERIOR ELEVATIONS
- forward folding backstop suspended from roof framing
- 15 FOLDING BLEACHER SYSTEM
- VIDEO PLATFORM IN BLEACHER
- AIR INTAKE LOUVER BY MECH.
- COILING STAINLESS STEEL SHUTTER
- 19 REFRIGERATOR (BY OWNER)
- RECEPTION COUNTER CUSTOM FABRICATED (SEE DETAILS)
- NEW ARCHITECTURAL LOUVER IN WINDOW OPENING (2)
- NEW CONCRETE BENCH IN TEAM ROOMS (TYP)

GYM P.A. SYSTEM LOCATION

- NEW 10' MARKER BOARD
- 24 MESH STORAGE GATE PARTITION W/ 4'-0" MAIN GATES
- (26) 12'Hx22'W ELECTRICAL PROJECTION SCREEN SUSPENDED FROM TRUSSES (CENTER
- 27 EXISTING WOOD MEZZANINE TO REMAIN

12"Dx12"Wx60"H METAL LOCKER ON 4" METAL BASE AND 4" SLOPED TOP

28 12"Dx12"Wx48"H METAL LOCKER ON 4" METAL BASE AND 4" SLOPED TOP

DRAWN BY: JA
CHECKED BY: BJ
REVISIONS:
Construction Set

DESIGN DEVELOPMENT

CONSTRUCTION

PLAN - AREA 'C'

PRELIMINARY

WAKELY ASSOCIATES, INC.

30500 VAN DYKE AVENUE

WARREN, MICHIGAN 48093

ARCHITECTS

SUITE M-7

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www.wakelyaia.com

Construction Set 04/25/17

SHEET NO.:

- 1. FLOOR PLANS ARE DIMENSIONED TO NOMINAL PARTITION THICKNESS (TYP). ALL WALLS TO BE CMU TO UNDERSIDE OF STRUCTURE ABOVE AND FIRE STOPPED WITHIN "FLUTES" OF METAL DECK SYSTEM, UNLESS OTHERWISE NOTED OR DETAILED. COPE AROUND STRUCTURE AND SEAL TIGHT ALL GAPS AND
- PROVIDE BULLNOSE CMU ON ALL EXPOSED CMU CORNERS UNLESS OTHERWISE NOTED.
- VERIFY QUANTITY, SIZE AND LOCATION OF ALL FLOOR, ROOF AND WALL OPENINGS FOR MECHANICAL AND ELECTRICAL WORK WITH THE APPROPRIATE TRADE, PROVIDE ALL OPENINGS SHOWN OR REQUIRED FOR THE COMPLETION OF THE WORK.
- 5. REFER TO ___ SERIES DRAWINGS FOR CASEWORK AND INTERIOR ELEVATIONS.
- 6. SEE EXTERIOR ELEVATIONS FOR LOCATIONS OF CONTROL JOINTS IN EXTERIOR WALLS.
- ALL EXPOSED STEEL COLUMNS AND MISCELLANEOUS METALS SHALL BE PRIMED AND
- 8. REFER TO LS1.0 FOR FIRE RATING OF WALLS.

WALL TYPES

- 1. ALL MASONRY AND/OR GYP. BD. PARTITION WALLS TO BE TIGHT TO UNDERSIDE OF DECK AND WITH IN FLUTES OF METAL DECK SYSTEM UNLESS OTHERWISE INDICATED. COPE AROUND STRUCTURE AND SEAL SMOKE TIGHT ALL GAPS AND PENETRATIONS. INTERSECTION BETWEEN RATED WALL SYSTEM AND DECK SYSTEM TO BE SEALED WITH
- APPROVED UL FIRE SPRAY MATERIAL. FIRE WALLS TO EXTEND CONTINUOUS THROUGH BUILDING WITHOUT INTERRUPTION. PROVIDE SOUIND ATTENUATING BLACKETS IN ALL VOIDS OF METAL STUD WALLS FULL HT.
- NOMINAL 4" CMU (ACTUAL WIDTH 3 5/8")
- NOMINAL 6" CMU (ACTUAL WIDTH 5 5/8")
- NOMINAL 8" CMU (ACTUAL WIDTH 7 5/8")
- NOMINAL 8" CMU (ACTUAL WIDTH 7 5/8") 1 HOUR FIRE-RATING (U.L. #905)
- NOMINAL 8" CMU (ACTUAL WIDTH 7 5/8") 2 HOUR FIRE-RATING (U.L. #905)
- NOMINAL 12" CMU (ACTUAL WIDTH 11 5/8")
- NOMINAL 12" CMU (ACTUAL WIDTH 11 5/8") W/FOAM INSULATION IN ALL CORES

NOMINAL 16" CMU

- NOMINAL 16" CMU (ACTUAL WIDTH 15 1/4" 2 HOUR FIRE-RATING (U.L. #)

5/8" GYP. BD. ON EACH SIDE OF 6" LT. GA. METAL FRAMING AT 16" O.C. MAX.

- 5/8" TYPE 'X' GYP. BD. ON EACH SIDE OF 6" LT. GA. METAL FRAMING AT 16"
- (2) LAYERS OF 5/8" TYPE "X" GYP. BD. ON EACH SIDE OF 6" LT. GA. MÉTAL FRAMING AT 16" O.C. MAX. 2 HOUR FIRE-RATING (U.L. #419)

O.C. MAX, 1 HOUR FIRE-RATING (U.L. #419)

FLOOR PLAN KEYNOTES:

- SEMI RECESSED FIRE EXTINGUISHER CABINET LOCATION (TOOTH-IN BLOCK OR BRICK AT EXIST WALL LOCATIONS IF ANY).
- CONCRETE SUPPORTED SLAB (SEE STRUCTURAL DRAWINGS)
- CONCRETE SUPPORTED SLAB FULL DEPTH OF SIDE WALLS x FULL WIDTH OF
- ELECTRIC WATER COOLER
- DISPLAY CASE. SEE SPEC.
- ELECTRIC WATER COOLER AND BOTTLE FILLET
- 2'-0" W x 6'-0" H SAFETY WALL PADS (20'-0" WIDE MIN)
- FULL WALK-OFF CARPET IN VESTIBULE
- SCORE BOARD LOCATION
- INFILL DOOR OPENING WITH BRICK / CMU FULL WIDTH AND HEIGHT OF OPENING (VERIFY TO MATCH EXIST WALL THICKNESS).
- TOOTH-IN BULLNOSE CMU AT BOTH JAMBS OF NEW DOOR OPENING
- RECESSED CABINET UNIT HEATER SEE MECHANICAL DRAWINGS
- CASEWORK SEE INTERIOR ELEVATIONS
- FORWARD FOLDING BACKSTOP SUSPENDED FROM ROOF FRAMING
- FOLDING BLEACHER SYSTEM
- VIDEO PLATFORM IN BLEACHER
- AIR INTAKE LOUVER BY MECH.

COILING STAINLESS STEEL SHUTTER

- REFRIGERATOR (BY OWNER)
- RECEPTION COUNTER CUSTOM FABRICATED (SEE DETAILS) NEW ARCHITECTURAL LOUVER IN WINDOW OPENING (2)
- NEW CONCRETE BENCH IN TEAM ROOMS (TYP)
- NEW 10' MARKER BOARD
- MESH STORAGE GATE PARTITION W/ 4'-0" MAIN GATES
- GYM P.A. SYSTEM LOCATION
- 12'Hx22'W ELECTRICAL PROJECTION SCREEN SUSPENDED FROM TRUSSES (CENTER
- EXISTING WOOD MEZZANINE TO REMAIN
- 12"Dx12"Wx48"H METAL LOCKER ON 4" METAL BASE AND 4" SLOPED TOP
- 12"Dx12"Wx60"H METAL LOCKER ON 4" METAL BASE AND 4" SLOPED TOP

WAKELY ASSOCIATES, INC. ARCHITECTS

30500 VAN DYKE AVENUE SUITE M-7 WARREN, MICHIGAN 48093 PH: 586.573.4100 FX: 586.573.0822 www.wakelyaia.com


NEW WORK PLAN SECOND FLOOR PLAN - AREA C

PRELIMINARY DESIGN DEVELOPMENT CONSTRUCTION FINAL RECORD CHECKED BY:

REVISIONS: Construction Set

SHEET NO.:

A1.3

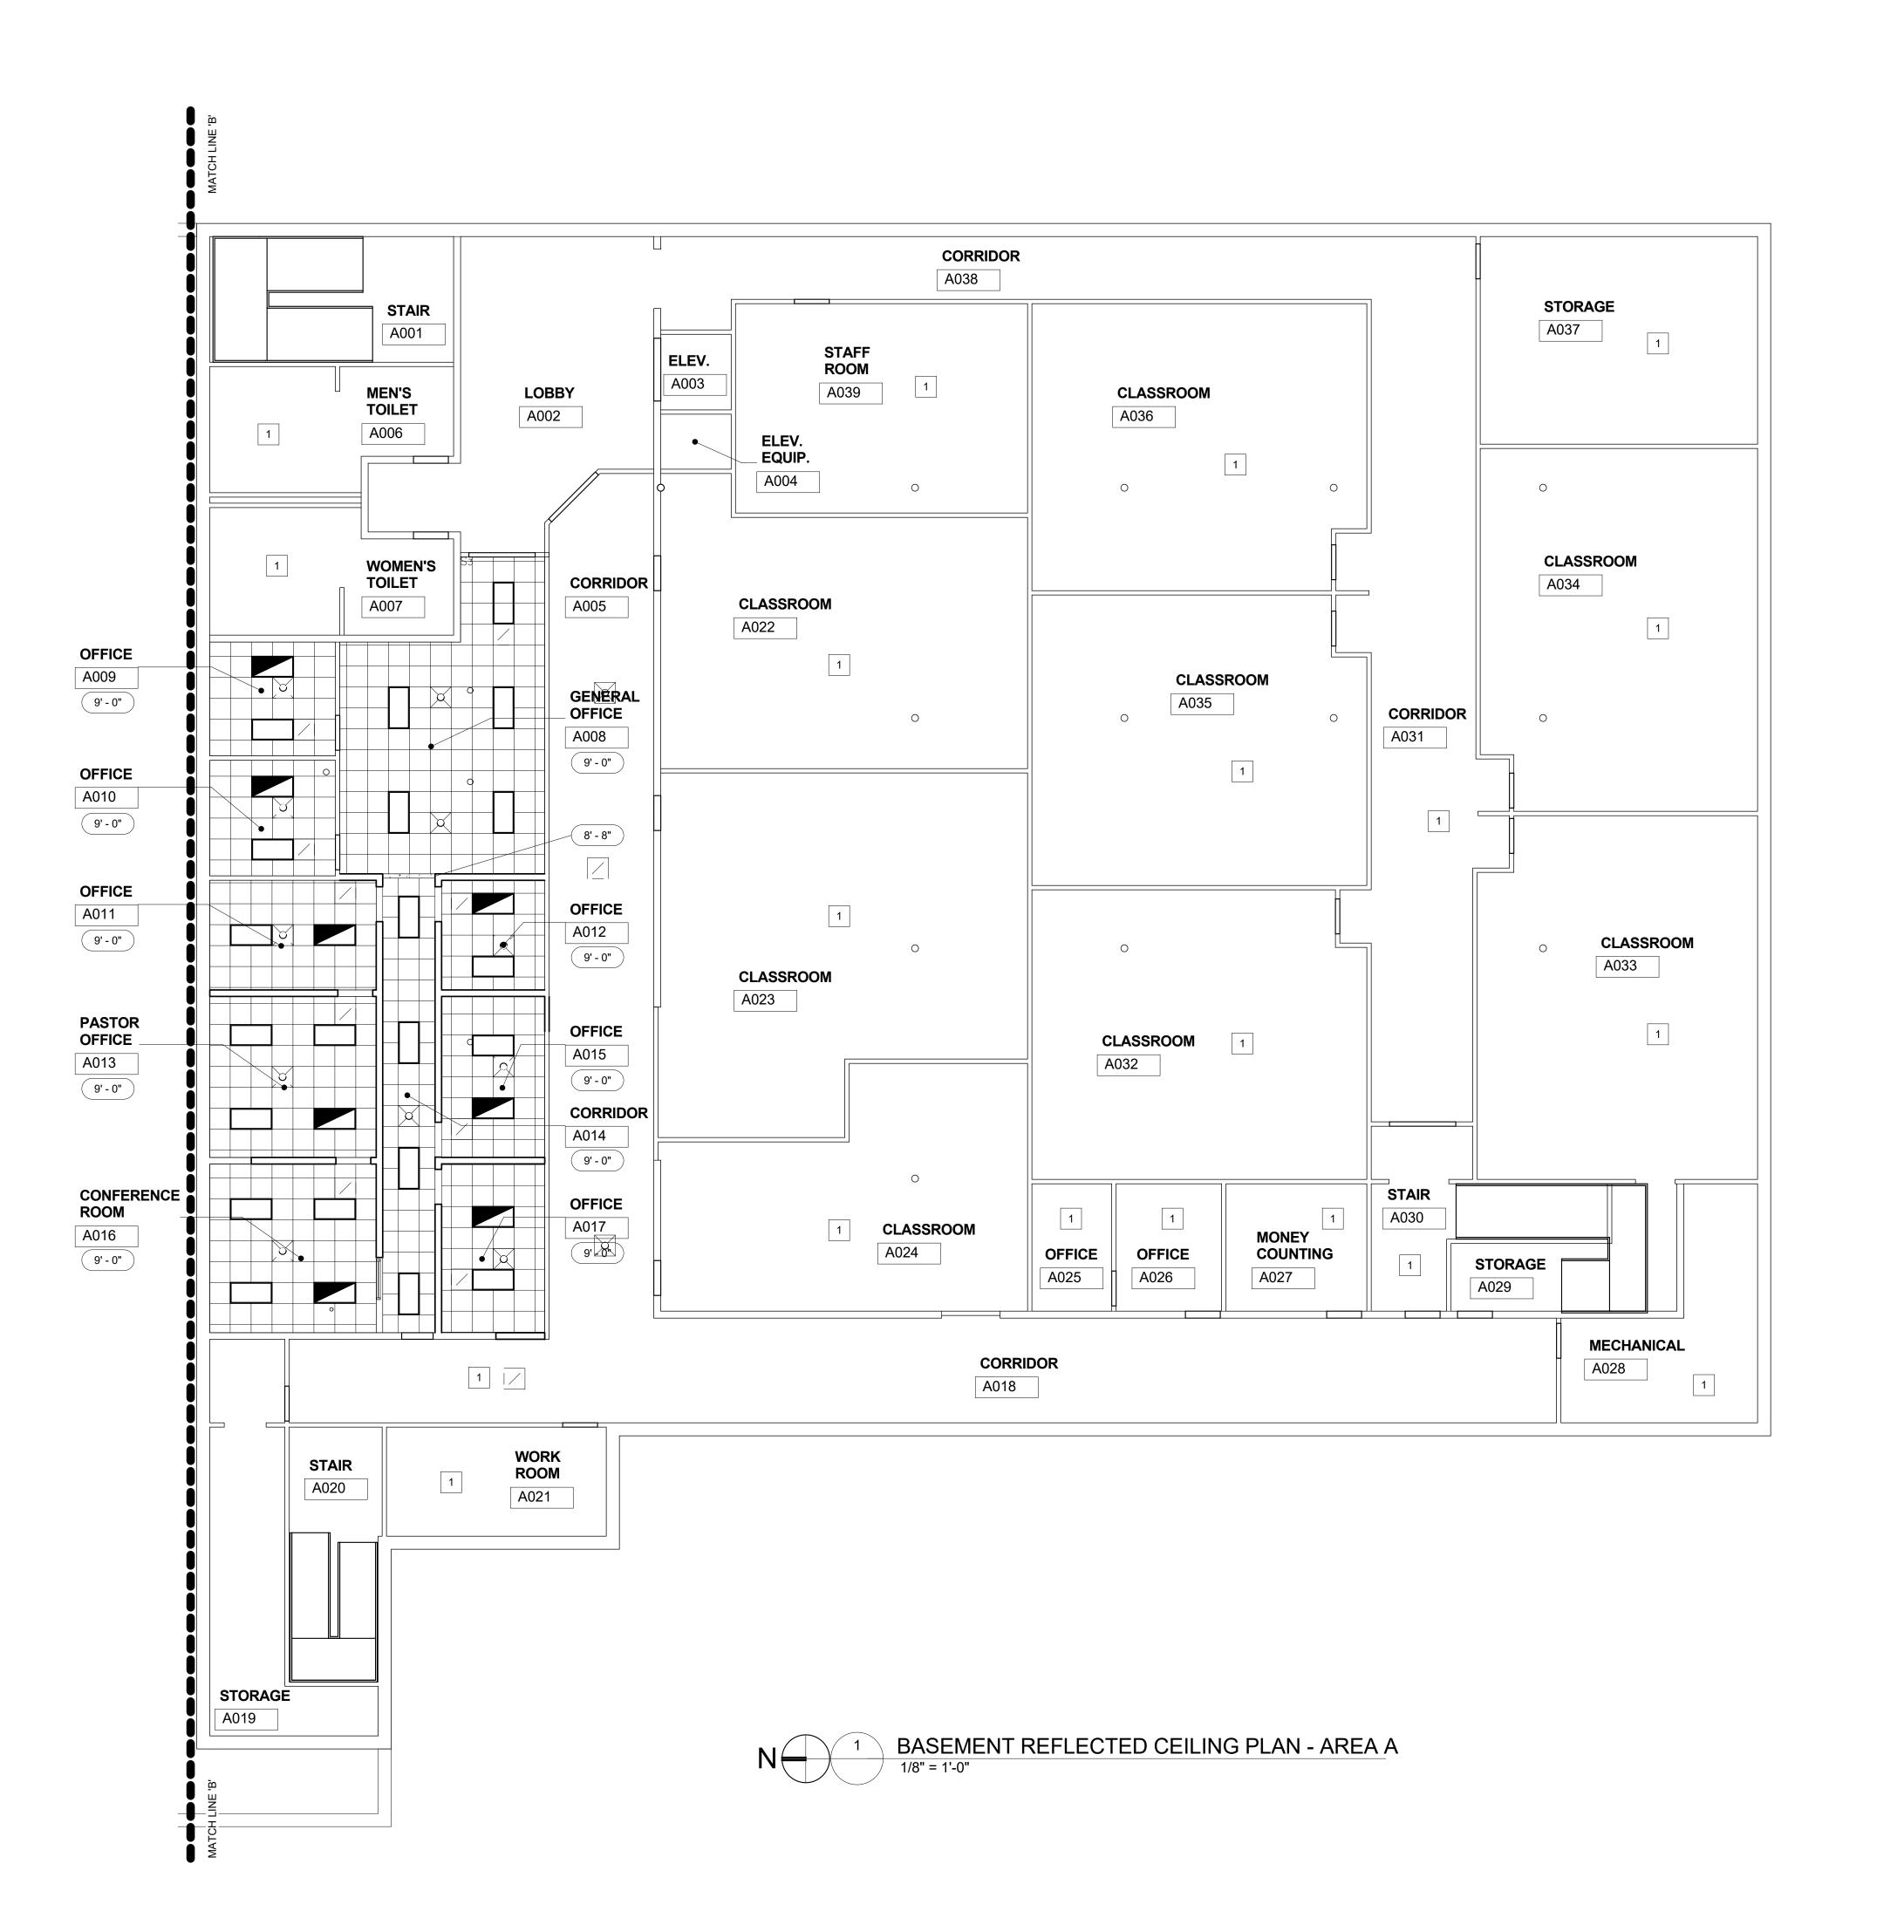

REFLECTED CEILING PLAN NOTES:

- 1 EXISTING CEILING TO REMAIN.
- 2 EXPOSED CONSTRUCTION TO BE PAINTED. SEE FINISH SCHEDULE FOR COLORS.
- REMOVE/REPLACE EXISTING CEILING CONSTRUCTION AS REQUIRED TO INSTALL NEW SPRINKLER SYSTEM AND PIPING ABOVE EXISTING CEILING.

GENERAL NOTES:

 REFER TO ELECTRICAL DRAWINGS FOR LIGHT FIXTURE TYPE, LAYOUT AND QUANTITY.
 REFER TO MECHANICAL DRAWINGS FOR DIFFUSER AND GRILLE LOCATIONS AND SIZES.



WAKELY ASSOCIATES, INC. ARCHITECTS

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ANUEL LUTHERAN CHURCH & SCHOC SROOM & GYMNASIUM ADDITION

O 4

BASEMENT REFLECTED CEILING PLANS

PRELIMINARY
DESIGN DEVELOPMENT
CONSTRUCTION
FINAL RECORD

DRAWN BY:
CHECKED BY:

REVISIONS:

Construction Set
04/25/17

PATE: 03/10/

A2.0

REFLECTED CEILING PLAN NOTES:

2 EXPOSED CONSTRUCTION TO BE PAINTED. SEE FINISH SCHEDULE FOR COLORS.

3 REMOVE/REPLACE EXISTING CEILING CONSTRUCTION AS REQUIRED TO INSTALL NEW SPRINKLER SYSTEM AND PIPING ABOVE EXISTING CEILING.

- REFER TO ELECTRICAL DRAWINGS FOR LIGHT FIXTURE
- TYPE, LAYOUT AND QUANTITY.
 REFER TO MECHANICAL DRAWINGS FOR DIFFUSER AND GRILLE LOCATIONS AND SIZES.

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WAKELY ASSOCIATES, INC.

30500 VAN DYKE AVENUE

WARREN, MICHIGAN 48093

ARCHITECTS

SUITE M-7

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FX: 586.573.0822

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FIRST FLOOR REFLECTED CEILING PLAN - AREA 'C'

DESIGN DEVELOPMENT


FINAL RECORD

CHECKED BY: REVISIONS:

Construction Set 04/25/17

SHEET NO.:

A2.1

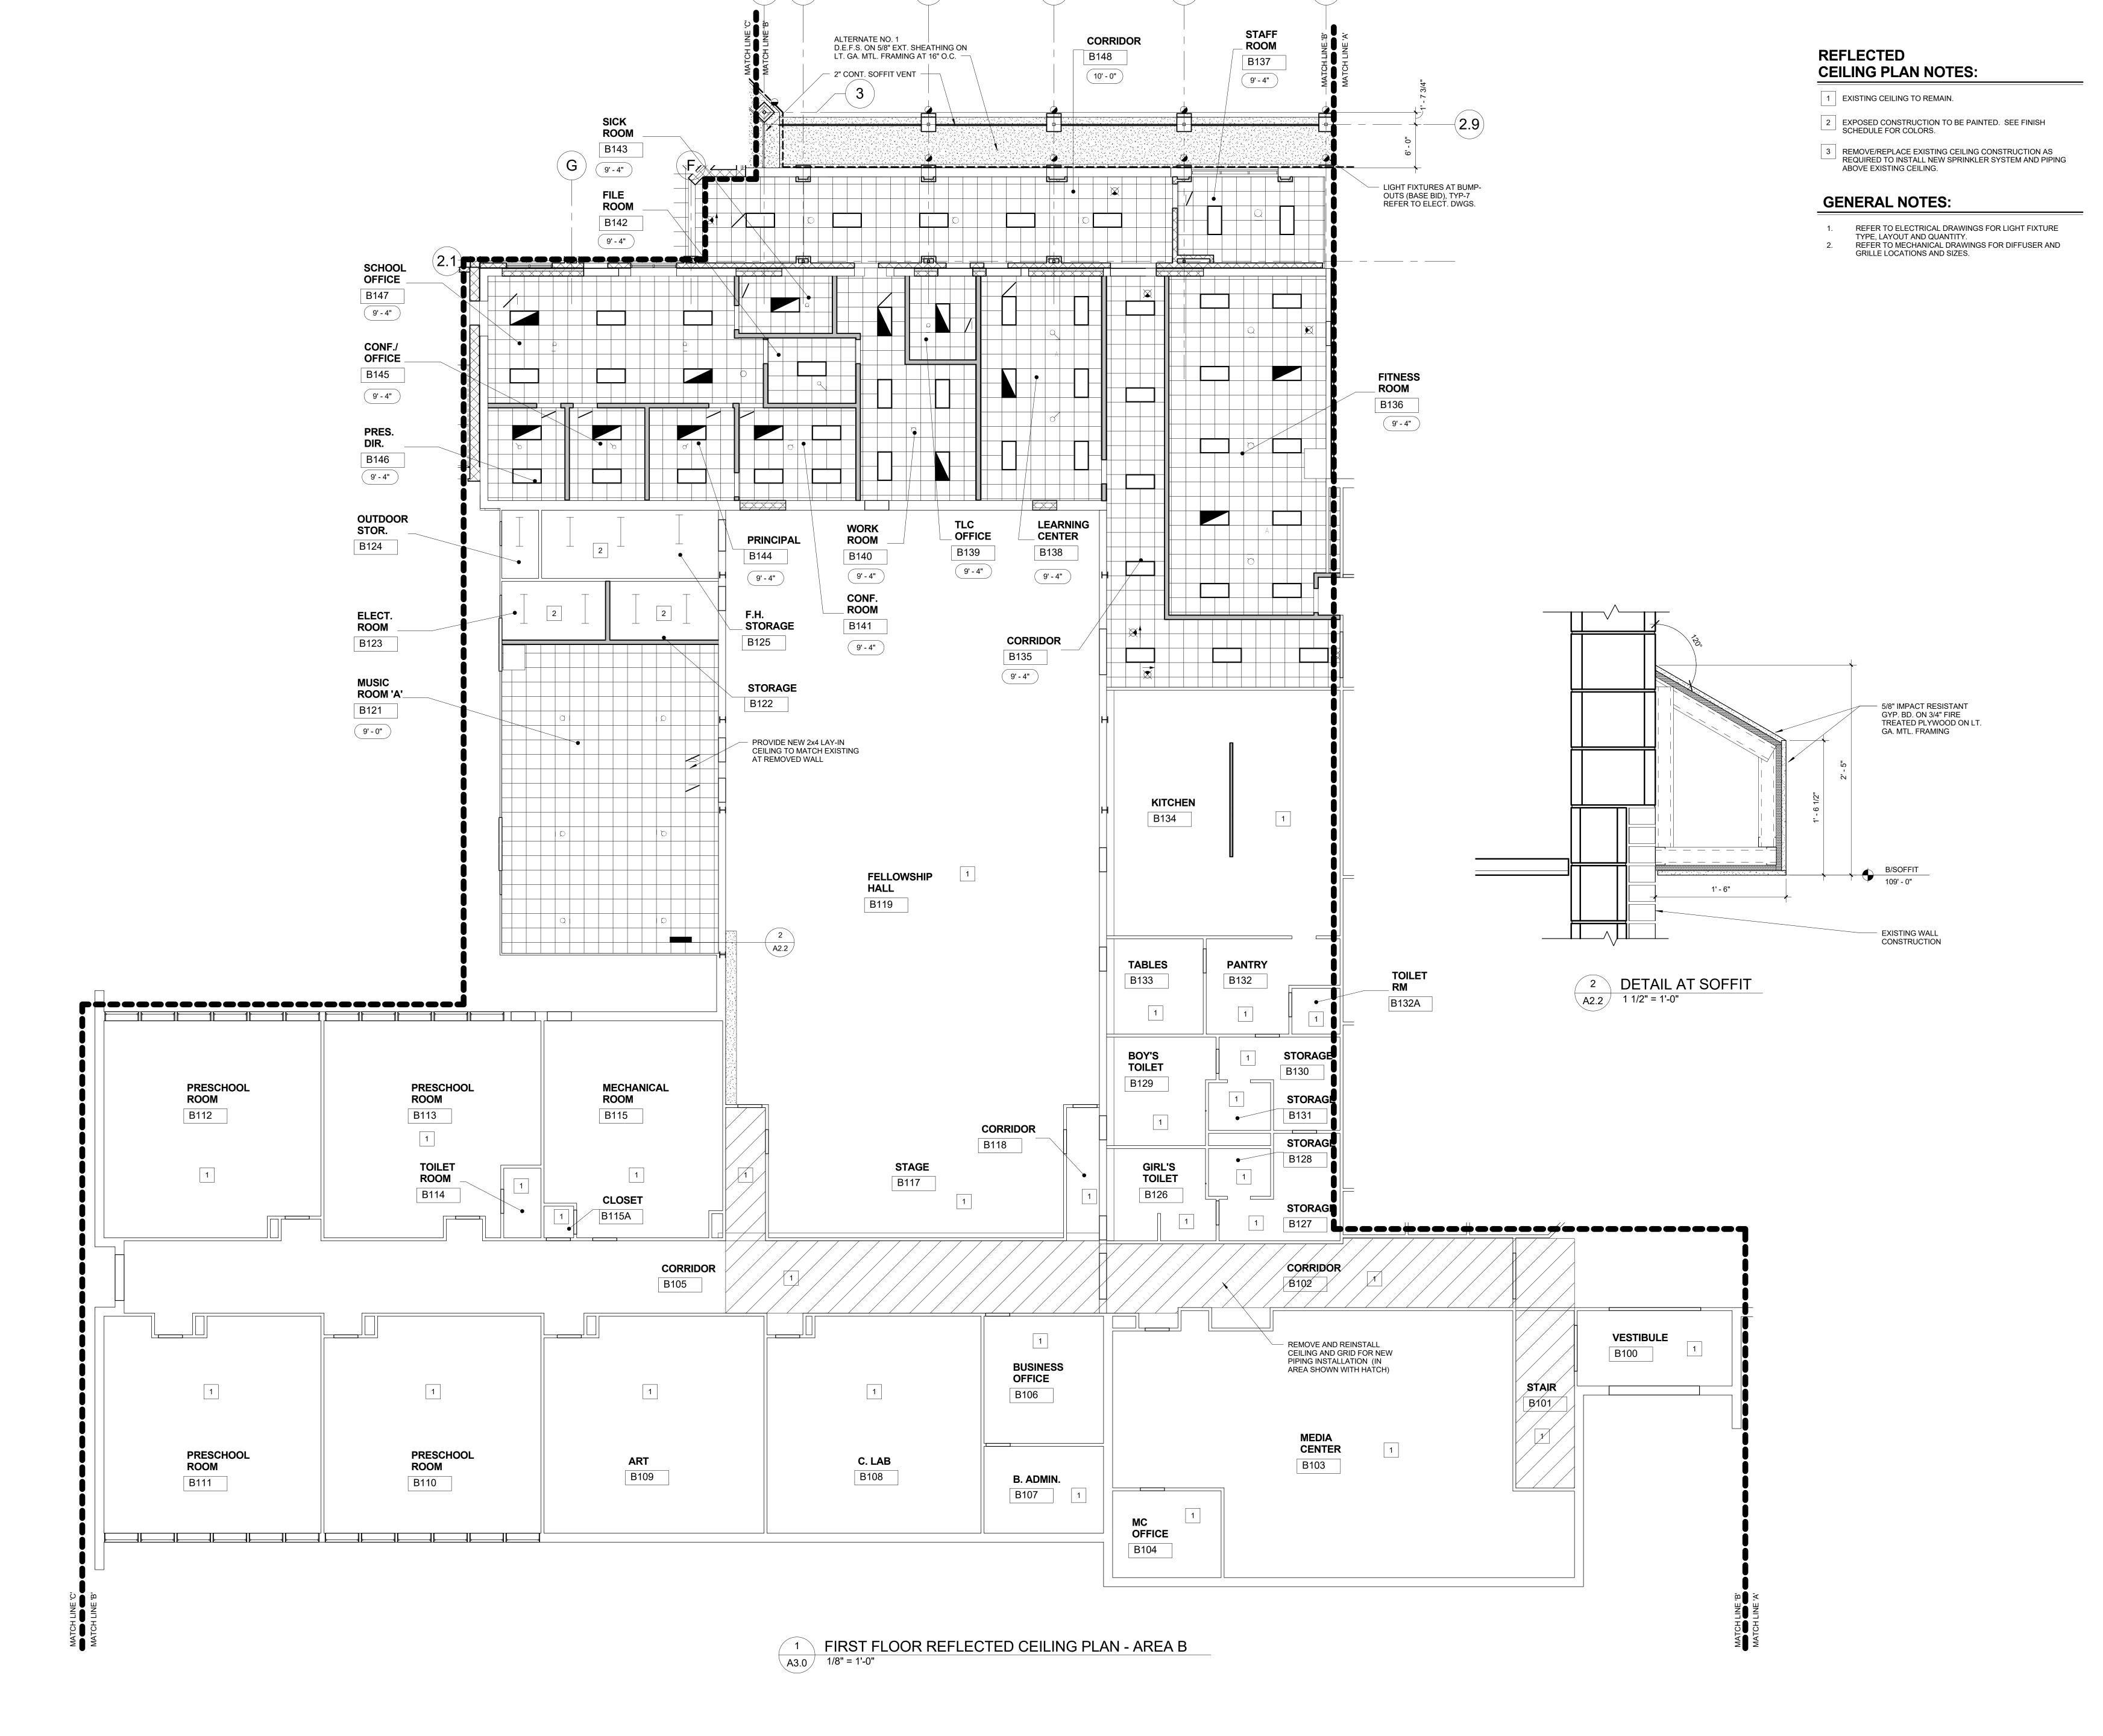

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CHURCH & SCHOO

FIRST FLOOR REFLECTED CEILING PLAN - AREA B

PRELIMINARY

DESIGN DEVELOPMENT

CONSTRUCTION

FINAL RECORD

DRAWN BY:

CHECKED BY:

BJS


REVISIONS:

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04/25/17

J/25/17

DATE: 0
SHEET NO.:

A2.2

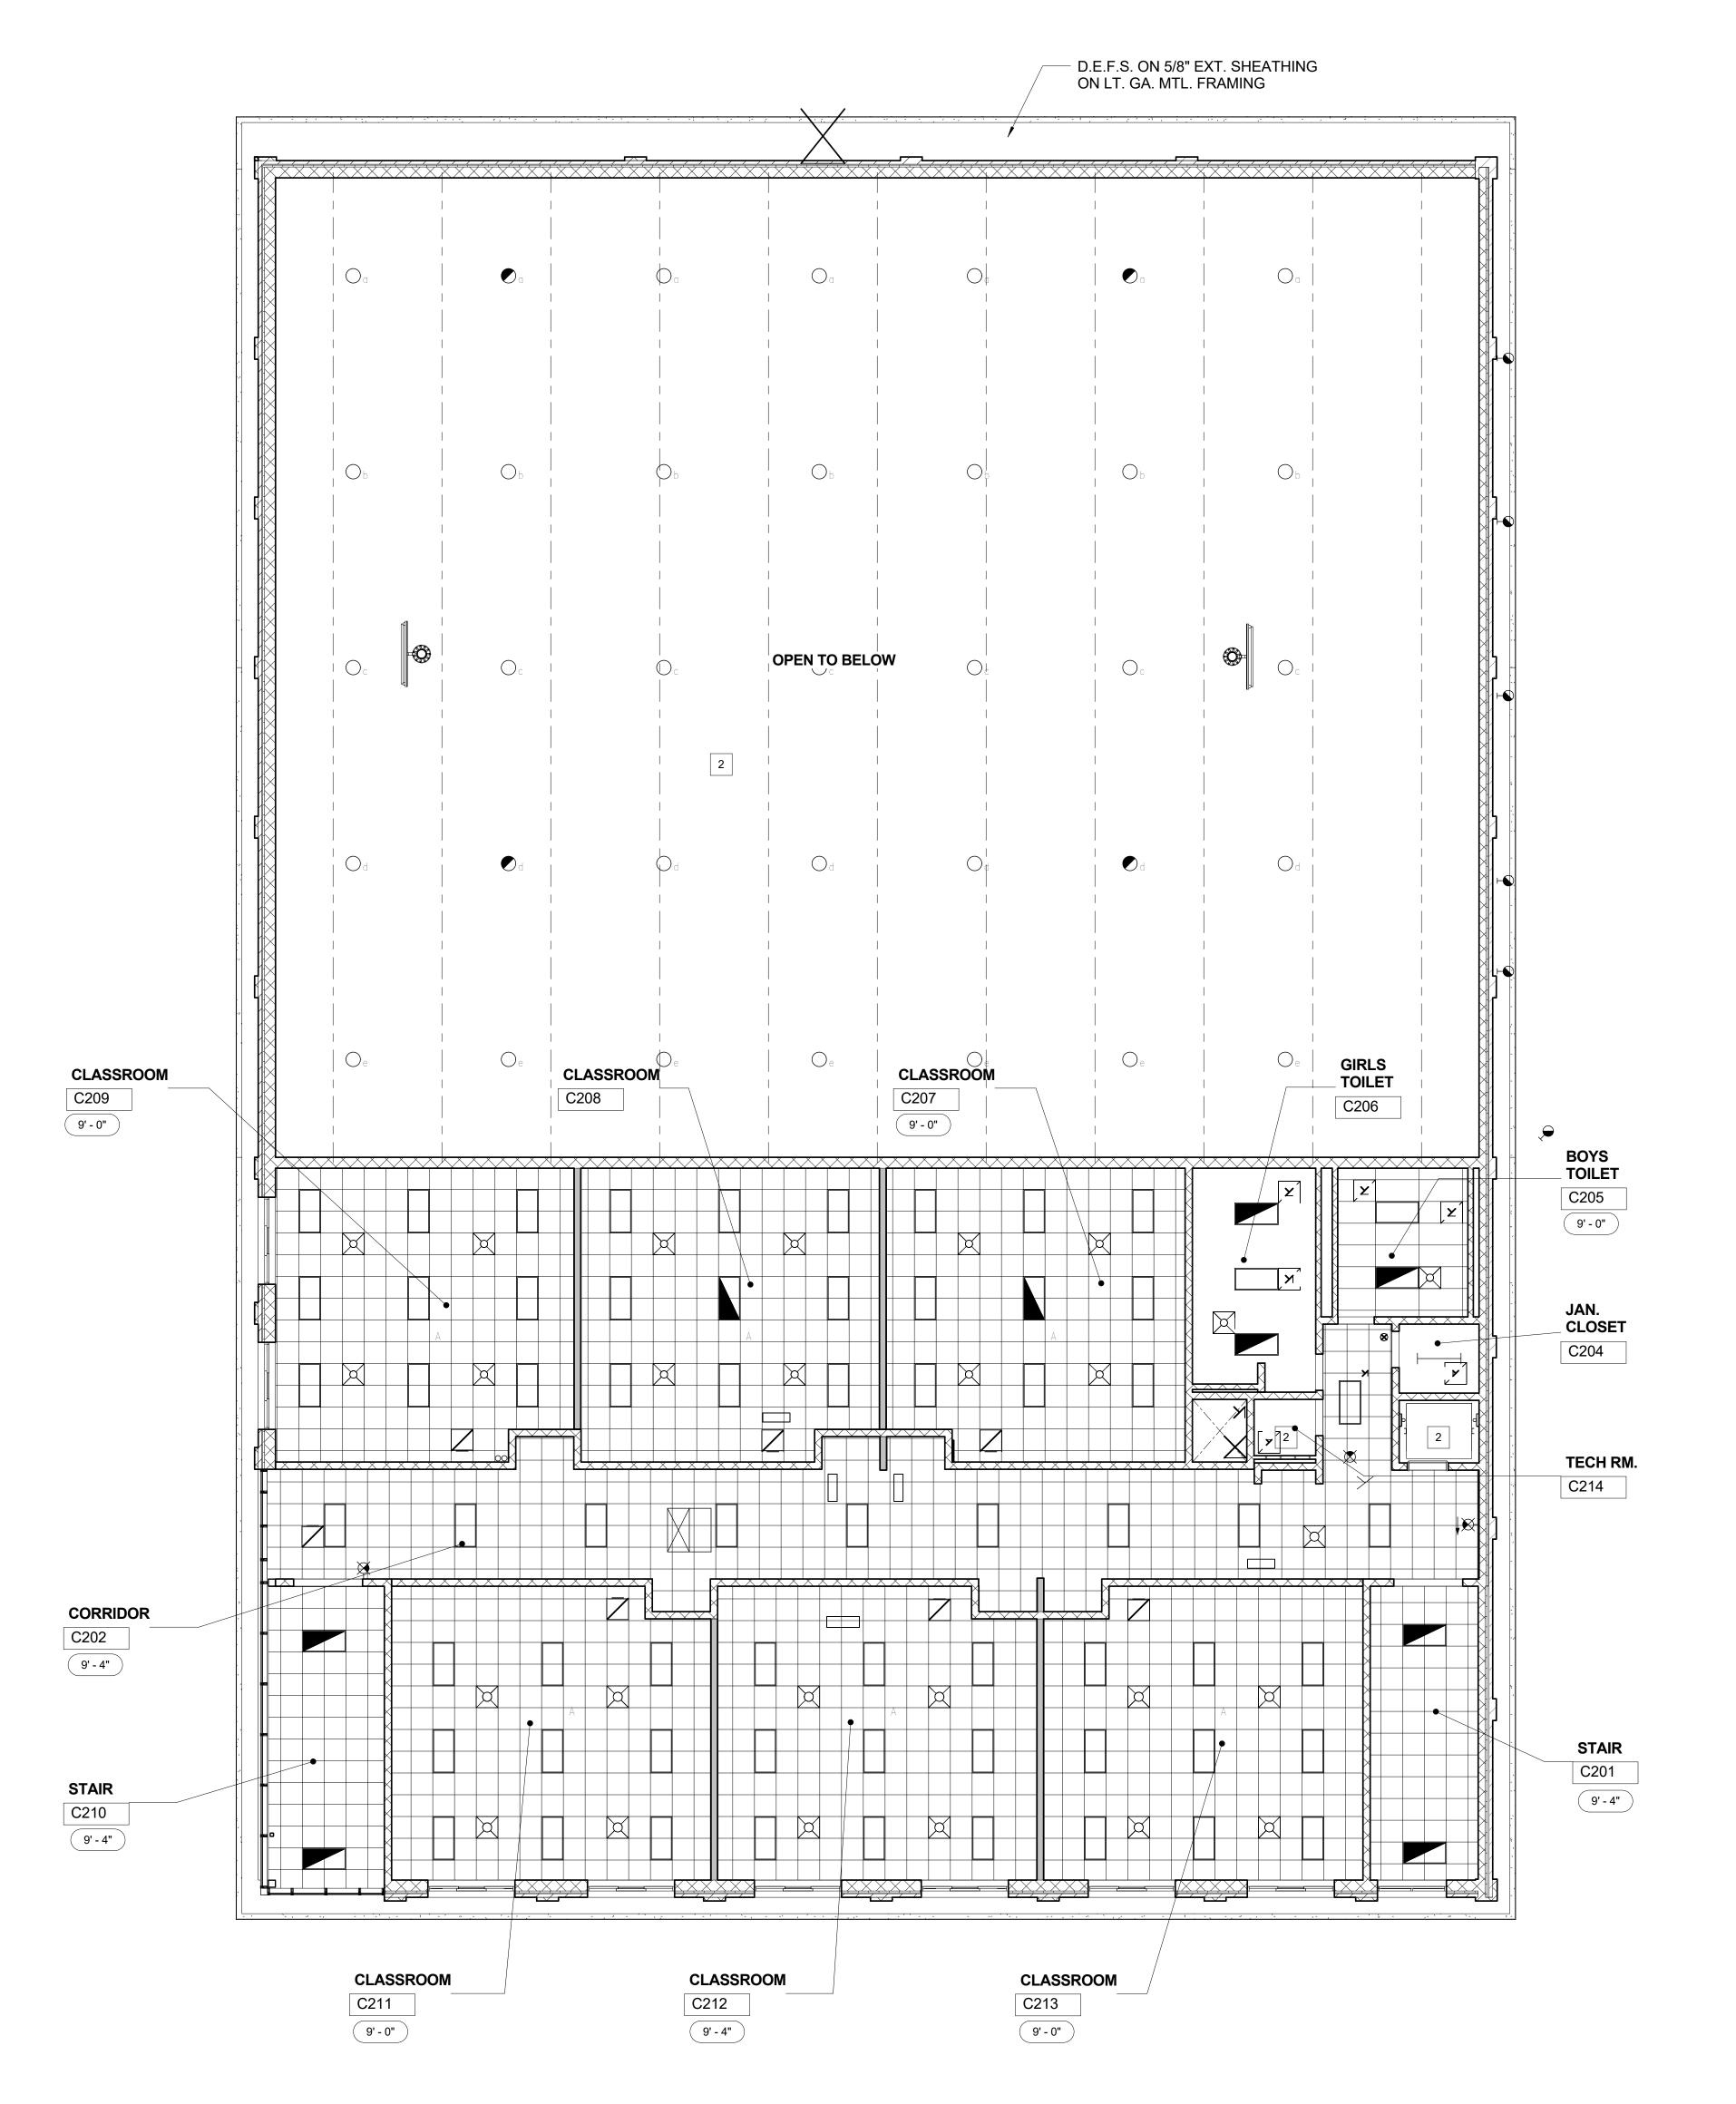

SECOND FLOOR REFLECTED

CEILING PLAN - AREA 'C'

A3.0 1/8" = 1'-0"

REFLECTED CEILING PLAN NOTES:

1 EXISTING CEILING TO REMAIN.

2 EXPOSED CONSTRUCTION TO BE PAINTED. SEE FINISH SCHEDULE FOR COLORS.

REMOVE/REPLACE EXISTING CEILING CONSTRUCTION AS REQUIRED TO INSTALL NEW SPRINKLER SYSTEM AND PIPING ABOVE EXISTING CEILING.

GENERAL NOTES:

1. REFER TO ELECTRICAL DRAWINGS FOR LIGHT FIXTURE TYPE, LAYOUT AND QUANTITY.

2. REFER TO MECHANICAL DRAWINGS FOR DIFFUSER AND GRILLE LOCATIONS AND SIZES.

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> IMIMIAINUEL LUI HERAIN CHURCH & VCHUCL CLASSROOM & GYMNASIUM ADDITION 47120 Romeo Plank Road, Macomb, MI 48044

SECOND FLOOR REFLECTED CEILING PLAN - AREA 'C'

PRELIMINARY
DESIGN DEVELOPMENT
CONSTRUCTION
FINAL RECORD

DRAWN BY:


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REVISIONS:

REVISIONS:
Construction Set
04/25/17

DATE: 03/10/17 SHEET NO.:

A2.3



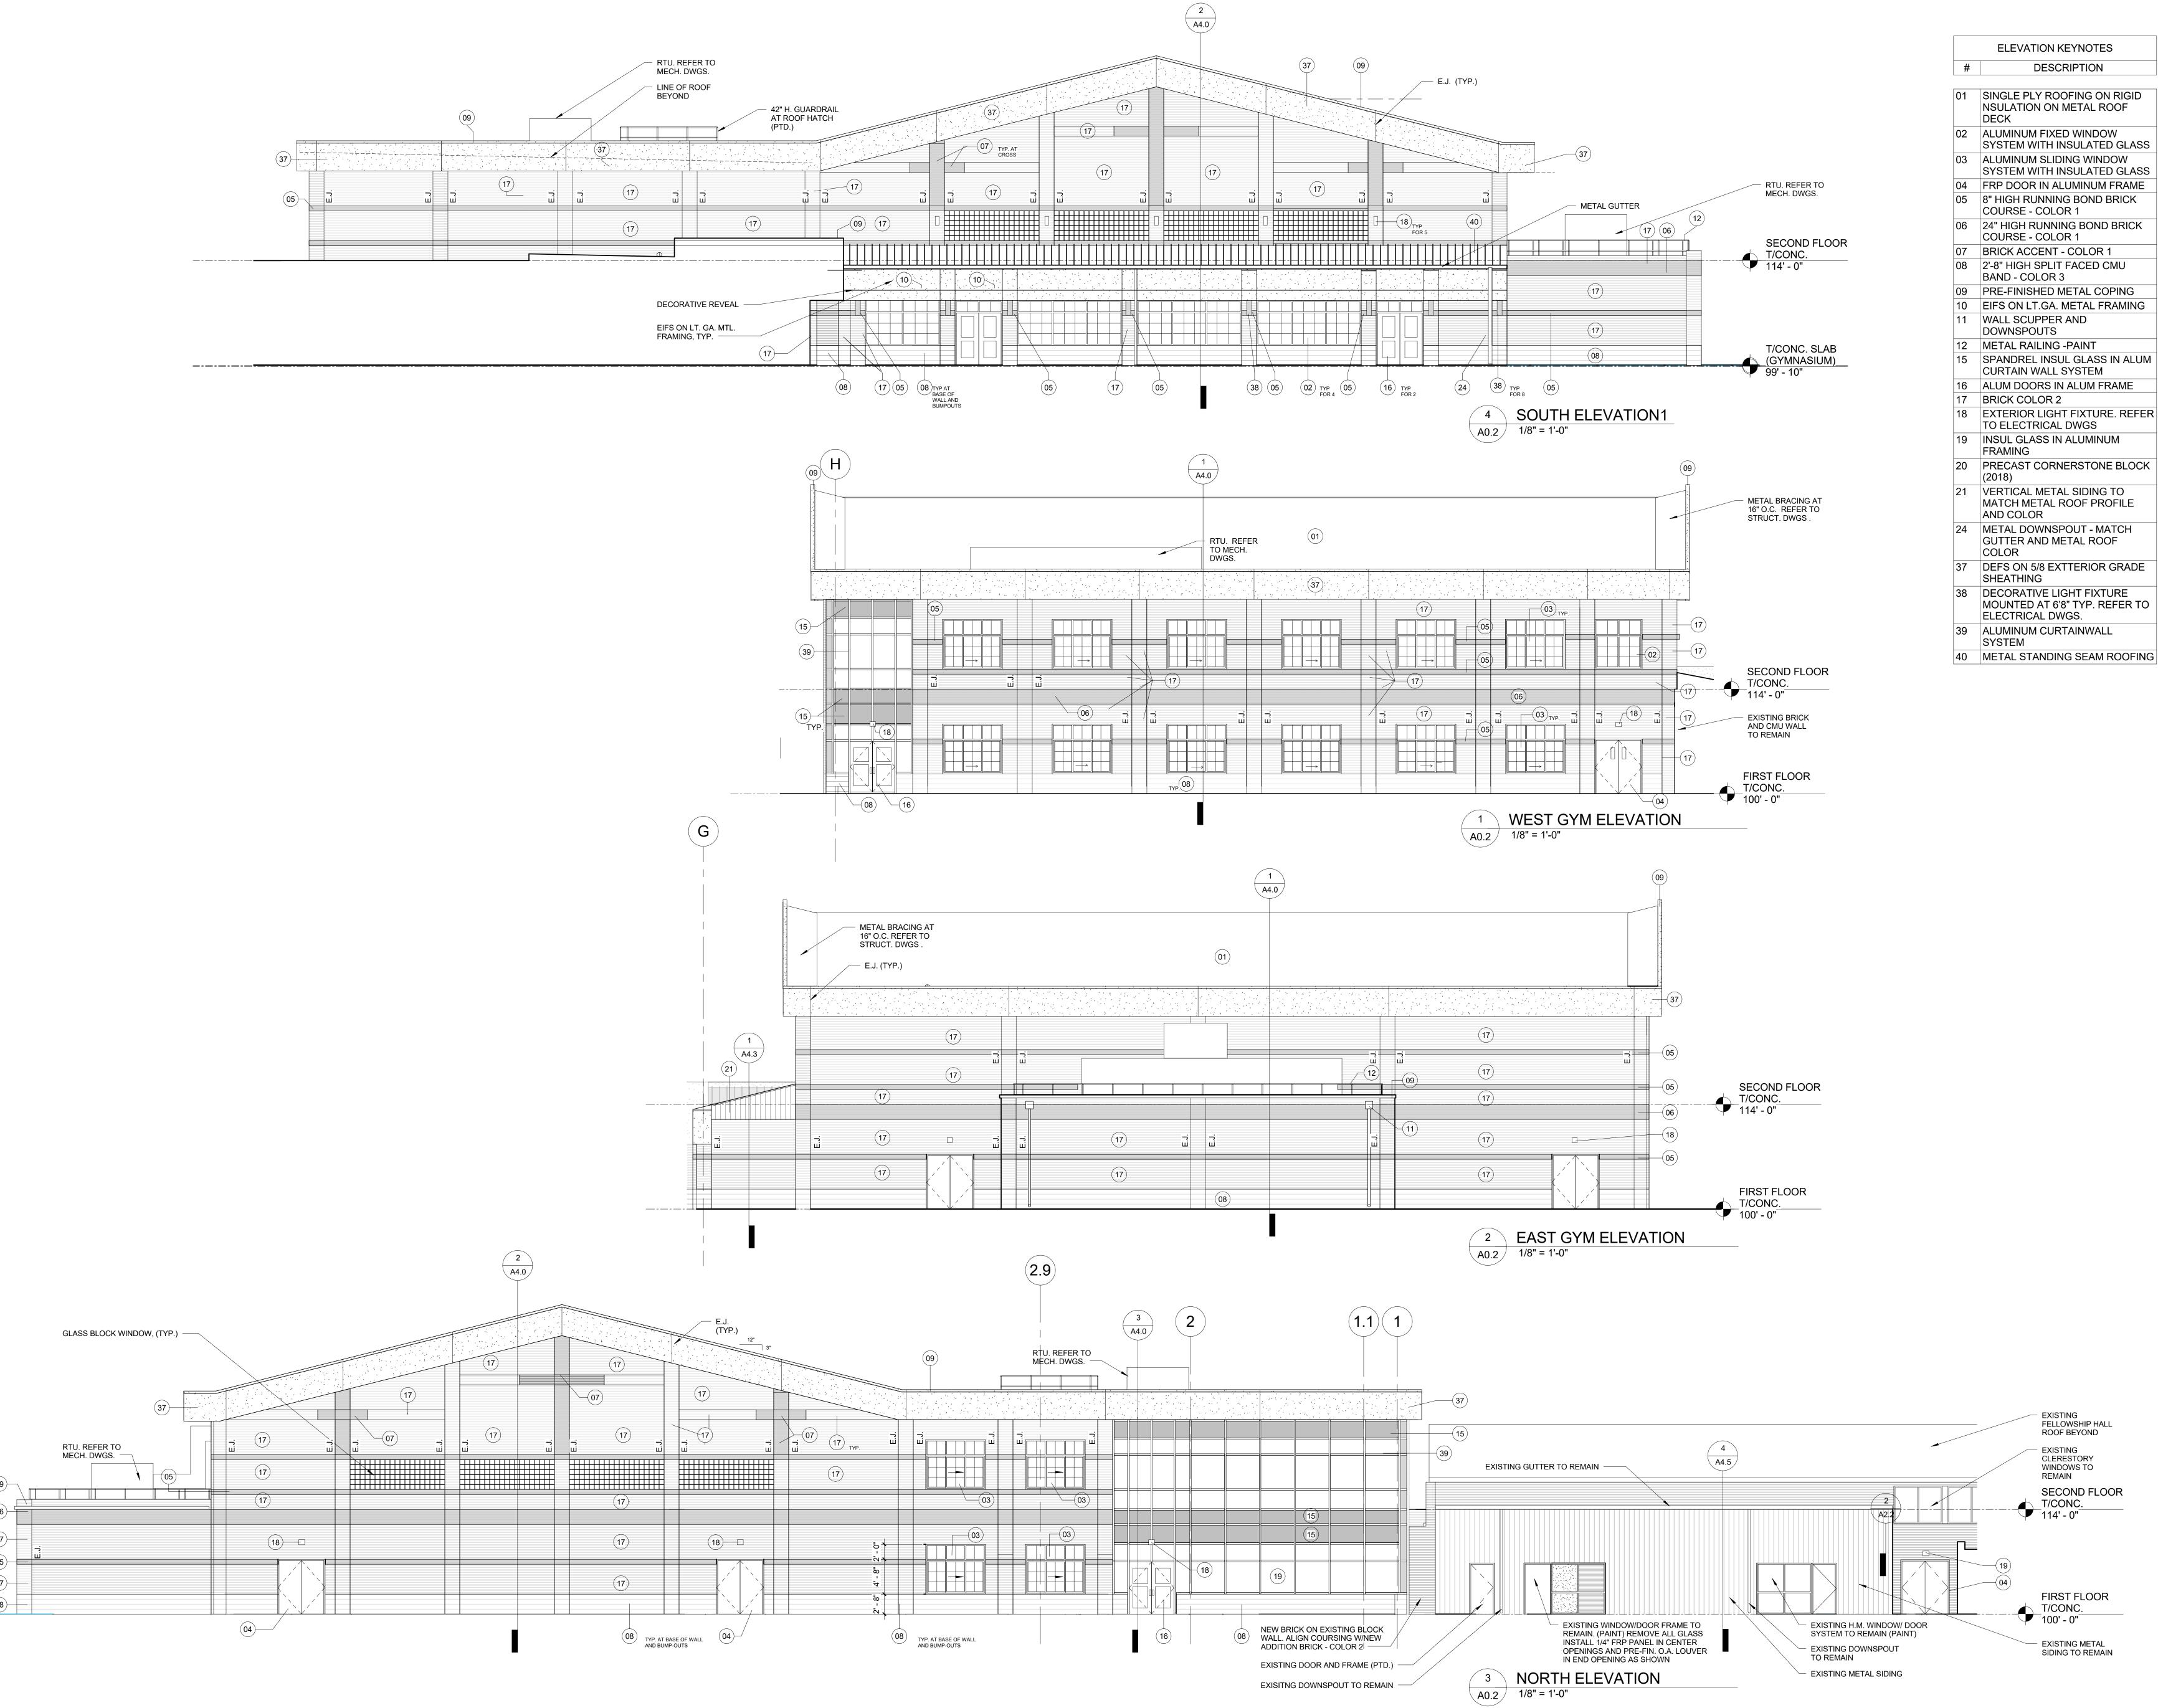

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BUILDING ELEVATIONS

PRELIMINARY **DESIGN DEVELOPMENT** CONSTRUCTION FINAL RECORD CHECKED BY: **REVISIONS:** Construction Set

DATE: 03/10/17 SHEET NO.:

30500 VAN DYKE AVENUE


WARREN, MICHIGAN 48093

SUITE M-7

PH: 586.573.4100

FX: 586.573.0822

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COURSE - COLOR 1

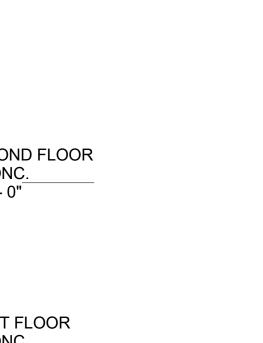06 24" HIGH RUNNING BOND BRICK COURSE - COLOR 1

07 BRICK ACCENT - COLOR 1

08 2'-8" HIGH SPLIT FACED CMU

ELEVATION KEYNOTES

01 SINGLE PLY ROOFING ON RIGID

02 ALUMINUM FIXED WINDOW

03 ALUMINUM SLIDING WINDOW

04 FRP DOOR IN ALUMINUM FRAME05 8" HIGH RUNNING BOND BRICK

DECK

NSULATION ON METAL ROOF

SYSTEM WITH INSULATED GLASS

SYSTEM WITH INSULATED GLASS

DESCRIPTION

BAND - COLOR 3

OPRE-FINISHED METAL COPING

EIFS ON LT.GA. METAL FRAMING

WALL SCUPPER AND
DOWNSPOUTS

 METAL RAILING -PAINT
 SPANDREL INSUL GLASS IN ALUM CURTAIN WALL SYSTEM

BRICK COLOR 2
 EXTERIOR LIGHT FIXTURE. REFER
 TO ELECTRICAL DWGS

16 ALUM DOORS IN ALUM FRAME

19 INSUL GLASS IN ALUMINUM FRAMING20 PRECAST CORNERSTONE BLOCK

(2018)

21 VERTICAL METAL SIDING TO
MATCH METAL ROOF PROFILE
AND COLOR

24 METAL DOWNSPOUT - MATCH GUTTER AND METAL ROOF COLOR

37 DEFS ON 5/8 EXTTERIOR GRADE SHEATHING
 38 DECORATIVE LIGHT FIXTURE MOUNTED AT 6'8" TYP. REFER TO


40 METAL STANDING SEAM ROOFING

ELECTRICAL DWGS.

39 ALUMINUM CURTAINWALL
SYSTEM

5 6 7 18-0" 9 8-4" 9 8-9" SECOND FLOOR TICONC. 114'-0" 114'-0" 1100'-0" SOUTH ENTRANCE ELEVATION - ALT NO. 1

A0.3 1/8" = 1'-0"

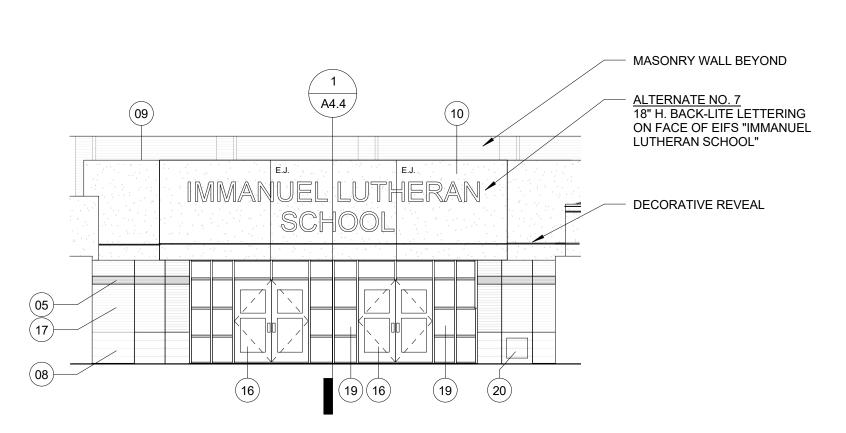

3 A4.4 17' - 4"

08) TYP. AT BASE OF WALL

EAST ENTRANCE ELEVATION

A0.2 1/8" = 1'-0"


5' - 4 1/2"


19' - 7 1/2"


08) TYP. AT BUMP-OUTS


18' - 0"



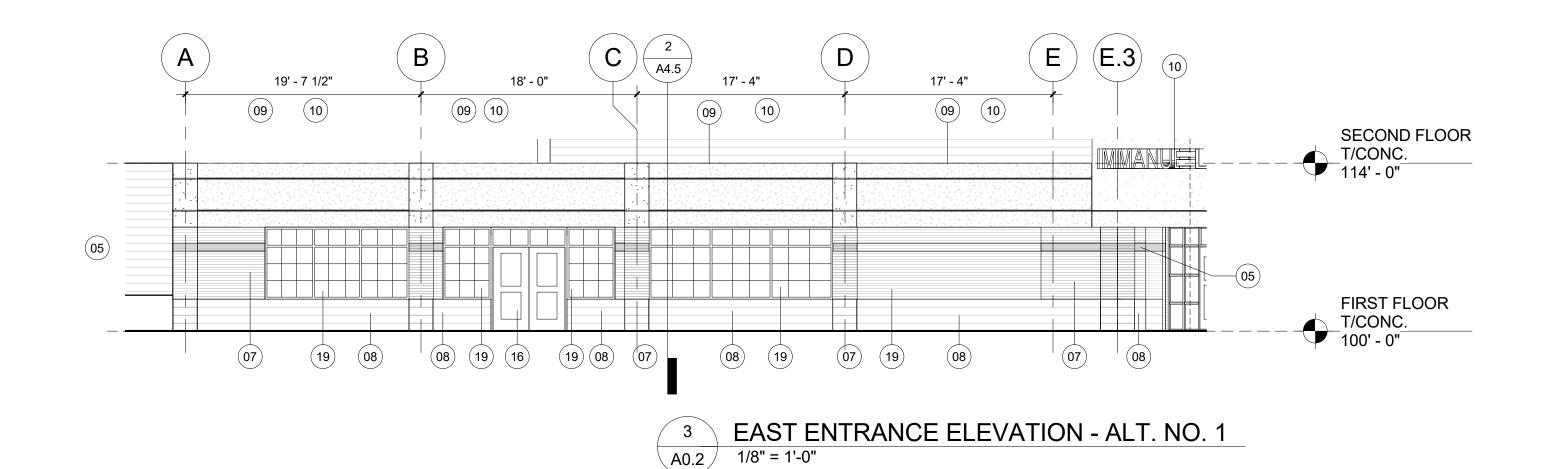

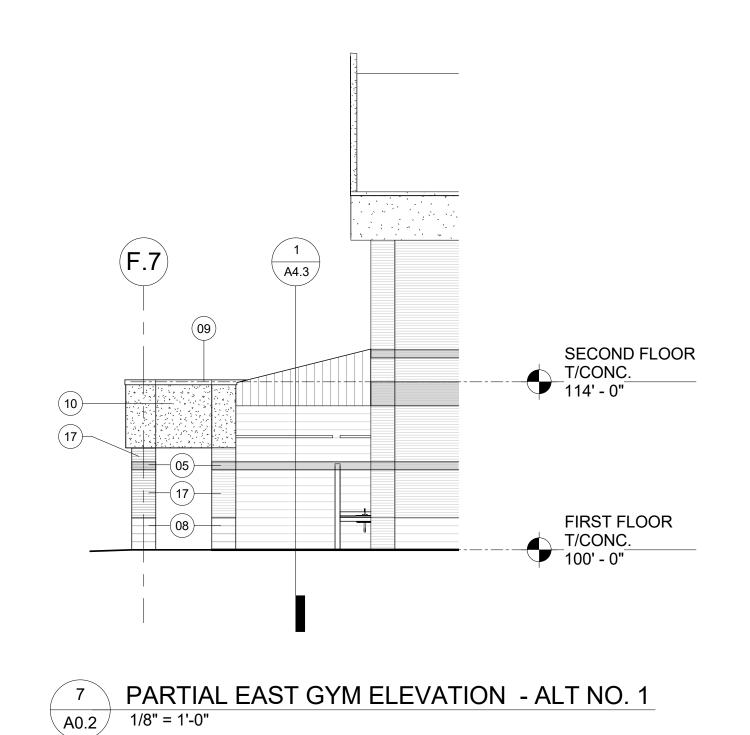

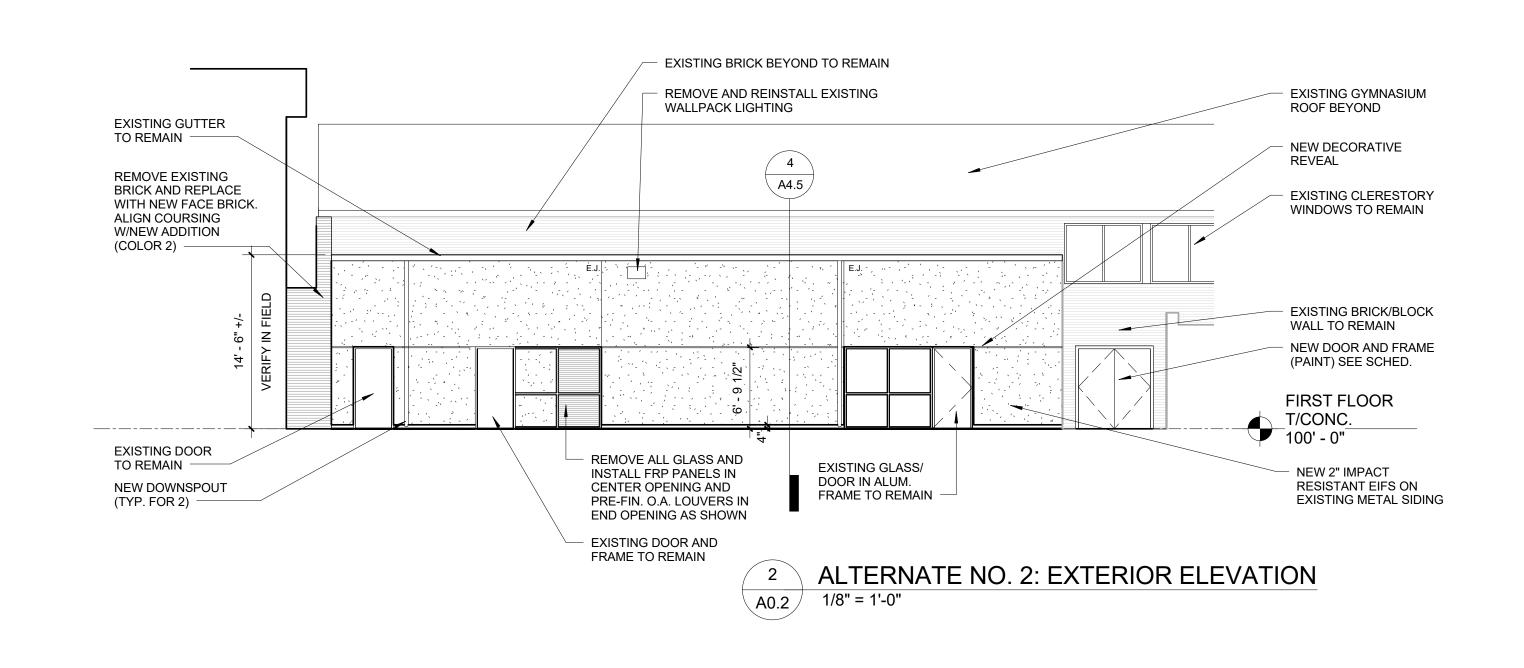

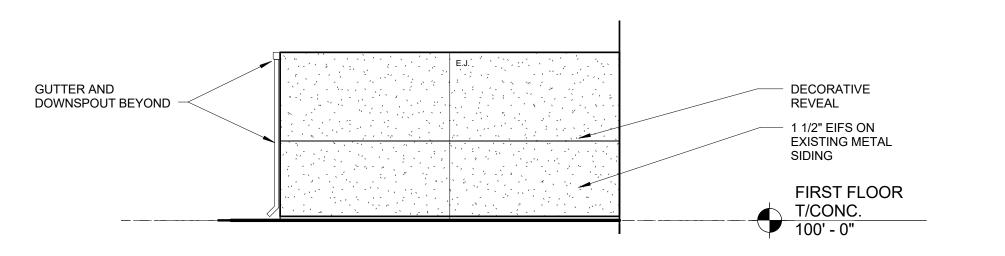

1 ALTERNATE NO. 2: EXTERIOR ELEVATION
A0.3 1/8" = 1'-0"



PRELIMINARY

DESIGN DEVELOPMENT

CONSTRUCTION

FINAL RECORD

DRAWN BY:

CHECKED BY:

BJS

REVISIONS:

Construction Set
04/25/17

BUILDING ELEVATIONS

A3.1





WAKELY ASSOCIATES, INC.

30500 VAN DYKE AVENUE

WARREN, MICHIGAN 48093

ARCHITECTS

SUITE M-7

PH: 586.573.4100

FX: 586.573.0822

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BUILDING SECTIONS

PRELIMINARY DESIGN DEVELOPMENT CONSTRUCTION FINAL RECORD

CHECKED BY: **REVISIONS:** Construction Set

DATE:

SHEET NO.:

A4.0

141594

03/10/17



WAKELY ASSOCIATES, INC. ARCHITECTS 30500 VAN DYKE AVENUE SUITE M-7 WARREN, MICHIGAN 48093

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WALL SECTIONS


PRELIMINARY DESIGN DEVELOPMENT CONSTRUCTION FINAL RECORD CHECKED BY:

REVISIONS: Construction Set 04/25/17

DATE: 03/10/17 SHEET NO.:

A4.1

PRE-FINISHED METAL COPING

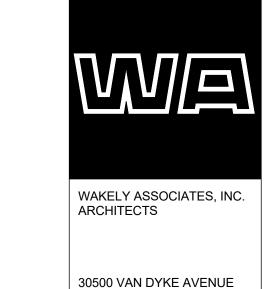

SUITE M-7

PH: 586.573.4100

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WARREN, MICHIGAN 48093

EL LUTHERAN CHURCH & SCHOOL
M & GYMNASIUM ADDITION

N & GYMNASIUM ADDITION

N & GYMNASIUM ADDITION

WALL SECTIONS

PRELIMINARY
DESIGN DEVELOPMENT
CONSTRUCTION
FINAL RECORD

DRAWN BY:
CHECKED BY:
BJS


REVISIONS:

DRAWN BY:
CHECKED BY:

REVISIONS:
Construction Set
04/25/17

DATE: 03/10/17
SHEET NO.:

A4.2

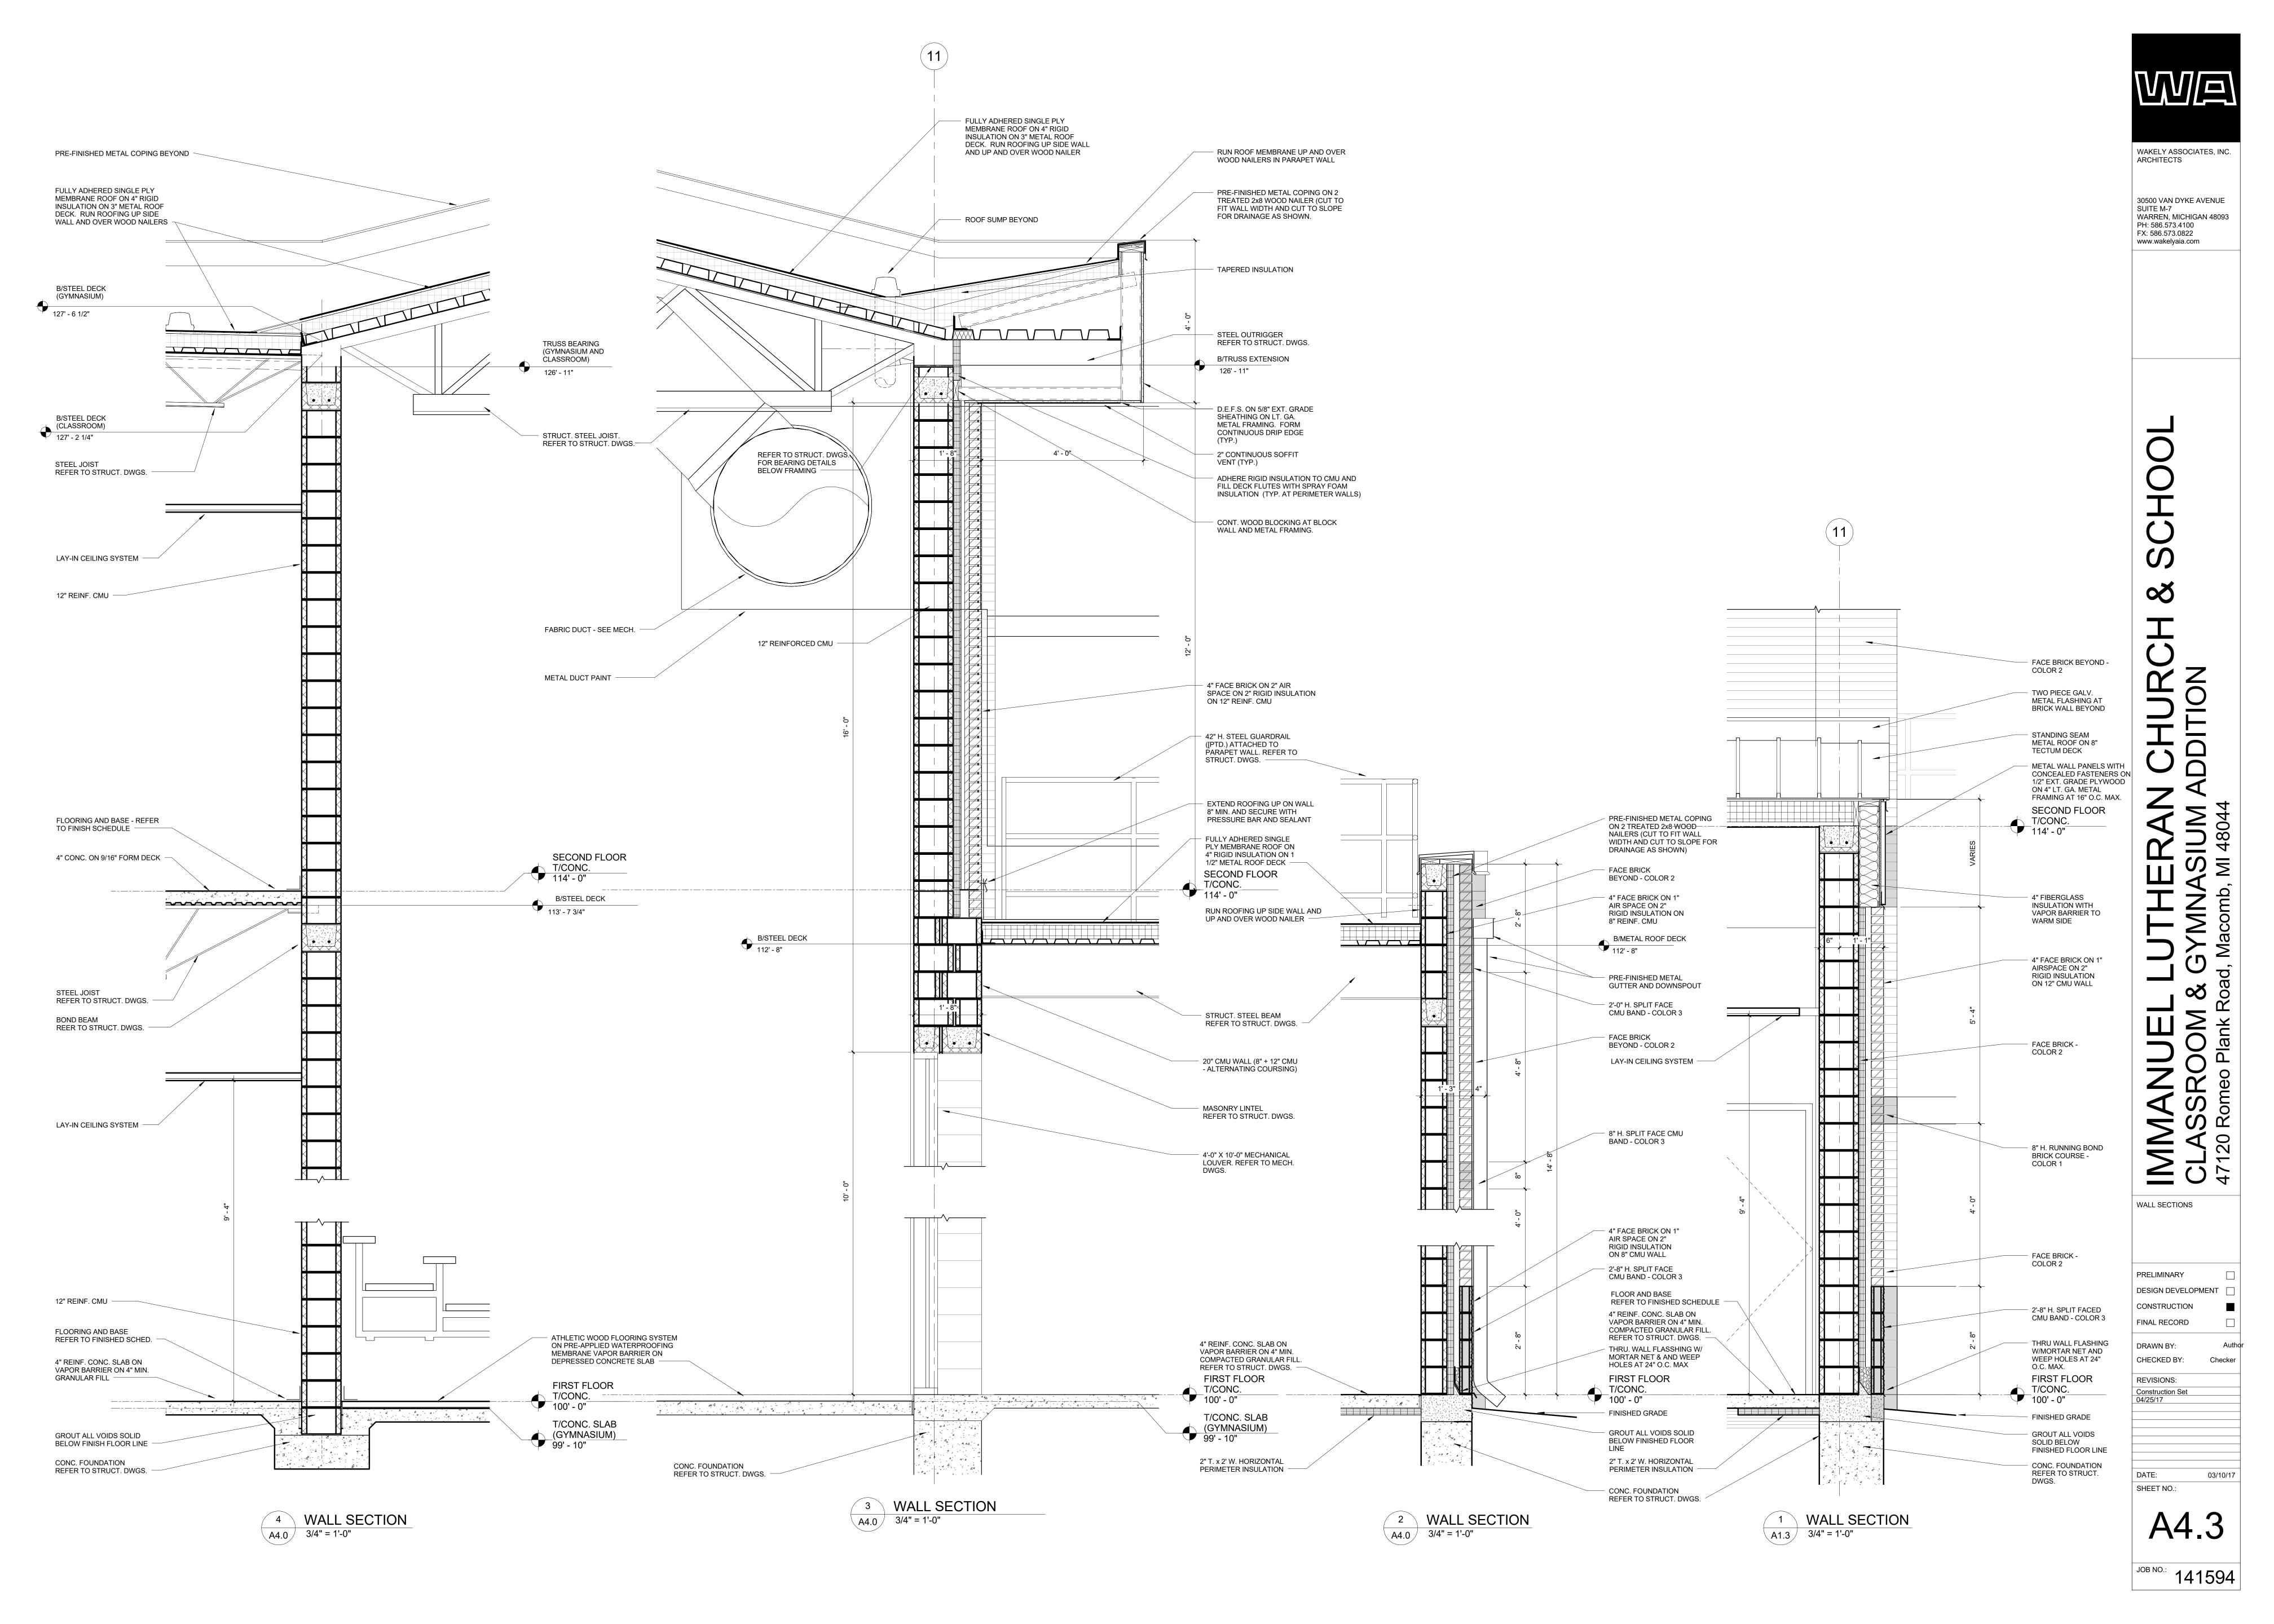


PRELIMINARY DESIGN DEVELOPMENT CONSTRUCTION

FINAL RECORD DRAWN BY: CHECKED BY:

REVISIONS: Construction Set 04/25/17

DATE: 03/10/17 SHEET NO.:

A4.4

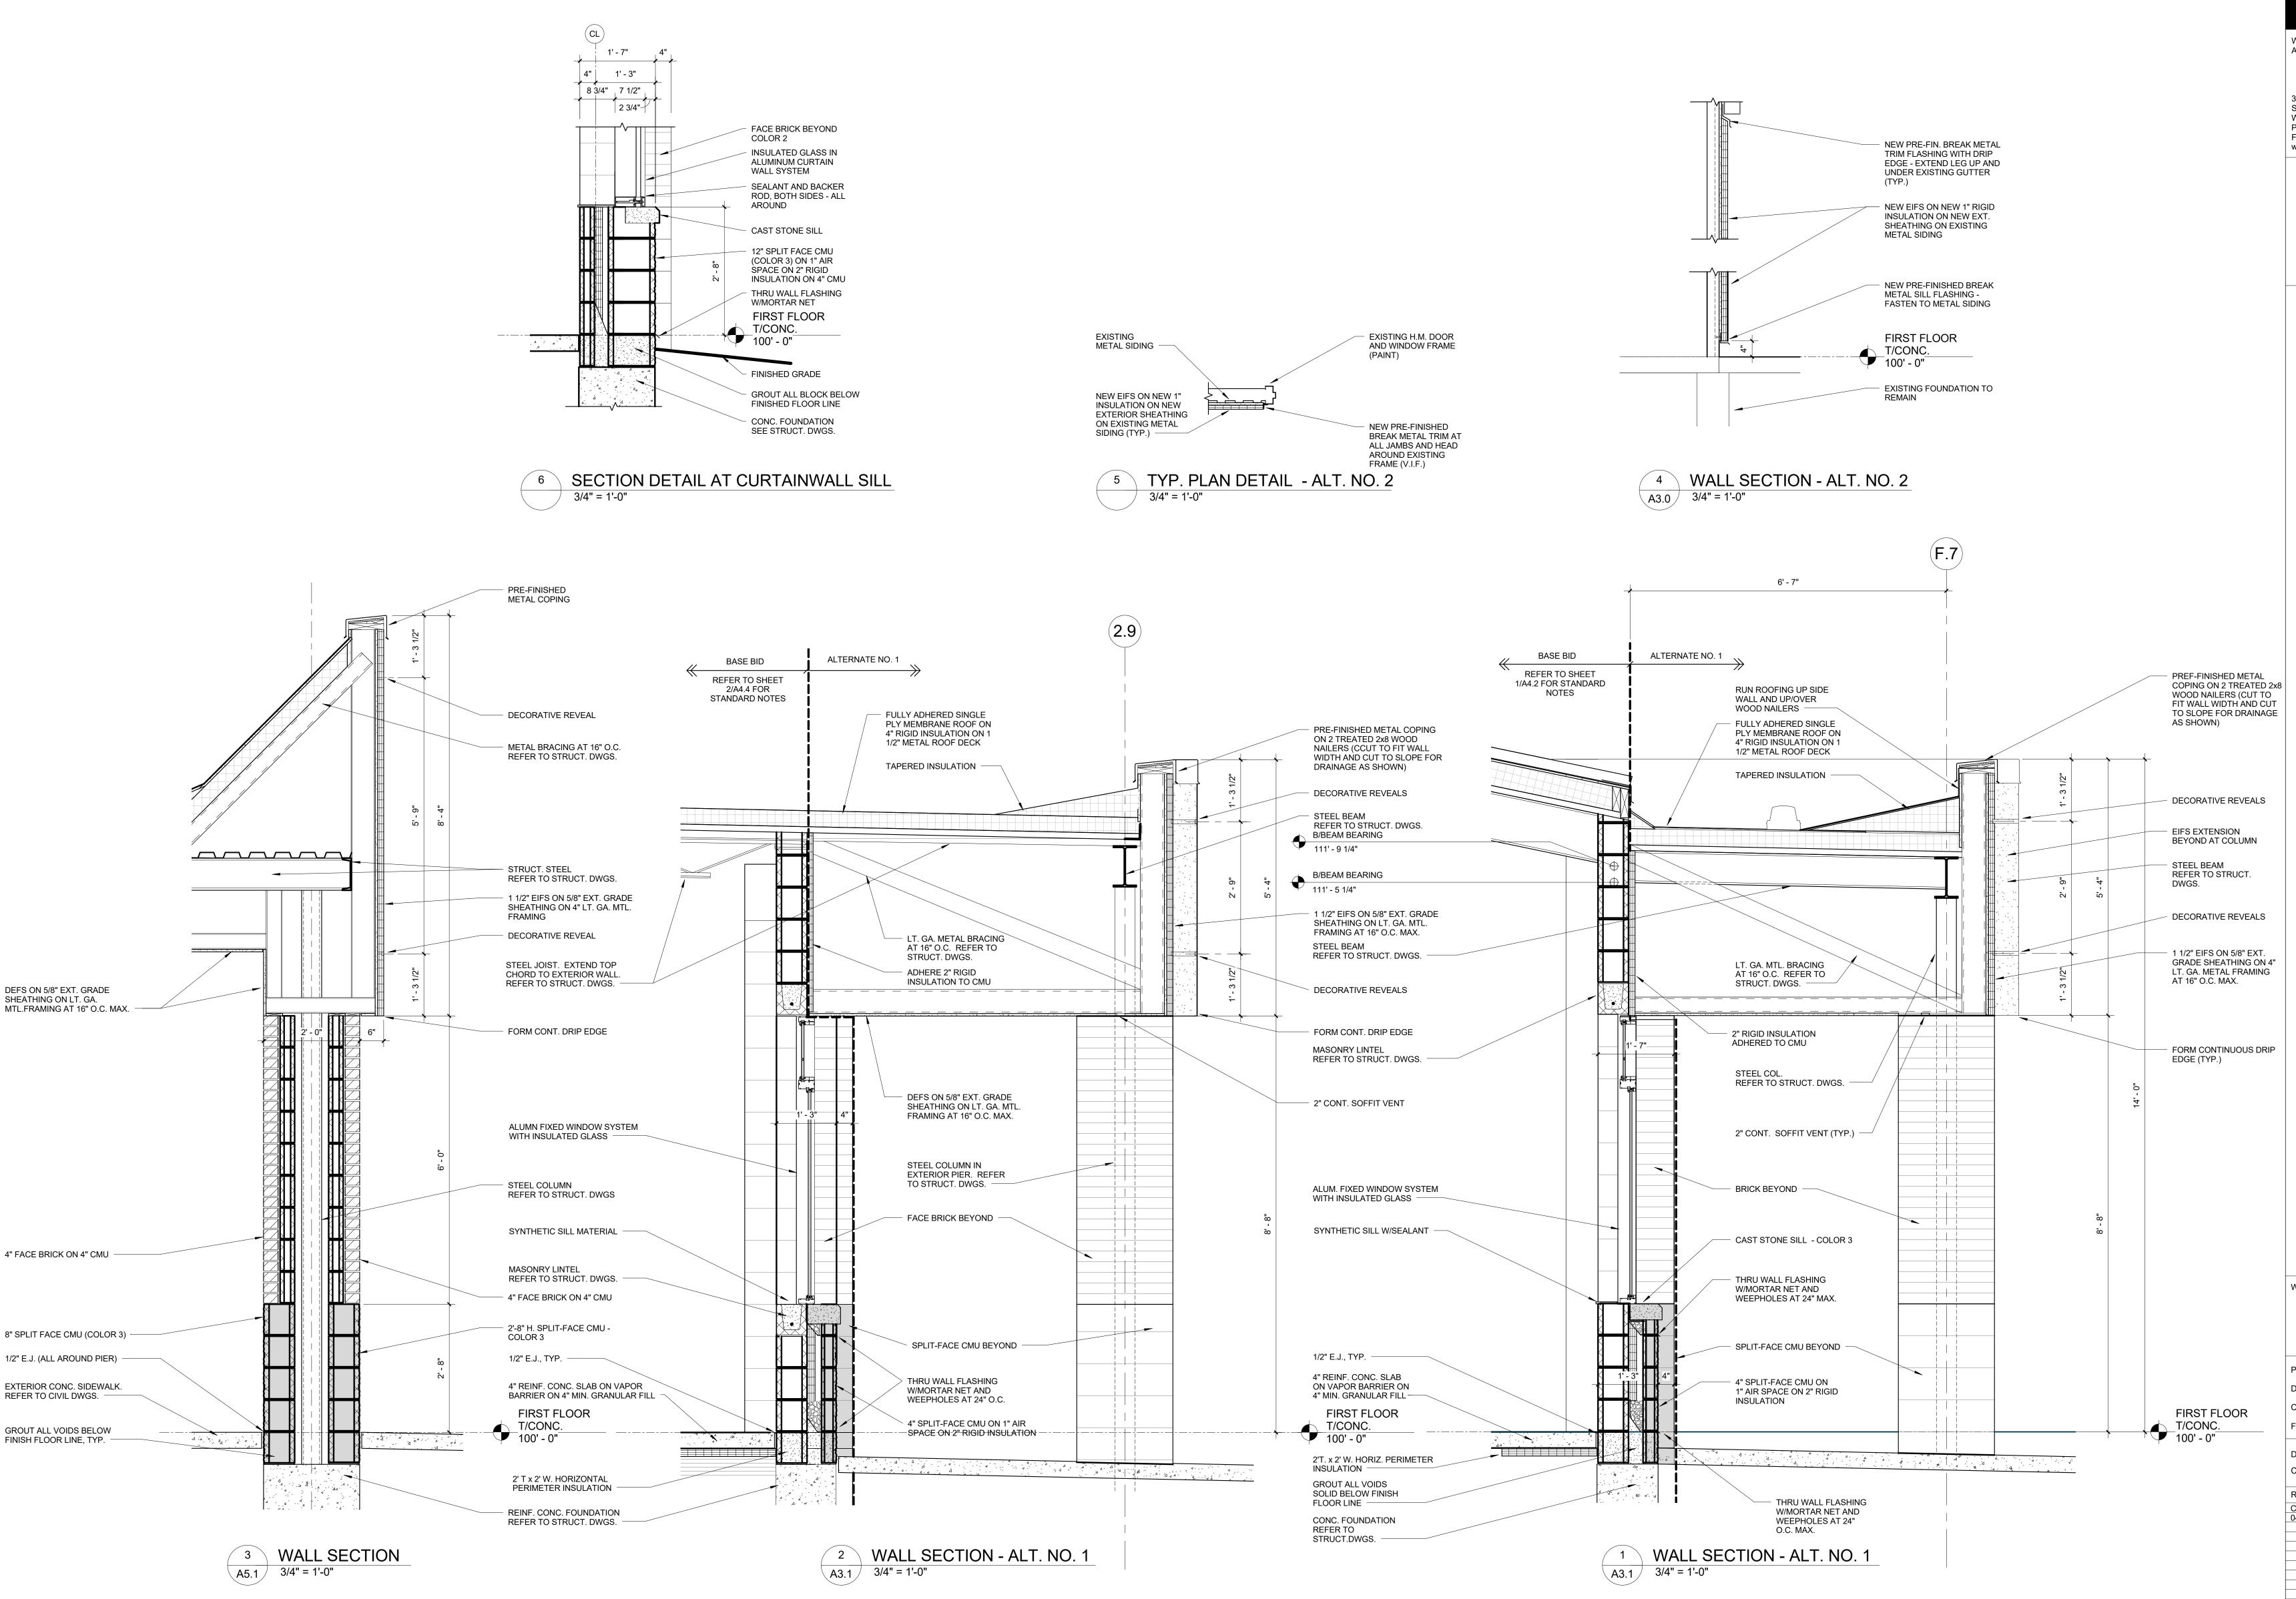

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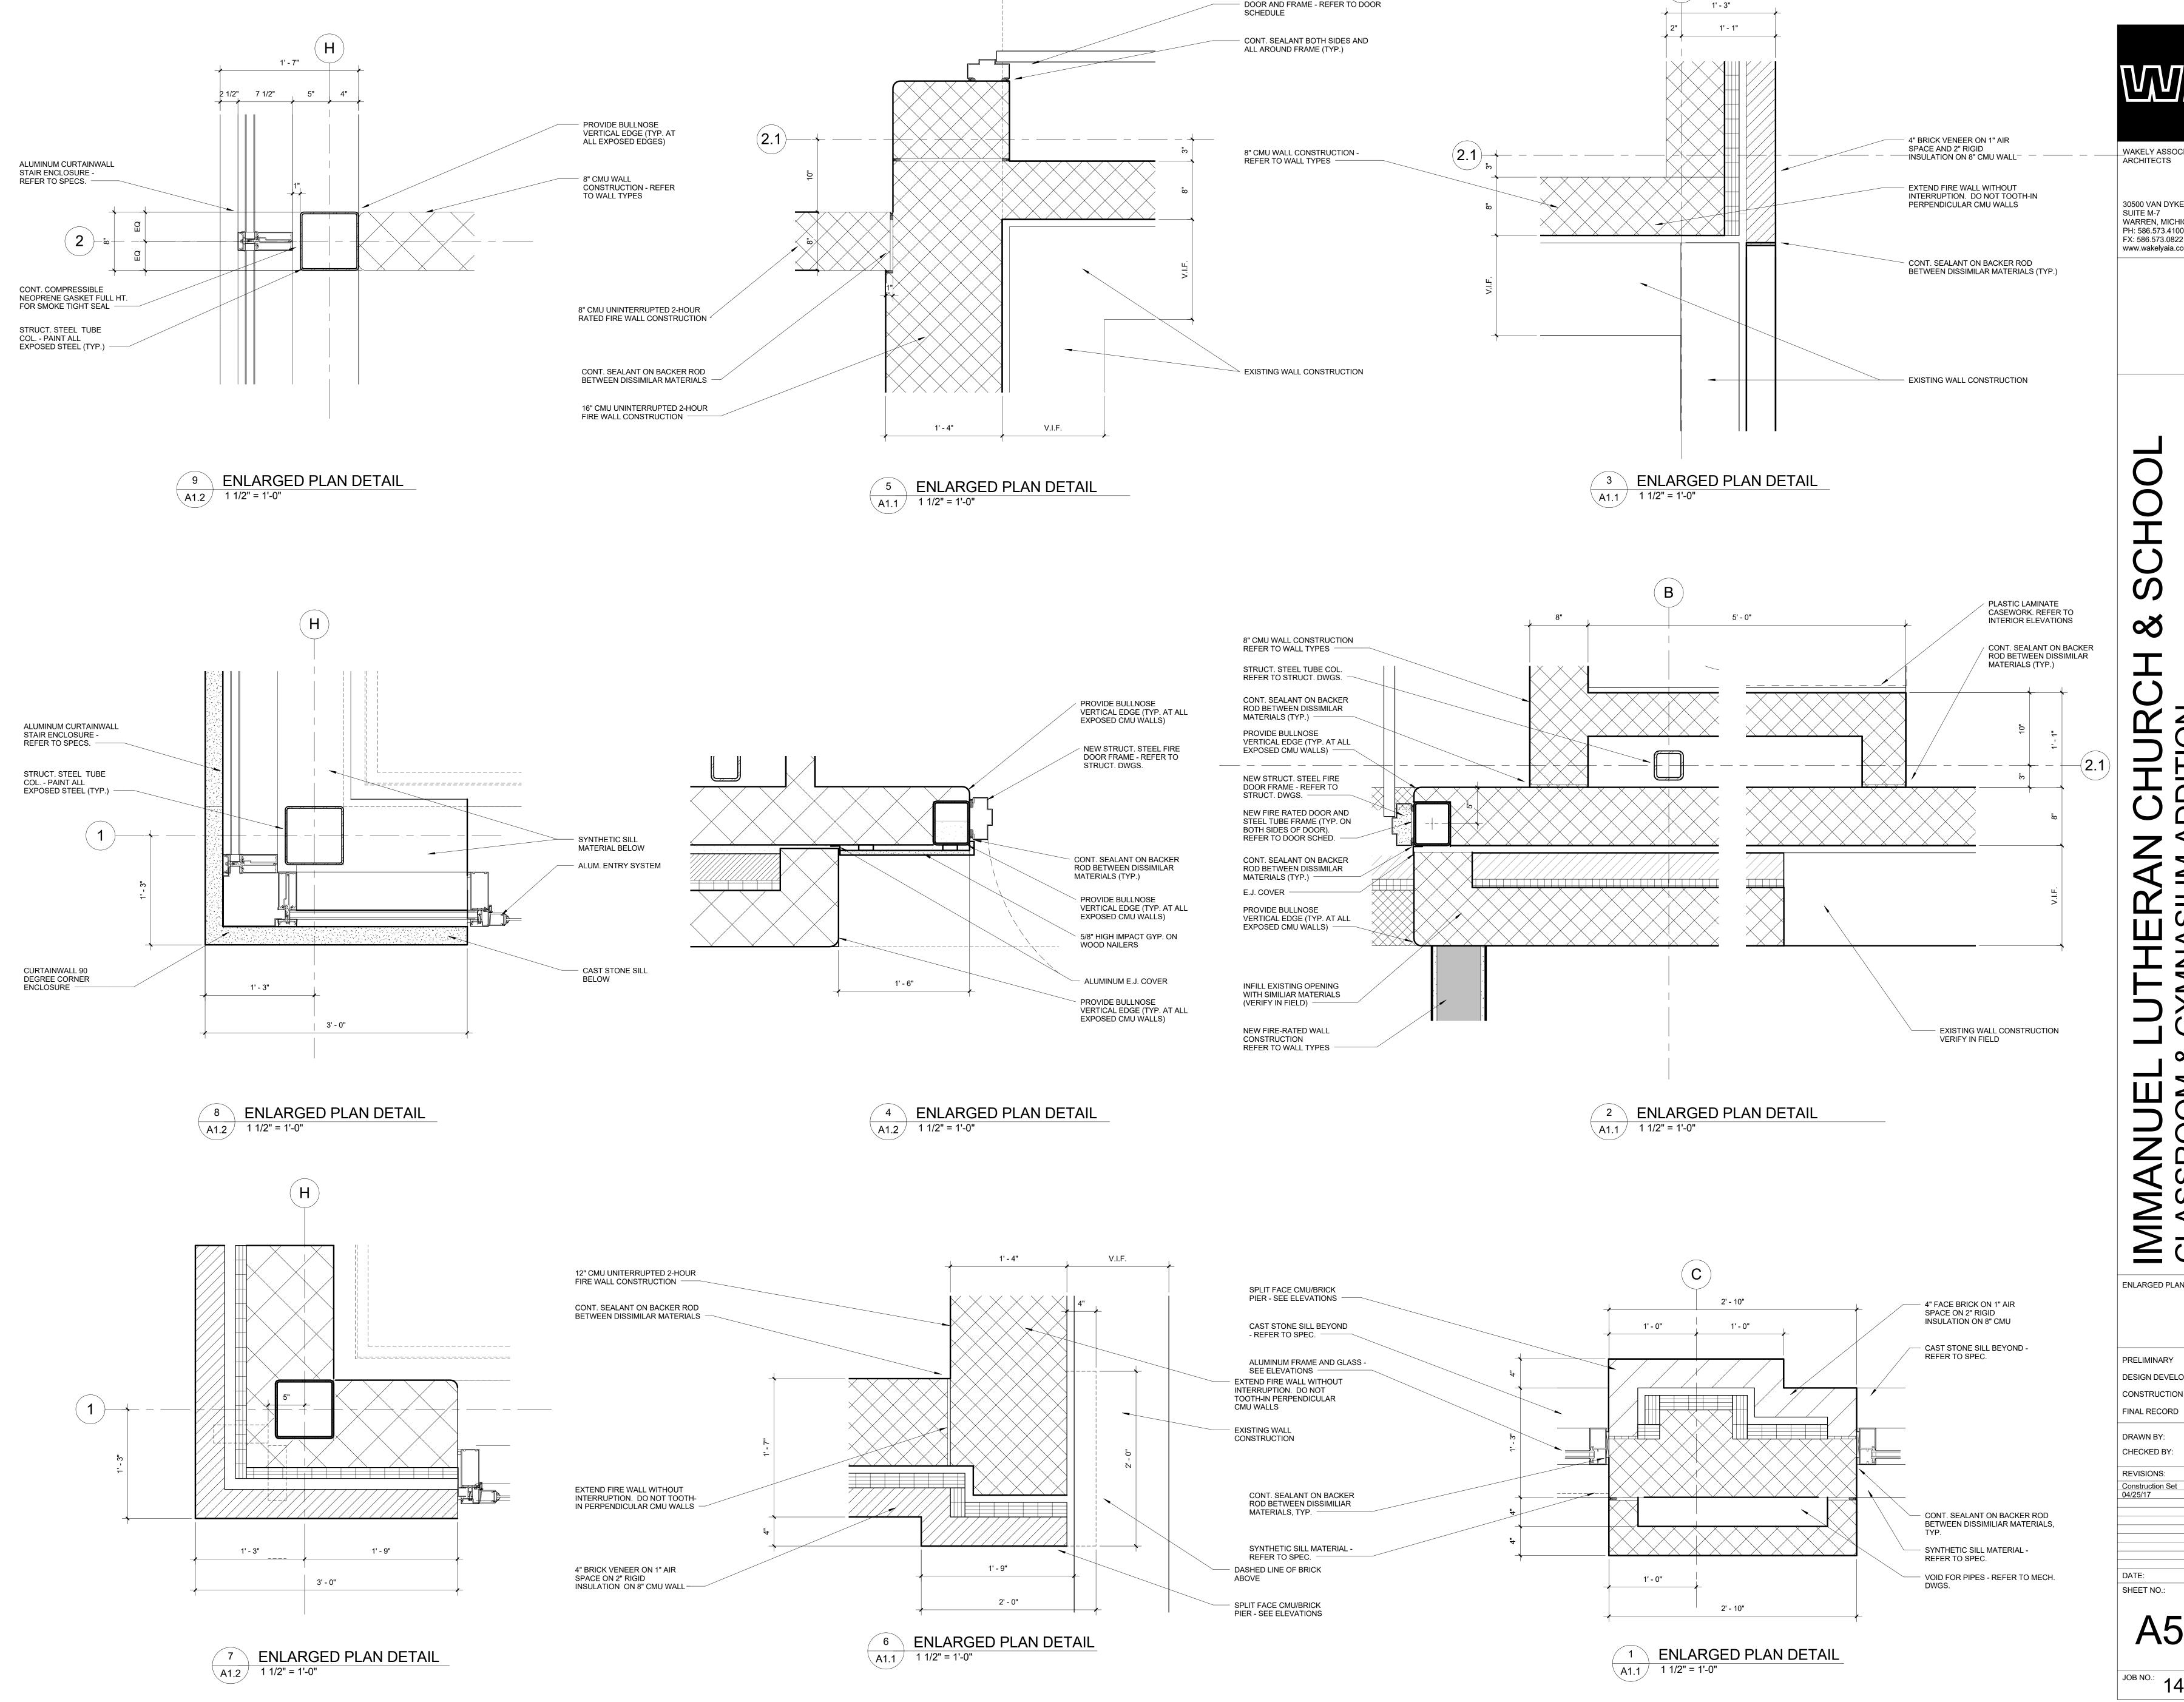
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WALL SECTIONS

PRELIMINARY DESIGN DEVELOPMENT CONSTRUCTION FINAL RECORD CHECKED BY:

REVISIONS: Construction Set 04/25/17

03/10/17 SHEET NO.: A4.5



DOOR AND FRAME - REFER TO DOOR

_WAKELY ASSOCIATES, INC. ARCHITECTS


PH: 586.573.4100 FX: 586.573.0822


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ENLARGED PLAN DETAILS PRELIMINARY DESIGN DEVELOPMENT CONSTRUCTION FINAL RECORD CHECKED BY:


03/10/17

A5.0



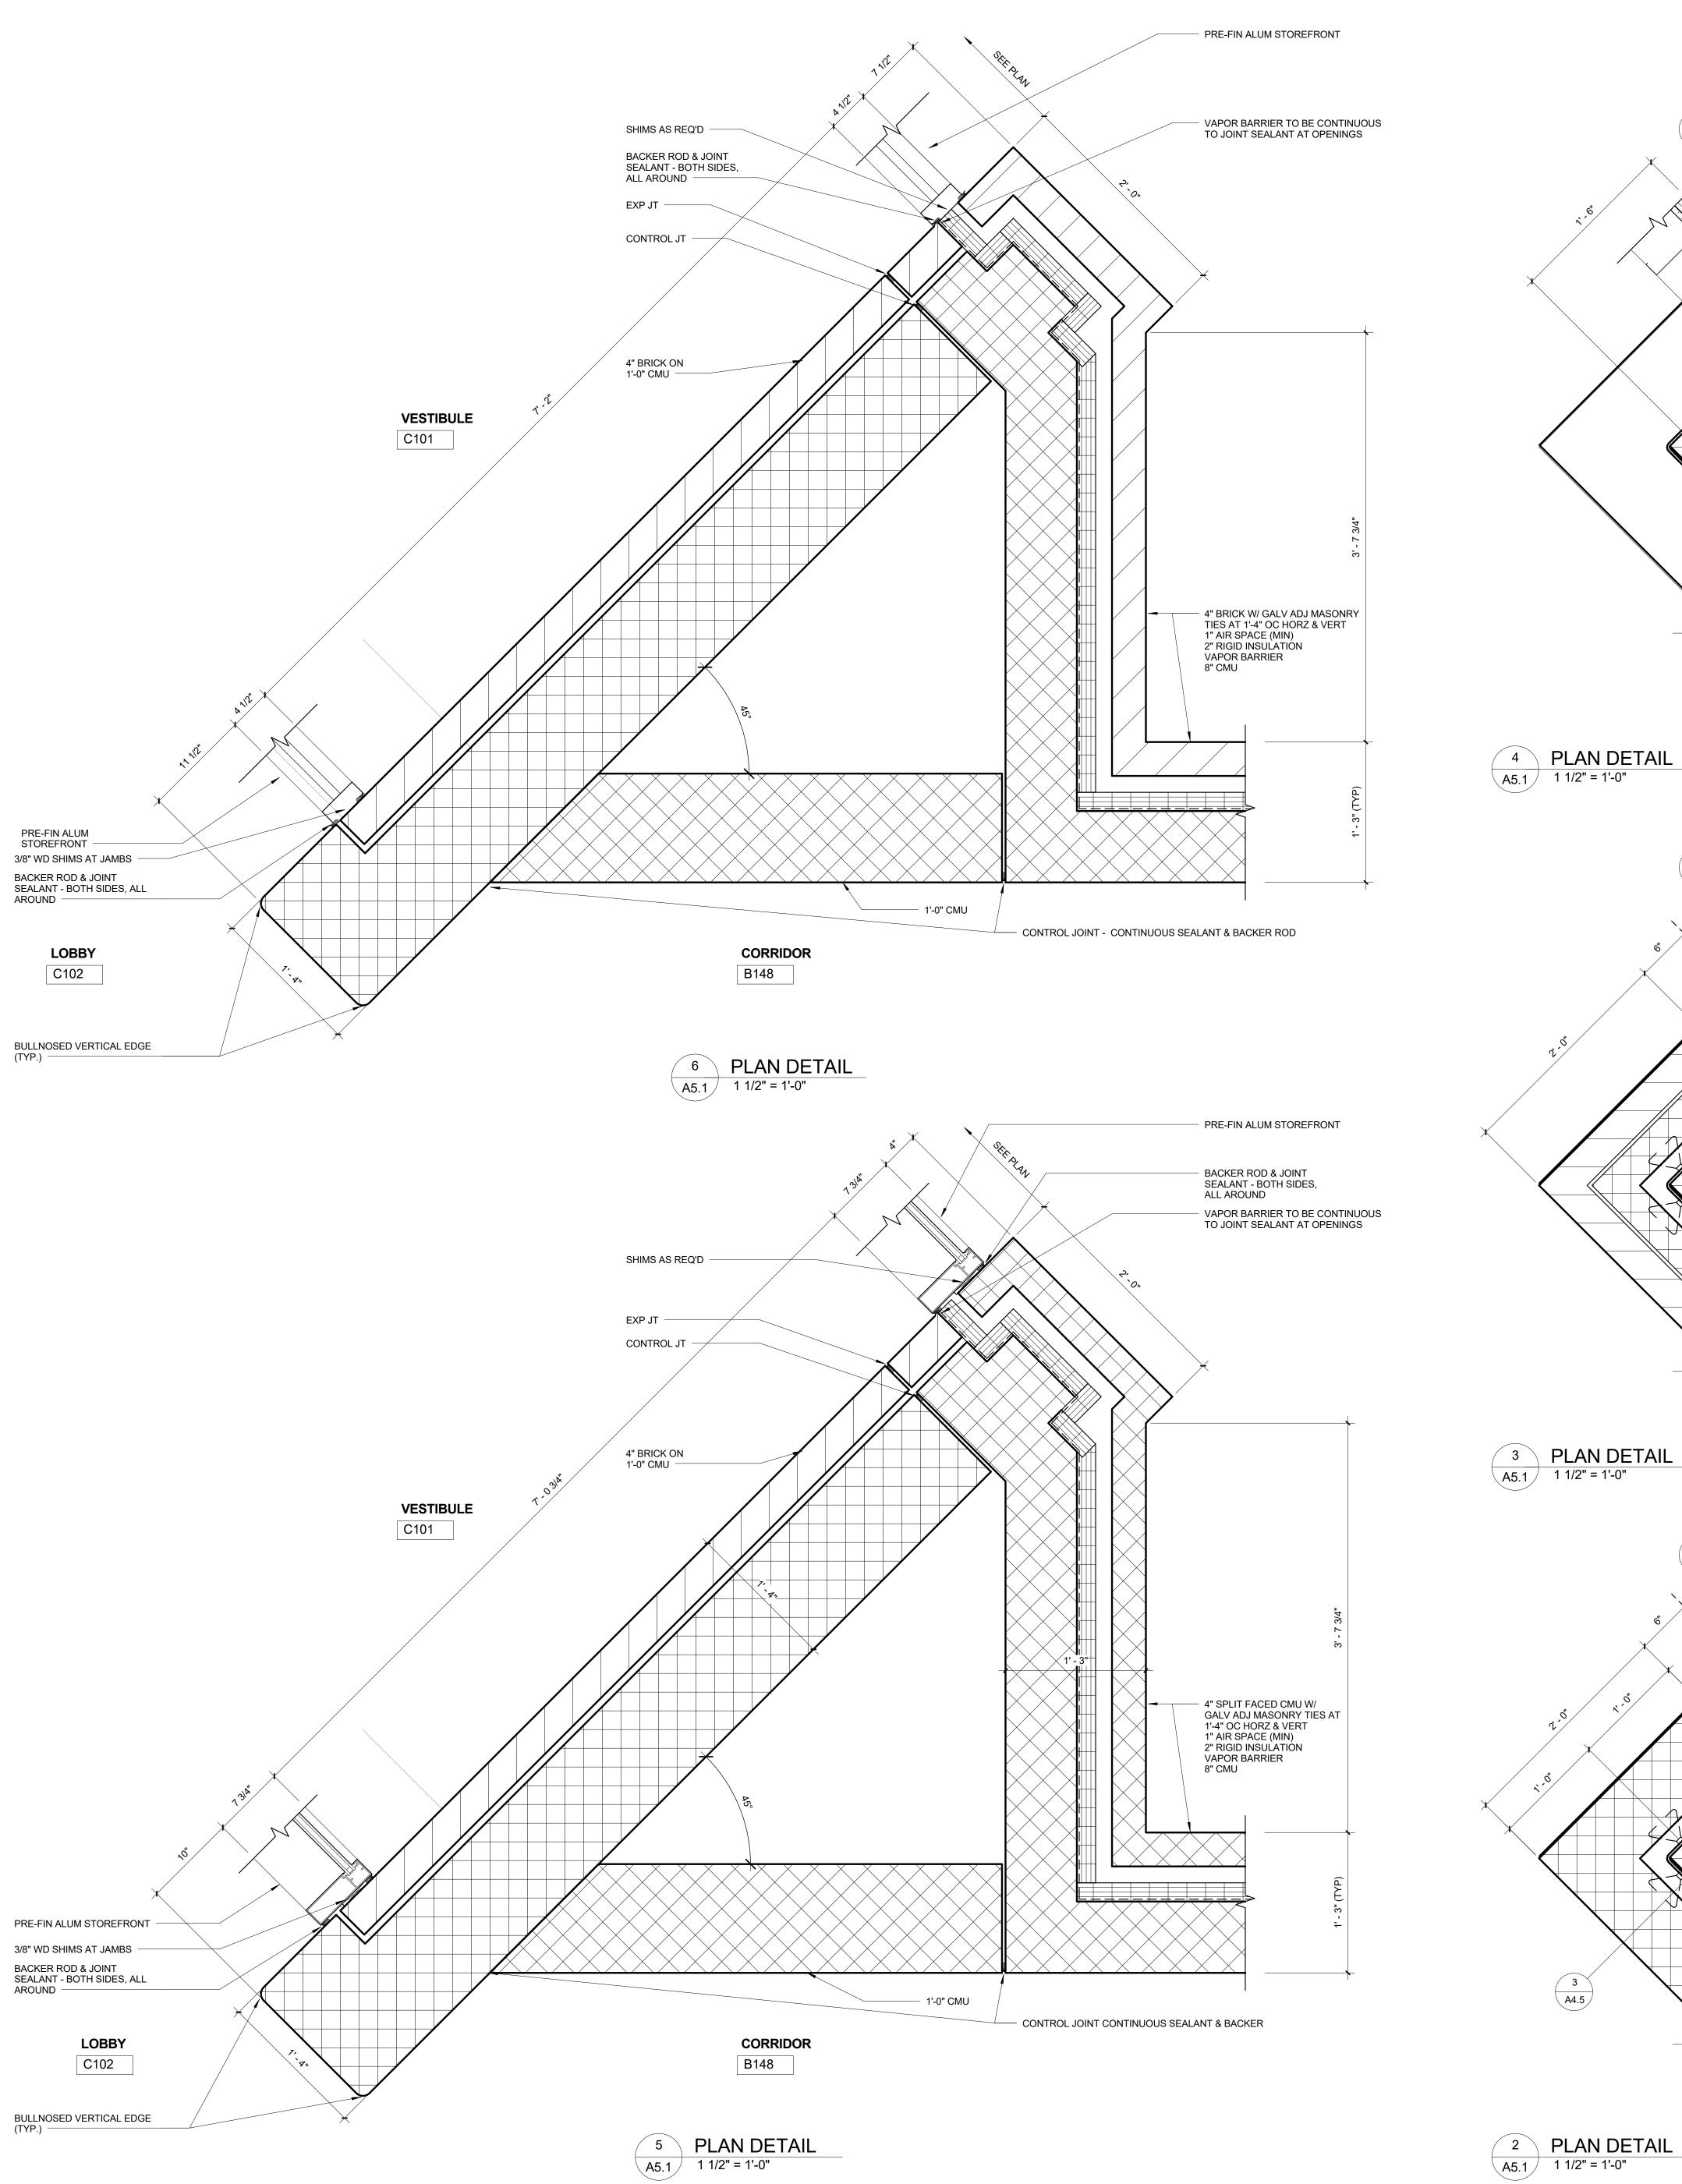

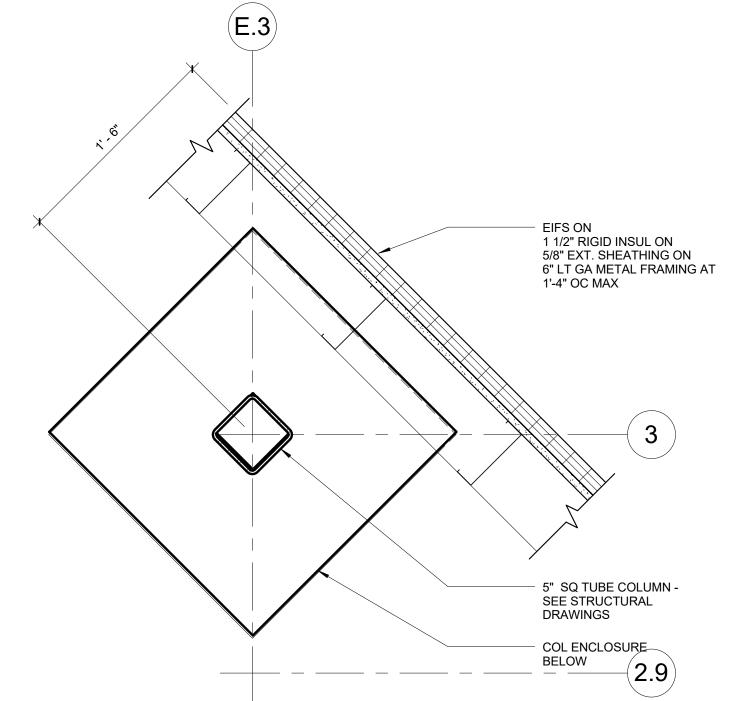4 PLAN DETAIL A5.1 1 1/2" = 1'-0"

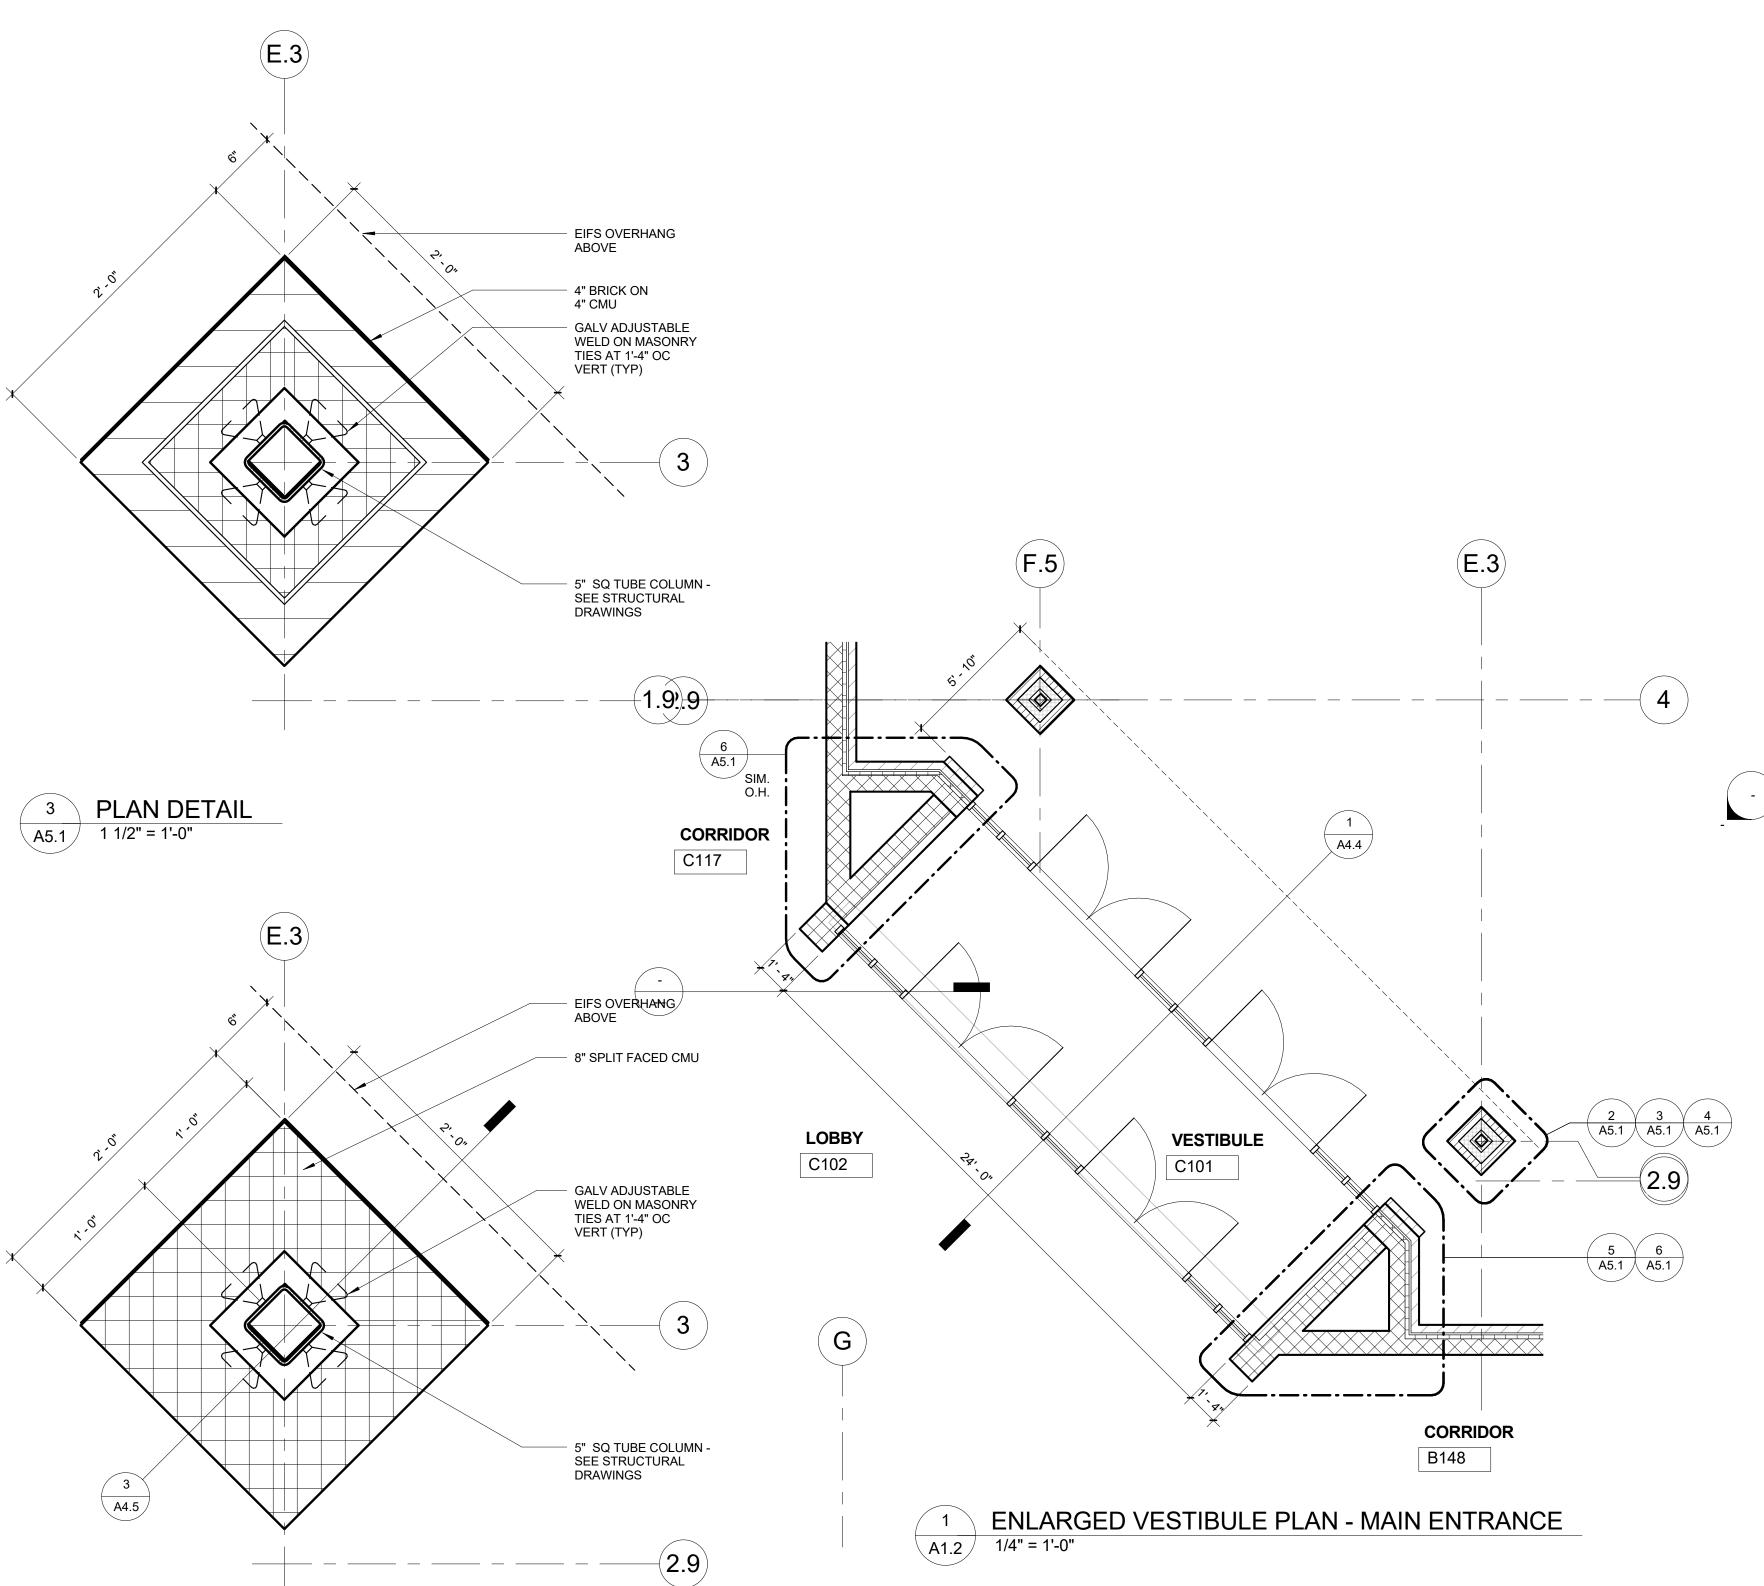



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∞ŏ REVISIONS:


ENLARGED PLAN DETAILS

PRELIMINARY DESIGN DEVELOPMENT CONSTRUCTION FINAL RECORD CHECKED BY:

Construction Set 04/25/17

DATE: 03/10/17 SHEET NO.:

A5.1

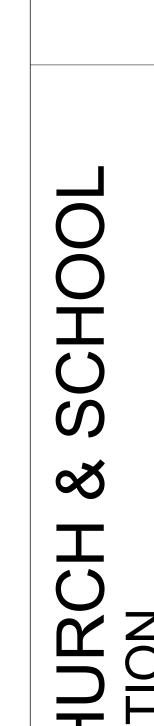

MI 48044

ENLARGED CLASSROOM PLANS AND INTERIOR ELEVATIONS

PRELIMINARY DESIGN DEVELOPMENT CONSTRUCTION FINAL RECORD


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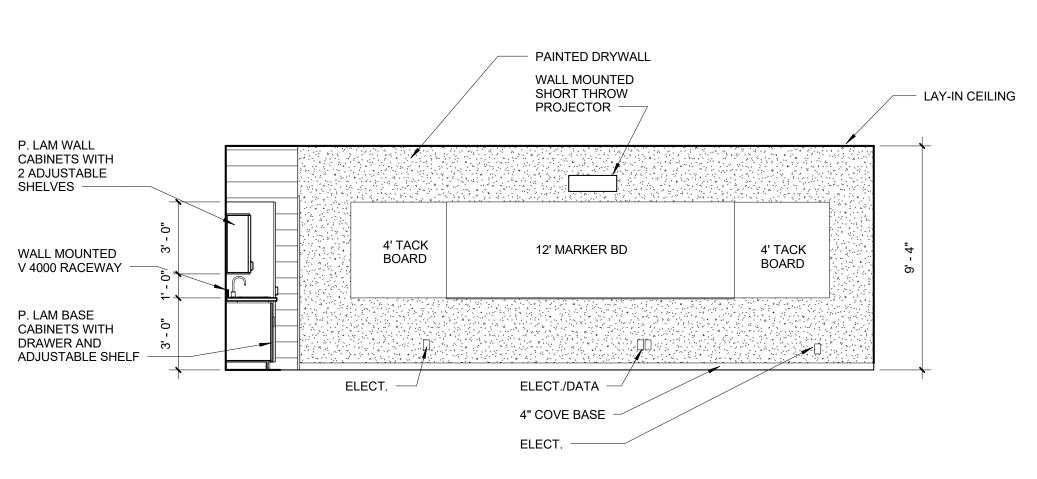
SHEET NO.:

A5.2

JOB NO.: 141594




5 TYP. CLASSROOM ELEVATION - WINDOW WALL A5.2 1/4" = 1'-0"

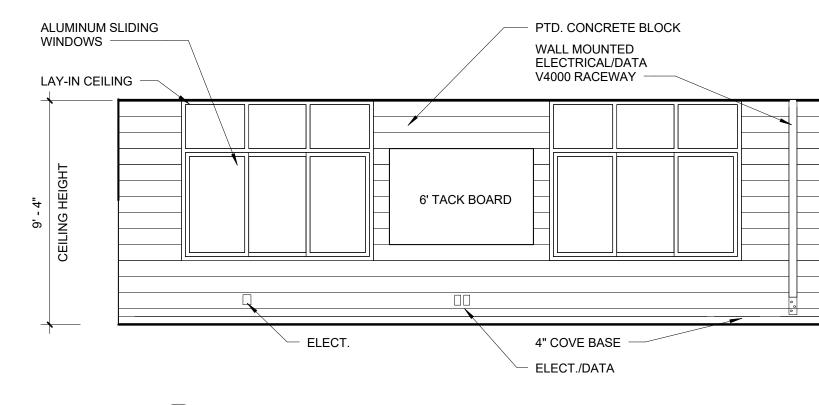


TYP. CLASSROOM ELEVATION - TEACHING WALL


A5.2 1/4" = 1'-0"

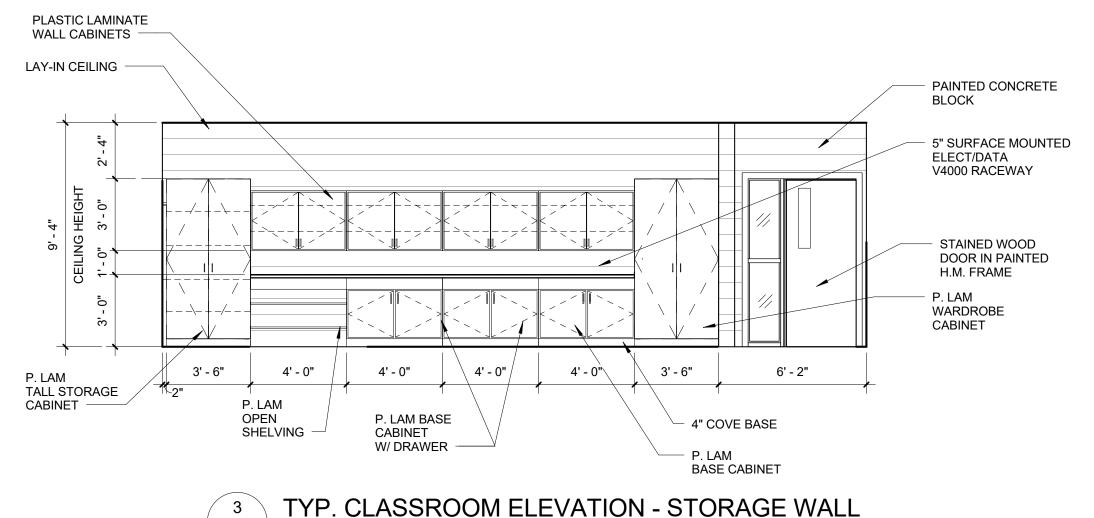


3 TYP. CLASSROOM ELEVATION - STORAGE WALL
A5.2 1/4" = 1'-0"

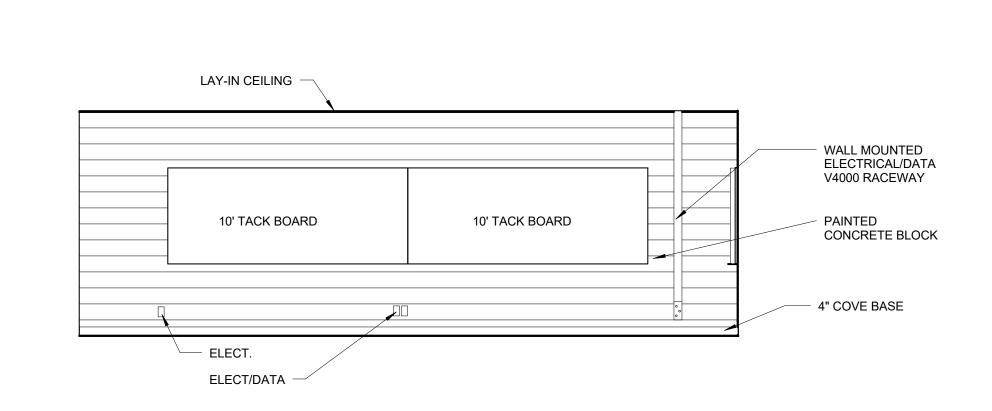

7 TYP. CLASSROOM ELEVATION - NO WINDOWS
A5.2 1/4" = 1'-0"

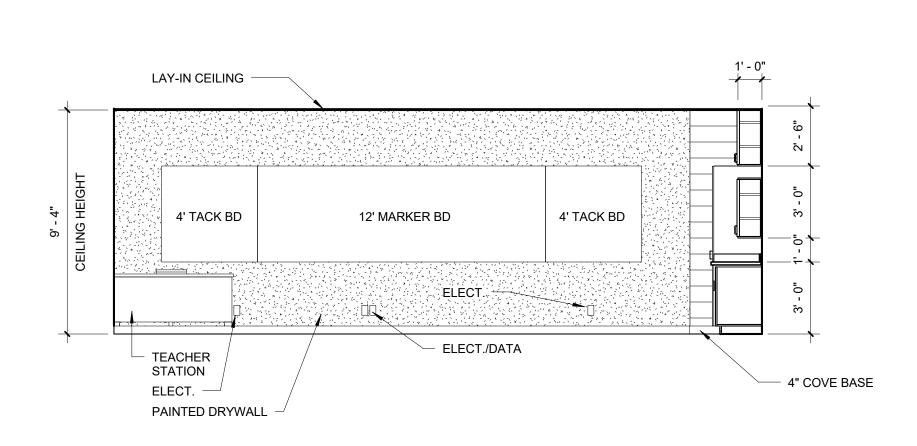

6 TYP. CLASSROOM ELEVATION - DISPLAY WALL
A5.2 1/4" = 1'-0"

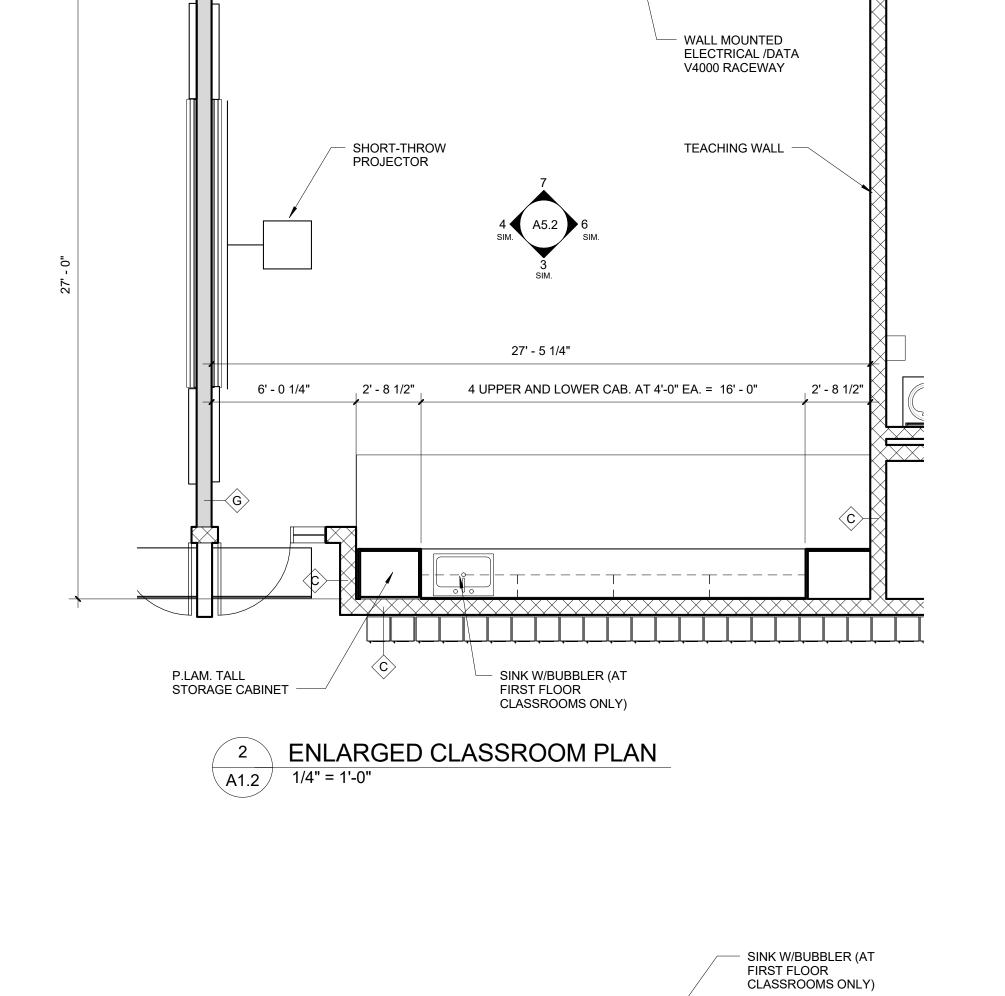

4 UPPER AND LOWER CAB.AT 4'-0"= 16' - 0"

23' - 4"

DISPLAY WALL

- WALL MOUNTED ELECTRICAL/DATA V4000 RACEWAY

1 ENLARGED CLASSROOM PLAN
A1.2 1/4" = 1'-0"

29' - 4"

P.LAM. TALL
 STORAGE CABINET

SHORT-THROW PROJECTOR

TEACHING WALL —

- ALUMINUM SLIDING WINDOWS



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ENLARGED FLOOR PLANS

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REVISIONS: Construction Set

DATE: 03/10/17 SHEET NO.: A5.3



PRELIMINARY DESIGN DEVELOPMENT CONSTRUCTION FINAL RECORD


CHECKED BY: **REVISIONS:**


Construction Set 04/25/17


SHEET NO.:

A5.4


FOR REFERENCE ONLY -JOB NO.: 141594 NOT FOR CONSTRUCTION

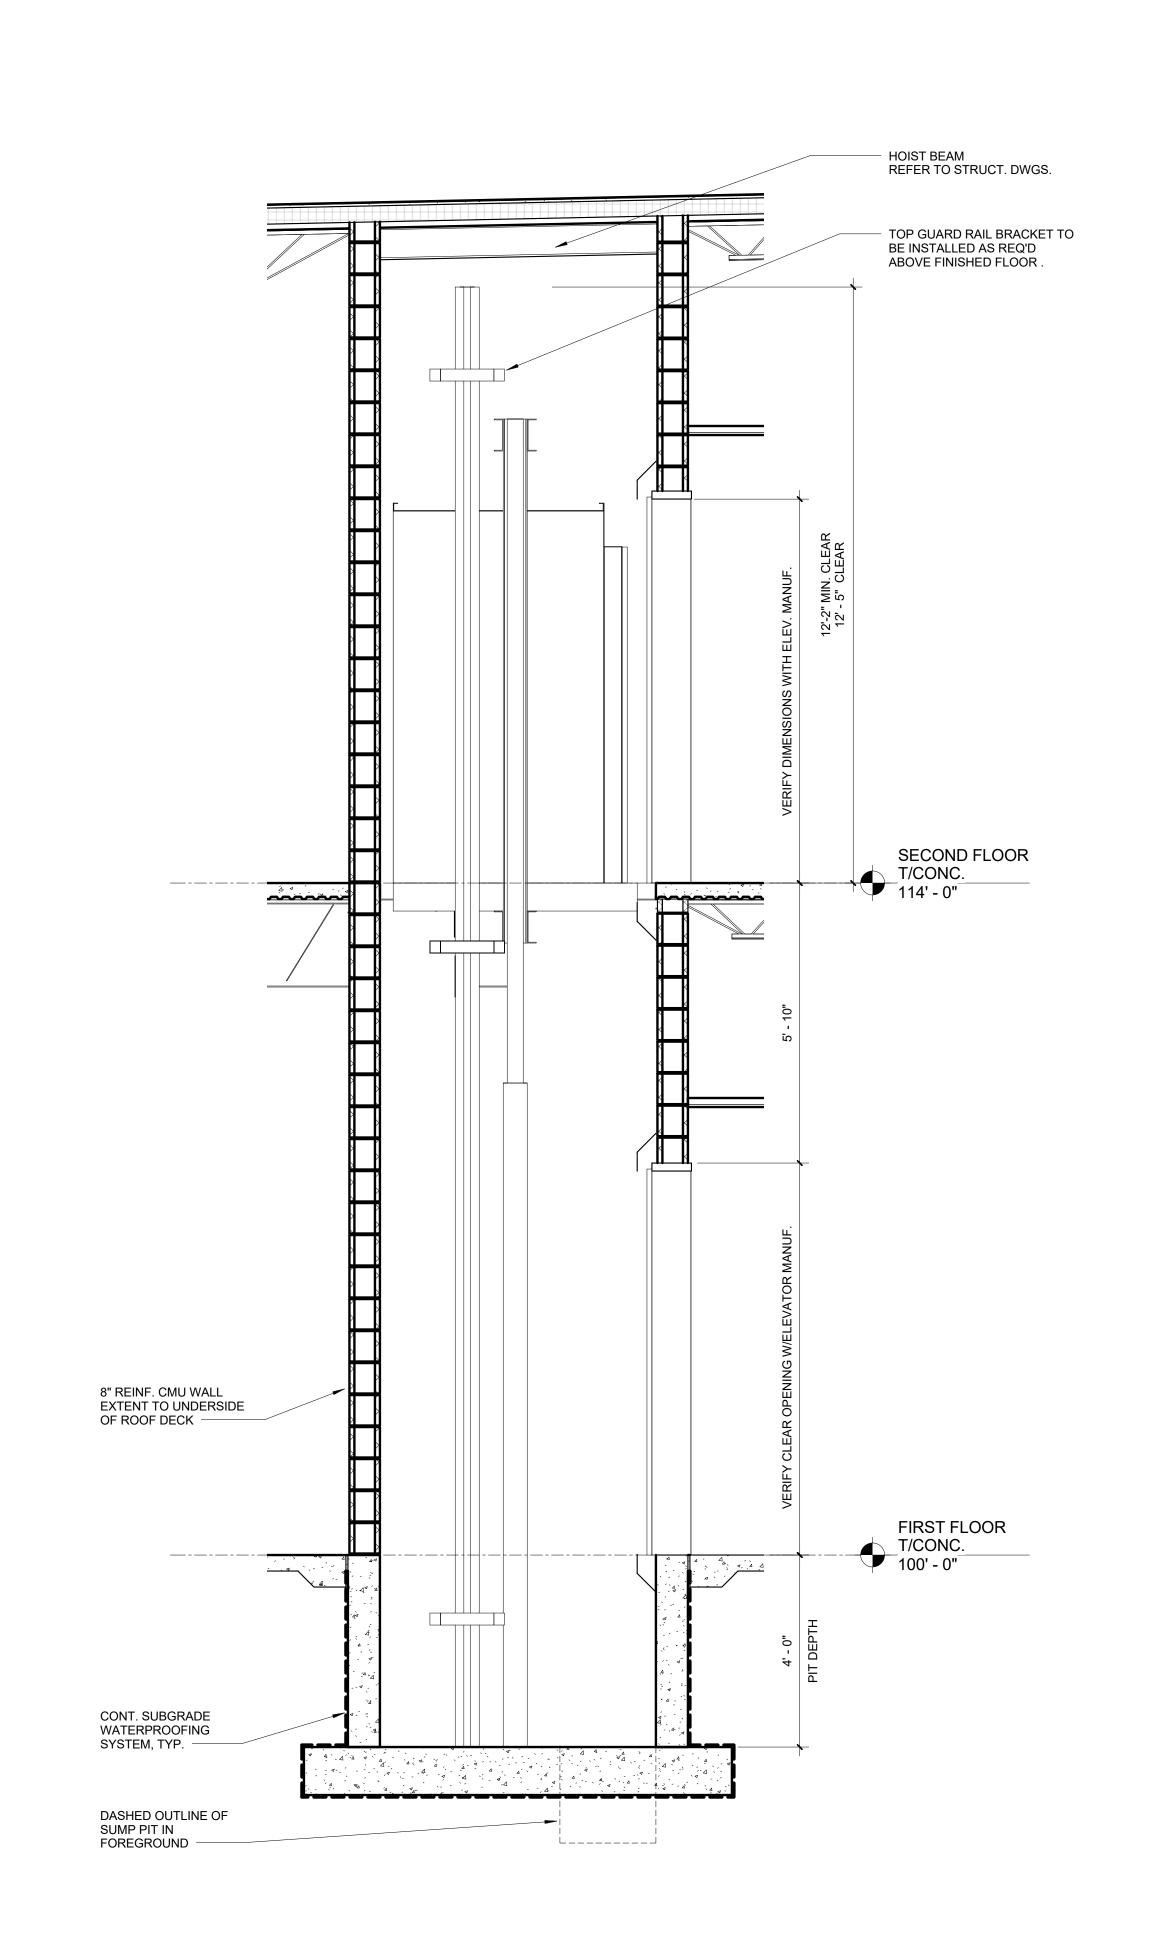

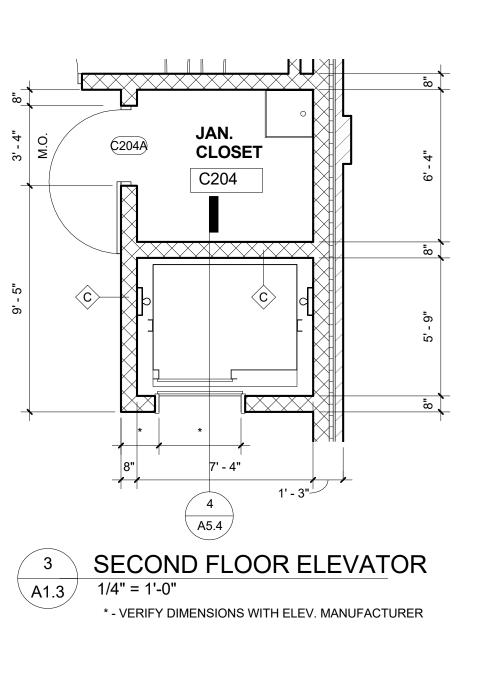

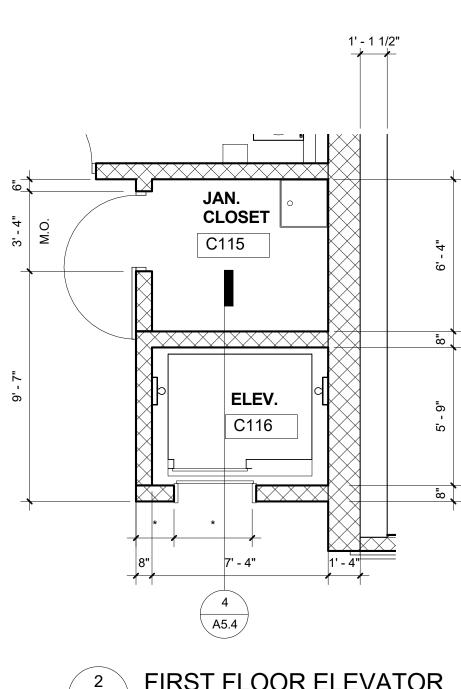



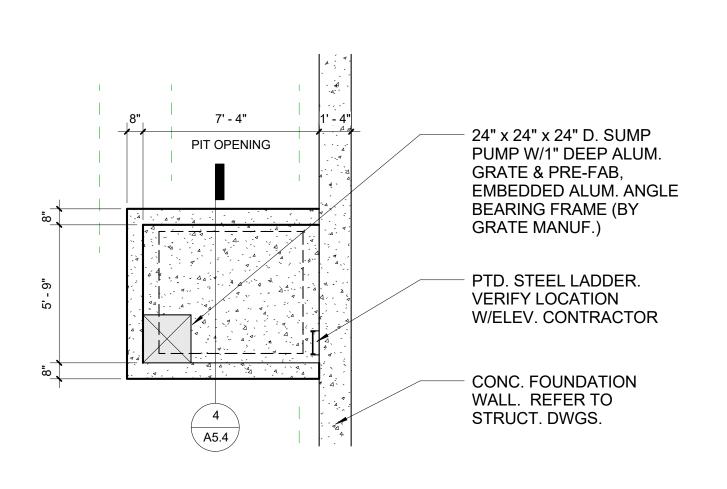



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2" CONC. FILLED STL. PAN STAIR TREADS W/ 1/8" STL. RISERS ENLARGED STAIR PLANS, SECTIONS AND DETAILS 1 1/4" PAINTED CONT. STD. SCHD. 40 STL. PIPE HANDRAIL/ GUARDRAIL 2" CONC. FILLED MTL. PAN STAIR LANDING PRELIMINARY

STAIR

C103


1 ENLARGED SOUTH STAIRWELL - FIRST FLOOR
A1.2 1/4" = 1'-0"

DESIGN DEVELOPMENT CONSTRUCTION FINAL RECORD CHECKED BY: REVISIONS:

Construction Set 04/25/17

DATE: SHEET NO.: 03/10/17

> A5.5 141594

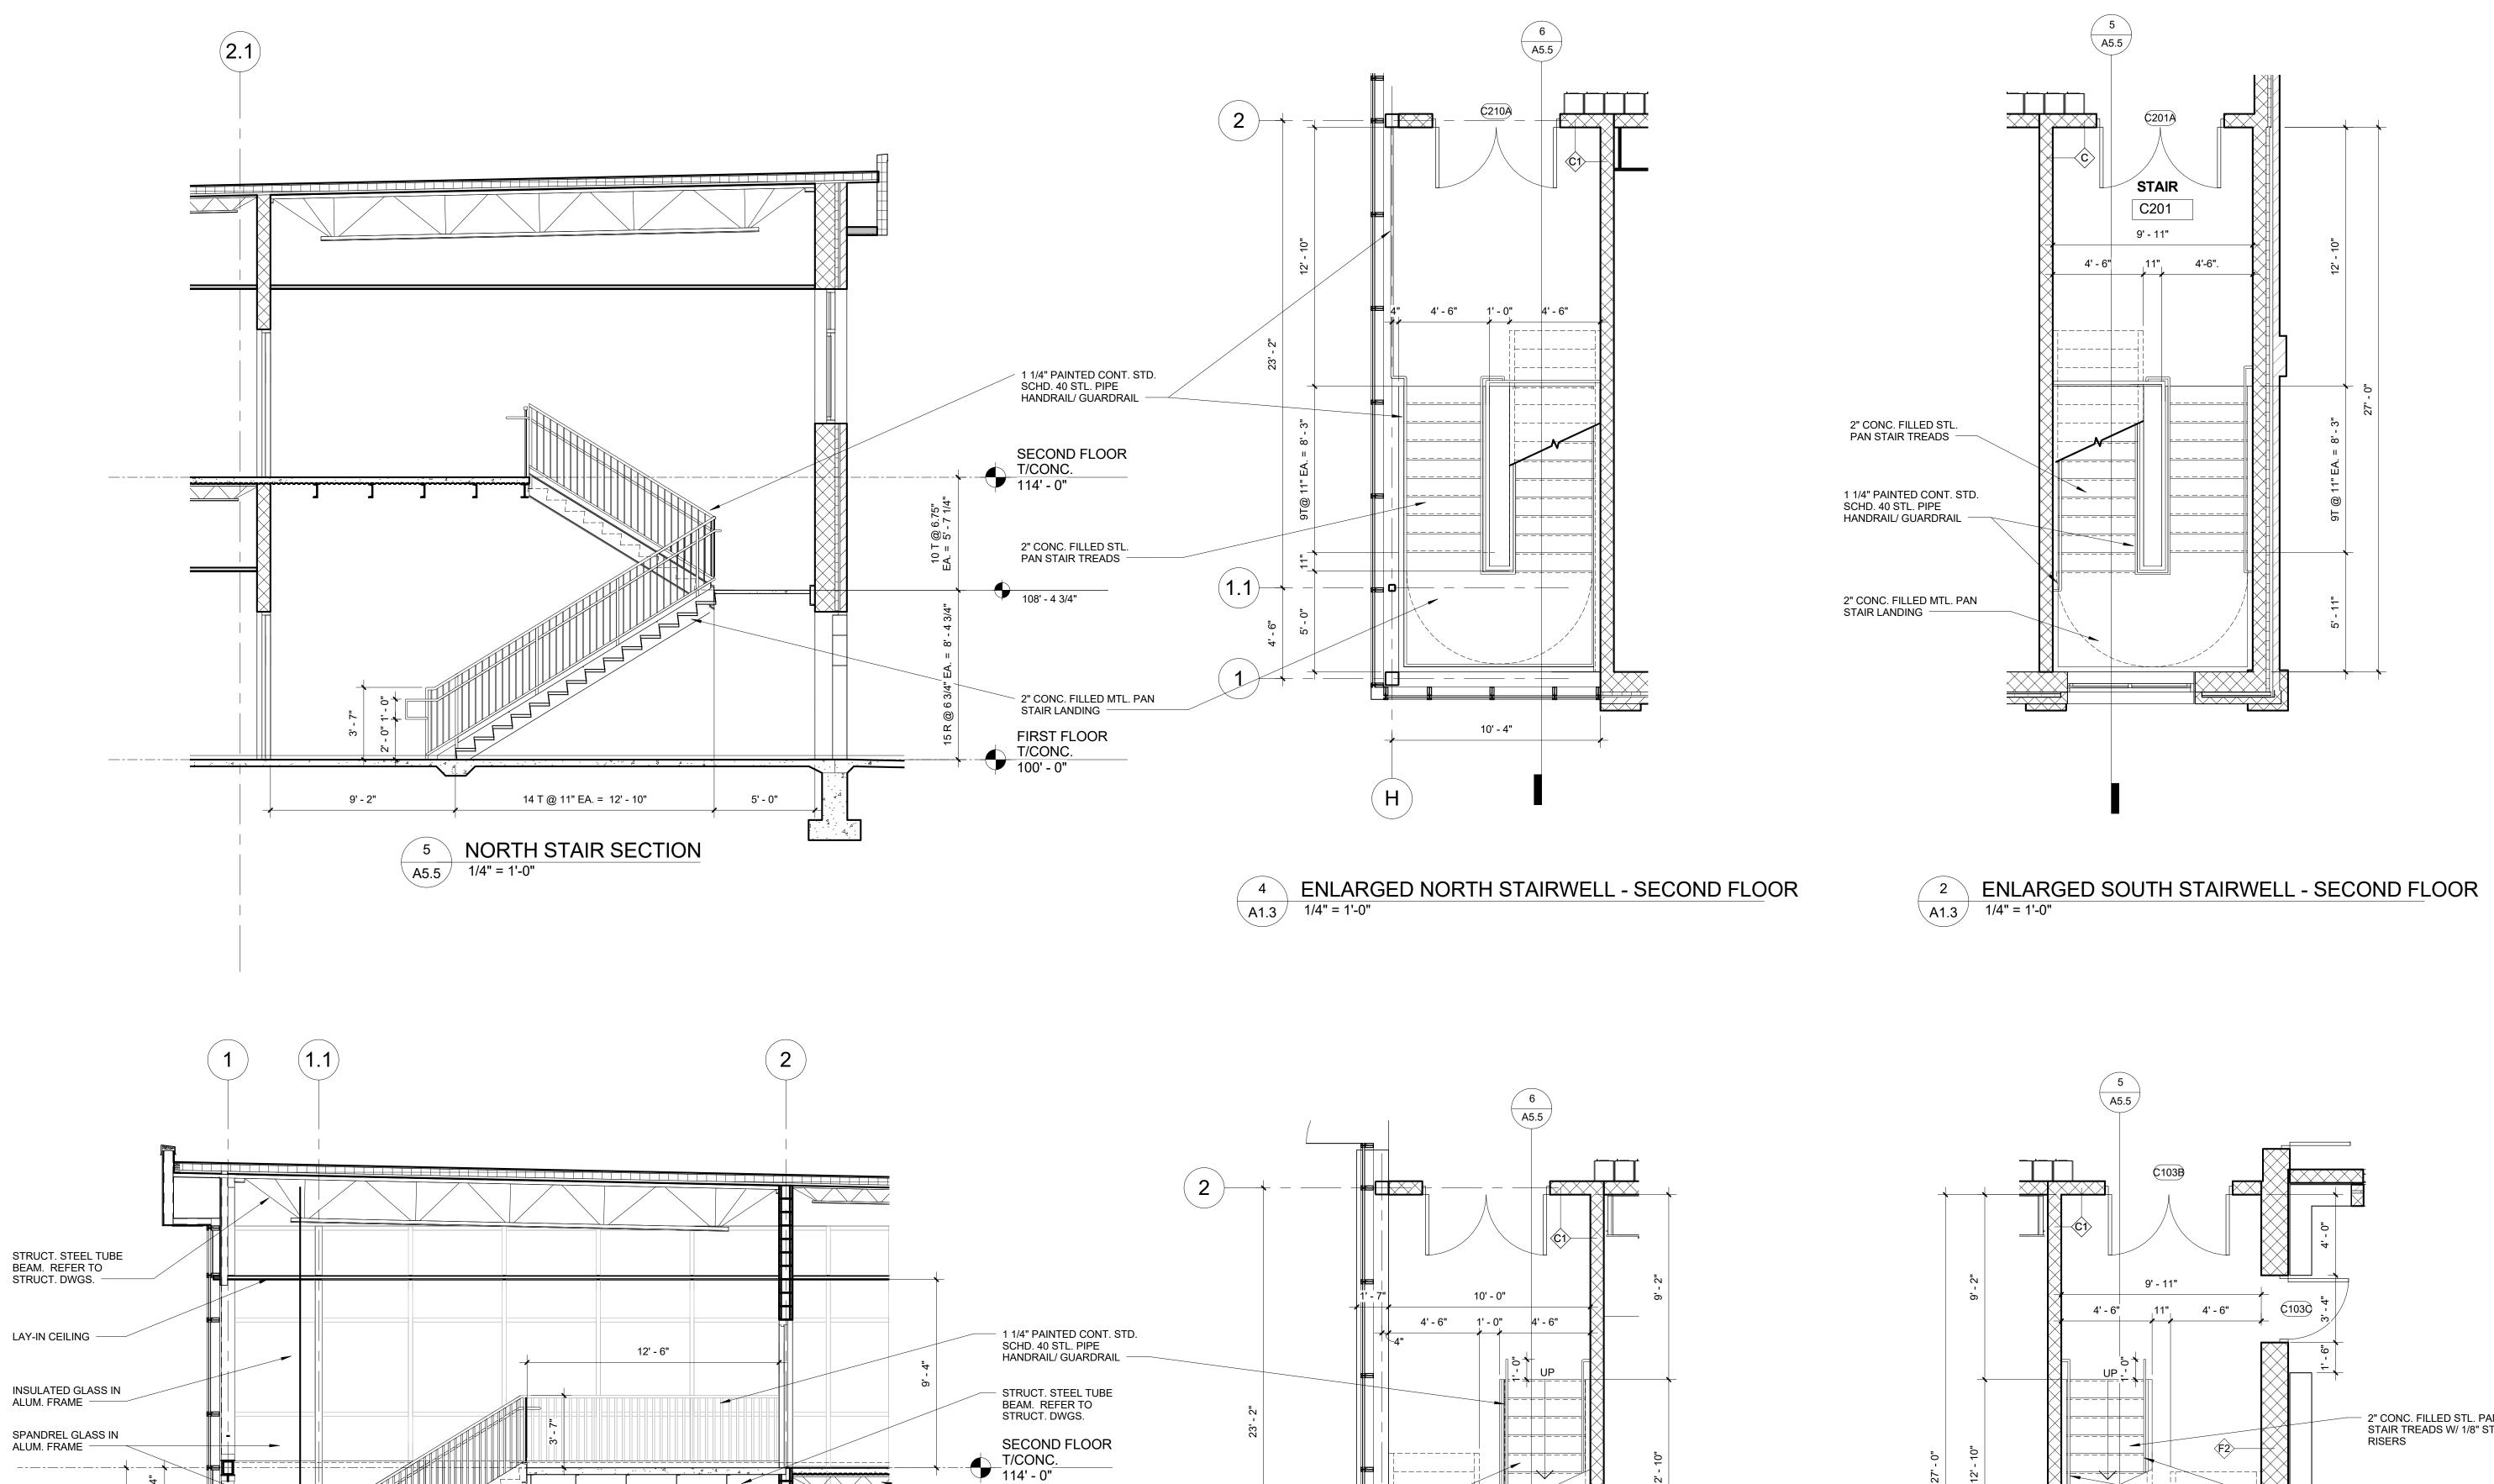

STRUCT. STEEL JOIST REFER TO STRUCT. DWGS.

— STRUCT. STEEL CHANNELS. REFER TO STRUCT. DWGS.

FIRST FLOOR T/CONC. 100' - 0"

2" CONC. FILLED STL. PAN STAIR TREADS W/STL. RISERS

2" CONC. FILLED STL. PAN STAIR TREADS W/STL. RISERS —

10' - 4"

3 ENLARGED NORTH STAIRWELL - FIRST FLOOR
A1.2 1/4" = 1'-0"

T/LANDING
108' - 4 3/4"


STRUCT. STEEL TUBE. REFER TO STRUCT. DWGS. —

14 T @ 11 EA. = 12' - 10"

6 BS SOUTH STAIR
A5.5 1/4" = 1'-0"

5' - 0"

9' - 2"

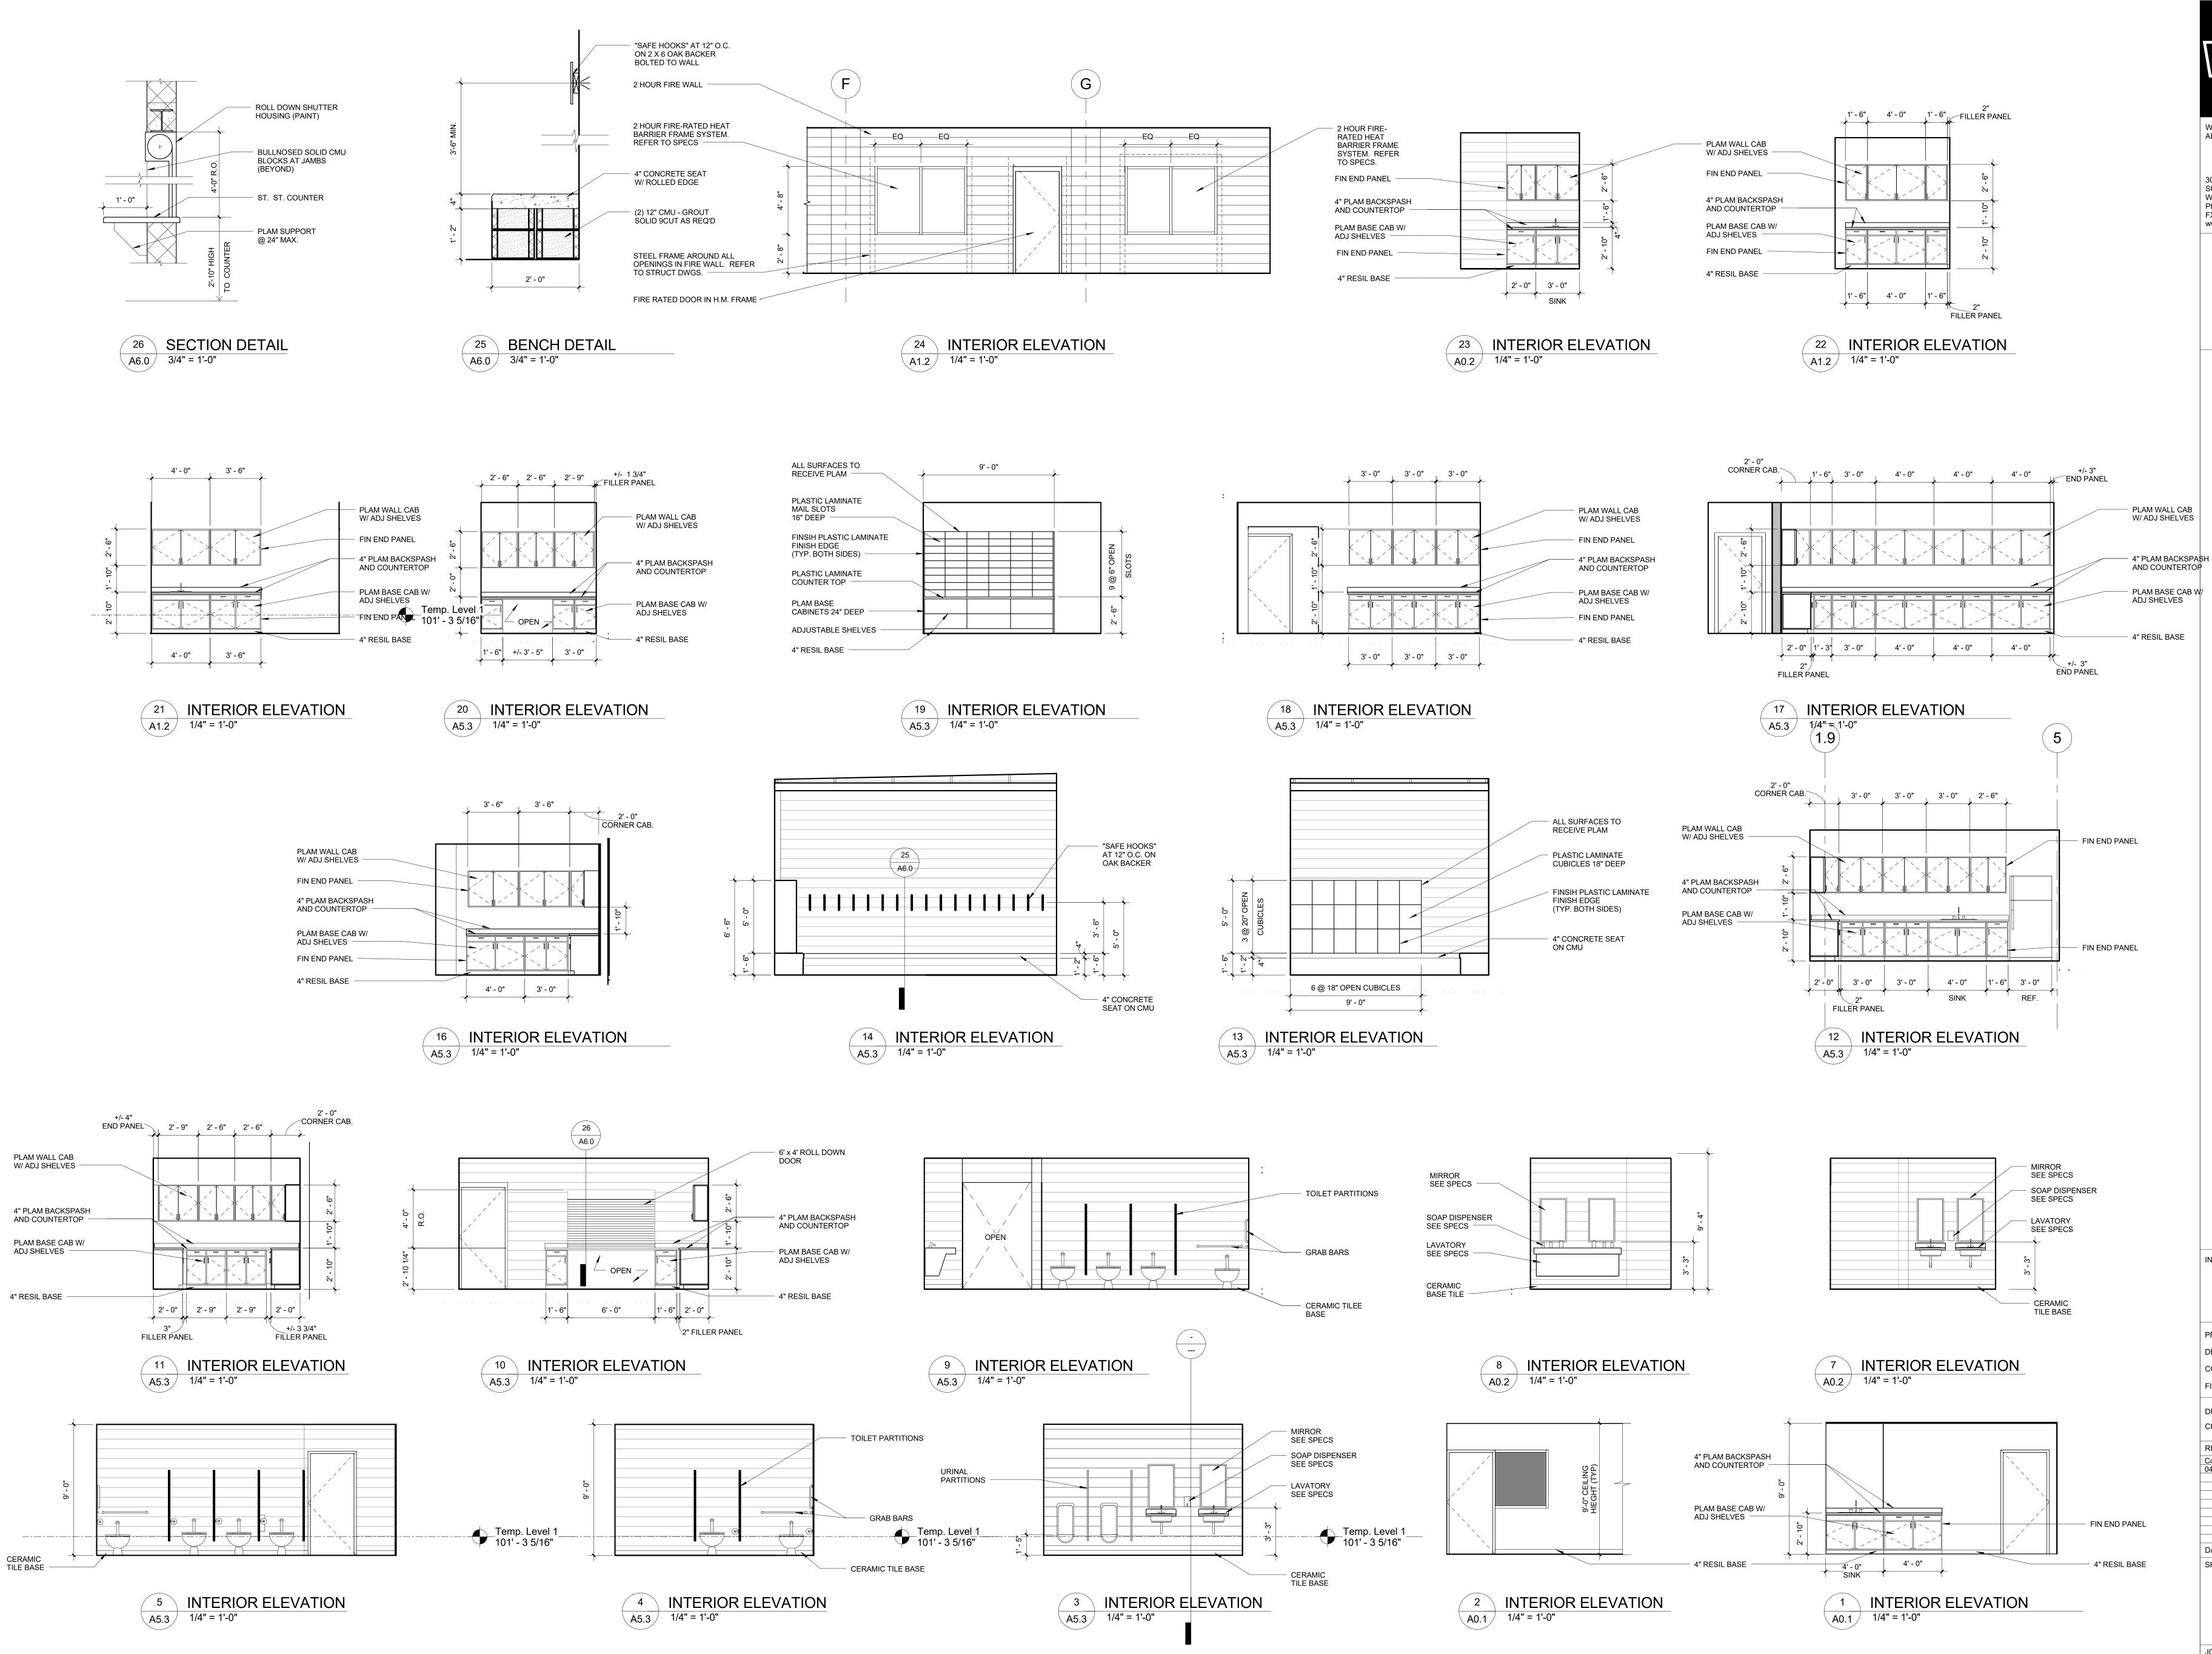



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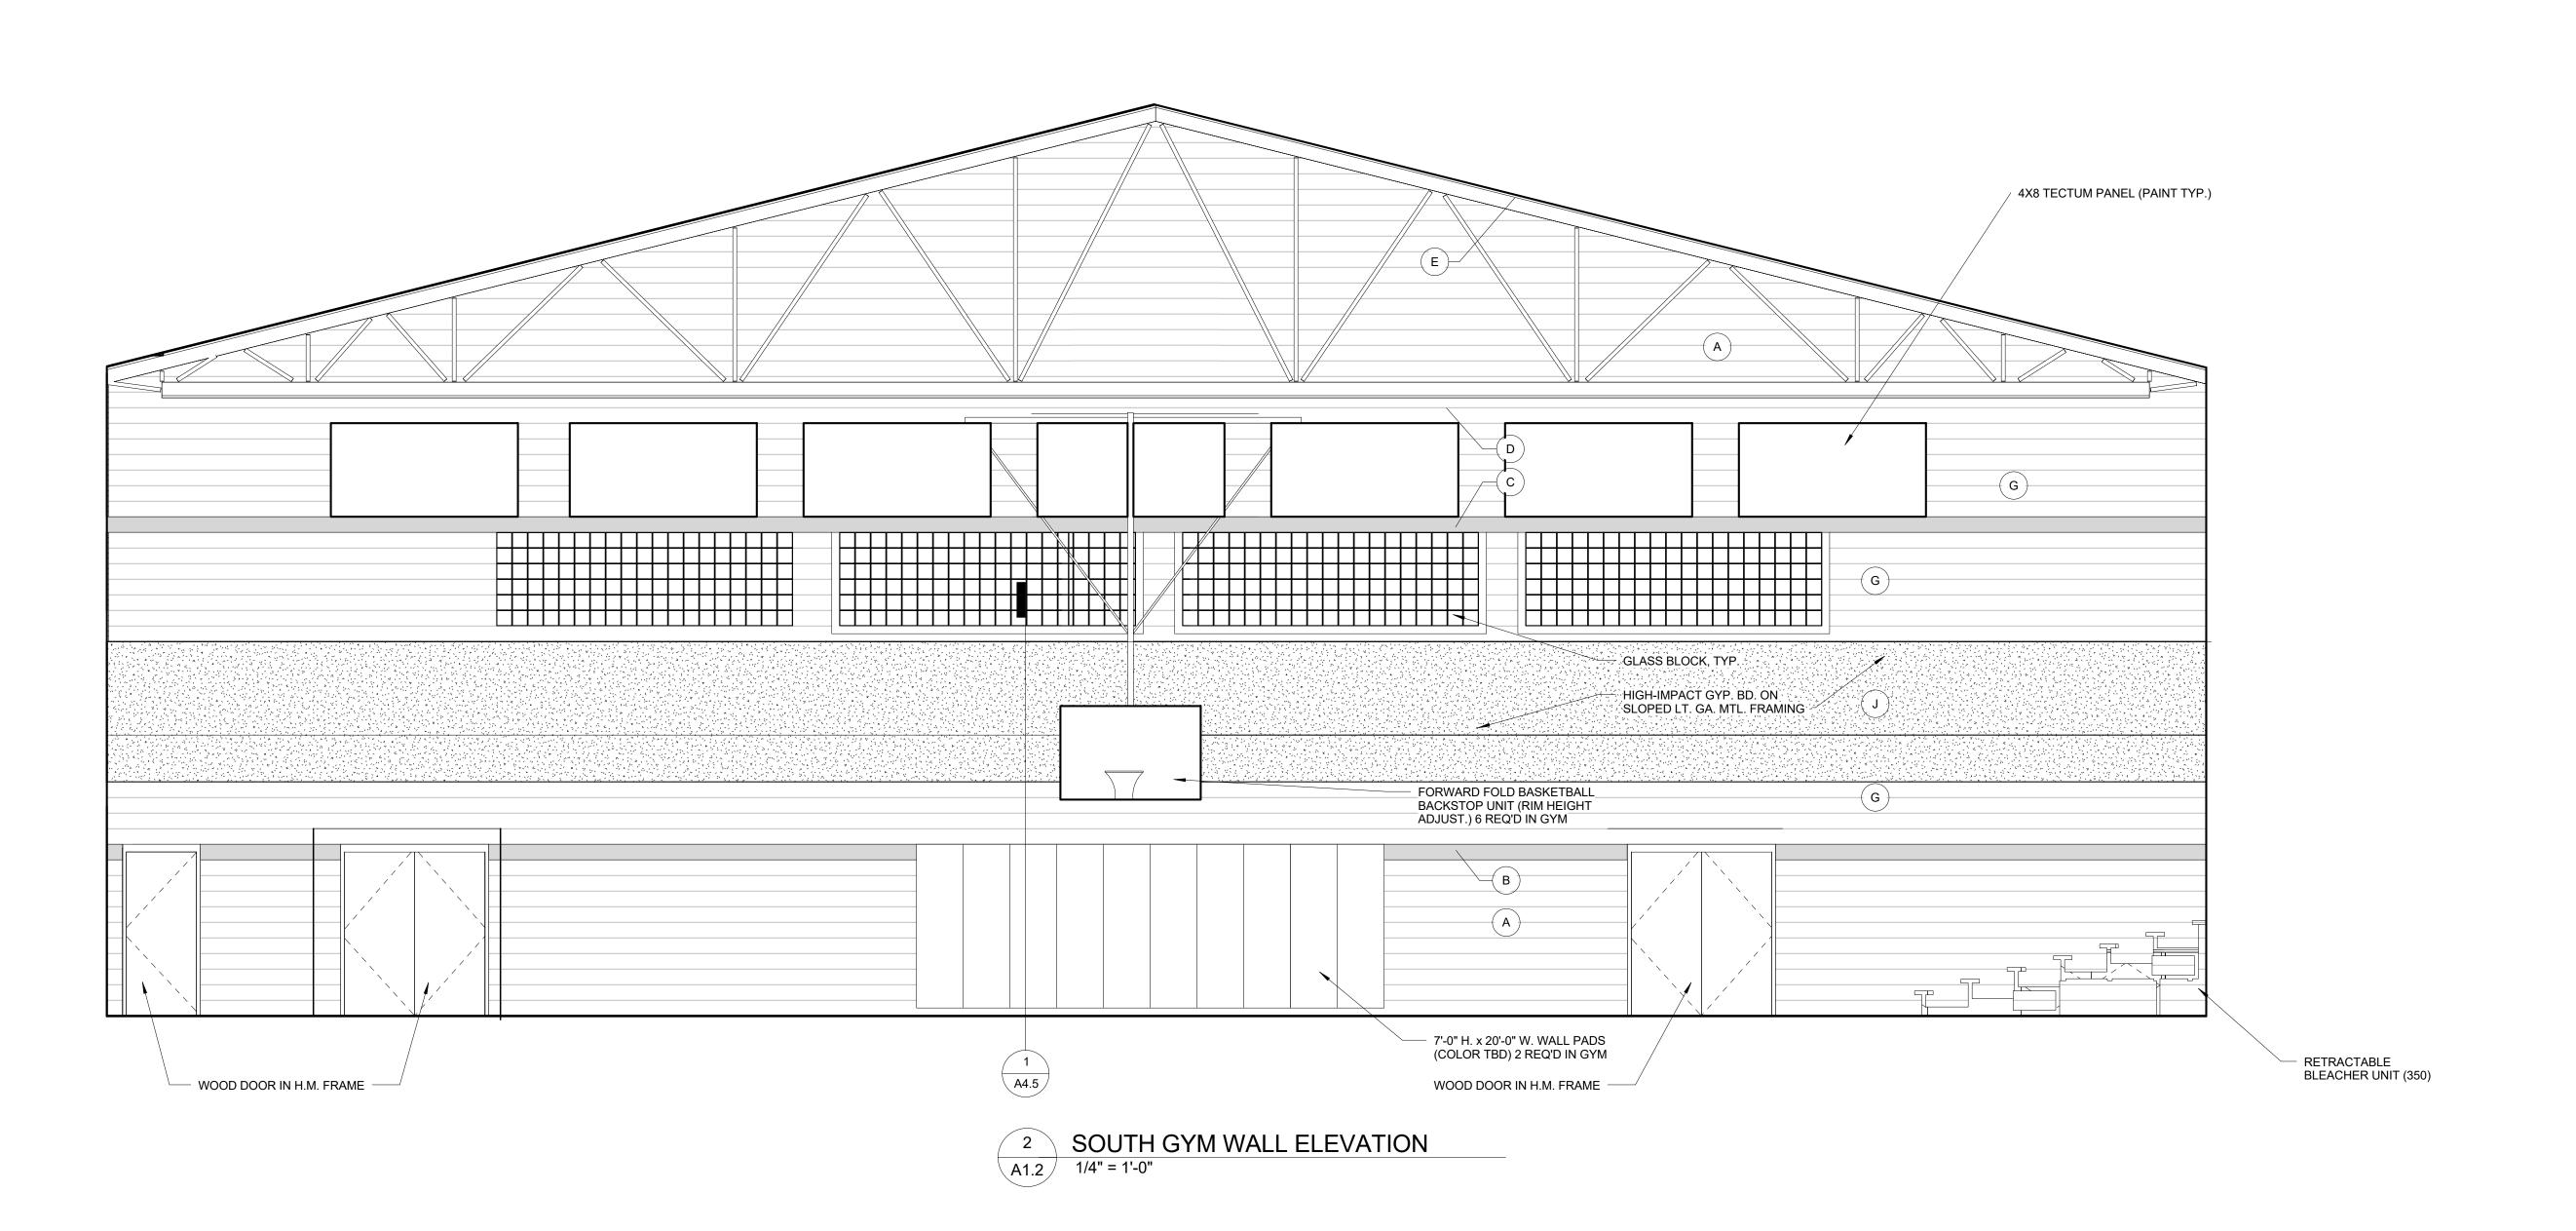
IMMANU CLASSRO 47120 Romeo PI INTERIOR ELEVATIONS

PRELIMINARY DESIGN DEVELOPMENT CONSTRUCTION FINAL RECORD DRAWN BY: CHECKED BY:

REVISIONS: Construction Set

DATE: 03/10/17 SHEET NO.:

A6.0




INTERIOR PAINT COLOR LEGEND:

- A COLOR 'A'
- B' H. COLOR 'B'
- 8" H. COLOR 'C'
- PAINT ROOF TRUSSES COLOR 'D'
- PAINT ROOF DECK COLOR 'E'
- PAINT 4' H. LETTERS ON THE WALL (CHARGERS) AT NORTH END OF GYM
- G) COLOR 'F'
- (H) COLOR 'G'
- COLOR 'H' (ON SLOPED ROOF)
- K COLOR 'J'
- L COLOR 'K'

GENERAL NOTES:

 REFER TO SHEET A3.0 BUILDING SECTIONS FOR NORTH AND EAST INTERIOR ELEVATION.

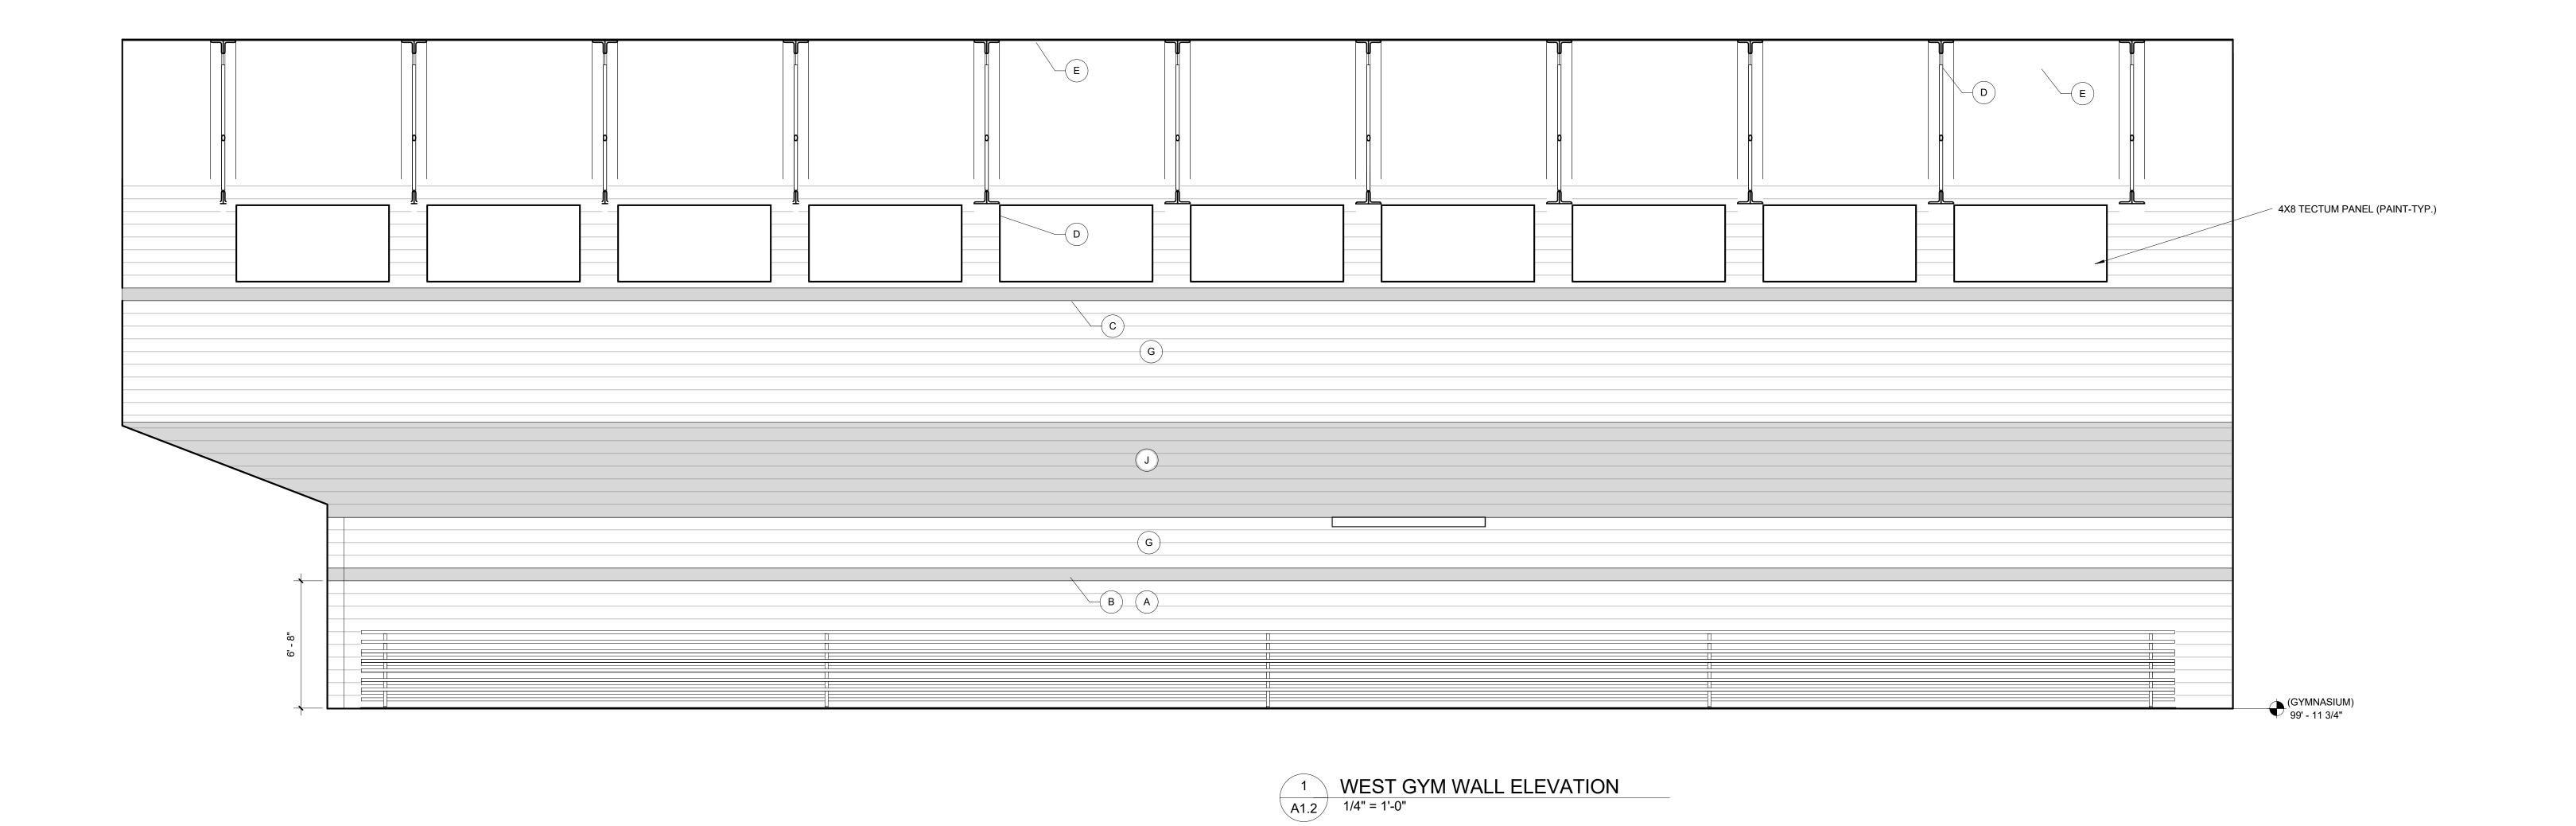

THE CLASSROOM & GYMNA

A7120 Romen Plank Road Macomb

WAKELY ASSOCIATES, INC. ARCHITECTS

30500 VAN DYKE AVENUE

WARREN, MICHIGAN 48093

SUITE M-7

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A6.1

DESIGN DEVELOPMENT

CONSTRUCTION


FINAL RECORD

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CONSTRUCTION SET


DATE:


SHEET NO.


03/10/17

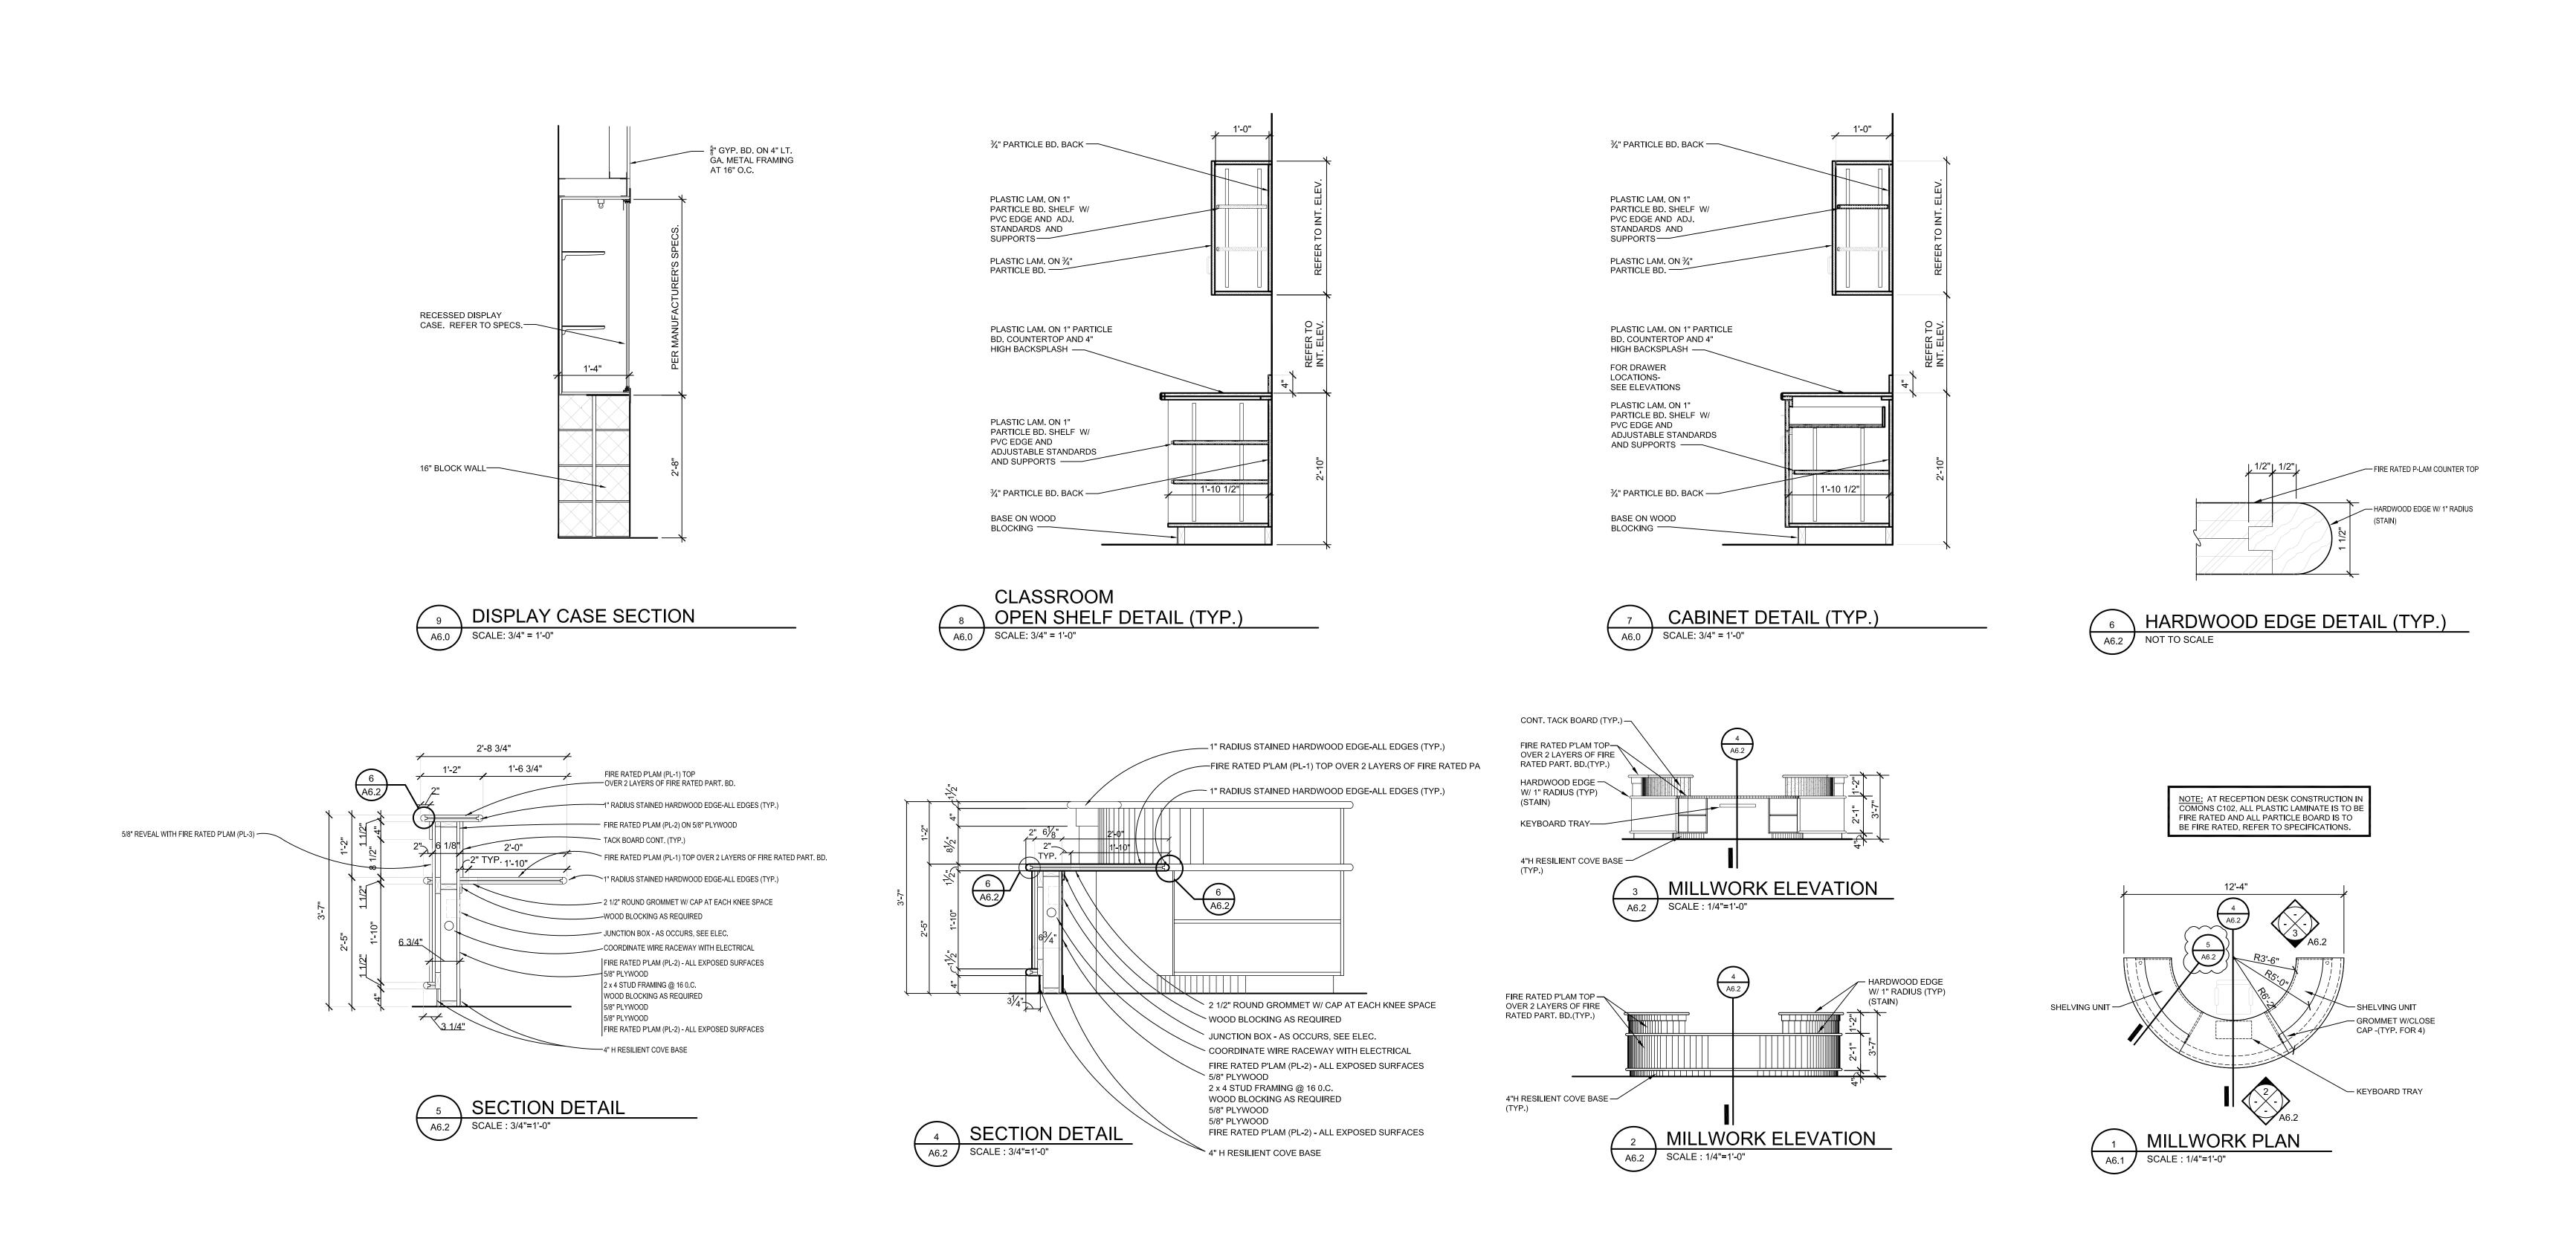
A6.2

^{JOB NO.}141594

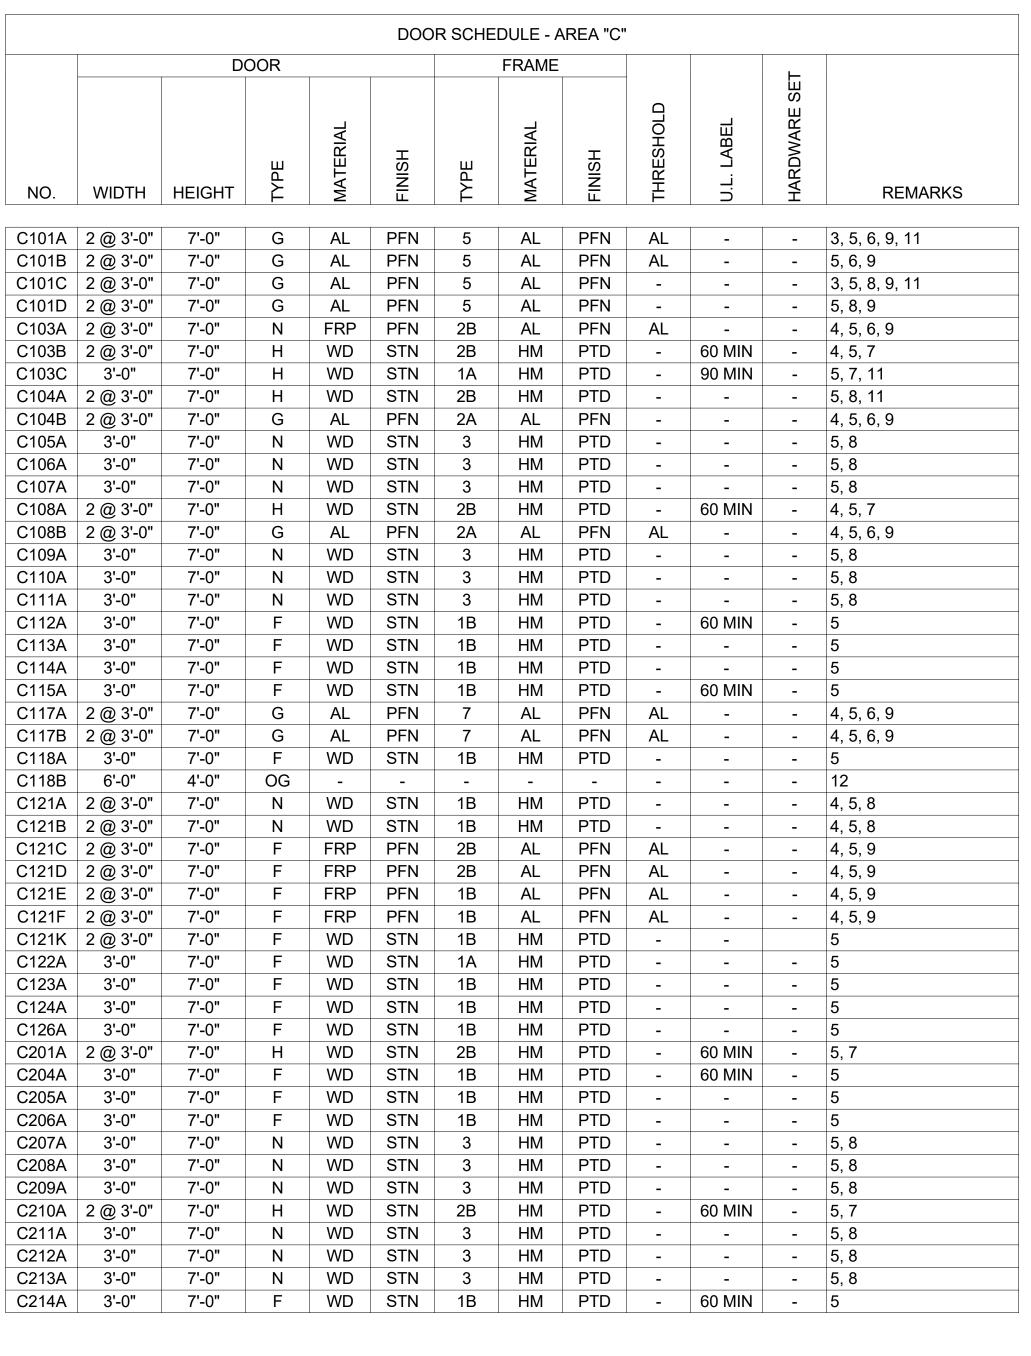

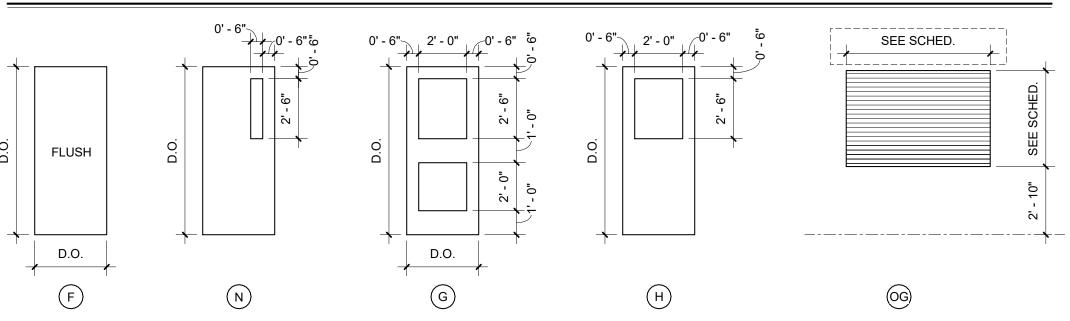

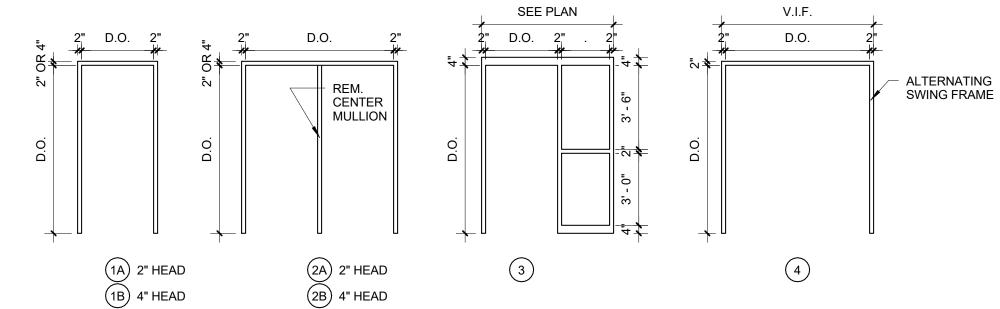

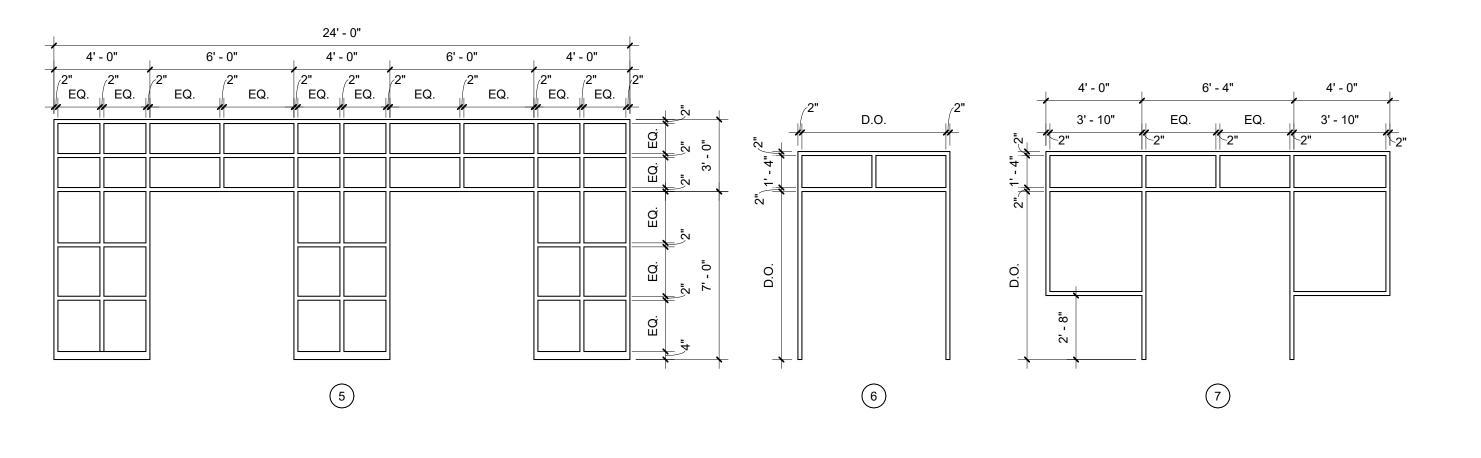

					DOO	R SCHE	DULE - A	NREA "A"				
		D	OOR				FRAME				_	
NO.	WIDTH	HEIGHT	ТҮРЕ	MATERIAL	FINISH	TYPE	MATERIAL	FINISH	THRESHOLD	U.L. LABEL	HARDWARE SET	REMARKS
A008A				WD			НМ	PTD				1
	-	-	-		-	-			-	-	-	1
A009A	-	-	-	WD	-	-	HM	PTD	-	-	-	1
A010A	-	_	_	WD	-	_	HM	PTD	-	_	-	1

A800A	-	_	-	WD	-	_	HM	PTD	-	-	-	1
A009A	-	-	-	WD	-	-	HM	PTD	-	-	-	1
A010A	-	-	-	WD	-	-	HM	PTD	-	-	-	1
A011A	3'-0"	7'-0"	N	WD	STN	1A	HM	PTD	-	-	-	5, 8
A012A	3'-0"	7'-0"	N	WD	STN	1A	HM	PTD	-	-	-	5, 8
A013A	3'-0"	7'-0"	N	WD	STN	1A	HM	PTD	-	-	-	5, 8
A013B	3'-0"	7'-0"	N	WD	STN	1A	HM	PTD	-	-	-	5, 8
A014A	3'-0"	7'-0"	N	WD	STN	8	HM	PTD	-	20 MIN	-	5, 7
A015A	3'-0"	7'-0"	N	WD	STN	1A	HM	PTD	-	-	-	5, 8
A016A	3'-0"	7'-0"	N	WD	STN	1A	HM	PTD	-	-	-	5, 8
A017A	3'-0"	7'-0"	N	WD	STN	1A	HM	PTD	-	-	-	5, 8
NOTIA	<u> </u>	1 -0	14	VVD	OIIV		I IIVI				_	

					DOO	R SCHE	DULE - A	AREA "B"				
			OOR				FRAME				—	
NO.	WIDTH	HEIGHT	ТҮРЕ	MATERIAL	FINISH	TYPE	MATERIAL	FINISH	THRESHOLD	U.L. LABEL	HARDWARE SET	REMARKS
D440A	0 @ 01 01	CL OII		EDD	DEN	0.4		DEN	Λ1			4.5.0
B119A	2 @ 3'-0" 3'-0"	6'-8"	F	FRP	PFN	2A	AL	PFN	AL	-	-	4, 5, 9
B122A B132A	3'-0"	6'-8" 7'-0"	F F	WD WD	STN STN	1A 1A	HM HM	PTD PTD	-	-		5
B135A	2 @ 3'-0"	7'-0"	N	WD	STN	2B	HM	PTD	-	90 MIN	<u>-</u>	4, 5, 7
B136A	3'-0"	7'-0"	N	WD	STN	1A	HM	PTD		20 MIN		5, 7
B136B	3'-0"	6'-8"	F	FRP	PFN	1A	AL	PFN	AL	-		5, 7
B137A	3'-0"	7'-0"	N	WD	STN	1B	HM	PTD	-	_		5, 8
B138A	3'-0"	7'-0"	N	WD	STN	1B	HM	PTD	_	90 MIN		5, 7
B138B	3'-0"	7'-0"	N	WD	STN	1A	HM	PTD	_	90 MIN	_	5, 7
B139A	3'-0"	7'-0"	N	WD	STN	1B	НМ	PTD	-	90 MIN	_	5, 7
B139B	3'-0"	7'-0"	N	WD	STN	1A	НМ	PTD	-	90 MIN	_	5, 7
B140A	3'-0"	7'-0"	N	WD	STN	1B	НМ	PTD	-	90 MIN	-	5, 7
B140B	3'-0"	6'-8"	F	WD	STN	1A	НМ	PTD	-	-	-	5
B141A	3'-0"	7'-0"	N	WD	STN	1A	НМ	PTD	-	-	-	5, 8
B142A	3'-0"	7'-0"	F	WD	STN	1A	HM	PTD	-	-	-	5
B142B	3'-0"	7'-0"	F	WD	STN	1A	HM	PTD	-	-	-	5
B143A	3'-0"	7'-0"	N	WD	STN	1A	НМ	PTD	-	-	-	5, 8
B144A	3'-0"	7'-0"	N	WD	STN	1A	HM	PTD	-	-	-	5, 8
B144B	3'-0"	7'-0"	N	WD	STN	1A	HM	PTD	-	-	-	5, 8
B145A	3'-0"	7'-0"	N	WD	STN	1A	HM	PTD	-	-	-	5, 8
B146A	3'-0"	7'-0"	N	WD	STN	1A	HM	PTD	-	-	-	5, 8
B147A	3'-0"	7'-0"	N	WD	STN	1B	HM	PTD		90 MIN		5,7,11
B148A	2 @ 3'-0"	7'-0"	G	ALUM	PFN	7	AL	PFN	AL	-	-	4, 5, 6, 10

DOOR SCHEDULE GENERAL NOTES (APPLIES TO ALL DOORS):

DOOR SCHEDULE REMARKS: (NOTE: NOT ALL REMARKS LISTED ARE USED)

- EXISTING DOOR AND FRAME TO REMAIN PAINT EXISTING FRAME (PAINT DOOR ALSO IF HM). REMOVE AND REPLACE EXISTING DOOR AND FRAME - SEE SCHEDULE.
- PROVIDE 1" INSUL. GLASS IN DOOR AND FRAME OPENINGS.
 PROVIDE FIRE RATED GLASS IN DOOR AND FRAME OPENINGS. REFER TO SPEC.
- PROVIDE 1/4" LAM. GLASS IN DOOR & FRAME OPENINGS. PROVIDE WEATHERSTRIPING ON NEW FRAME.
- EXISTING FRAMED DOOR OPENING. REMOVE STOPS, REWORK FRAME AS REQ'D TO REVERSE
- 11. PREP NEW FRAME FOR STRIKE RELEASE HARDWARE.
 12. DOOR AND FRAME MATERIALS/FINISHES PER THE MANUFACTURER. REFER TO SPEC.

DOOR SCHEDULES

PRELIMINARY DESIGN DEVELOPMENT CONSTRUCTION FINAL RECORD

DRAWN BY:

JOB NO.: 141594


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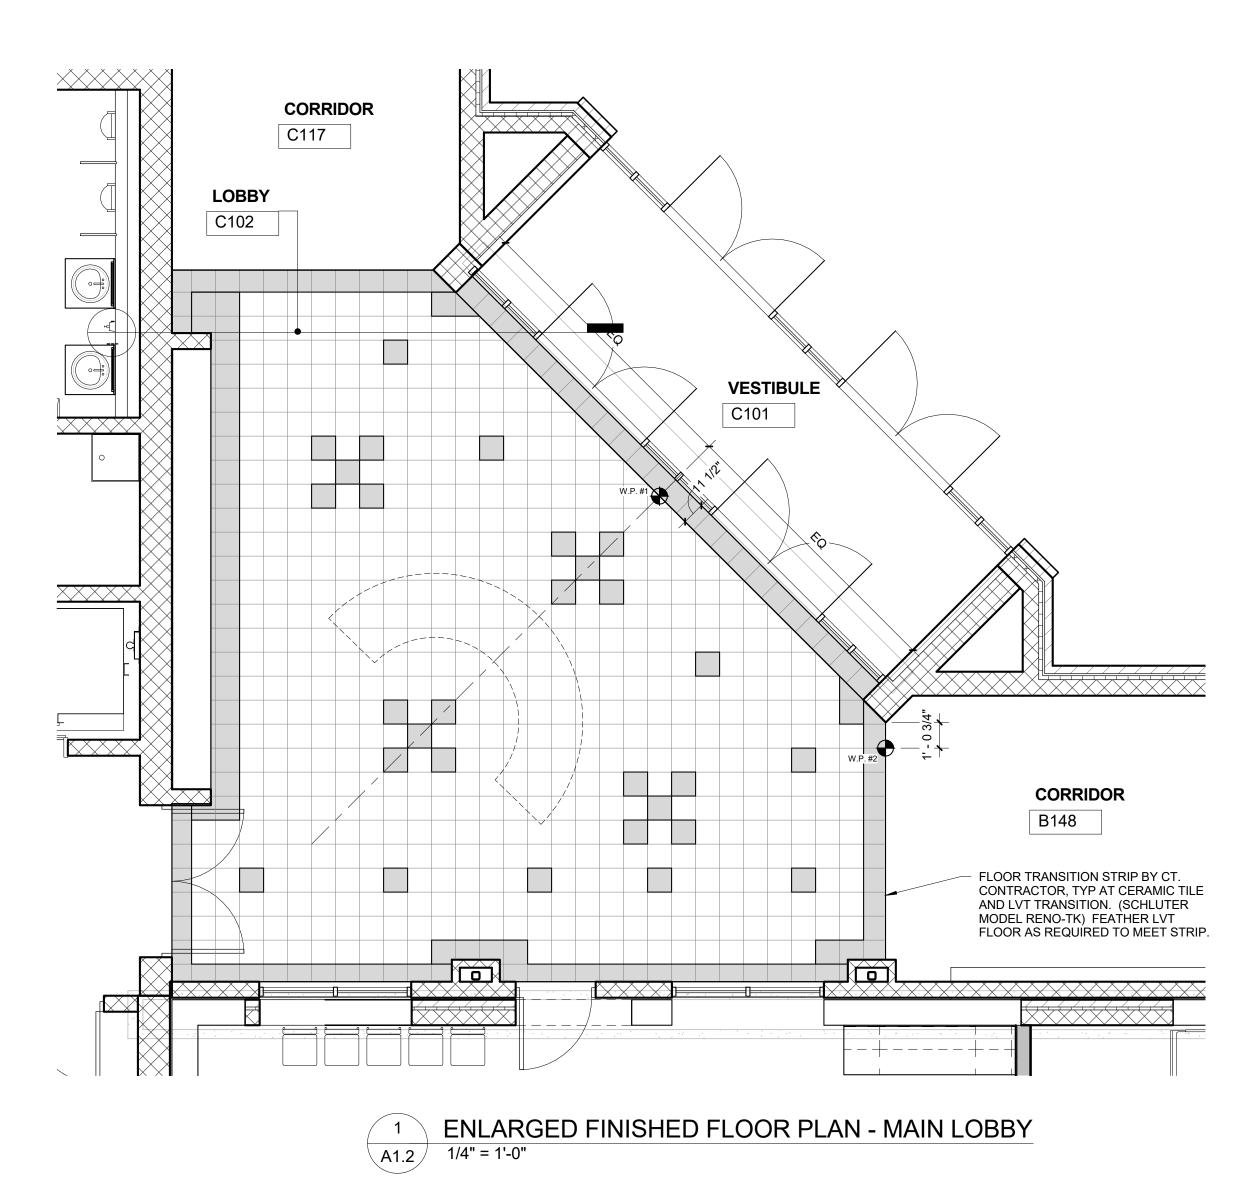
ARCHITECTS

PH: 586.573.4100 FX: 586.573.0822

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30500 VAN DYKE AVENUE SUITE M-7 WARREN, MICHIGAN 48093



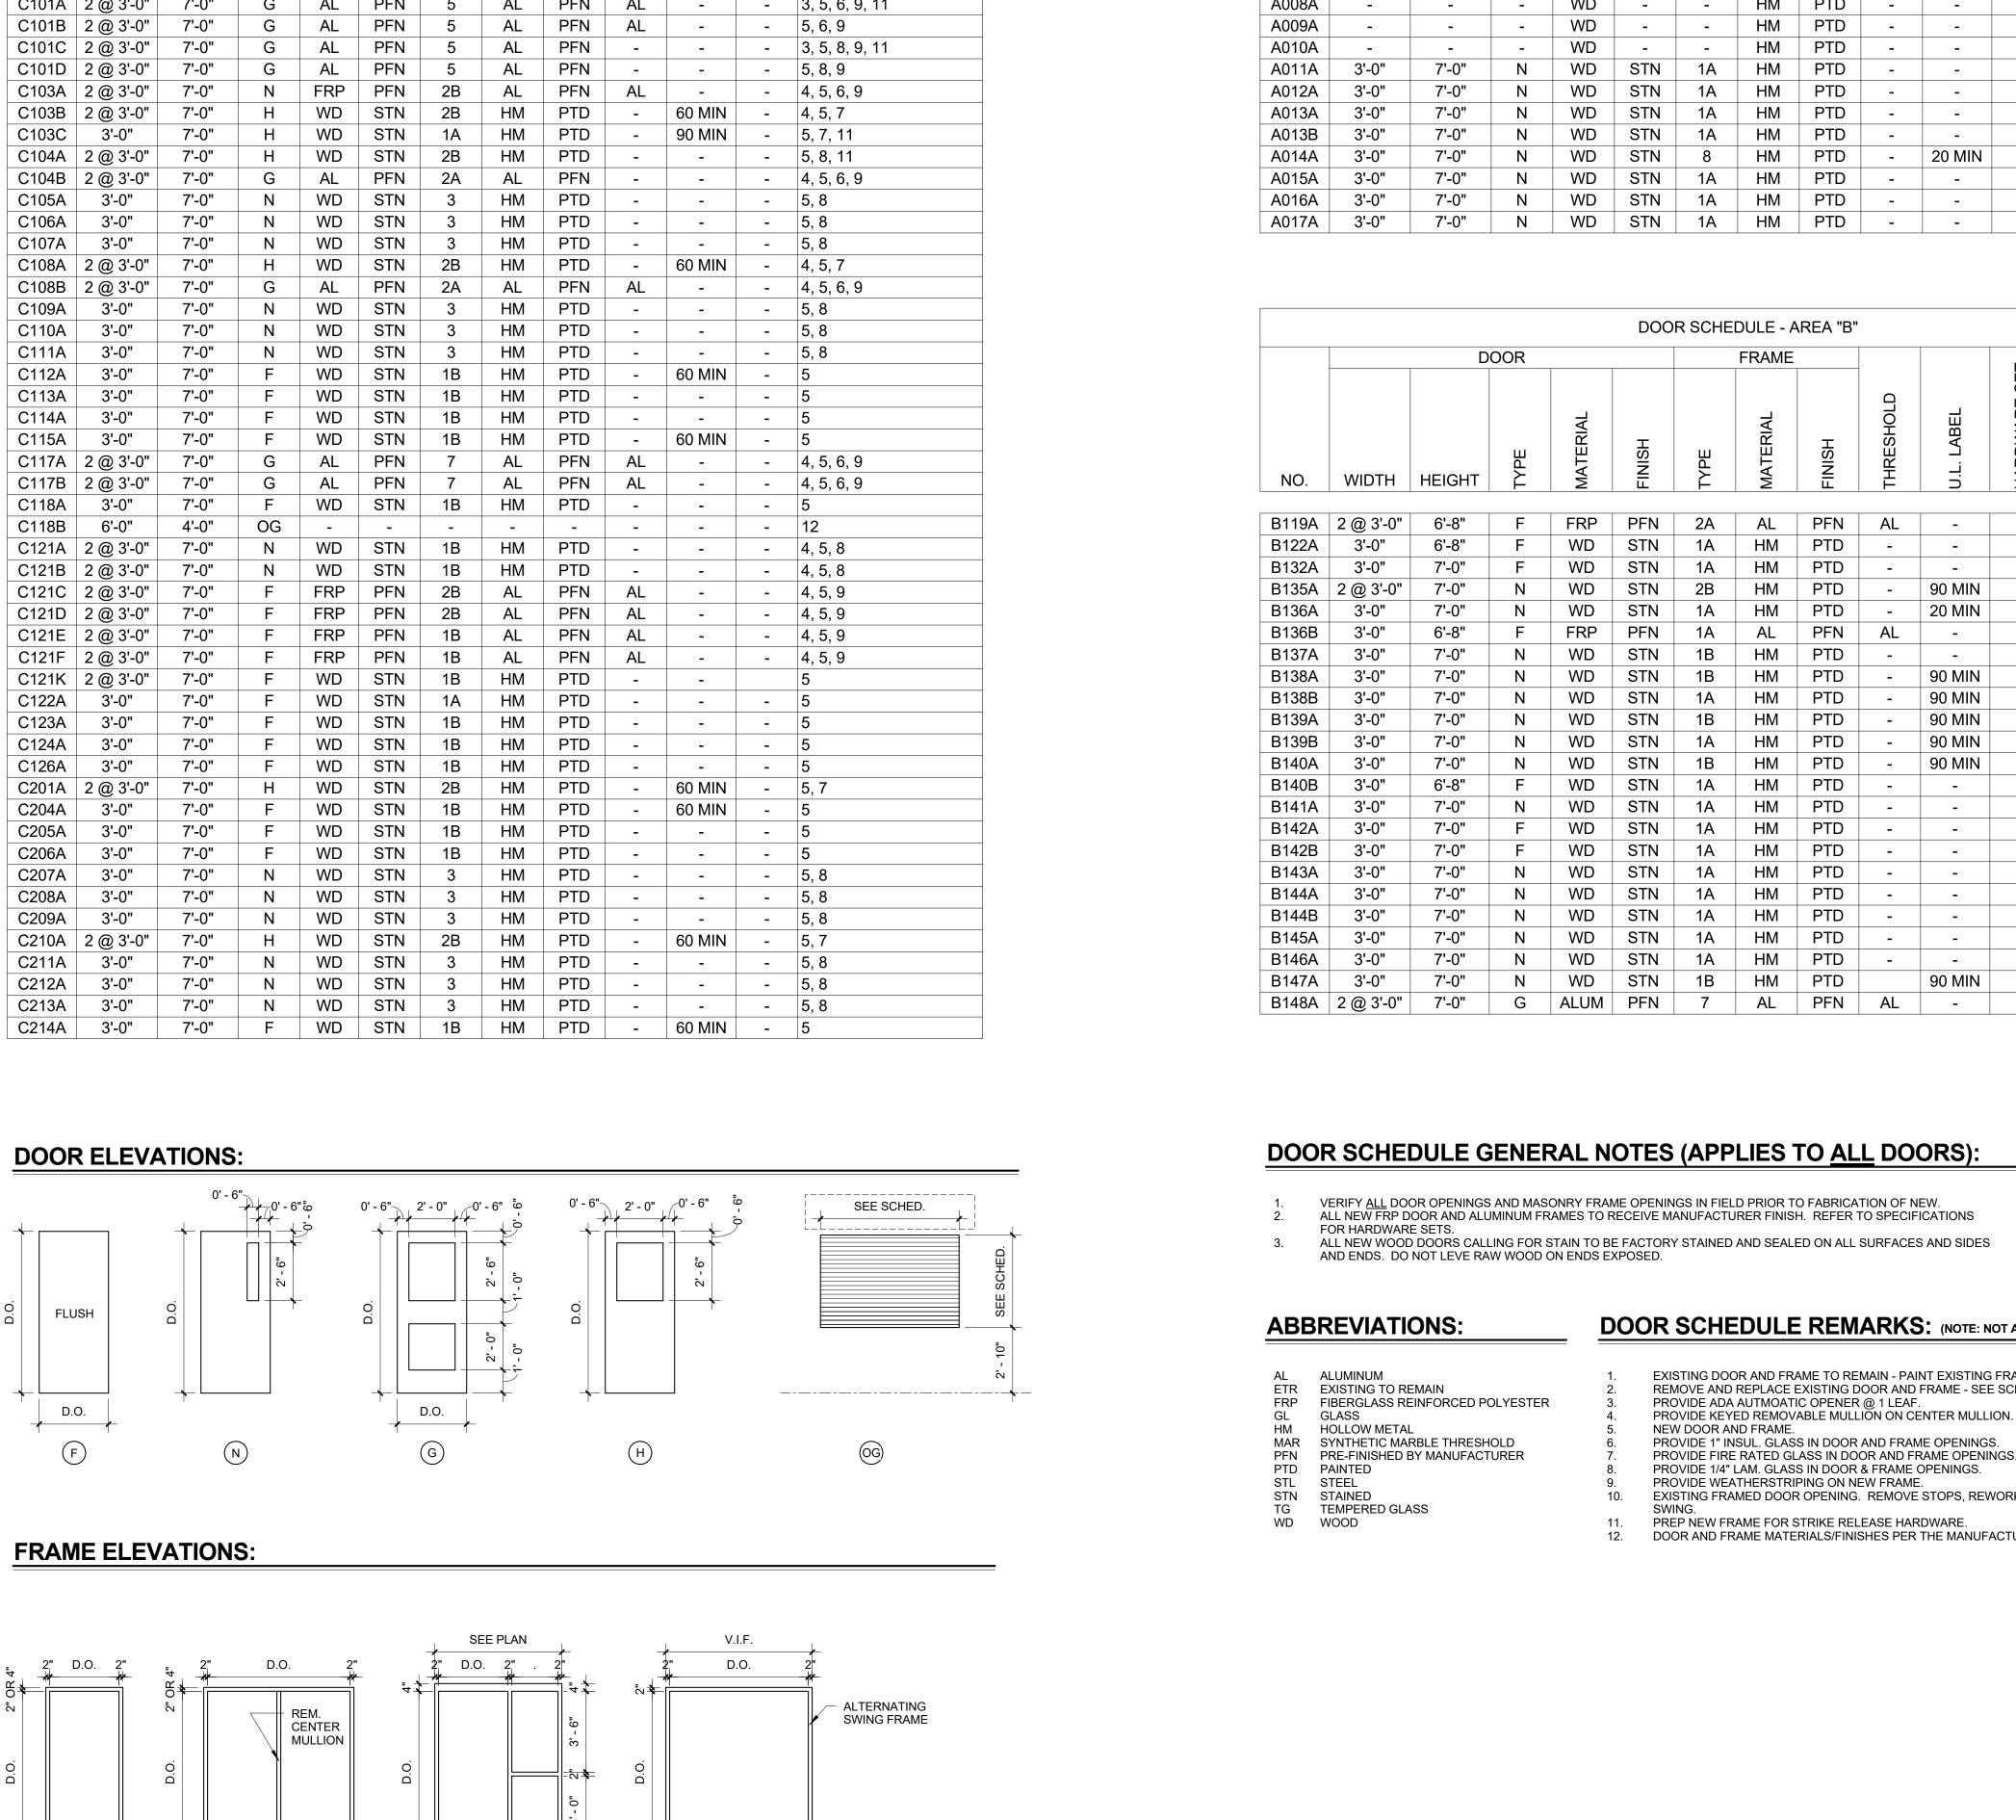

		RO	OM FINISH	SCHEDULE	- 'AREA B'		
					CEIL	ING	
NO.	ROOM NAME	FLOOR	BASE	WALL	MATERIAL	HEIGHT	REMARKS
B100	VESTIBULE	ETR	ETR	ETR	ETR		
B101	STAIR	ETR	ETR	ETR	ETR		
B102	CORRIDOR	ETR	ETR	ETR	ETR		
B103	MEDIA CENTER	ETR	ETR	ETR	ETR		
B104	MC OFFICE	ETR	ETR	ETR	ETR		
B105	CORRIDOR	ETR	ETR	ETR	ETR		
B106	BUSINESS OFFICE	ETR	ETR	ETR	ETR		
B107	B. ADMIN.	ETR	ETR	ETR	ETR		
B108	C. LAB	ETR	ETR	ETR	ETR		
B109	ART	ETR	ETR	ETR	ETR		
B110	PRESCHOOL ROOM	ETR	ETR	ETR	ETR		
B111	PRESCHOOL ROOM	ETR	ETR	ETR	ETR		
B112	PRESCHOOL ROOM	ETR	ETR	ETR	ETR		
B113	PRESCHOOL ROOM	ETR	ETR	ETR	ETR		
B114	TOILET ROOM	ETR	ETR	ETR	ETR		
B115	MECHANICAL ROOM	ETR	ETR	ETR	ETR		
B115A	CLOSET	ETR	ETR	ETR	ETR		
B116	CORRIDOR	ETR	ETR	ETR	ETR		
B117	STAGE	ETR	ETR	ETR	ETR		
B118	CORRIDOR	ETR	ETR	ETR	ETR		
B119	FELLOWSHIP HALL	ETR	ETR	ETR	ETR		7
B121	MUSIC ROOM 'A'	LVT	RB	PT	ACT-1	(V.I.F.)	1, 4, 8
B122	STORAGE	CONC	-	PT	EXP	(*)	4
B123	ELECT. ROOM	CONC	_	PT	EXP		4
B124	OUTDOOR STOR.	CONC	_	-	EXP		4
B125	F.H. STORAGE	CONC	_	_	EXP		4
B126	GIRL'S TOILET	ETR	ETR	ETR	ETR		•
B127	STORAGE	ETR	ETR	ETR	ETR		
B128	STORAGE	ETR	ETR	ETR	ETR		
B129	BOY'S TOILET	ETR	ETR	ETR	ETR		
B130	STORAGE	ETR	ETR	ETR	ETR		
B131	STORAGE	ETR	ETR	ETR	ETR		
B131	PANTRY	ETR	ETR	ETR	ETR		
B132A	TOILET RM	ETR	ETR	ETR	ETR		
B133	TABLES	ETR	ETR	ETR	ETR		
B134	KITCHEN	ETR	ETR	ETR	ETR		
B135	CORRIDOR	LVT	RB	PT	ACT-1	(\/ E\	1 / Q
B136	FITNESS ROOM	LVT	RB	PT	ACT-1	(V.I.F.)	1, 4, 8
B137	STAFF ROOM	LVT	RB	PT	ACT-1		1, 3, 4
B138	LEARNING CENTER	LVT		PT			1, 3, 4
			RB		ACT-1		1, 3, 4
B139	TLC OFFICE	LVT	RB	PT	ACT-1		1, 3, 4
B140	WORK ROOM	LVT	RB	PT	ACT-1		1, 3, 4
B141	CONF. ROOM	CPT	RB	PT	ACT-1		1, 3, 4
B142	FILE ROOM	LVT	RB	PT	ACT-1		1, 3, 4
B143	SICK ROOM	LVT	RB	PT	ACT-1		1, 3, 4
B144	PRINCIPAL	CPT	RB	PT	ACT-1		1, 3, 4
B145	CONF./ OFFICE	CPT	RB	PT	ACT-1		1, 3, 4
B146	PRES. DIR.	CPT	RB	PT	ACT-1		1, 3, 4
B147	SCHOOL OFFICE	CPT	RB	PT	ACT-1		1, 3, 4
B148	CORRIDOR	LVT	RB	PT	ACT-1		1, 3, 4, 12

					OFILI	INIO	
NO.	ROOM NAME	FLOOR	BASE	WALL	CEILI MATERIAL	HEIGHT	REMARKS
C101	VESTIBULE	WC	RB	BR	GB / PT	HEIGHT	3
C101	LOBBY	LVT	RB	PT	ACT-1 / GB /		3
C 102	LODDI	LVI	ועט	1 1	PT		1, 3, 4, 12
C103	STAIR	RTB / LVT	RB	PT	ACT-1		1, 3, 4, 13
C104	CORRIDOR	WC / LVT	RB	PT	ACT-1		1, 3, 4, 10, 11, 12, 1
C105	CLASSROOM	LVT / CPT	RB	PT	ACT-1		1, 3, 4, 10,16
C106	CLASSROOM	LVT / CPT	RB	PT	ACT-1		1, 3, 4, 10,16
C107	CLASSROOM	LVT / CPT	RB	PT	ACT-1		1, 3, 4, 10,16
C108	STAIR	RTB / LVT	RB	PT	ACT-1		1, 3, 4, 13
C109	CLASSROOM	LVT / CPT	RB	PT	ACT-1		1, 3, 4, 10,16
C110	CLASSROOM	LVT / CPT	RB	PT	ACT-1		1, 3, 4, 1
C111	CLASSROOM	LVT / CPT	RB	PT	ACT-1		1, 3, 4, 10
C112	TECH ROOM	CONC	RB	PT	EXP / PT		1, 4
C113	GIRLS TOILET	PCT	PCT	EPT	ACT-2		1, 3, 4, 9, 14
C114	BOYS TOILET	PCT	PCT	EPT	ACT-2		1, 3, 4, 9, 14
C115	JAN. CLOSET	CONC	-	EPT	EXP / PT		1, 4
C116	ELEV.	LVT	-	-	-		,
C117	CORRIDOR	LVT	RB	PT	EXP / PT		1, 4, 12
C118	CONCESSION	LVT	RB	EPT	ACT-2		1, 3, 4
C119	WOMEN'S TOILET	PCT	PCT	EPT	ACT-2		1, 3, 4, 9, 14
C120	MEN'S TOILET	PCT	PCT	EPT	ACT-2		1, 3, 4, 9, 14
C121	GYMNASIUM	WD	VB	PT	EXP / PT		1, 2, 4, 12
C122	OFFICE	CONC	-	PT	ACT-1		1, 3, 4
C123	TRAINING ROOM	CONC	-	PT	ACT-1		1, 3, 4
C124	TEAM ROOM	CONC	-	PT	EXP / PT		1, 4
C125	STORAGE	CONC	-	PT	EXP / PT		1, 4
C126	TEAM ROOM	CONC	-	PT	EXP / PT		1, 4
C201	STAIR	RTB / LVT	RB	PT	ACT-1		1, 3, 4, 13
C202	CORRIDOR	LVT	RB	PT	ACT-1		
C203	ELEV.	LVT	-	-	-		
C204	JAN. CLOSET	CONC	-	EPT	EXP / PT		1, 4
C205	BOYS TOILET	PCT	PCT	EPT	ACT-2		1, 3, 4, 9, 14
C206	GIRLS TOILET	PCT	PCT	EPT	ACT-2		1, 3, 4, 9, 14
C207	CLASSROOM	LVT	RB	PT	ACT-1		1, 3, 4
C208	CLASSROOM	LVT	RB	PT	ACT-1		1, 3, 4
C209	CLASSROOM	LVT	RB	PT	ACT-1		1, 3, 4, 16
C210	STAIR	RTB / LVT	RB	PT	ACT-1		1, 3, 4, 13
C211	CLASSROOM	LVT	RB	PT	ACT-1		1, 3, 4,16
C212	CLASSROOM	LVT	RB	PT	ACT-1		1, 3, 4,16
C213	CLASSROOM	LVT	RB	PT	ACT-1		1, 3, 4,16
C214	TECH RM.	CONC	RB	PT	EXP / PT		1, 4

					CEIL	ING	
NO.	ROOM NAME	FLOOR	BASE	WALL	MATERIAL	HEIGHT	REMARK
						TILIGITI	INLIVIAIN
A001	STAIR	ETR	ETR	ETR	ETR		
A002	LOBBY	ETR	ETR	ETR	ETR		
A003	ELEV.	ETR	ETR	ETR	ETR		
A004	ELEV. EQUIP.	ETR	ETR	ETR	ETR		
A005	CORRIDOR	ETR	ETR / RB	ETR / PT	ETR		5, 6
A006	MEN'S TOILET	ETR	ETR	ETR	ETR		
A007	WOMEN'S TOILET	ETR	ETR	ETR	ETR		
A008	GENERAL OFFICE	LVT	RB	PT	ACT-1	(V.I.F.)	1, 4, 8
A009	OFFICE	LVT	RB	PT	ACT-1	(V.I.F.)	1, 4, 8
A010	OFFICE	LVT	RB	PT	ACT-1		
					-	(V.I.F.)	1, 4, 8
A011	OFFICE	LVT	RB	PT	ACT-1	(V.I.F.)	1, 4, 8
A012	OFFICE	LVT	RB	PT	ACT-1	(V.I.F.)	1, 4, 8
A013	PASTOR OFFICE	LVT	RB	PT	ACT-1	(V.I.F.)	1, 4, 8
A014	CORRIDOR	LVT	RB	PT	ACT-1	(V.I.F.)	1, 4, 8
A015	OFFICE	LVT	RB	PT	ACT-1	(V.I.F.)	1, 4, 8
A016	CONFERENCE ROOM	LVT	RB	PT	ACT-1	(V.I.F.)	1, 4, 8
A017	OFFICE	LVT	RB	PT	ACT-1	(V.I.F.)	1, 4, 8
A018	CORRIDOR	ETR	ETR / RB	ETR / PT	ETR	(v <i>)</i>	5, 6
							J, U
A019	STORAGE	ETR	ETR	ETR	ETR		
A020	STAIR	ETR	ETR	ETR	ETR		
A021	WORK ROOM	ETR	ETR	ETR	ETR		
A022	CLASSROOM	ETR	ETR	ETR	ETR		
A023	CLASSROOM	ETR	ETR	ETR	ETR		
A024	CLASSROOM	ETR	ETR	ETR	ETR		
A025	OFFICE	ETR	ETR	ETR	ETR		
A026	OFFICE	ETR	ETR	ETR	ETR		
A027	MONEY COUNTING		ETR	ETR	ETR		
		ETR					
A028	MECHANICAL	ETR	ETR	ETR	ETR		
A029	STORAGE	ETR	ETR	ETR	ETR		
A030	STAIR	ETR	ETR	ETR	ETR		
A031	CORRIDOR	ETR	ETR	ETR	ETR		
A032	CLASSROOM	ETR	ETR	ETR	ETR		
A033	CLASSROOM	ETR	ETR	ETR	ETR		
A034	CLASSROOM	ETR	ETR	ETR	ETR		
A035	CLASSROOM	ETR	ETR	ETR	ETR		
A036	CLASSROOM	ETR	ETR	ETR	ETR		
A037	STORAGE	ETR	ETR	ETR	ETR		
A038	CORRIDOR	ETR	ETR	ETR	ETR		
A039	STAFF ROOM	ETR	ETR	ETR	ETR		
A100	CORRIDOR	ETR	ETR	ETR	ETR		
A101	STORAGE	ETR	ETR	ETR	ETR		
A102	STAIR	ETR	ETR	ETR	ETR		
A103	STAIR	ETR	ETR	ETR	ETR		
A104	TOILET	ETR	ETR	ETR	ETR		
A105	EXISTING	ETR	ETR	ETR	ETR		
A106	EXISTING	ETR	ETR	ETR	ETR		
A107	WORSHIP SPACE	ETR	ETR	ETR	ETR		
A108	STAIR	ETR	ETR	ETR	ETR		
A109	STAIR	ETR	ETR	ETR	ETR		
A110	CORRIDOR	ETR	ETR	ETR	ETR		
A111	EXISTING	ETR	ETR	ETR	ETR		
A112	NURSERY	ETR	ETR	ETR	ETR		
A113	TOILET	ETR	ETR	ETR	ETR		
A114	MEETING ROOM	ETR	ETR	ETR	ETR		
A115	J.C.	ETR	ETR	ETR	ETR		
A116	BRIDAL ROOM	ETR	ETR	ETR	ETR		
A117	WOMEN'S TOILET	ETR	ETR	ETR	ETR		
A118	MEN'S TOILET	ETR	ETR	ETR	ETR		
A119	CORRIDOR	ETR	ETR	ETR	ETR		
A120	VESTIBULE	ETR	ETR	ETR	ETR		
A120A	ELEV.	ETR	ETR	ETR	ETR		
A121	STAIR	ETR	ETR	ETR	ETR		
A122	EXISTING	ETR	ETR	ETR	ETR		
· · 			· · `		ETR		

ROOM FINISH SCHEDULE ABBREVIATIONS:

FLOOR	<u>S</u>	WALLS	<u>i</u>
CPT ETR LVT PCT RTB WC WD	CARPET EXISTING TO REMAIN LUXURY VINYL TILE PORCELAIN TILE RUBBER TREADS/RISERS WALK-OFF CARPET WOOD ATHLETIC FLOOR	BR EPT ETR PT	BRICK EPOXY PAINT EXISTING TO REMAIN PAINT
WALL ETR PCT RB RTR	EXISTING TO REMAIN 6"H PORCELAIN TILE 4"H RESILIENT COVE BASE RUBBER TREAD & RISERS	ACT-1 ACT-2 ETR EXP GB PT	

ROOM FINISH SCHEDULE REMARKS:

VB VENTED GYM BASE

- PAINT ALL EXPOSED ITEMS IN ROOM: DUCTS, DOOR FRAMES, DOORS, PIPES, CONDUITS, DUCTWORK, ROOF DECK, ROOF FRAMING, ETC. SEE FLOOR PATTERN PLAN FOR WOOD FLOOR STRIPING AND COLORS.
- SEE FLOOK PATTERIN PLAN FOR WOOD FLOOK STRIPING AND COLORS.

 SEE REFLECTED CEILING PLANS FOR HEIGHTS AND SOFFIT DROP LOCATIONS.

 PAINT ALL WALLS AND FRAMES IN ROOM (NEW AND EXISTING).

 PAINT NEW WALL CONSTRUCTION TO MATCH EXISTING U.N.O. (V.I.F.).

 PROVIDE NEW YORK OF THE FAIR COLUMN.
- PAINT NEW SOFFIT / PIPE ENCLOSURE.
 NEW CEILING TO BE INSTALLED AT SAME ELEVATION OF EXISTING CEILING. PROVIDE HOLD DOWN CLIPS ON CEILING TILES IN ENTIRE ROOM.
- SEE FLOOR PLANS FOR MATERIALS / PATTERNS OF FLOOR FINISHES. PROVIDE HOLD DOWN CLIPS ON CEILING TILES WITHIN 20' OF EXTERIOR DOORS (V.I.F.).
 MULTIPLE PAINT COLORS TO BE USED ON WALLS AND/OR CEILINGS, FRAMING, ROOF DECK, ETC. (TBD).
 PROVIDE RUBBER TREADS / RISERS ON STAIRS AND RUBBER FLOORING ON INTERMEDIATE LANDINGS. REFER TO SCHEDULE FOR FINISH AT
- FLOOR LEVEL.
- PROVIDE MARBLE THRESHOLDAT DOOR OPENING.
 ALTERNATE NO. 3 INSTALL CERAMIC TILE FLOOR AND BASE. REFER TO SPEC.
 PROVIDE PULL DOWN BLINDS FOR ALL CLASSROOM WINDOWS. REFER TO SPEC.

ROOM FINISH SCHEDULE GENERAL NOTES (APPLIES TO ALL ROOMS):

PROVIDE METAL TRANSITION STRIPS (SCHLUTER) BETWEEN FLOOR FINISHES - TILE / CARPET, TILE / CONCRETE, ETC. REMOVE / RE-INSTALL EXISTING LAY-IN CEILINGS AS REQ'D FOR OVERHEAD WORK: PIPING, DUCTWORK, ETC.




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ROOM FINISH SCHEDULES PRELIMINARY DESIGN DEVELOPMENT CONSTRUCTION FINAL RECORD DRAWN BY: CHECKED BY: **REVISIONS:** Construction Set 04/25/17

SHEET NO.:



LEGEND:

1 VOLLEYBALL POLE INSERT

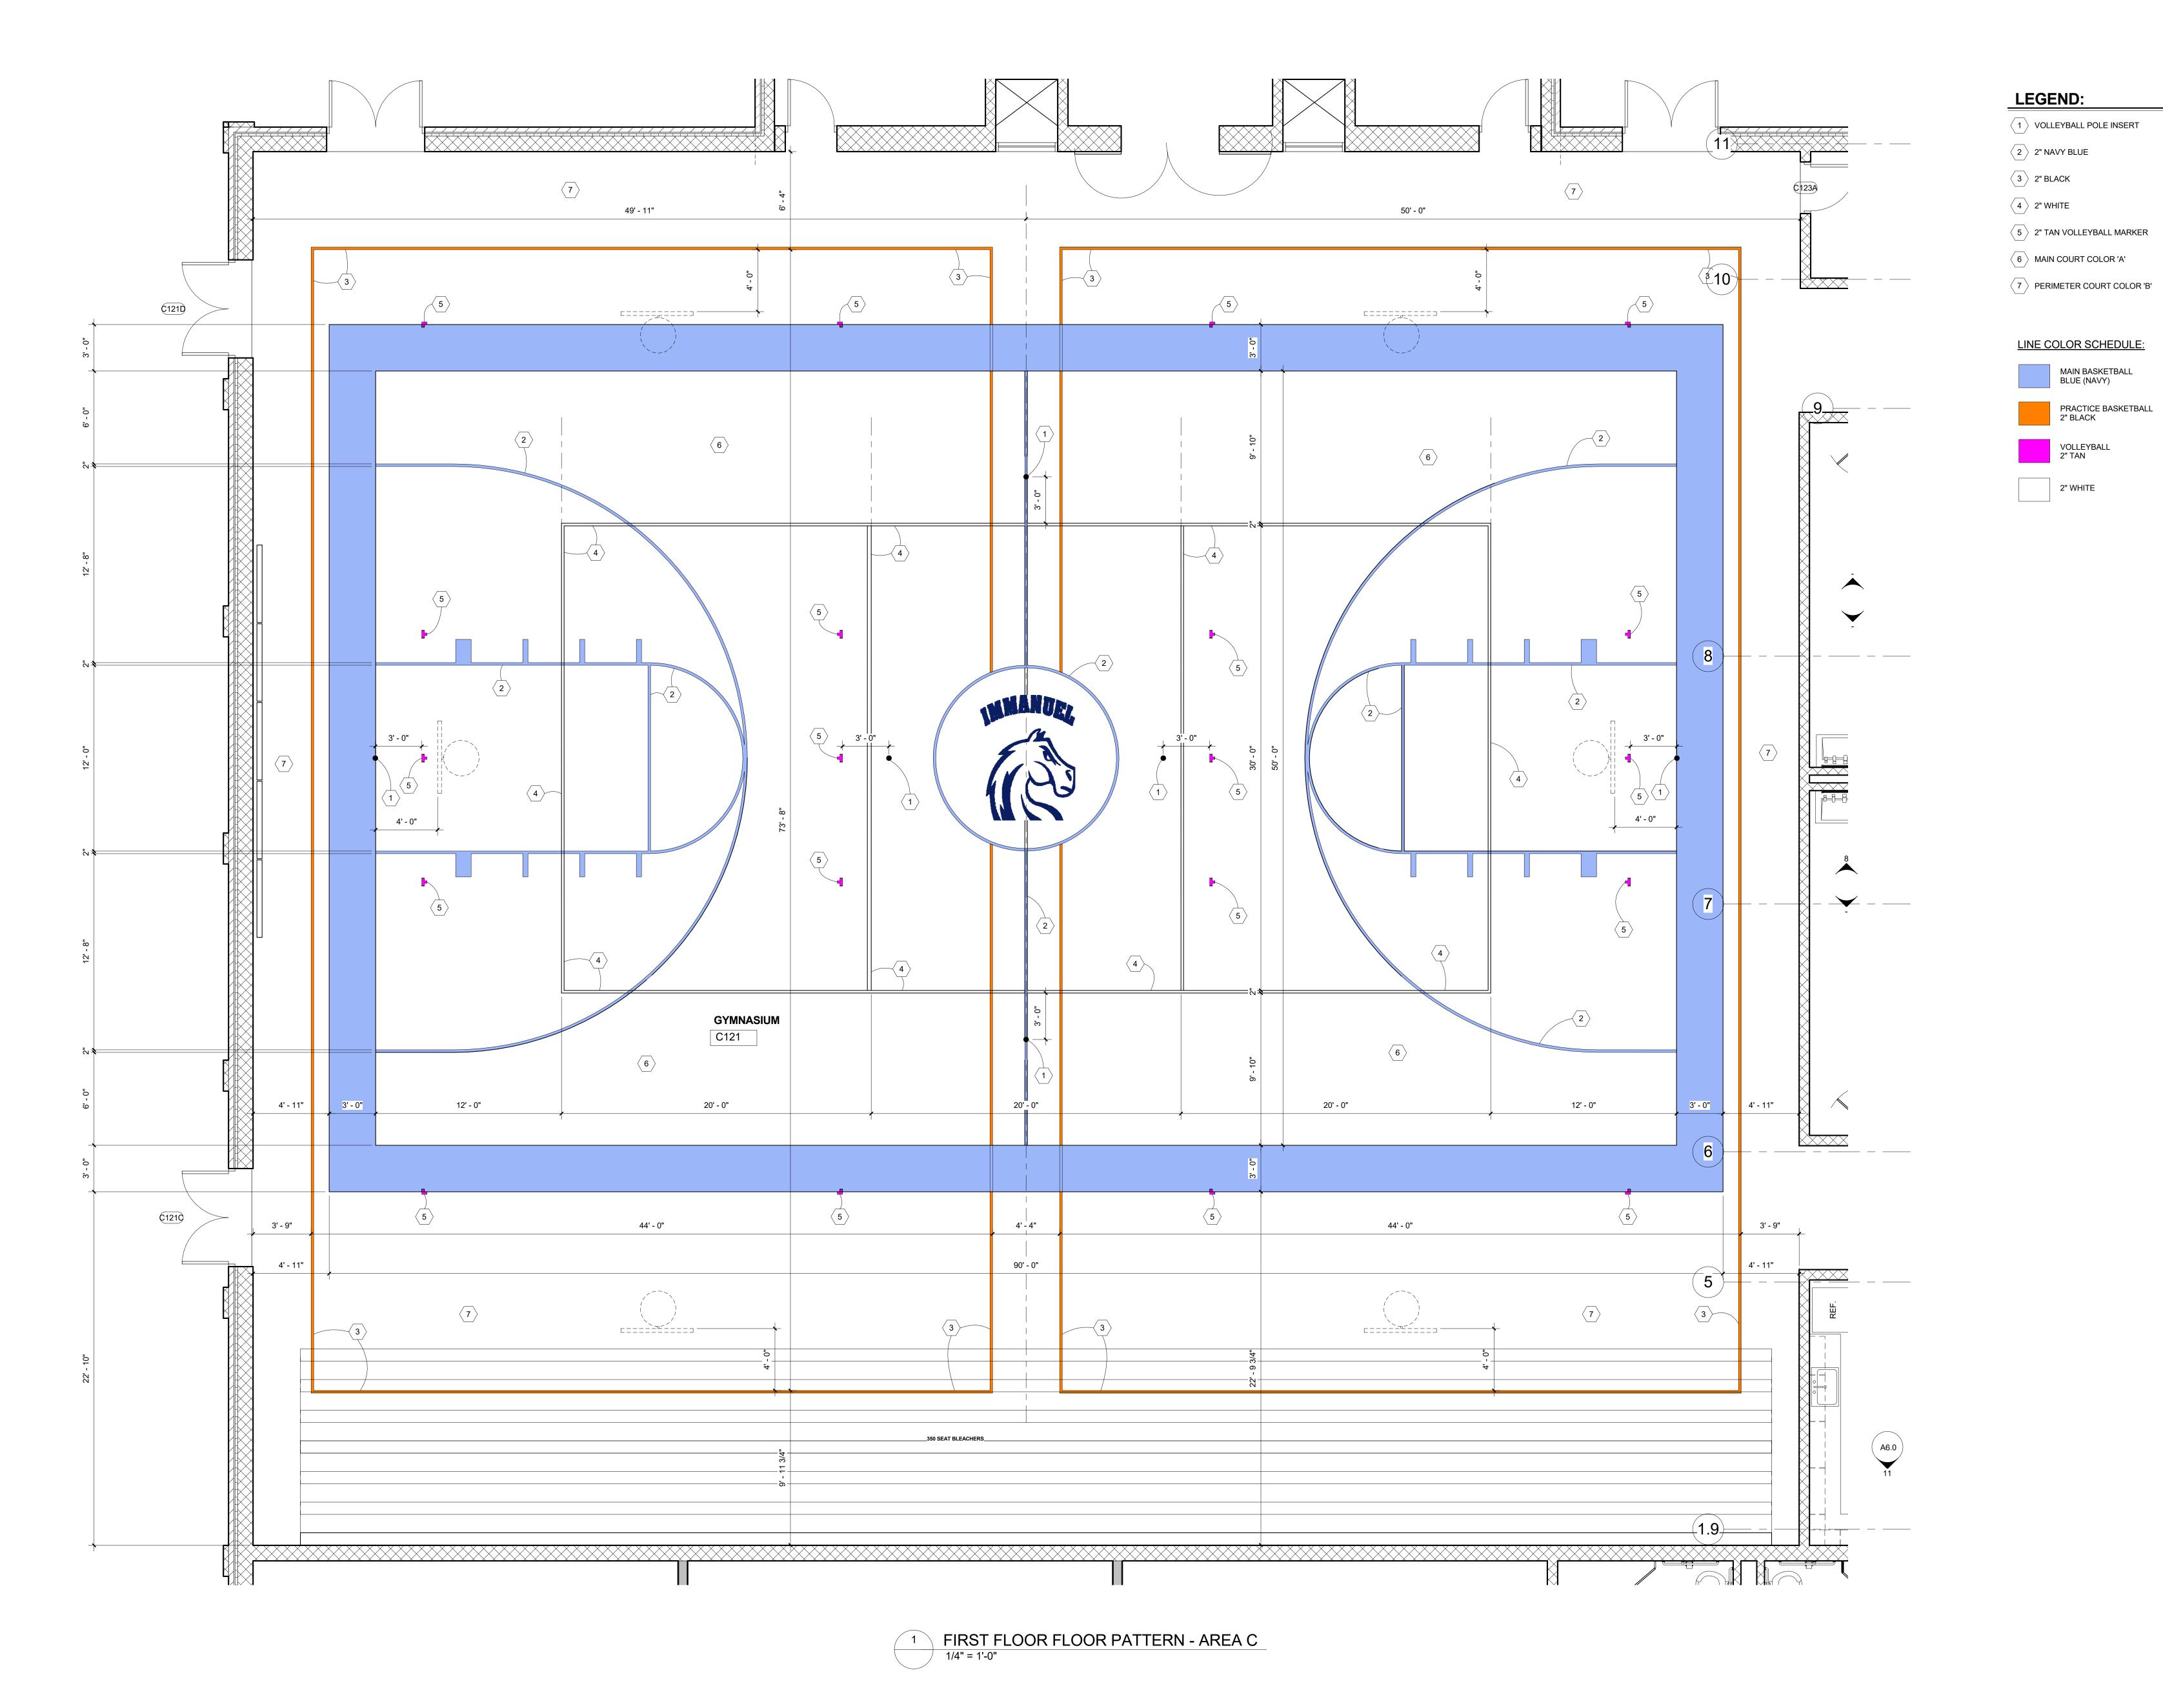2 2" NAVY BLUE

3 2" BLACK

4 2" WHITE

5 2" TAN VOLLEYBALL MARKER

6 MAIN COURT COLOR 'A'

7 PERIMETER COURT COLOR 'B'

MAIN BASKETBALL BLUE (NAVY)

HERAN CHURCH & SCHOOL NASIUM ADDITION

nb, MI 48044

FIRST FLOOR FLOOR PATTERN - AREA 'C'


PRELIMINARY DESIGN DEVELOPMENT CONSTRUCTION FINAL RECORD DRAWN BY: KAN

CHECKED BY:

REVISIONS:

Construction Set
04/25/17

A8.1

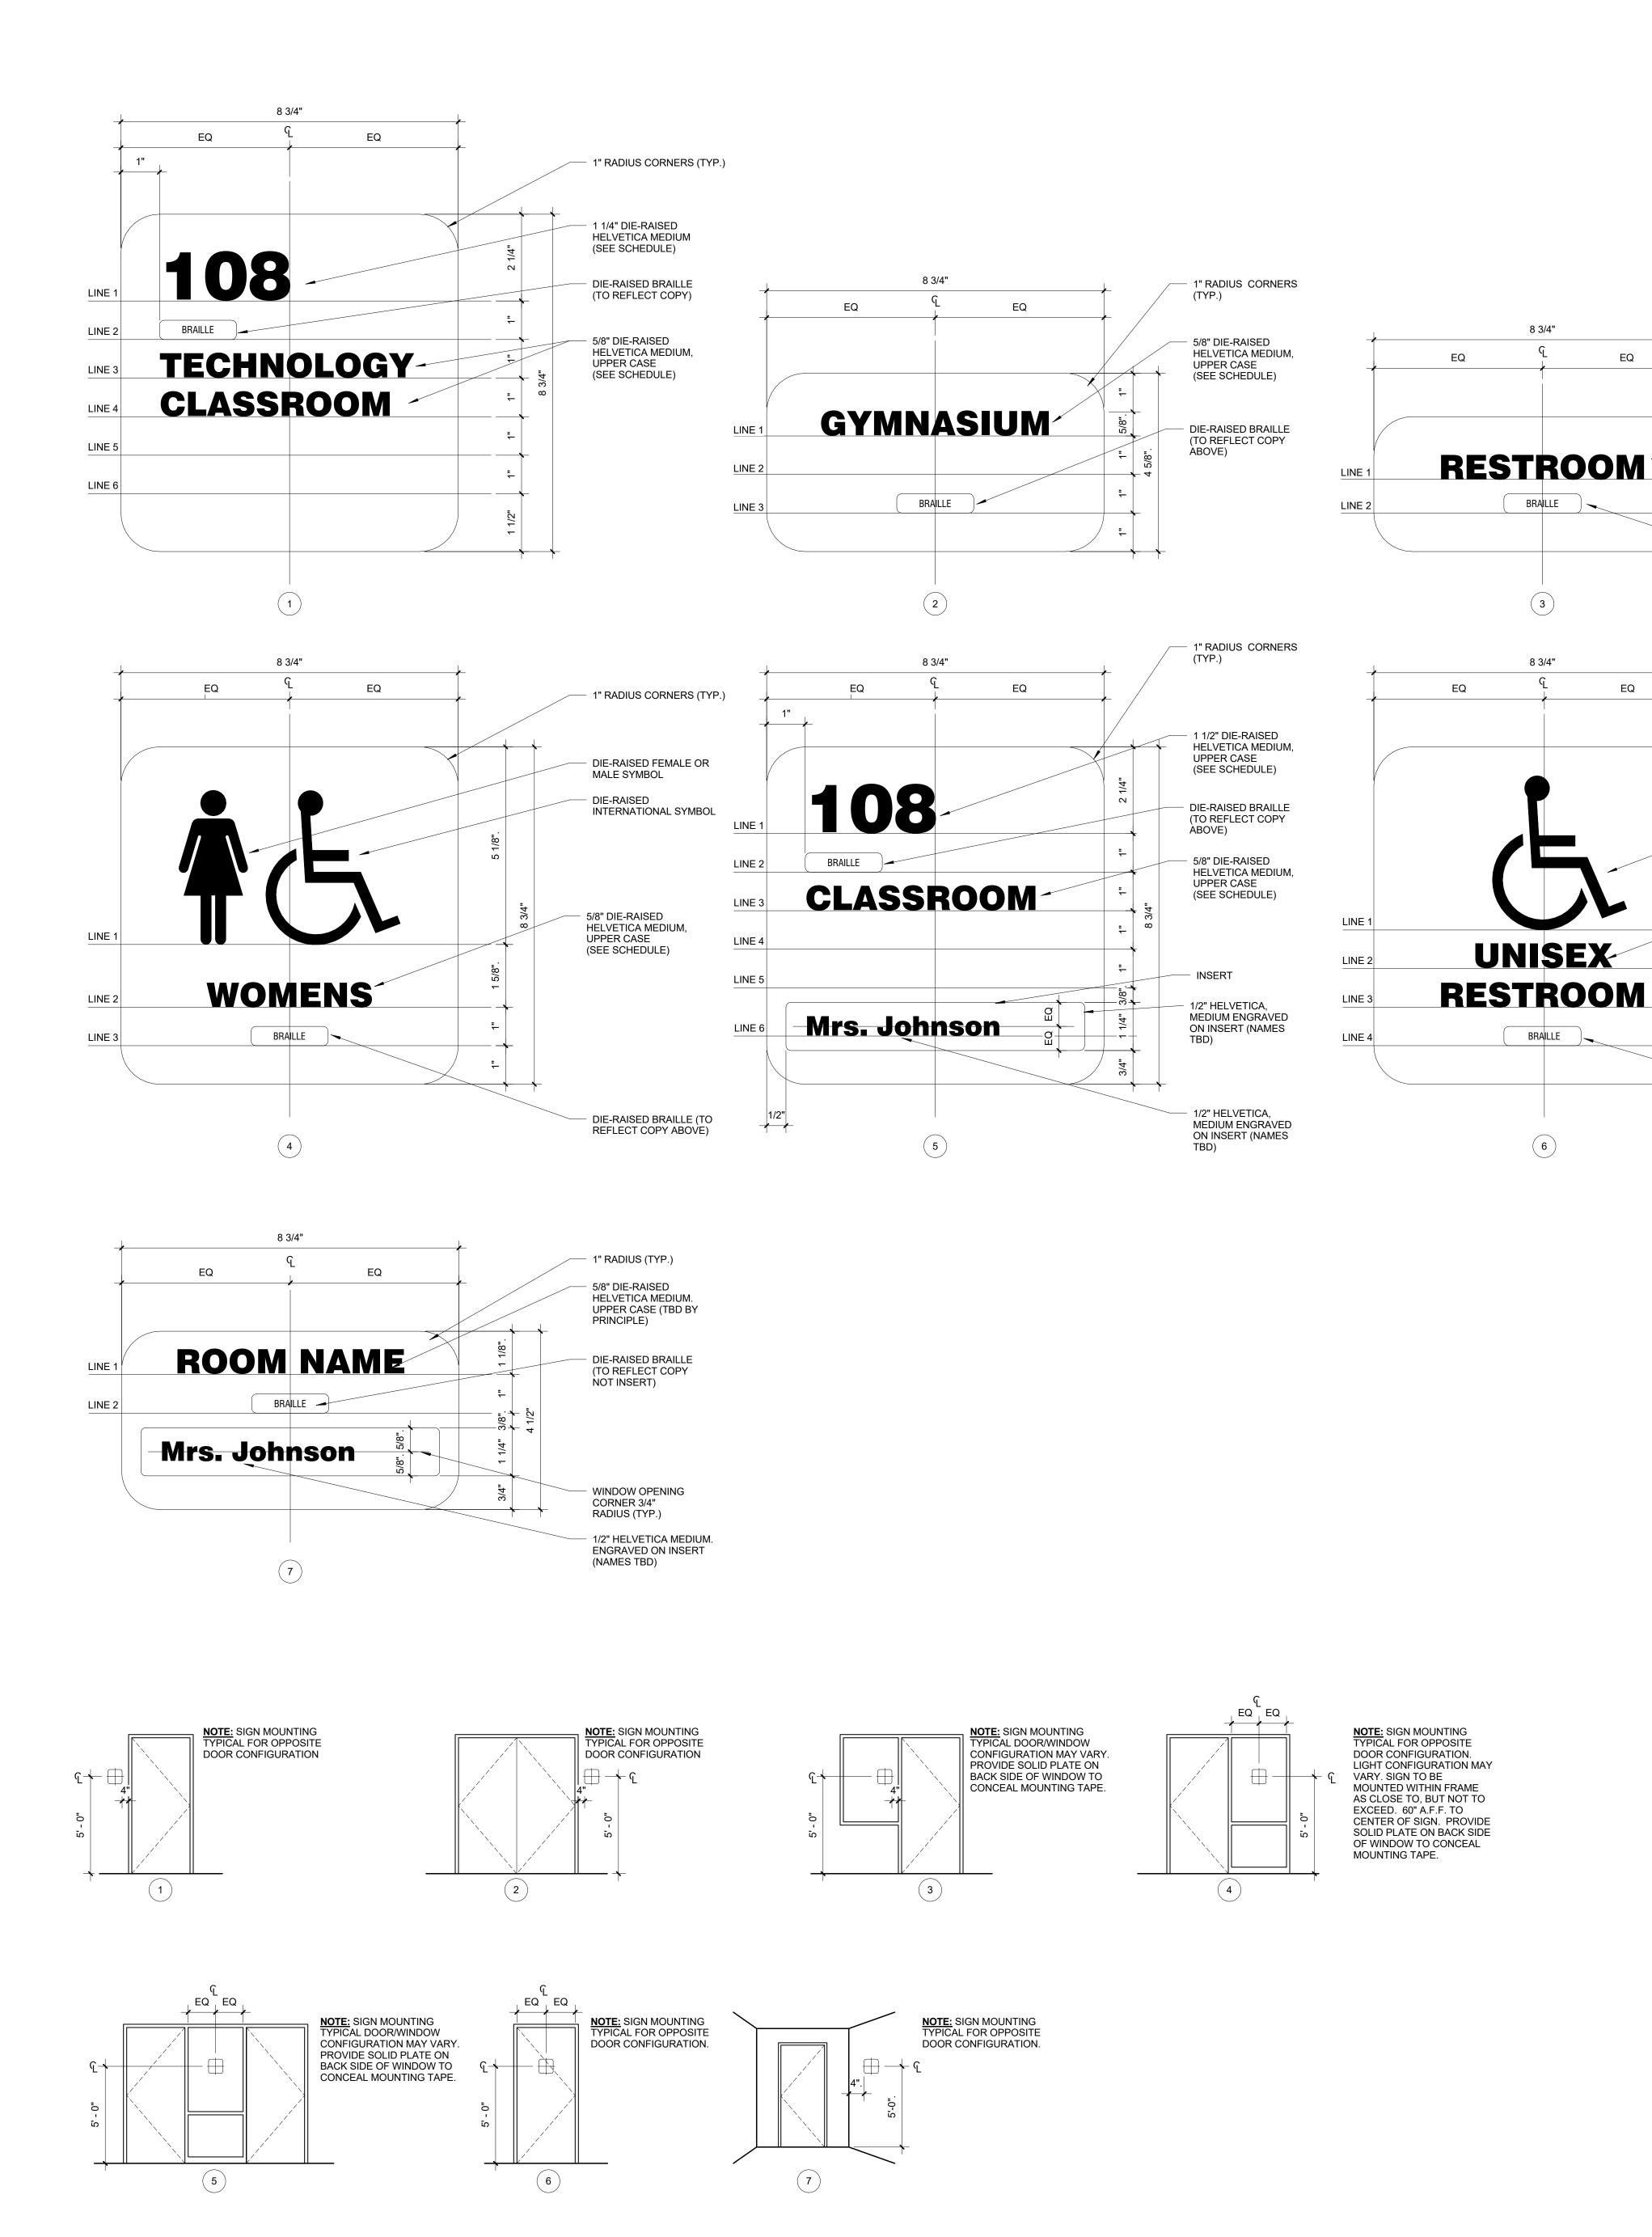

	PLAN	OWNER			
QTY	NO.	NO.	SIGN TYPE	MOUNTING	TEXT
1	A008		2	1	LINE 1: PARISH, LINE 2: OFFIC
1	A009		7		LINE 1: OFFICE
1	A010		7	1	LINE 1: OFFICE
1	A011		7	1	LINE 1: OFFICE
1	A012		7	1	LINE 1: OFFICE
1	A013		7	1	LINE 1: OFFICE
<u>·</u> 1	A014		2	1	LINE 1: PARISH, LINE 2: OFFIC
1	A015		7	1	LINE 1: OFFICE
2	A016		2	1	LINE 1: CONFERENCE, LINE 2: ROOM
4	A047		7	1	
1	A017	1.15.15.4	7	1	LINE 1: OFFICE
1	B121	LINE 1:	5	1	LINE 3: MUSIC, LINE 4: ROOM
1	B122		3	2	LINE 1: STORAGE
1	B125		3	1	LINE 1: STORAGE
	B135				
1	B136		2	1	LINE 1: FITNESS, LINE 2: ROOM
1	B137		2	1	LINE 1: STAFF, LINE 2: ROOM
2	B138	LINE 1:	5	1	LINE 3: LEARNING, LINE 4: CEN
2	B139		7	1	LINE 1: OFFICE
2	B140		2	1	LINE 1: WORK, LINE 2: ROOM
1	B140		2	1	LINE 1: CONFERENCE, LINE 2:
ı	ו 41			'	ROOM
2	B142		2	1	LINE 1: FILE, LINE 2: ROOM
			2	1	•
1	B143			1	LINE 1:SICK, LINE 2: ROOM
1	B144		7	1	LINE 1: PRINCIPAL
1	B145		7	1	LINE 1: OFFICE
1	B146		7	1	LINE 1: PS DIRECTOR
2	B147		2	1	LINE 1: SCHOOL, LINE 2: OFFIC
	B148				
1	C103		3	1	LINE 1: STAIRS
	C104				
1	C105	LINE 1:	5	4	LINE 3:CLASSROOM
1	C106	LINE 1:	5	4	LINE 3:CLASSROOM
1			5		LINE 3:CLASSROOM
-	C107	LINE 1:		4	
1	C108		3	1	LINE 1:STAIRS
1	C109	LINE 1:	5	4	LINE 3:CLASSROOM
1	C110	LINE 1:	5	4	LINE 3: CLASSROOM
1	C111	LINE 1:	5	4	LINE 3: CLASSROOM
1	C112		2	1	LINE 1: TECHNOLOGY, LINE 2:
					CLOSET
1	C113		4	1	LINE 2: GIRLS
1	C114		4	1	LINE 2: BOYS
1	C115		3	1	LINE 1: CUSTODIAL
2	C116		3	1	LINE 1: ELEVATOR
1	C118		3	1	LINE 1: CONCESSIONS
1	C118		_	1	LINE 2: WOMEN
			4	-	
1	C120		4	1	LINE 2: MEN
2	C121		3	7	LINE 3: GYMNASIUM
1	C122		3	1	LINE 1: OFFICE
1	C123		2	1	LINE 1: TRAINING, LINE 2: ROO
1	C124		2	1	LINE 1: TEAM, LINE 2: ROOM
1	C125		2	1	LINE 1: GYMNASIUM, LINE 2:
					STORAGE
1	C126		2	1	LINE 1: TEAM, LINE 2: ROOM
1	C201		3	1	LINE 1: STAIRS
•	C203			•	
1	C204		3	1	LINE 1: CUSTODIAL
1	C204		4	1	LINE 2: BOYS
-				-	
1	C206		4	1	LINE 2: GIRLS
1	C207	LINE 1:	5	4	LINE 3: CLASSROOM
1	C208	LINE 1:	5	4	LINE 3: CLASSROOM
1	C209	LINE 1:	5	4	LINE 3: CLASSROOM
1	C210		3	1	LINE 1: STAIRS
1	C211	LINE 1:	5	4	LINE 3:CLASSROOM
1	C212	LINE 1:	5	4	LINE 3:CLASSROOM
1	C213	LINE 1:	5	4	LINE 3:CLASSROOM
1	C214	1	2	1	LINE 1: TECHNOLOGY, LINE 2:

1" RADIUS CORNERS

5/8" DIE-RAISED HELVETICA MEDIUM,

UPPER CASE (SEE SCHEDULE)

DIE-RAISED BRAILLE (TO REFLECT COPY ABOVE)

1" RADIUS CORNERS

DIE-RAISED

SYMBOL

INTERNATIONAL

5/8" DIE-RAISED HELVETICA MEDIUM,

UPPER CASE (SEE SCHEDULE)

DIE-RAISED BRAILLE (TO REFLECT COPY ABOVE)

EQ

EQ



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SIGNAGE DETAIL

PRELIMINARY DESIGN DEVELOPMENT CONSTRUCTION

FINAL RECORD DRAWN BY: CHECKED BY:

REVISIONS: Construction Set

SHEET NO.: