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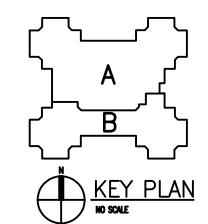
REGISTRATION SEAL

CONSULTANT

Allen Elementary Remodel

Southgate Community Schools Southgate, Michigan

DRAWING TITLE
First Level
Composite Floor Plan



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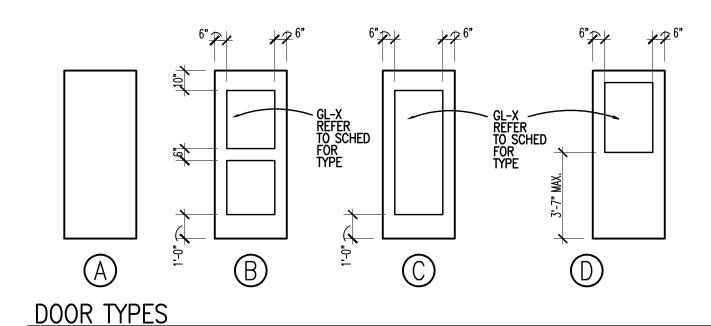
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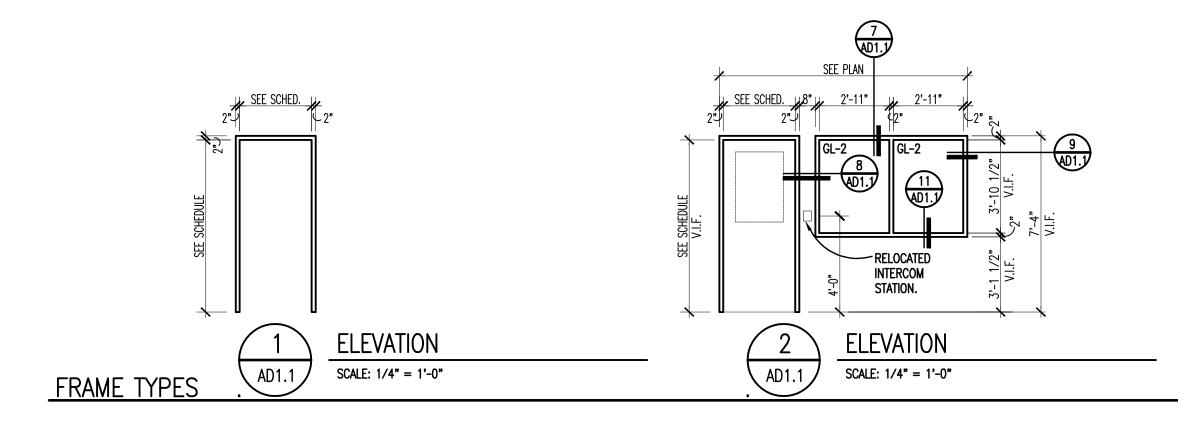
PROJECT NO.


16009

DRAWING NO. AC1.1

	DOOR &	F	R/	\M	E	S	CHI	ED	UL	E						
Ope	ning	D	oor			F	ram	е		Details				 	્રા	Remarks
No.	Opening Size (Width x Height)	Type	Material	Finish	Glass	Туре	Material	Finish	Glass	Head	Jamb	≣. I	Threshold	U.L. Label	Hdwe. Set	
Low	er Level - Zo	ne	'A'													
A100A	EXISTING	С	EX. AL	EX.	•	EX.	EX. H.M.	EX.	•	-	-	-	•	•	•	•
A100B	EXISTING	С	EX. AL	EX.		EX.	EX. H.M.	EX.	•	-	-	-	•	•	•	•
A100C	3'-0"x 7'-2"	В	H.M.	PTD		3/AD11	H.M.	PTD	•	5/AD1.1	6,10/AD1.1	-	•	•	•	•
A100D	3'-0"x 7'-2"	В	H.M.	PTD		3/AD11	H.M.	PTD	•	5/AD1.1	6, 10/AD1.1	-	•	•	•	•
A151A	EXISTING	Α	EX. WD	EX.		EX.	EX. H.M.	EX.		-	-	-	•	•		
A151B	EXISTING	Α	EX. WD	EX.		EX.	EX. H.M.	EX.		-	-	-	•			
A155A	3'-0"x 7'-2"	D	WD	PFN		1/AD11	H.M.	PTD		7/AD1.1	8,10/AD1.1	11/AD1.1	•	45		(2)
A155B	3'-0"x 7'-2"	D	WD	PFN		2/AD11	H.M.	PTD	•	7/AD1.1	8,10/AD1.1	11/AD1.1		45	•	•





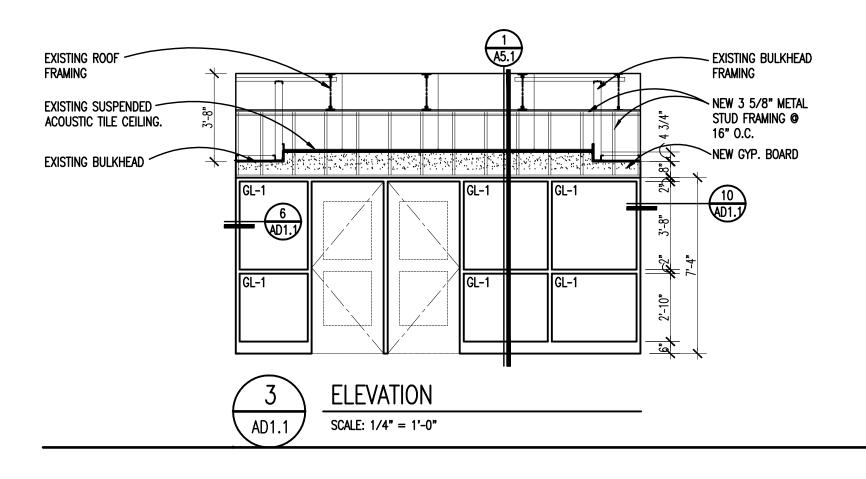

DOOR SCHEDULE ABBREVIATIONS AND NOTES

(REFER TO SPECIFICATIONS FOR ADDITIONAL DOOR INFORMATION)

DOOR SCHEDULE ABBREVIATIONS ALUMINUM ALUMINUM AND GLASS HOLLOW METAL

SOLID CORE HARDWOOD PREFINISHED BY MANUFACTURER PAINTED SYNTHETIC MARBLE THRESHOLD METAL THRESHOLD PLASTIC LAMINATE CLAD FRP STSTL STAINLESS STEEL

1. GALVANIZED METAL TO BE PROVIDED FOR HOLLOW METAL DOOR AND/OR FRAME AT EXTERIOR LOCATION. 2. DOORS ARE 1-3/4" THICK UNLESS OTHERWISE NOTED. 3. DETAIL NUMBERS NOTED SIM. REFER TO DETAILS SHOWING HEAD,

SIMILAR TO THOSE NOTED. 4. HOLLOW METAL FRAMES SET IN MASONRY WALLS ARE 5 3/4" WIDE (U.O.N.). FIBERGLASS REINFORCED POLYESTER STEEL

> 6. AN ASTERISK (*) CALLS ATTENTION TO THE REMARKS COLUMN OF THE SCHEDULE.

NOTES - REMARKS COLUMN 1. INSTALL SALVAGED ELECTRIC STRIKE 2. CONNECT STRIKE TO FIRE ALARM SYSTEM

DOOR SCHEDULE GENERAL NOTES

JAMB, AND/ OR SILL DETAILS THAT REPRESENT CONDITIONS

5. HOLLOW METAL FRAMES, SET IN GYPSUM BD. /METAL STUD PARTITIONS, SHALL BE "DOUBLE BACK-BEND" FRAMES WITH A THROAT DIMENSION EQUAL TO THE PARTITION THICKNESS PLUS 9/16" RETURNS ON EACH SIDE OF THE PARTITION. PROVIDE EQUAL RABBETS.

GLAZING TYPES

U.L. DOOR LABEL DESIGNATIONS:

U.L. LABEL** MIN. OPENING PROTECTION ASSEMBLY

1-1/2 HR. FIRE RATING

3 HR. FIRE RATING

1 HR. FIRE RATING

3/4 HR. FIRE RATING

1/3 HR. FIRE RATING

** ALL FIRE RATED DOORS SHALL BE SMOKE AND DRAFT

— HOLLOW METAL FRAME

— 16 GAUGE GALVANIZED 8" X 2" BRAKE FORMED ANGLE CLOSURE FULL

HEIGHT OF DOOR OPENING, AT BOTH

JAMBS AND HEAD, PAINTED AND MECHANICALLY FASTENED TO MASONRY SUBSTRATE AT 16" O.C.

-CONT. SEALANT. AND BACKER ROD

EXISTING DOUBLE WYTHE GLAZED FACE

AD.1

AD.1

BOTH SIDES OF FRAME

- EXISTING FOAM INSULATION

-HOLLOW METAL FRAME

OPENING, TYPICAL

BULLNOSE CONCRETE MASONRY UNIT AT EXPOSED CORNER OF MASONRY

CONT. SEALANT. AND BACKER ROD BOTH SIDES OF FRAME

-NEW CMU INFILL TOOTHED IN AT SOUTH

GROUT CORE SOLID AT JAMB ANCHOR

SEALANT AT JOINT BETWEEN DOOR
FRAME AND MASONRY, TYPICAL BOTH
SIDES AROUND PERIMETER OF

DOOR FRAME JAMB ANCHOR, MINIMUM OF THREE EMBEDDED IN MASONRY

LINE OF RUBBER BASE (WHERE OCCURRING) BELOW, ON BOTH SIDES OF WALL, SHOWN DASHED

BULLNOSE CONCRETE MASONRY UNIT AT EXPOSED CORNER OF MASONRY OPENING, TYPICAL

HOLLOW METAL SIDE LIGHT

WALL CONSTRUCTION

OPENING

HOLLOW METAL SILL DETAIL

HOLLOW METAL SILL DETAIL

HOLLOW METAL DOOR FRAME JAMB

MASONRY OPENING

SEALANT AT JOINT BETWEEN DOOR
FRAME AND MASONRY, TYPICAL BOTH
SIDES AROUND PERIMETER OF

OPENING

--- HOLLOW METAL DOOR FRAME

LINE OF FRAME AND WALL ABOVE

DOOR FRAME EXSPANSION ANCHOR, MINIMUM OF THREE EMBEDDED IN MASONRY WALL CONSTRUCTION

- BULLNOSE CONCRETE MASONRY UNIT AT EXPOSED CORNER OF MASONRY

LINE OF RUBBER BASE (WHERE OCCURRING) BELOW, ON BOTH SIDES

OF WALL, SHOWN DASHED

OPENING, TYPICAL

SCALE: $1 \frac{1}{2} = 1'-0"$

SCALE: 1 1/2" = 1'-0"

SCALE: 1 1/2" = 1'-0"

7 5/8"

AD.1

AD.1

CONTROL LABELED IN ADDITION TO U.L. LABELS INDICATED.

(REFER TO SPECIFICATIONS FOR ASSEMBLIES) GL-1 1/4" CLEAR TEMPERED MONOLITHIC GLASS GL-2 45 MIN. FIRE RATED CLEAR GLASS

—HOLLOW METAL WINDOW UNIT

SEALANT AT JOINT BETWEEN HOLLOW METAL FRAME AND MASONRY, TYPICAL BOTH SIDES AROUND PERIMETER OF

—GROUT CORE SOLID AT JAMB ANCHOR

—OUTLINE OF INTERCOM CALL STATION

OCCURRING) BELOW, ON BOTH SIDES

BULLNOSE CONCRETE MASONRY UNIT AT EXPOSED CORNER OF MASONRY OPENING, TYPICAL

- DOOR FRAME JAMB ANCHOR, MINIMUM OF THREE EMBEDDED IN MASONRY

- EXISTING CONCRETE UNIT MASONRY

- EXISTING STEEL LINTEL ABOVE

- SEALANT CONTINUOUS AT PERIMETER BOTH SIDES OF DOOR FRAME

SEALANT AT JOINT BETWEEN DOOR FRAME AND MASONRY, TYPICAL BOTH

SIDES AROUND PERIMETER OF

EXISTING CMU WALL CONSTRUCTION

-EXPANSION ANCHOR

- HOLLOW METAL FRAME

ENTIRE OPENING

HOLLOW METAL FRAME

WALL CONSTRUCTION (TYP.)

HOLLOW METAL DOOR FRAME JAMB

HOLLOW METAL FRAME HEAD

SCALE: 1 1/2" = 1'-0"

SCALE: 1 1/2" = 1'-0"

7 5/8"

LINE OF RUBBER BASE (WHERE

OF WALL, SHOWN DASHED

AND BACK BOX.



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REGISTRATION SEAL

CONSULTANT


PROJECT TITLE

Allen Elementary Remodel

Southgate Community Schools Southgate, Michigan

DRAWING TITLE

Door & Frame Schedule

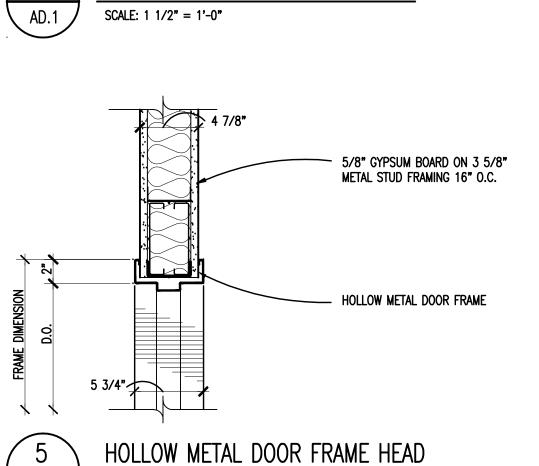


HOLLOW METAL FRAME JAMB

HOLLOW METAL DOOR FRAME JAMB

SCALE: 1 1/2" = 1'-0"


AD.1 SCALE: 1 1/2" = 1'-0"

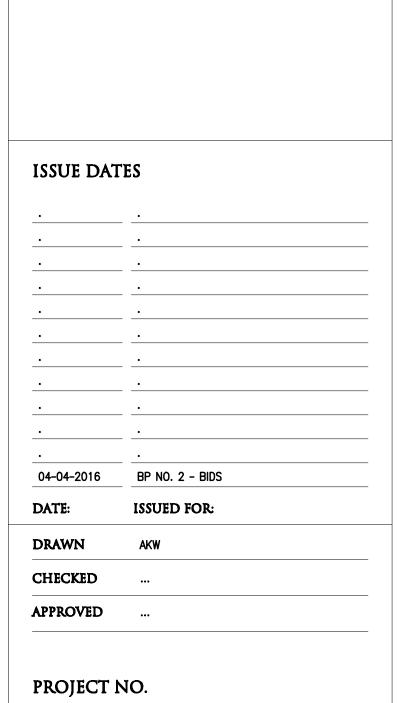

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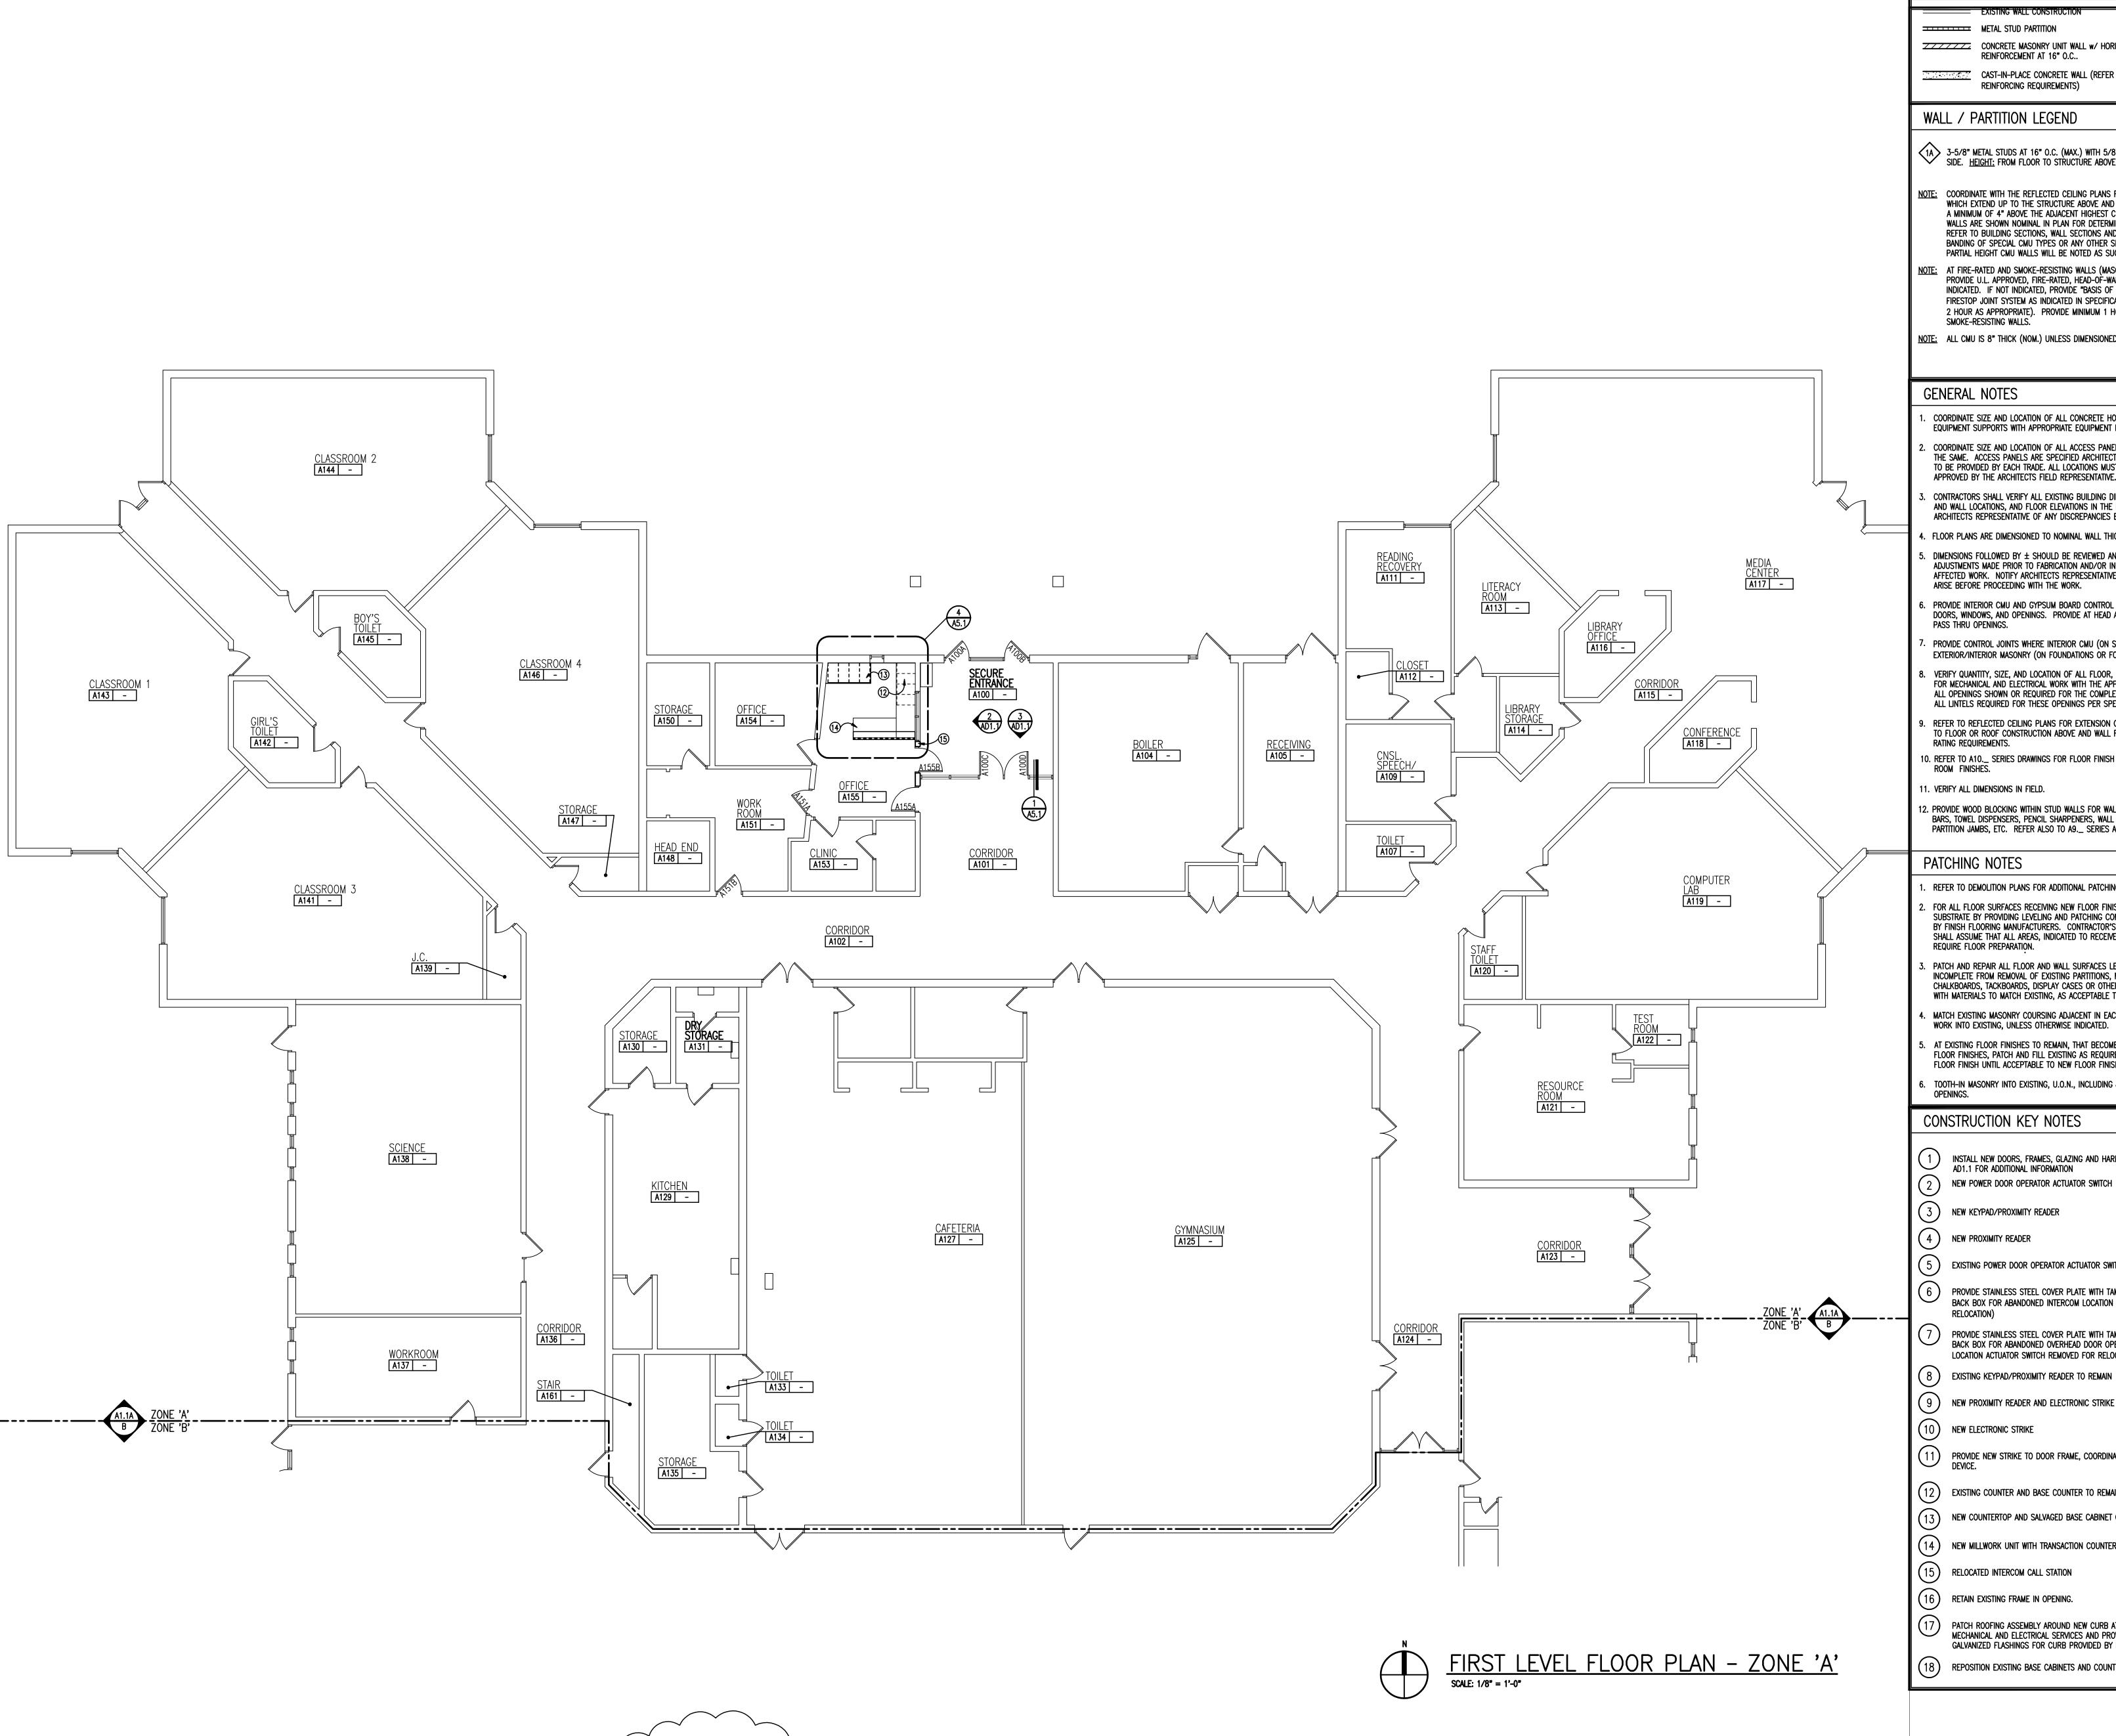
AD1.1



GENERAL NOTES

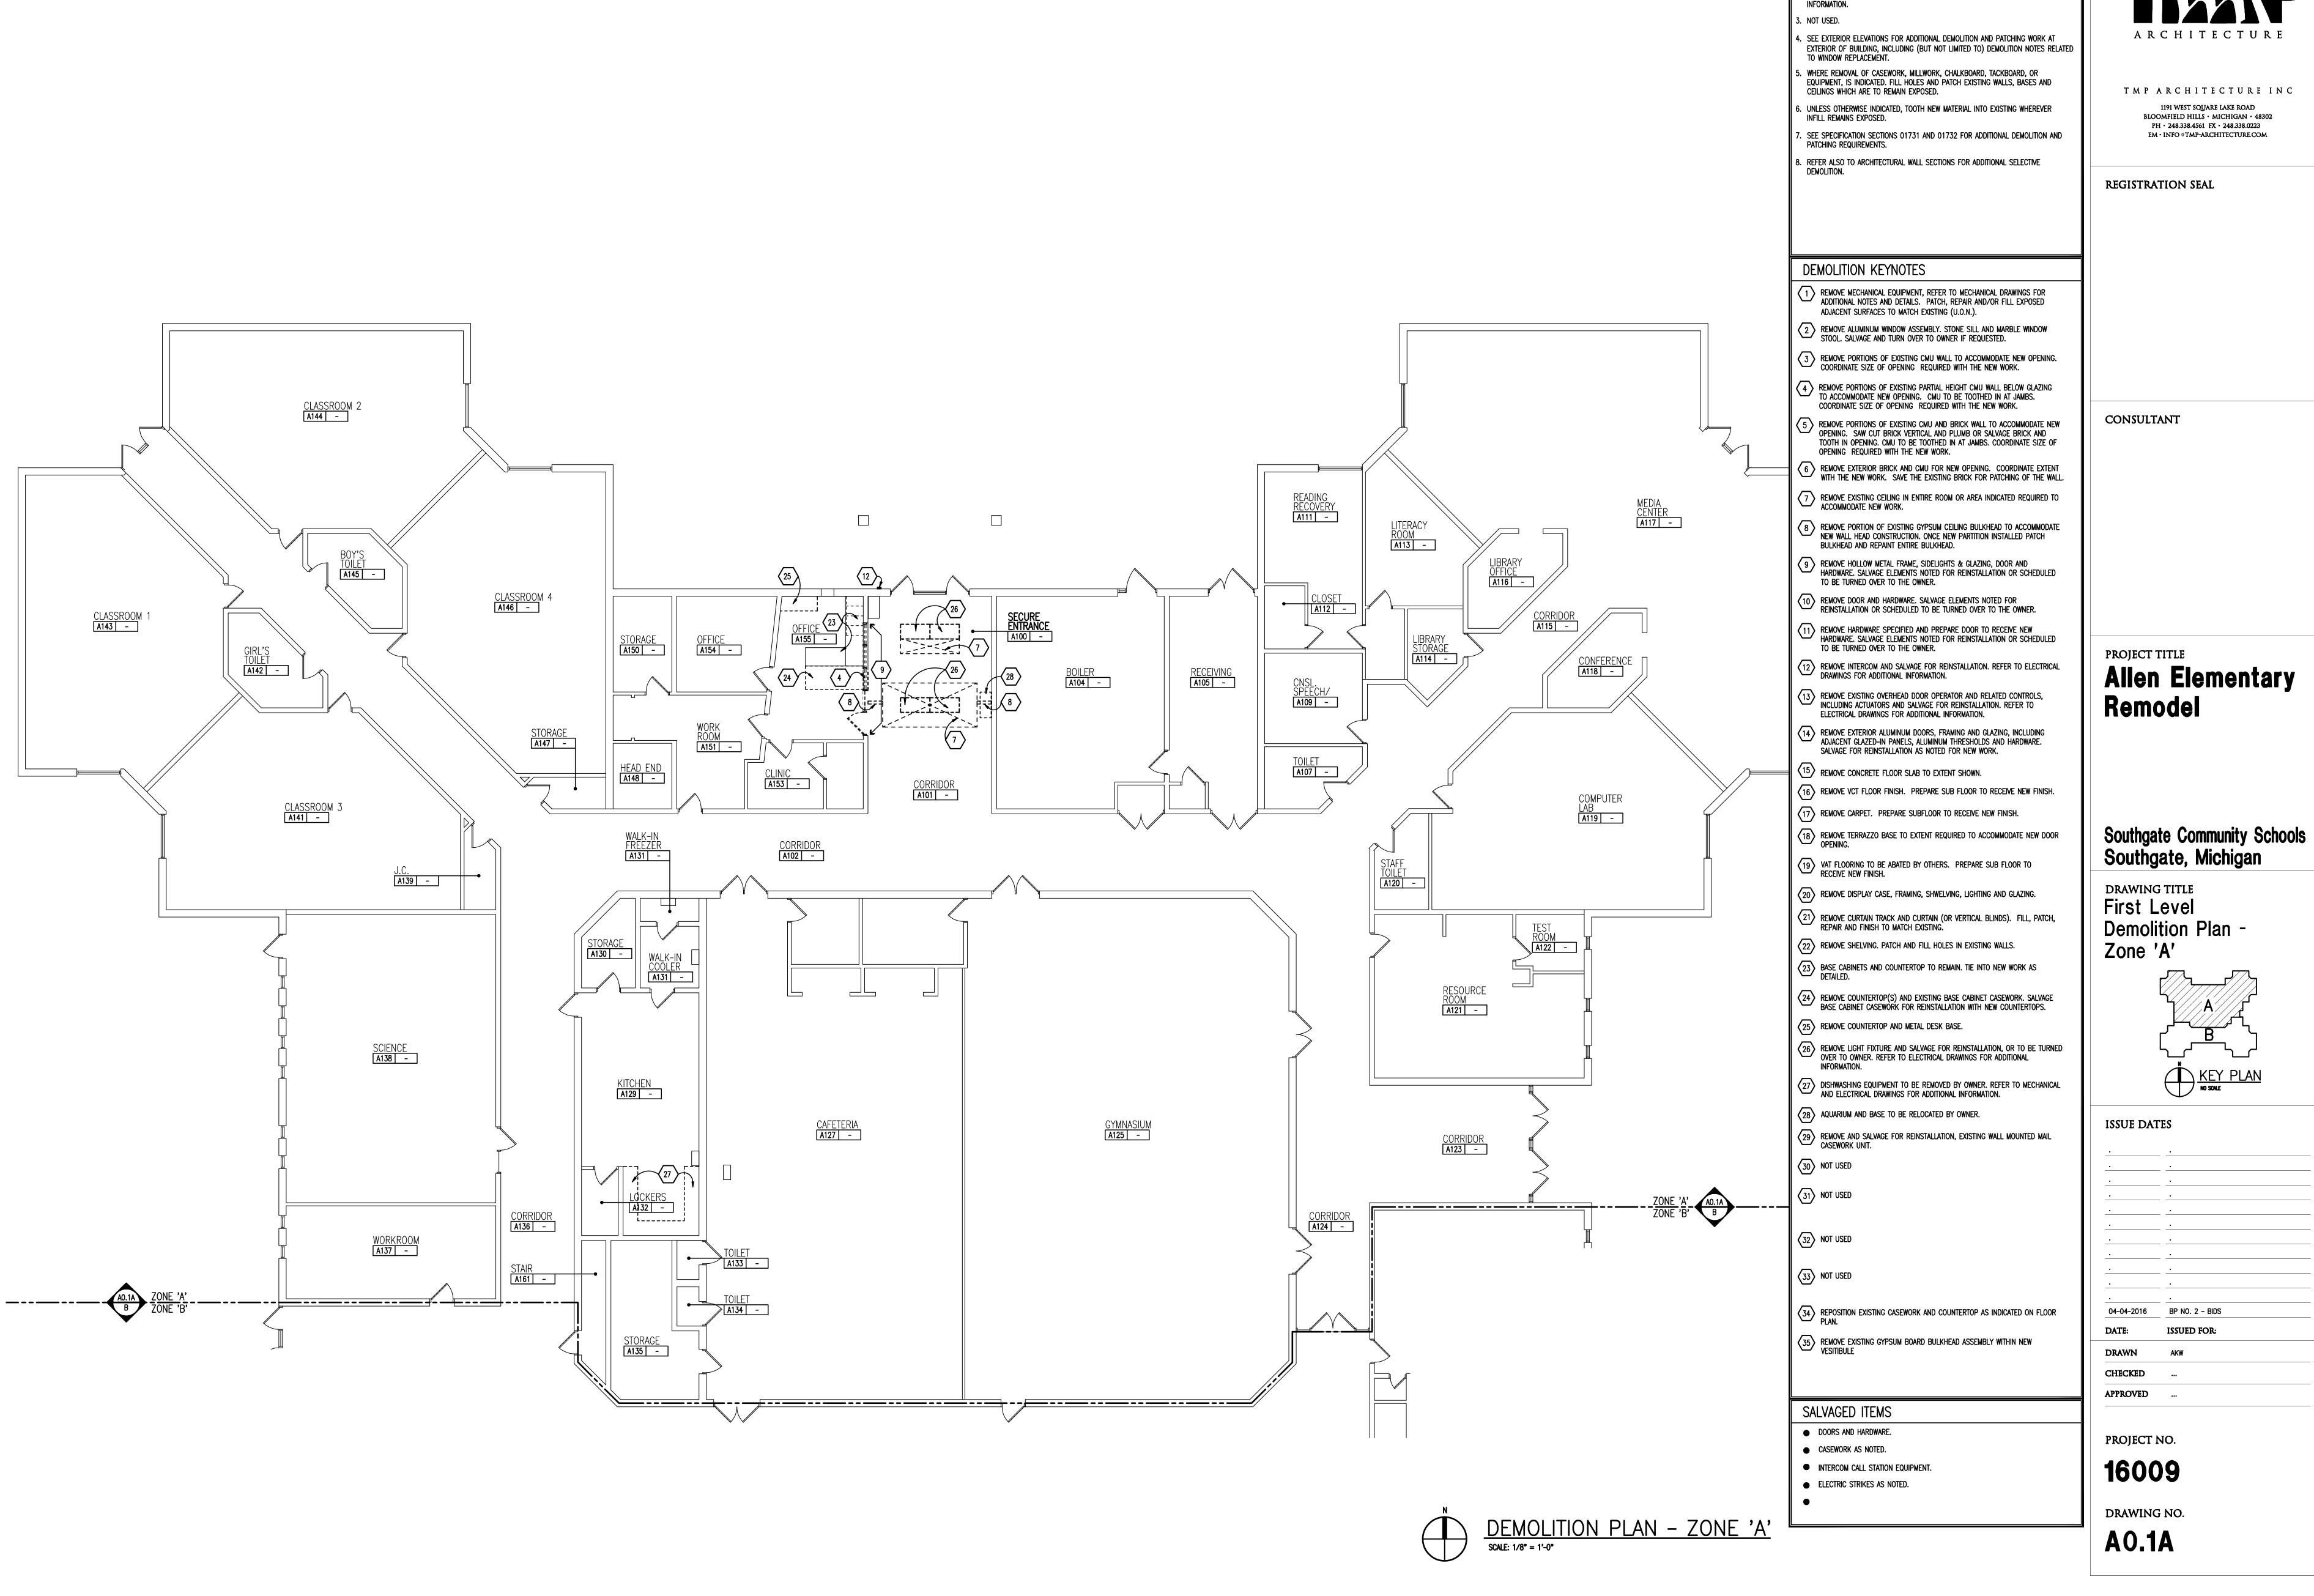. REFER TO MECHANICAL AND ELECTRICAL DRAWINGS FOR RELATED AND ADDITIONAL DEMOLITION AND PATCHING WORK BY MECHANICAL AND ELECTRICAL TRADES.

REFER TO FOOD SERVICE EQUIPMENT (FSE) DRAWINGS FOR ADDITIONAL



WALL / PARTITION KEY

METAL STUD PARTITION

CONCRETE MASONRY UNIT WALL w/ HORIZONTAL JOINT REINFORCEMENT AT 16" O.C..

CAST-IN-PLACE CONCRETE WALL (REFER TO STRUCTURAL FOR REINFORCING REQUIREMENTS)

WALL / PARTITION LEGEND

3-5/8" METAL STUDS AT 16" O.C. (MAX.) WITH 5/8" GYPSUM BOARD EACH SIDE. <u>HEIGHT:</u> FROM FLOOR TO STRUCTURE ABOVE.

NOTE: COORDINATE WITH THE REFLECTED CEILING PLANS FOR RATED WALLS. WALLS WHICH EXTEND UP TO THE STRUCTURE ABOVE AND WALLS WHICH EXTEND ONLY A MINIMUM OF 4" ABOVE THE ADJACENT HIGHEST CEILING. DIMENSIONS OF WALLS ARE SHOWN NOMINAL IN PLAN FOR DETERMINING THE CMU THICKNESS. REFER TO BUILDING SECTIONS, WALL SECTIONS AND INTERIOR ELEVATIONS FOR BANDING OF SPECIAL CMU TYPES OR ANY OTHER SPECIAL CONDITIONS. PARTIAL HEIGHT CMU WALLS WILL BE NOTED AS SUCH ON THE FLOOR PLANS.

NOTE: AT FIRE-RATED AND SMOKE-RESISTING WALLS (MASONRY OR GYPSUM BOARD), PROVIDE U.L. APPROVED, FIRE-RATED, HEAD-OF-WALL TERMINATIONS AS INDICATED. IF NOT INDICATED, PROVIDE "BASIS OF DESIGN", HEAD-OF-WALL FIRESTOP JOINT SYSTEM AS INDICATED IN SPECIFICATION SECTION 07842 (1 OR 2 HOUR AS APPROPRIATE). PROVIDE MINIMUM 1 HOUR TERMINATION AT SMOKE-RESISTING WALLS.

NOTE: ALL CMU IS 8" THICK (NOM.) UNLESS DIMENSIONED OTHERWISE.

GENERAL NOTES

COORDINATE SIZE AND LOCATION OF ALL CONCRETE HOUSEKEEPING PADS AND/OR EQUIPMENT SUPPORTS WITH APPROPRIATE EQUIPMENT MANUFACTURER.

COORDINATE SIZE AND LOCATION OF ALL ACCESS PANELS WITH TRADE REQUIRING THE SAME. ACCESS PANELS ARE SPECIFIED ARCHITECTURALLY BUT ARE REQUIRED TO BE PROVIDED BY EACH TRADE. ALL LOCATIONS MUST BE COORDINATED AND APPROVED BY THE ARCHITECTS FIELD REPRESENTATIVE.

CONTRACTORS SHALL VERIFY ALL EXISTING BUILDING DIMENSIONS, PARTITION AND WALL LOCATIONS, AND FLOOR ELEVATIONS IN THE FIELD AND NOTIFY THE ARCHITECTS REPRESENTATIVE OF ANY DISCREPANCIES BEFORE START OF WORK.

4. FLOOR PLANS ARE DIMENSIONED TO NOMINAL WALL THICKNESS - TYPICAL.

. DIMENSIONS FOLLOWED BY \pm SHOULD BE REVIEWED AND ALL NECESSARY ADJUSTMENTS MADE PRIOR TO FABRICATION AND/OR INSTALLATION OF AFFECTED WORK. NOTIFY ARCHITECTS REPRESENTATIVE IF DISCREPANCIES ARISE BEFORE PROCEEDING WITH THE WORK.

PROVIDE INTERIOR CMU AND GYPSUM BOARD CONTROL JOINTS AT BOTH JAMBS OF DOORS, WINDOWS, AND OPENINGS. PROVIDE AT HEAD AND SILL OF WINDOWS AND Pass thru openings.

PROVIDE CONTROL JOINTS WHERE INTERIOR CMU (ON SLAB) ABUTS EXTERIOR/INTERIOR MASONRY (ON FOUNDATIONS OR FOOTINGS)

VERIFY QUANTITY, SIZE, AND LOCATION OF ALL FLOOR, ROOF, AND WALL OPENINGS FOR MECHANICAL AND ELECTRICAL WORK WITH THE APPROPRIATE TRADE. PROVIDE ALL OPENINGS SHOWN OR REQUIRED FOR THE COMPLETION OF THE WORK. PROVIDE ALL LINTELS REQUIRED FOR THESE OPENINGS PER SPECIFICATIONS.

REFER TO REFLECTED CEILING PLANS FOR EXTENSION OF PARTITION WALLS TO FLOOR OR ROOF CONSTRUCTION ABOVE AND WALL FIRE RESISTANCE RATING REQUIREMENTS.

10. REFER TO A10._ SERIES DRAWINGS FOR FLOOR FINISH PATTERNS AND ROOM FINISHES.

11. VERIFY ALL DIMENSIONS IN FIELD.

2. PROVIDE WOOD BLOCKING WITHIN STUD WALLS FOR WALL MOUNTED ITEMS i.e. GRAB BARS, TOWEL DISPENSERS, PENCIL SHARPENERS, WALL STOPS, ACCORDIAN PARTITION JAMBS, ETC. REFER ALSO TO A9._ SERIES AND A6._ SERIES DRAWINGS.

PATCHING NOTES

. REFER TO DEMOLITION PLANS FOR ADDITIONAL PATCHING NOTES.

E. FOR ALL FLOOR SURFACES RECEIVING NEW FLOOR FINISHES, PREPARE SUBSTRATE BY PROVIDING LEVELING AND PATCHING COMPOUNDS RECOMMENDED BY FINISH FLOORING MANUFACTURERS. CONTRACTOR'S BASE BID PROPOSAL SHALL ASSUME THAT ALL AREAS, INDICATED TO RECEIVE NEW FINISHES, WILL REQUIRE FLOOR PREPARATION.

PATCH AND REPAIR ALL FLOOR AND WALL SURFACES LEFT DAMAGED OR INCOMPLETE FROM REMOVAL OF EXISTING PARTITIONS, MILLWORK, CASEWORK, CHALKBOARDS, TACKBOARDS, DISPLAY CASES OR OTHER FIXED EQUIPMENT WITH MATERIAL'S TO MATCH EXISTING, AS ACCEPTABLE TO THE ARCHITECT.

MATCH EXISTING MASONRY COURSING ADJACENT IN EACH AREA AND TOOTH NEW WORK INTO EXISTING, UNLESS OTHERWISE INDICATED.

AT EXISTING FLOOR FINISHES TO REMAIN, THAT BECOME SUBSTRATES FOR NEW FLOOR FINISHES, PATCH AND FILL EXISTING AS REQUIRED TO PREPARE FOR NEW FLOOR FINISH UNTIL ACCEPTABLE TO NEW FLOOR FINISH CONTRACTOR.

TOOTH-IN MASONRY INTO EXISTING, U.O.N., INCLUDING JAMBS OF DOOR AND OTHER

CONSTRUCTION KEY NOTES

INSTALL NEW DOORS, FRAMES, GLAZING AND HARDWARE. REFER TO DRAWING AD1.1 FOR ADDITIONAL INFORMATION 2 NEW POWER DOOR OPERATOR ACTUATOR SWITCH

NEW KEYPAD/PROXIMITY READER

4 NEW PROXIMITY READER

EXISTING POWER DOOR OPERATOR ACTUATOR SWITCH TO REMAIN

PROVIDE STAINLESS STEEL COVER PLATE WITH TAMPER PROOF SCREWS TO BACK BOX FOR ABANDONED INTERCOM LOCATION (INTERCOM REMOVED FOR

PROVIDE STAINLESS STEEL COVER PLATE WITH TAMPER PROOF SCREWS TO BACK BOX FOR ABANDONED OVERHEAD DOOR OPERATOR ACTUATOR SWITCH LOCATION ACTUATOR SWITCH REMOVED FOR RELOCATION)

EXISTING KEYPAD/PROXIMITY READER TO REMAIN

10) NEW ELECTRONIC STRIKE

(11) PROVIDE NEW STRIKE TO DOOR FRAME, COORDINATED WITH EXISTING EXIT

EXISTING COUNTER AND BASE COUNTER TO REMAIN.

(13) NEW COUNTERTOP AND SALVAGED BASE CABINET CASEWORK.

(14) NEW MILLWORK UNIT WITH TRANSACTION COUNTER.

15) RELOCATED INTERCOM CALL STATION

(16) RETAIN EXISTING FRAME IN OPENING.

PATCH ROOFING ASSEMBLY AROUND NEW CURB AT PENETRATIONS FOR MECHANICAL AND ELECTRICAL SERVICES AND PROVIDE MEMBRANE AND GALVANIZED FLASHINGS FOR CURB PROVIDED BY MECHANICAL CONTRACTOR.

(18) REPOSITION EXISTING BASE CABINETS AND COUNTERTOP AS INDICATED.

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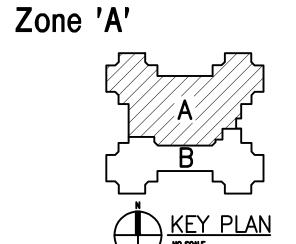
REGISTRATION SEAL

CONSULTANT

PROJECT TITLE Allen Elementary Remodel

Southgate Community Schools Southgate, Michigan

DRAWING TITLE First Level Floor Plan -




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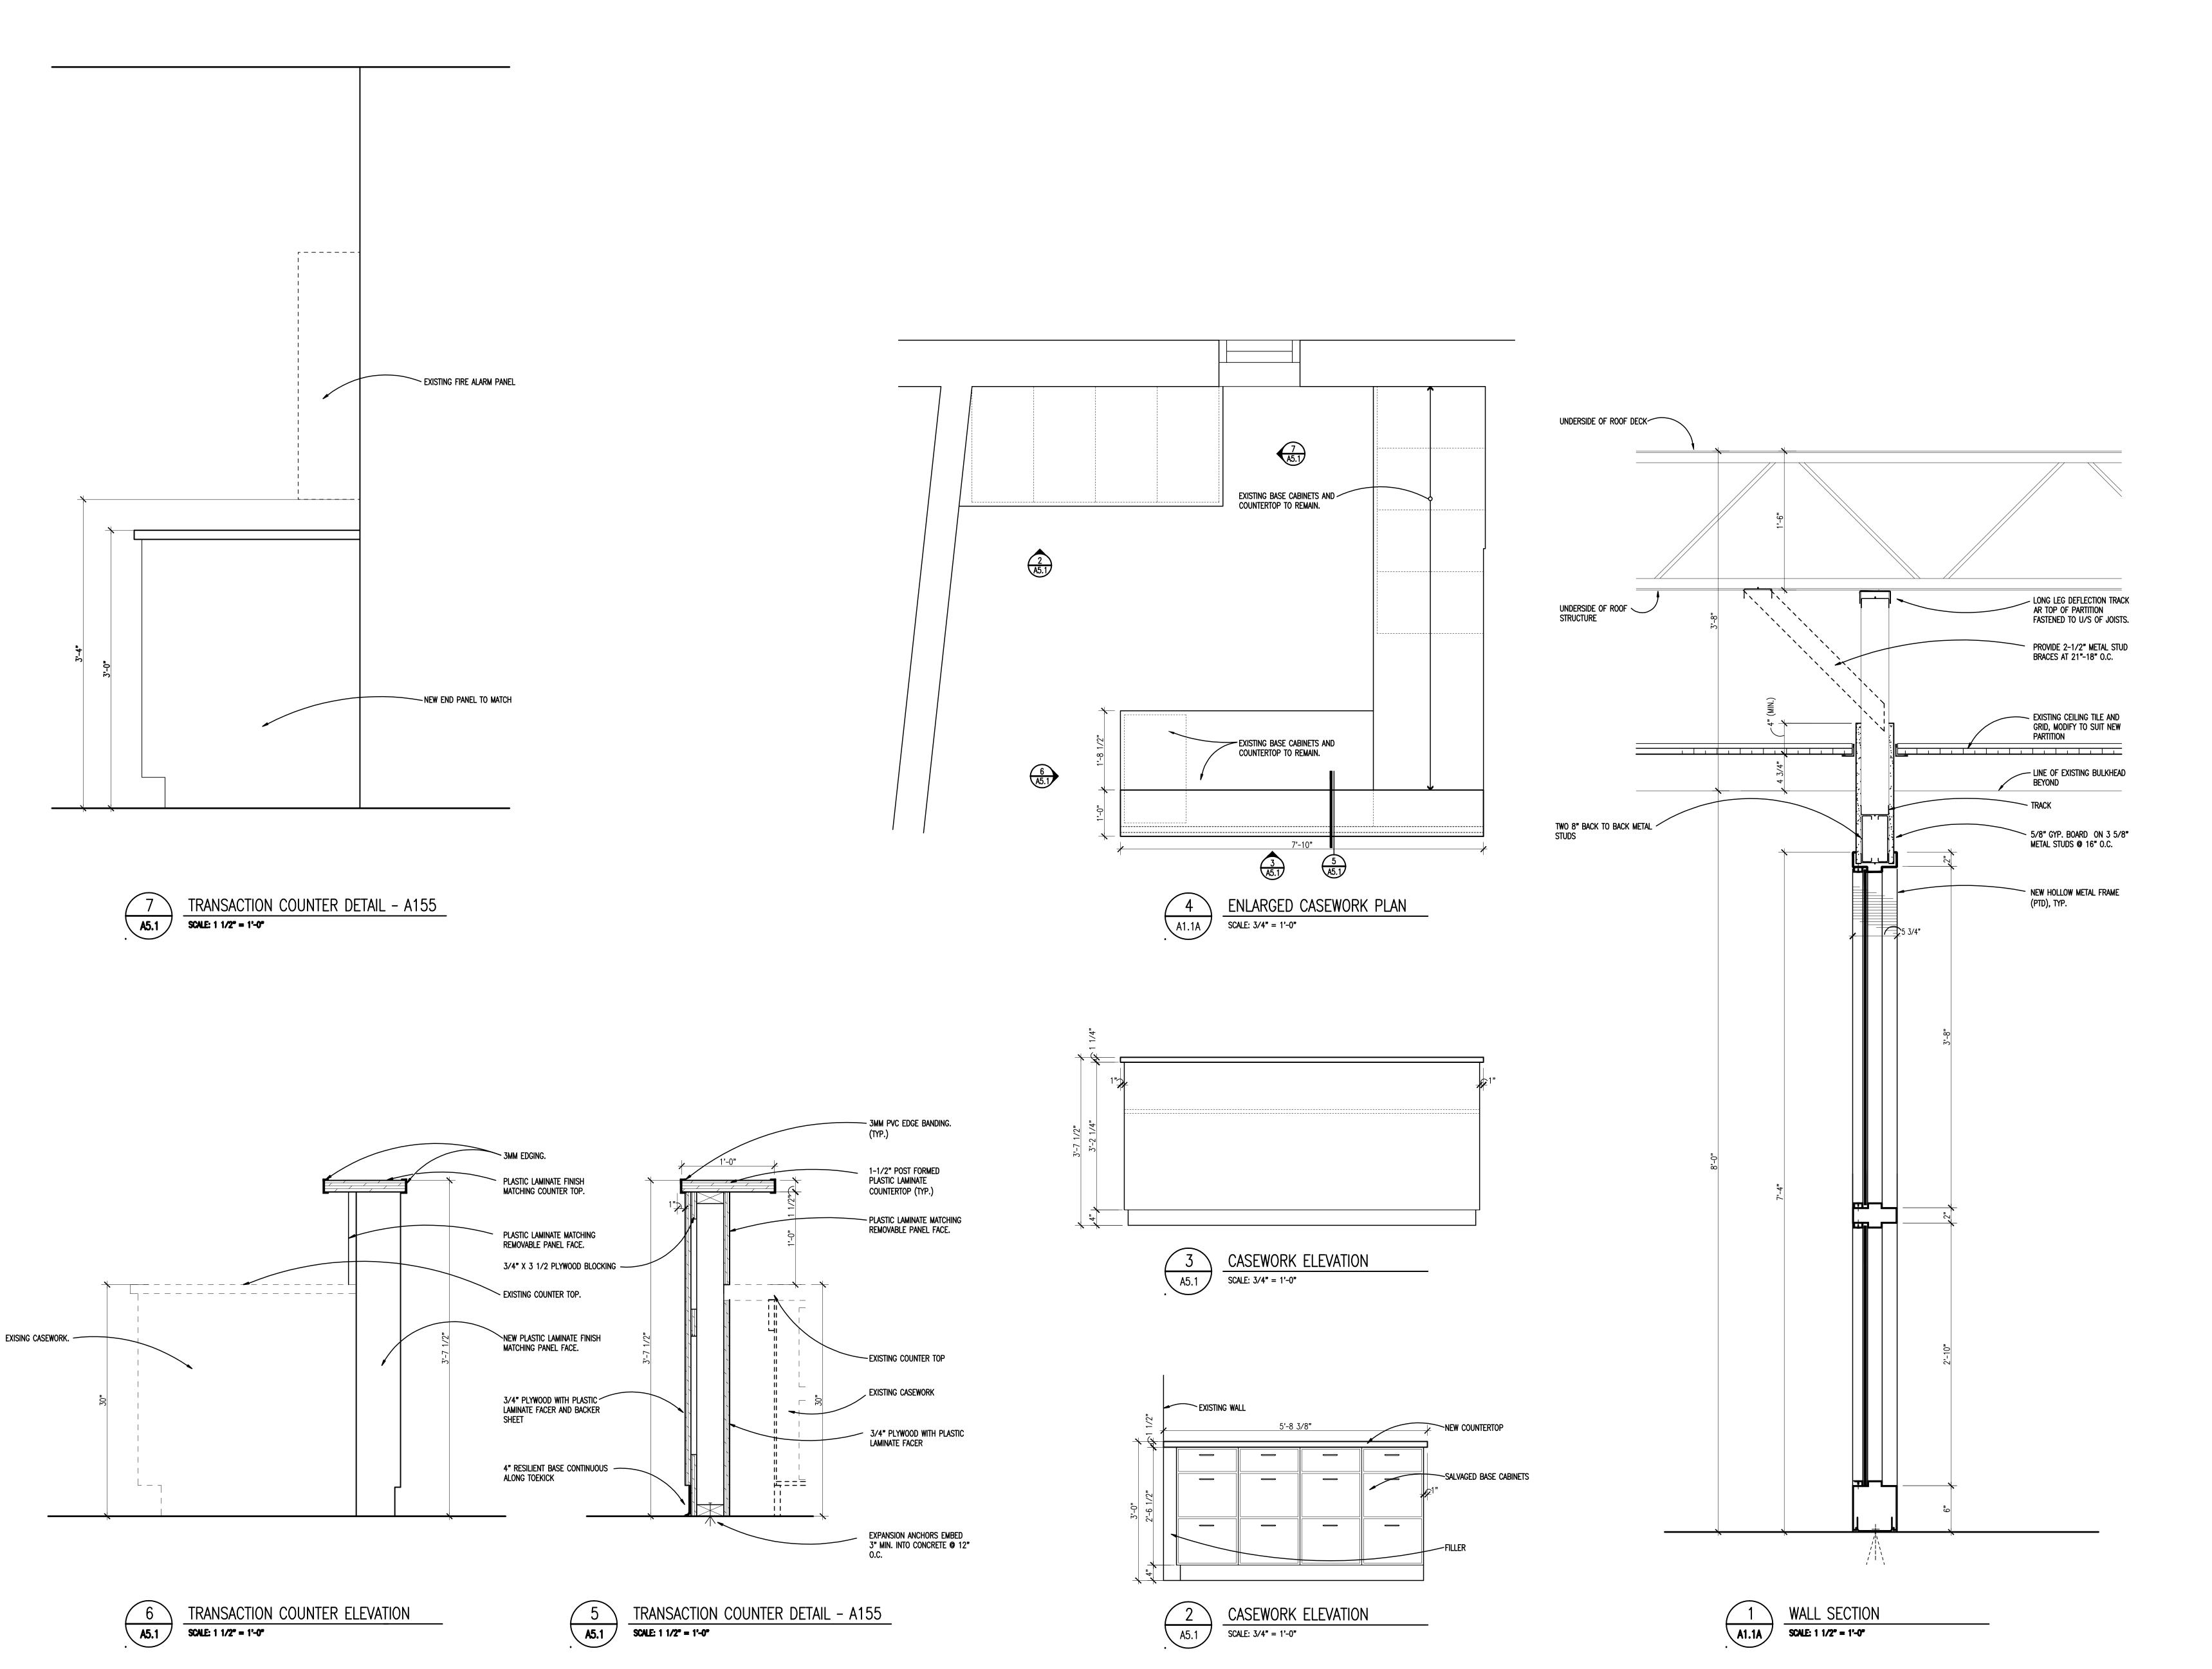
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PROJECT NO.

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DRAWING NO. **A1.1A**





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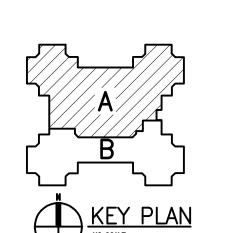
PROJECT TITLE

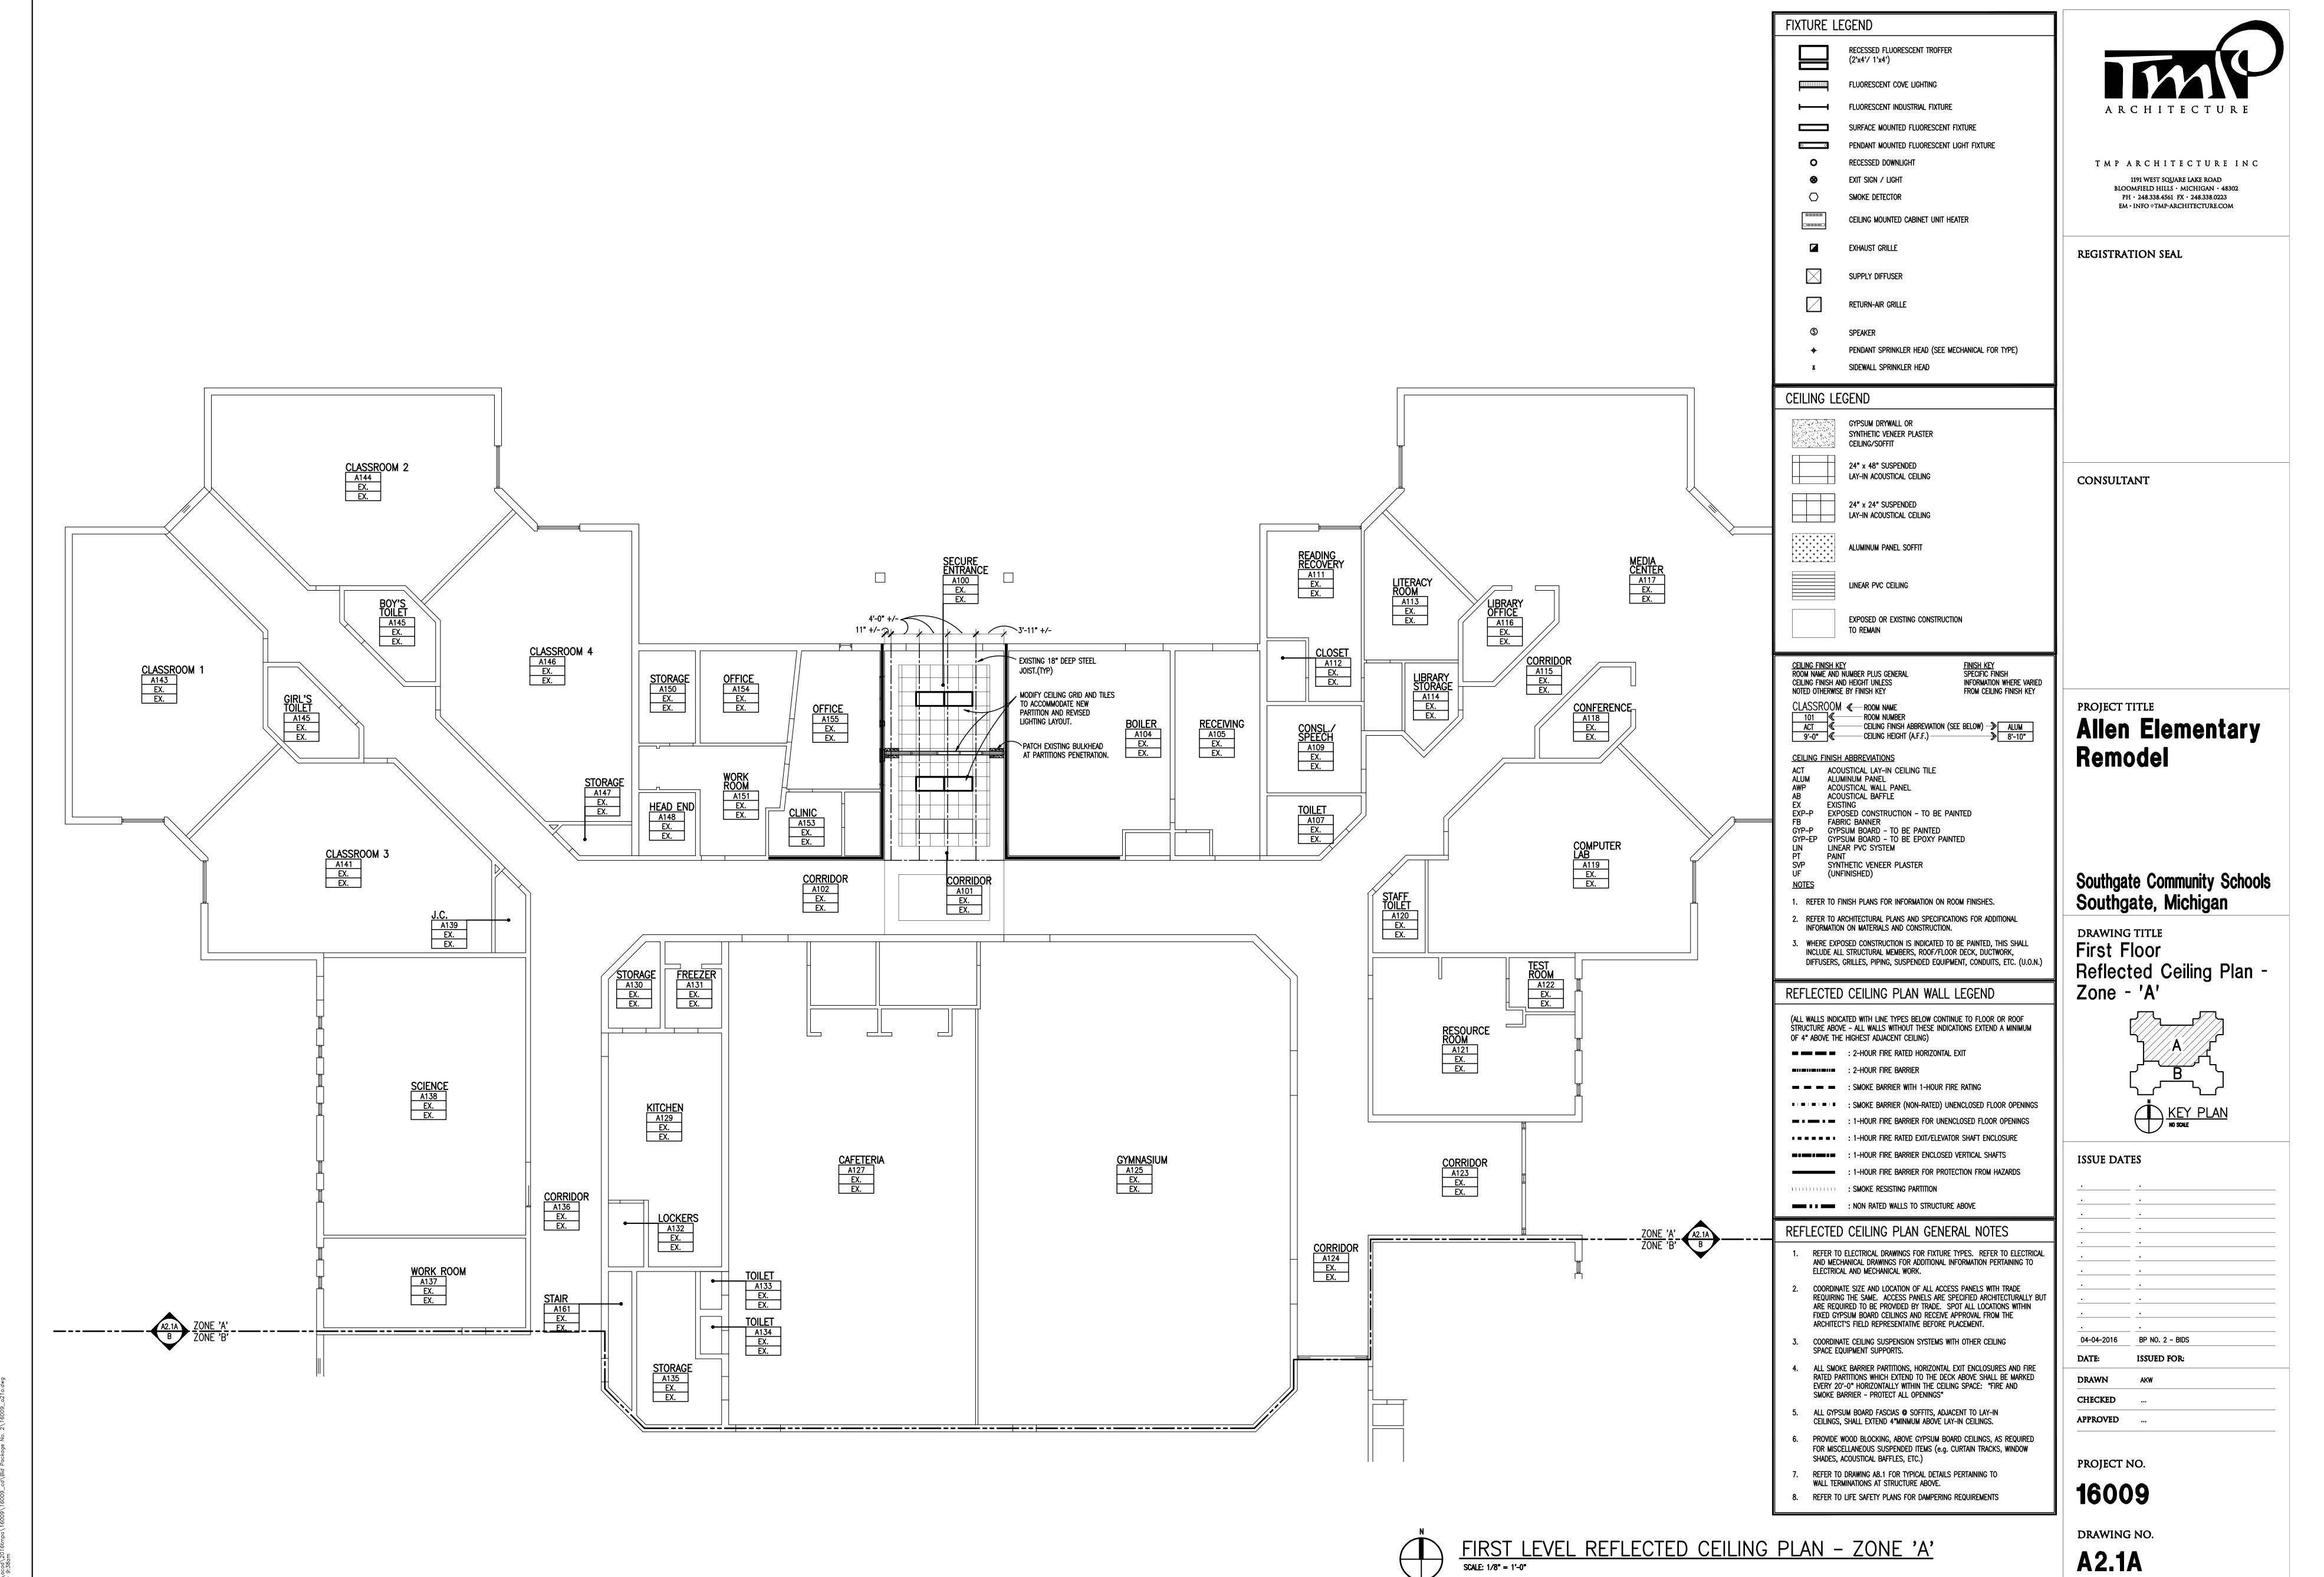Allen Elementary Remodel

Southgate Community Schools Southgate, Michigan

DRAWING TITLE

Details




PROJECT NO.

16009

DRAWING NO. **A5.1**

DE	SCRIPTION	<u>SYMBOL</u>	<u>DESCRIPTION</u>	<u>SYMBOL</u>	<u>DESCRIPTION</u>	<u>SYMBOL</u>	<u>DESCRIPTION</u>	<u>SYMBOL</u>	<u>DESCRIPTION</u>
	(TURE TYPE	TWC	TWO-WAY COMMUNICATION SYSTEM	S TMBOL CP	CONTROL PANEL		SECURITY CAMERA	<u>STMBOL</u>	MANUAL FIRE ALARM BOX
LIG	SHTING FIXTURE		CALL STATION TWO-WAY COMMUNICATION SYSTEM	<u> </u>	MOTOR	MD	MOTION DETECTOR	SD	SMOKE DETECTOR
DIR	RECT/INDIRECT LIGHTING FIXTURE	TWCD	AUTO DIALER	VFC	VARIABLE FREQUENCY CONTROLLER.	⟨K⟩	SECURITY KEY SWITCH	DD	DUCT SMOKE DETECTOR
	,	TWCA	TWO-WAY COMMUNICATION SYSTEM ANNUNCIATOR & COMMUNICATION PANEL		MANUAL CONTROLLER	DC	DOOR CONTACT	CO	CARBON MONOXIDE DETECTOR
EM	IERGENCY FIXTURE	TWCP	TWO-WAY COMMUNICATION SYSTEM		MAGNETIC CONTROLLER	KP	KEY PAD	RT	REMOTE TEST STATION (FOR DUCT DETECTOR)
NIG	GHT LIGHTING FIXTURE		POWER SUPPLY WITH BATTERY BACK-UP		COMBINATION MAGNETIC CONTROLLER	CR	ACCESS CONTROL STATION	TD	THERMAL DETECTOR
ШС	SHTING FIXTURE	TWCDP	TWO-WAY COMMUNICATION SYSTEM AUTO DIALER POWER SUPPLY WITH BATTERY BACK-UP	<u> </u>	NON-FUSIBLE DISCONNECT SWITCH	DB	DURESS PUSH BUTTON STATION	BD	PROJECTED BEAM DETECTOR
	IERGENCY FIXTURE	RGP	REMOTE GENERATOR ANNUCIATOR PANEL		FUSIBLE DISCONNECT SWITCH	DE	DELAYED EGRESS	FO	FIRE ALARM BELL
	ALL MOUNTED LIGHTING FIXTURE	ATS	AUTOMATIC TRANSFER SWITCH	CB [_]	ENCLOSED CIRCUIT BREAKER	REX	REQUEST TO EXIT STATION	F	FIRE ALARM AUDIBLE NOTIFICATION APPLIANCE
	SHTING FIXTURE	UPS	UN-INTERRUPTABLE POWER SUPPLY	•	PUSH BUTTON STATION	°\			
	IERGENCY FIXTURE	CSX	LOW VOLTAGE CONTROL STATION "X" INDICATES TYPE		JUNCTION BOX	<i>。)</i> ∻	CIRCUIT BREAKER	-l∕√- _{XX}	"XX" INDICATES CANDELA RATING IF NO RATING SHOWN, APPLIANCE IS 15cd
	RECTIONAL LIGHTING FIXTURE	ф	SINGLE RECEPTACLE	•	HARD WIRE POWER CONNECTION		DRAWOUT CIRCUIT BREAKER MANUALLY/ OPERATED	_/	FIRE ALARM COMBINATION VISUAL/ AUDIBLE
	INDANT LIGHTING FIXTURE	ф	DUPLEX RECEPTACLE	DP	AUTOMATIC DOOR CONTROLLER	*		□ XX	"XX" INDICATES CANDELA RATING
WA	ALL SCONCE	<u></u>	QUAD RECEPTACLE	PP	AUTOMATIC DOOR PUSH PAD OPERATOR	€ †	DRAWOUT CIRCUIT BREAKER ELECTRICALLY/ OPERATED	\	IF NO RATING SHOWN, APPLIANCE IS 15cd
LIG	SHTING TRACK	Ψ	ABOVE COUNTER DUPLEX RECEPTACLE	•	GROUND ROD	∜ ∘/	·	F XX	FIRE ALARM COMBINATION VISUAL/ AUDIBLE NOTIFICATION APPLIANCE— CEILING MOUNTED
TR	ACK LIGHTING FIXTURE	 	(SIMILAR FOR TAMPER RESISTANT, QUADS, EMERGENCY AND GFI RECEPTACLES)		GROUND CONNECTION CONDUIT SLEEVE WITH BUSHINGS	\ <u>\</u>	SWITCH	/ \ \ \ \ \ \ \ \ \ \ \ \ \ \ \ \ \ \ \	"XX" INDICATES CANDELA RATING IF NO RATING SHOWN, APPLIANCE IS 15cd
PO	DLE MOUNTED LIGHTING FIXTURE	ф	DUPLEX RECEPTACLE—GROUND FAULT CIRCUIT	\vdash X	LENGTH AS REQUIRED "X" INDICATES CONDUIT SIZE		AUTOMATIC OR MANUAL TRANSFER SWITCH FUSE		FIRE ALARM VISUAL NOTIFICATION APPLIANCE
PO	DLE MOUNTED LIGHTING FIXTURE — POST TOP	å	INTERRUPTER DUPLEX EMERGENCY RECEPTACLE	0	CONDUIT UP	ww	TRANSFORMER	\searrow XX	CEILING MOUNTED "XX" INDICATES CANDELA RATING
ВО	DLLARD LIGHTING FIXTURE	₩	TAMPER RESISTANT RECEPTACLE	•	CONDUIT DOWN	\rightarrow	CURRENT TRANSFORMER		IF NO RATING SHOWN, APPLIANCE IS 15cd
EM	IERGENCY LIGHTING UNIT	₩	QUAD TAMPER RESISTANT RECEPTACLE	\triangleleft	EMPTY BOX FOR FUTURE	38	POTENTIAL TRANSFORMER	F	FIRE ALARM AUDIBLE NOTIFICATION APPLIANC CEILING MOUNTED
	IT LIGHTING FIXTURE WITH DIRECTIONAL RROWS (SHADED AREA INDICATES FACE)		ABOVE COUNTER DUPLEX	1	TELECOMMUNICATION OUTLET ABOVE COUNTER EMPTY BOX FOR	→ • -	LIGHTNING ARRESTOR	◀	FIREFIGHTERS PHONE JACK
EVI	IT LIGHTING FIXTURE WITH DIRECTIONAL	+	TAMPER RESISTANT RECEPTACLE	\forall	FUTURE TELECOMMUNICATION OUTLET	X	PANELBOARD "X" INDICATES PANELBOARD NAME	<u>+</u>	
	RROWS (SHADED AREA INDICATES FACE)	4	DUPLEX UPS RECEPTACLE		EMPTY BOX FOR FUTURE CEILING MOUNTED TELECOMMUNICATION OUTLET REFER TO		GROUND	FACP	FIRE ALARM CONTROL PANEL
EXI	TIT LIGHTING FIXTURE — WALL MOUNTED	#	USB RECEPTACLE	\triangleleft	TELECOMMUNICATION OUTLET STANDARD "X" INDICATES TYPE SCHEDULES	<u>-</u> ▼	STRESS CONE TERMINATION	FAA	FIRE ALARM ANNUNCIATOR PANEL
EM	IERGENCY LOAD TRANSFER DEVICE	¥F	4 PORT USB CHARGING STATION	X	ABOVE COUNTER TELECOMMUNICATION	K	SECURITY KEY INTERLOCK	NAC	NOTIFICATION APPLIANCE CIRCUIT EXTENDER PANEL
SIN	NGLE POLE TOGGLE SWITCH		CEILING MOUNTED DUPLEX RECEPTACLE	X	OUTLET "X" INDICATES TYPE	<u> </u>	ENGINE GENERATOR	IM	ADDRESSABLE MONITORING MODULE
	O POLE TOGGLE SWITCH		POWER POLE		TELECOMMUNICATION CEILING MOUNTED OUTLET "X" INDICATES TYPE	M	UTILITY METER	СМ	ADDRESSABLE CONTROL MODULE
	WAY TOGGLE SWITCH WAY TOGGLE SWITCH	××	SPECIAL RECEPTACLE — REFER TO ELECTRICAL STANDARD SCHEDULES	^	J	EMU	ELECTRONIC METERING UNIT	TS	TAMPER SWITCH
	Y OPERATED SWITCH	<u>т</u> Ж Ж Ж		KXXXXX	TELECOMMUNICATION BACKBOARD	A	AMMETER	FS	FLOW SWITCH
3 1	WAY KEY OPERATED SWITCH		MULTI-OUTLET RACEWAY	—TGB <i>-</i> - —TMGB	TELECOMMUNICATION GROUNDING BUS BAR TELECOMMUNICATION MAIN GROUNDING BUS BAR	V	VOLTMETER	DR	MAGNETIC DOOR RELEASE
4 1	WAY KEY OPERATED SWITCH	, X,	MULTI-SERVICE DROP SEE ELECTRICAL DETAILS AND DIAGRAMS SHEET			AS	AMMETER SWITCH		
	MMER SWITCH		"X" INDICATES TYPE POKE THRU SERVICE FITTING	IC	INTERCOM OUTLET	VS	VOLTMETER SWITCH		
	WAY DIMMER SWITCH MMER OCCUPANCY SENSOR SWITCH	PTX	"X" INDICATES TYPE	(\$)	SPEAKER	SPD	SURGE PROTECTIVE DEVICE		
	W VOLTAGE DIMMER SWITCH	FBX	FLOOR BOX SERVICE FITTING "X" INDICATES TYPE	H(s)	SPEAKER — WALL MOUNTED	(CR)	CONTROL RELAY		
PIL	LOT SWITCH	AFX	ACCESS FLOOR SERVICE FITTING "X" INDICATES TYPE	MIC	MICROPHONE	(TDR)	TIME DELAY RELAY		
		RX	CORD REEL	VC	VOLUME CONTROL/STATION SELECTOR	<u> </u>	THERMAL OVERLOAD RELAY		
			"X" INDICATES TYPE DUAL SWITCHING FOR INNER/OUTER LAMPS	BO	SIGNALING BELL		NORMALLY OPEN CONTACTS		
		\$\$	OF FLUORESCENT LIGHT FIXTURES		SINGLE FACE CLOCK — CEILING MOUNTED	0	NORMALLY CLOSED CONTACTS		
		5353	3-WAY DUAL SWITCHING FOR INNER/OUTER LAMPS OF FLUORESCENT LIGHT FIXTURES	H	SINGLE FACE CLOCK — WALL MOUNTED		N.O. PUSH BUTTON SINGLE CIRCUIT		
			4-WAY DUAL SWITCHING FOR INNER/OUTER	8	DOUBLE FACE CLOCK - CEILING MOUNTED	<u> </u>	N.C. PUSH BUTTON SINGLE CIRCUIT		
		\$4\$4	LAMPS OF FLUORESCENT LIGHT FIXTURES	S	DOUBLE FACE COMBINATION CLOCK/SPEAKER		CABLE VAULT		
		ST	DIGITAL TIME SWITCH		CEILING MOUNTED	○ X-X	"X-X" INDICATES TYPE		
		Sı	ILLUMINATED TOGGLE SWITCH FOR CONTROL OF		DOUBLE FACE CLOCK — WALL MOUNTED		BRANCH CIRCUIT PANELBOARD		
			LIGHTING ON CRITICAL POWER-ILLUMINATED WHEN SWITCH IS IN "OFF" POSITION	S	DOUBLE FACE COMBINATION CLOCK/SPEAKER		MOTOR CONTROL CENTER		
		SL	LOW VOLTAGE SWITCH		WALL MOUNTED	Т	TRANSFORMER		
		So	OCCUPANCY SENSOR REFER TO ELECTRICAL	T/C	TIME CLOCK		DISTRIBUTION PANEL		
		S02	STANDARD SCHEDULES OCCUPANCY SENSOR	С	CONTACTOR	├─-GB	GROUND BUS		
				P		$\vdash\!$	PLUG IN BUSWAY		

STANDARD MOUNTING HEIGHTS

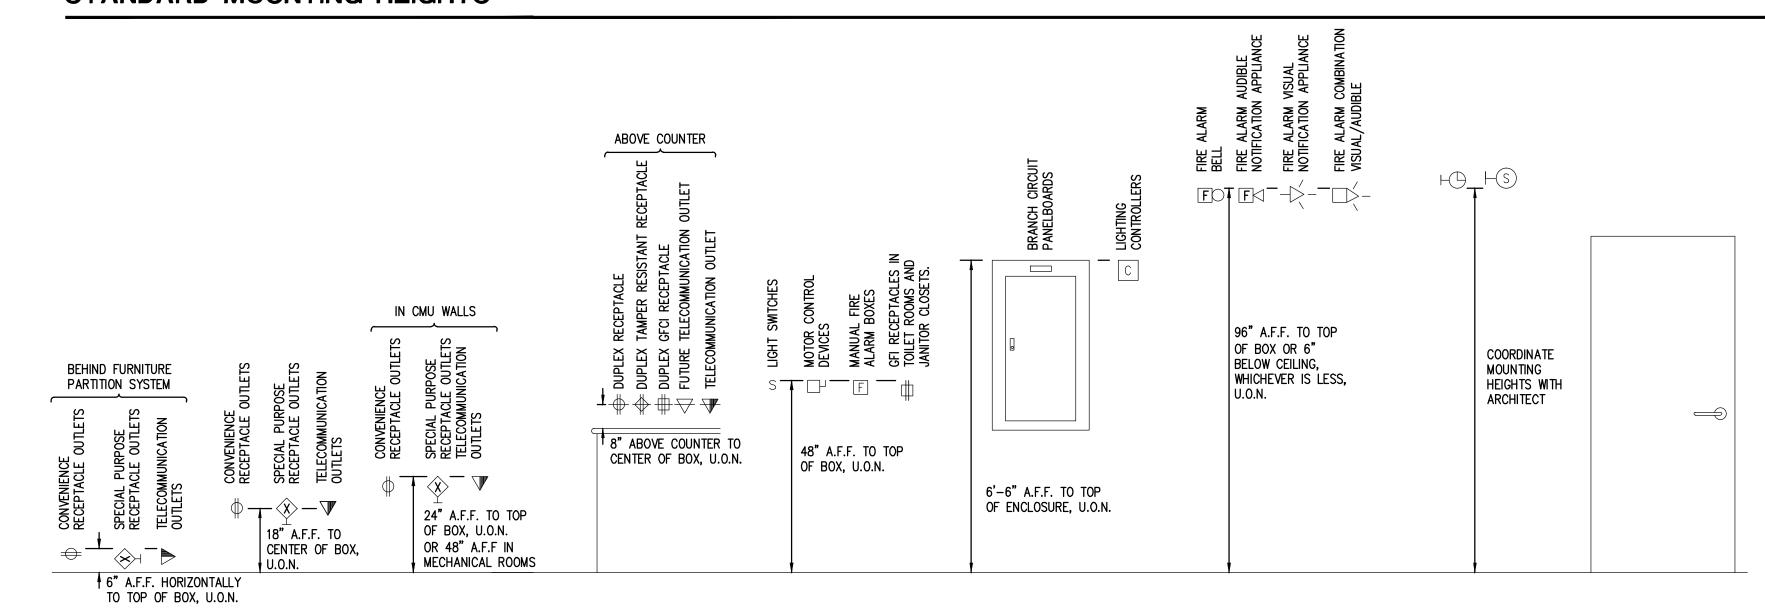


ELECTRICAL DRAWING INDEX

SHEET TITLE ELECTRICAL STANDARDS AND DRAWING INDEX ELECTRICAL STANDARD SCHEDULES E0.3 ELECTRICAL COMPOSITE PLAN E1.1 PARTIAL ELECTRICAL PLANS EMERGENCY LIGHTING CALCULATIONS

ELECTRICAL ABBREVIATION LIST

<u>ABBREVIATION</u>	DESCRIPTION	<u>ABBREVIATION</u>	DESCRIPTION	<u>ABBREVIATION</u>	<u>DESCRIPTION</u>
١	AMPERES	G/GRD/EG	GROUND	OC	ON CENTER
∖ F	AMPERES FRAME (BREAKER RATING)	GFCI	GROUND FAULT CIRCUIT INTERRUPTER	OFCI	OWNER FURNISHED,
A.F.F.	ABOVE FINISH FLOOR	GFP	GROUND FAULT PROTECTION		CONTRACTOR INSTALLED
AIC	AMPS INTERRUPTING CAPACITY	HOA	HAND-OFF-AUTO	OFOI	OWNER FURNISHED,
AL	AUDIENCE LEFT	HP	HORSEPOWER		OWNER INSTALLED
AR	AUDIENCE RIGHT	HV	HIGH VOLTAGE	Р	POLE
AT.	AMPERES TRIP (BREAKER SETTING)	HZ	HERTZ	, PB	PUSHBUTTON STATION
ATS	AUTOMATIC TRANSFER SWITCH			PH	PHASE
AUX	AUXILIARY	IG	ISOLATED GROUND	PT	POTENTIAL TRANSFORMER
BKR	BREAKER	JB	JUNCTION BOX	PDP	POWER DISTRIBUTION PANEL
BPS	BOLTED PRESSURE SWITCH	KV	KILOVOLT		
C	CONDUIT	KVA	KILOVOLT – AMPERES	RECEPT.	RECEPTACLE
ČB	CIRCUIT BREAKER	KW	KILOWATT	RDP	RECEPTACLE DISTRIBUTION PAN
CFCI	CONTRACTOR FURNISHED,	KWH	KILOWATT - HOURS	RP	RECEPTACLE PANEL
J. J.	CONTRACTOR INSTALLED	IXWIII	NEOWATT TIOONS	RSC	RIGID STEEL CONDUIT
CKT	CIRCUIT	LA	LIGHTNING ARRESTOR	SCHED	SCHEDULE
CT CT	CURRENT TRANSFORMER	LP	LIGHTING PANEL	SW	SWITCH
DEMO		LDP	LIGHTING DISTRIBUTION PANEL	SWBD	SWITCHBOARD
DEMO DIM	DEMOLITION DIMENSION	MAX	MAXIMUM	SWGR	SWITCHGEAR
DISC	DISCONNECT	MCB	MAIN CIRCUIT BREAKER	ТВ	TERMINAL BOX
)P	DISTRIBUTION PANEL	MCC	MOTOR CONTROL CENTER	TELECOM	TELECOMMUNICATIONS
DP DS	DOWNSTAGE	MDP	MAIN DISTRIBUTION PANEL	TR	TAMPER RESISTANT
DS DWG	DRAWING	MECH	MECHANICAL	TTB	TELEPHONE TERMINAL BACKBO
		MIN	MINIMUM	TYP	TYPICAL
EBU	EMERGENCY BATTERY UNIT	MISC.	MISCELLANEOUS		
EC	ELECTRICAL CONTRACTOR	MLO	MAIN LUGS ONLY	U.O.N.	UNLESS OTHERWISE NOTED
LEC	ELECTRICAL	MTD	MOUNTED	US	UPSTAGE
M/ EMERG	EMERGENCY	MTG	MOUNTING	٧	VOLTS
MT	ELECTRICAL METALLIC TUBING	MTR	MOTOR	W	WIRE
.0	ELECTRICALLY OPERATED			W WP	WEATHERPROOF
PO	EMERGENCY POWER OFF	N	NEUTRAL	WP	WEATHERPROOF
:WC	ELECTRIC WATER COOLER	NC	NORMALLY CLOSED	XFMR	TRANSFORMER
XIST	EXISTING	NEC	NATIONAL ELECTRICAL CODE	XP	EXPLOSION PROOF
-A	FIRE ALARM	NF	NON-FUSIBLE	(E)	EXISTING
LA	FULL LOAD AMPS	NIC	NOT IN CONTRACT		
LR	FLOOR	NL	NIGHT LIGHT	(R)	RELOCATED
OH	FRONT OF HOUSE	NO	NORMALLY OPEN		
SEC	FOOD SERVICE EQUIPMENT CONTRACTOR	NTS	NOT TO SCALE		
- -	FLOR				

STANDARD METHODS OF NOTATION

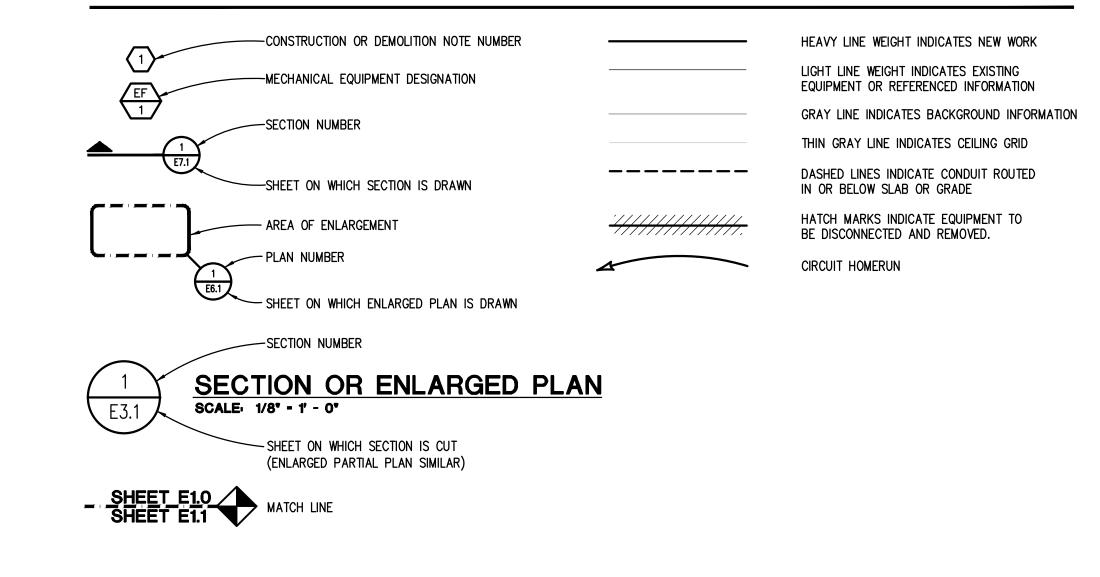



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PROJECT TITLE

Allen Elementary Remodel

Southgate Community Schools Southgate, Michigan

DRAWING TITLE ELECTRICAL STANDARDS AND DRAWING INDEX

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ISSUED FOR:

CHECKED GJZ APPROVED **GJZ**

PROJECT NO.

16009

DRAWING NO.

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			COPPER CON	DUCTORS		
OVERCURRENT		SIZE R KCMIL)		CC	ONDUIT SIZE	
DEVICE RATING (AMPERES)	PHASE & NEUTRAL	GROUND	SINGLE PHASE 2 WIRE+G (1PH, 1N, 1G)	SINGLE PHASE 3 WIRE+G (2PH, 1N, 1G)	THREE PHASE 3 WIRE+G (3PH, 1G)	THREE PHAS & NEUTRAL 4 WIRE+G (3PH, 1N, 1G)
15-20	12	12	3/4"	3/4"	3/4"	3/4"
25-30	10	10	3/4"	3/4"	3/4"	3/4"
35-40	8	10	3/4"	3/4"	3/4"	3/4"
45-50	8 (6)	10	3/4"	3/4"	3/4"	3/4"
60	6 (4)	10	3/4" (1")	3/4" (1")	3/4" (1")	3/4" (1")
70	4	8	1"	1 1/4"	1 1/4"	1 1/4"
80	4 (3)	8	1"	1 1/4"	1 1/4"	1 1/4"
90-100	3 (2)	8	1 1/4"	1 1/4"	1 1/4"	1 1/4"
110	2 (1)	6	-	1 1/4"	1 1/4"	1 1/4" (1 1/2'
125	1 (1/0)	6	-	1 1/4" (1 1/2")	1 1/4" (1 1/2")	1 1/2"
150	1/0	6	-	1 1/2"	1 1/2"	1 1/2"
175	2/0	6	-	2"	2"	2"
200	3/0	6	-	2"	2"	2 1/2"
225	4/0	4	-	2"	2"	2 1/2"
250	250	4	-	2 1/2"	2 1/2"	2 1/2"
300	350	4	_	2 1/2"	2 1/2"	3"
350	500	3	-	3"	3"	3"
400	500	3	_	3"	3"	3"
450	2-4/0	2–2	_	2-2"	2-2"	2-2 1/2"
500	2-250	2–2	_	2-2 1/2"	2-2 1/2"	2-2 1/2"
600	2-350	2-1	_	2-2 1/2"	2-2 1/2"	2-3"
700	2-500	2-1/0	-	2-3"	2-3"	2-3"
800	2-500	2-1/0	_	2-3"	2-3"	2-3 1/2"
1000	3-400	3-2/0	-	3–3"	3–3"	3–3"
1200	3-600	3–3/0	_	3-3 1/2"	3-3 1/2"	3–3 1/2"
1600	4–600	4-4/0	_	4-3 1/2"	4-3 1/2"	4-3 1/2"
2000	5-600	5-250	I –	5-3 1/2"	5-3 1/2"	5-3 1/2"

* = SEE NOTE 4

NOTES:

- 1. CONTRACTOR TO SIZE FEEDERS AND BRANCH CIRCUITS BASED ON THIS SCHEDULE AND OVER CURRENT DEVICE SIZE, UNLESS NOTED OTHERWISE.
- 2. CONTRACTOR MAY COMBINE 20A CIRCUITS AS NOTED IN SPECIFICATION. 3. CONDUCTORS ARE BASED ON THHN/THWN UP TO AND INCLUDING #4/0. LARGER THAN #4/0 ARE BASED ON TYPE XHHW.
- 4. CONDUCTORS ARE BASED ON 90°C, 600V. INSULATED COPPER WIRE APPLIED AT 75°C FOR TERMINATION RATED 60/75°C OR 75°C. FOR TERMINATION RATED AT 60°C, USE CONDUCTORS AND CONDUIT SIZES INDICATED IN PARENTHESES. 5. CONDUIT SIZES ARE VALID FOR EMT OR RGS. CONDUIT SIZES SHALL BE ADJUSTED AS REQUIRED FOR OTHER TYPES OF CONDUIT.
- 7. SIZE OF DISCONNECT SWITCH LOCATED AT EQUIPMENT SHALL BE SIZED BASED UPON OVERCURRENT PROTECTION OF THAT DEVICE. 8. PRIOR APPROVAL FROM ENGINEER SHALL OCCUR IF A DIFFERENT SIZE/NUMBER OF CONDUCTORS IS TO BE USED. AMPACITY SHALL BE EQUAL OR GREATER.

6. ELECTRICAL CONTRACTOR TO COORDINATE WITH MECHANICAL CONTRACTOR AND PROVIDE REQUIRED WIRE SIZES TO ACCOMMODATE MECHANICAL EQUIPMENT LUG

RACEWAY		AC/MC CABLE	ALUMINUM RIGID CONDUIT	ELECTRICAL METALLIC TUBING (EMT)	SURFACE RACEWAY	ELECTRICAL NONMETALLIC TUBING (ENT)	FLEXIBLE METAL CONDUIT (FMC)	GENERAL-USE OPTICAL FIBER/COMMUNICATION CABLE RACEWAY	INTERMEDIATE METAL CONDUIT (IMC)	LIQUIDTIGHT FLEXIBLE METAL CONDUIT (LFMC)	LIQUIDTIGHT FLEXIBLE NONMETAL CONDUIT (LFNC)	PLENUM-TYPE OPTICAL FIBER/COMMUNICATIONS	RIGID STEEL CONDUIT	RISER-TYPE OPTICAL FIBER/COMMUNICATIONS CABLE RACEWAY	RIGID NONMETALLIC CONDUIT (RNC) TYPE EPC-40	RIGID NONMETALLIC CONDUIT (RNC) TYPE EPC-80	HIGH DENSITY POLYTHYLENE (HDPE) SCHEDULE 40	HIGH DENSITY POLYTHYLENE (HDPE) SCHEDULE 80	KEYED NOTES
~	EVDOSED		\square					GEI	_		_		<u> </u>	≅⋧					
OUTDOOR	EXPOSED CONCEALED (AROUT CROUND)		ert	_			_		X	╀	╀	 	X		\vdash	\vdash		Н	
100 1	CONCEALED (ABOVE GROUND) UNDERGROUND		\dashv						Х	\vdash			X		Х	Х	Х	Х	
	CHECKGROOM												Ĺ		Ĺ	Ĺ		^	
	CONNECTED TO VIBRATING EQUIPMENT									Х									EQUIPMENT INCLUDING: TRANSFORMERS, HYDRAULIC PNEUMATIC, ELECTRIC SOLENOID, MOTOR DRIVEN EQUIPMENT
INDOOR	EXPOSED NOT SUBJECT TO PHYSICAL DAMAGE — UNFINISHED SPACES			Χ															
	EXPOSED NOT SUBJECT TO PHYSICAL DAMAGE — FINISHED SPACES				Х														
	EXPOSED SUBJECT TO SEVERE PHYSICAL DAMAGE								X				Х						RIGID STEEL CONDUIT UP TO 10'-0"AFF. LOCATIONS INCLUDE: LOADING DOCKS, CORRIDORS USED FOF TRAFFIC OF MECHANIZED CARTS AND PALLET HANDLING UNITS, MECHANICAL ROOMS
	CONCEALED IN CEILINGS, INTERIOR WALL AND PARTITIONS	Х		Х															NOT TO EXCEED 6'-0" IN CEILING SPACE
	CONNECTED TO VIBRATING EQUIPMENT						Χ			х									EQUIPMENT INCLUDING: TRANSFORMERS, HYDRAULIC PNEUMATIC, ELECTRIC SOLENOID, MOTOR DRIVEN EQUIPMENT USE LFMC IN DAMP/WET LOCATIONS
	DAMP AND WET LOCATIONS								Х				Х						
	BELOW SLAB IN GRADE														Х	Х			PROVIDE RIGID STEEL ELBOWS WHERE CONDUIT PENETRATES SLAB. CONDUIT INSTALLED 6" BELOW BOTTOM OF SLAB
	EMBEDDED IN CONCRETE ABOVE GRADE		\forall						\vdash	t	\vdash	\vdash	Х		Х	Х			SEAS. SOURSELL STATES OF BELOW BOTTOM OF SEAS
	OPTICAL FIBER OR COMMUNICATIONS CABLE IN SPACES USED FOR ENVIRONMENTAL AIR			Х								Х							
	CONCEALED GENERAL PURPOSE DISTRIBUTION OF OPTICAL FIBER OR COMMUNICATION CABLE			Χ				Χ				Х		Х					
NS	MRI		Х							T	T								
SPECIAL APPLICATIONS	NATATORIUMS/FOUNTAINS			Х															USE COMPRESSION FITTINGS. PAINTED WITH CORROSION RESISTANT PAINT BY PAINTING CONTRACTOR.
AP.			Щ						<u> </u>						lacksquare				

GENERAL NOTES

1. 'X' INDICATES ACCEPTABLE SELECTION. 2. REFER TO "CONDUCTORS AND CABLES" SPECIFICATION FOR APPLICATION LIMITATIONS OF AC/MC CABLE.

В	RANCH CIF		TAGE DROLLE PHASE		SCHEDUL	E
BRANCH	WIRE SIZE	M	IAXIMUM BRAN	CH CIRCUIT LE	ENGTH (IN FEE	T)
CKT RATING (A)	(AWG)	120V	208V	240V	277V	480V
20A	12	83	143	165	191	331
	10	128	222	256	295	511
	8	201	348	402	464	804
	6	313	542	625	721	1250
30A	10	85	148	170	197	341
	8	134	232	268	309	536
	6	208	361	417	481	833
	4	313	542	625	721	1250

- THE ABOVE TABLE VALUES ARE BASED ON COPPER CONDUCTORS, IN STEEL CONDUIT, WITH A LOAD POWER FACTOR OF 0.85 PER NEC CHAPTER 9, TABLE 9.
 PROVIDE BRANCH CIRCUIT CONDUCTORS AS INDICATED IN THE TABLE ABOVE FOR ALL LIGHTING AND RECEPTACLE
- BRANCH CIRCUITS. WHERE BRANCH CIRCUITS SERVE DEDICATED EQUIPMENT, THE CONTRACTOR MAY PERFORM VOLTAGE DROP CALCULATIONS BASED ON ACTUAL EQUIPMENT CONNECTED LOAD AND PROVIDE CONDUCTORS APPROPRIATELY SIZED TO LIMIT VOLTAGE DROP TO A MAXIMUM OF 3%.

 3. CONDUCTOR SIZES ARE BASED ON MAXIMUM OF 9 CURRENT CARRYING CONDUCTORS IN A SINGLE CONDUIT.
- 4. LIMITS FOR CONDUCTOR LENGTHS SHOWN ARE BASED ON A MAXIMUM BRANCH CIRCUIT LOADING OF 64% OF THE BRANCH BREAKER RATING AND A MAXIMUM OF 3 PERCENT VOLTAGE DROP TO COMPLY WITH ASHRAE/IES 90.1 -1999 AND THE NEC. FOR CIRCUITS LOADED GREATER THAN 64% OF BRANCH BREAKER RATING, THE CONTRACTOR SHALL PROVIDE CONDUCTORS APPROPRIATELY SIZED TO LIMIT VOLTAGE DROP TO 3%.



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PROJECT TITLE

Allen Elementary Remodel

Southgate Community Schools Southgate, Michigan

DRAWING TITLE ELECTRICAL STANDARD SCHEDULES

DRAWN SC CHECKED **GJZ**

APPROVED GJZ

PROJECT NO. 16009

DRAWING NO.

E0.2

NOTE: SOME SYMBOLS AND ABBREVIATIONS SHOWN MAY NOT APPLY TO THIS PROJECT.





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PROJECT TITLE

Allen Elementary Remodel

Southgate Community Schools Southgate, Michigan

DRAWING TITLE
ELECTRICAL COMPOSITE
PLAN

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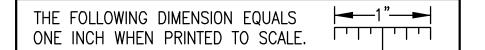
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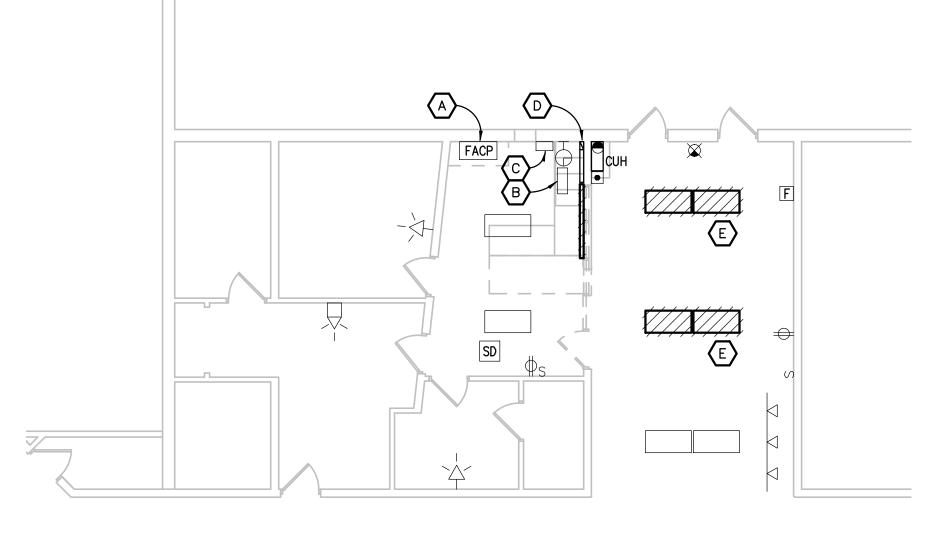
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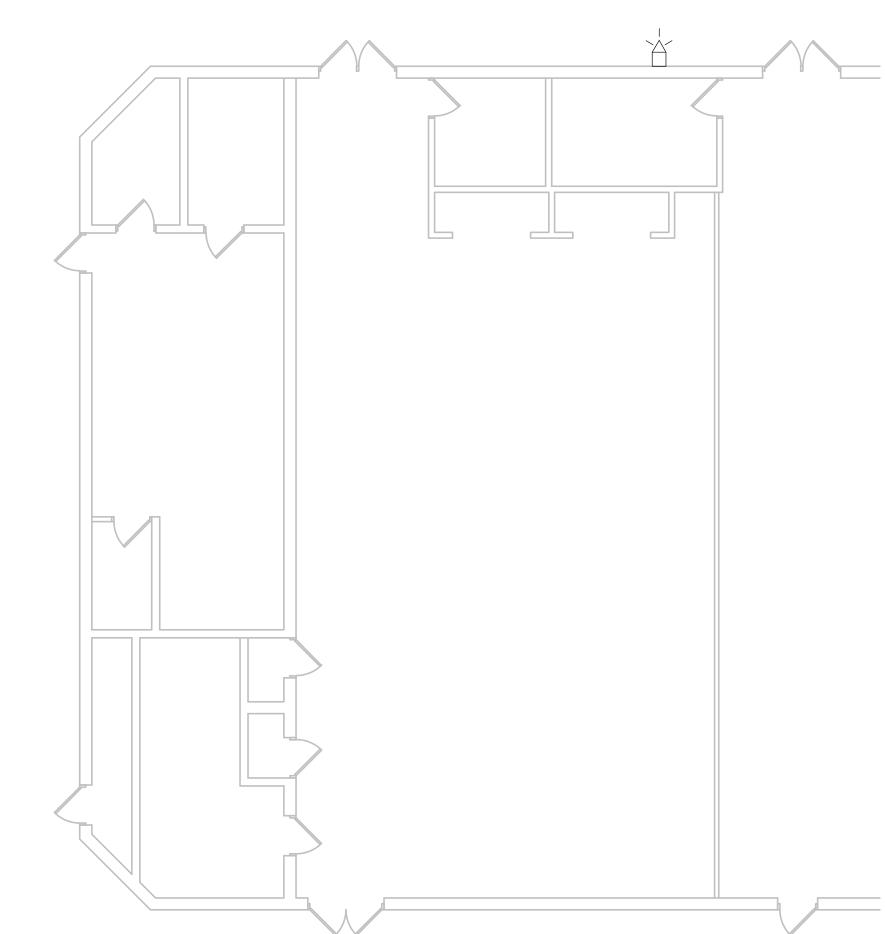
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PARTIAL ELECTRICAL DEMOLITION PLAN

GENERAL NOTES:

1. VISIT THE SITE PRIOR TO SUBMISSION OF BID TO EXAMINE THE EXISTING CONDITIONS AND THE EXTENT OF DEMOLITION WORK.

2. EXAMINE THE DRAWINGS OF OTHER TRADES AND BE FAMILIAR WITH THE DEMOLITION


- REQUIRED BY OTHER TRADES. PERFORM ALL INCIDENTAL ELECTRICAL DEMOLITION AND/OR RELOCATION REQUIRED TO FACILITATE THE DEMOLITION WORK OF OTHER TRADES, WHETHER OR NOT SPECIFICALLY INDICATED.
- 3. REMOVE LIGHTING FIXTURES AND ELECTRICAL DEVICES AS INDICATED ON PLAN WITH CROSS HATCHING. DEMOLITION SHALL INCLUDE, BUT NOT BE LIMITED TO, THOSE
- 4. COORDINATE WITH NEW WORK PLANS, ONE LINE DIAGRAMS AND RISER DIAGRAMS FOR EXTENT OF DEMOLITION WORK.
- 5. PROVIDE PROPER SUPPORT FOR EXISTING TO REMAIN CONDUITS AND BOXES WHERE EXISTING SUPPORT IS TO BE REMOVED. RE-ROUTE BRANCH CIRCUIT CONDUITS AND RELOCATE JUNCTION BOXES AS REQUIRED TO FACILITATE INSTALLATION OF NEW
- 6. REMOVE ALL CONDUIT AND WIRE BACK TO THE SOURCE OR NEAREST UPSTREAM DEVICE REMAINING IN SERVICE.

EQUIPMENT AND SYSTEMS IN CEILING SPACES.

- 7. MAINTAIN ELECTRICAL SERVICE TO ALL LIGHTING FIXTURES, DEVICES AND EQUIPMENT THAT ARE TO REMAIN. EXTEND CONDUIT AND WIRE AS REQUIRED WHERE DEMOLITION WORK AFFECTS ELECTRICAL SERVICE TO DOWNSTREAM LOADS THAT ARE TO REMAIN.
- 8. DISPOSE OF ALL MATERIALS OFF SITE AND INCLUDE ALL COSTS FOR DISPOSAL IN BID. ALL MATERIALS SHALL BE DISPOSED OF IN ACCORDANCE WITH ALL FEDERAL, STATE, AND LOCAL REGULATIONS, INCLUDING TCLP TESTING, PROPER DISPOSAL AND/OR RECYCLING OF FLUORESCENT LAMPS.
- 9. PROVIDE BLANK COVER PLATES WHERE SWITCHES AND DEVICES ARE REMOVED BUT EXISTING WALLS REMAIN INTACT.
- 10. RING OUT AND TAG ALL CIRCUITS AFFECTED BY THIS ALTERATION AT BOTH ENDS. MARK ALL UNUSED CIRCUIT BREAKERS "SPARE".
- 11. PROVIDE UPDATED TYPED-IN DIRECTORIES FOR ALL PANELS AFFECTED BY THIS ALTERATION.
- 12. VERIFY ALL UNDERGROUND AND IN SLAB UTILITY LOCATIONS PRIOR TO SAW-CUTTING OR PENETRATING ANY FLOOR SLAB.
- 13. COORDINATE ANY SHUT DOWN OF EXISTING SERVICES AND EQUIPMENT THAT ARE REMAINING IN USE WITH THE OWNER'S REPRESENTATIVE. WHERE EXISTING BUILDING SERVICE IS REQUIRED TO BE SHUT DOWN, INCLUDE ALL ASSOCIATED OVERTIME COSTS TO PERFORM THIS WORK DURING WEEKENDS AND EVENINGS INCLUDE ALL COSTS FOR PROVIDING TEMPORARY POWER WHERE SHUT DOWNS MUST OCCUR FOR PERIODS LONGER THAN THESE HOURS. COORDINATE ELECTRICAL SHUT DOWNS WITH THE OWNER 72 HOURS PRIOR TO SHUT DOWN.

DEMOLITION NOTES:

- A. FIRE ALARM CONTROL PANEL, NOTIFIER AFP 300.
- B. RELOCATE WEATHER/FIRE/BELL TOGGLE SWITCHES.
- C. DUKANE P.A. CONSOLE.
- D. PARTIAL WIREMOLD V4000 SHALL REMAIN. MODIFY AS INDICATED. CIRCUITING SHALL
- E. RELOCATE LIGHT FIXTURES.

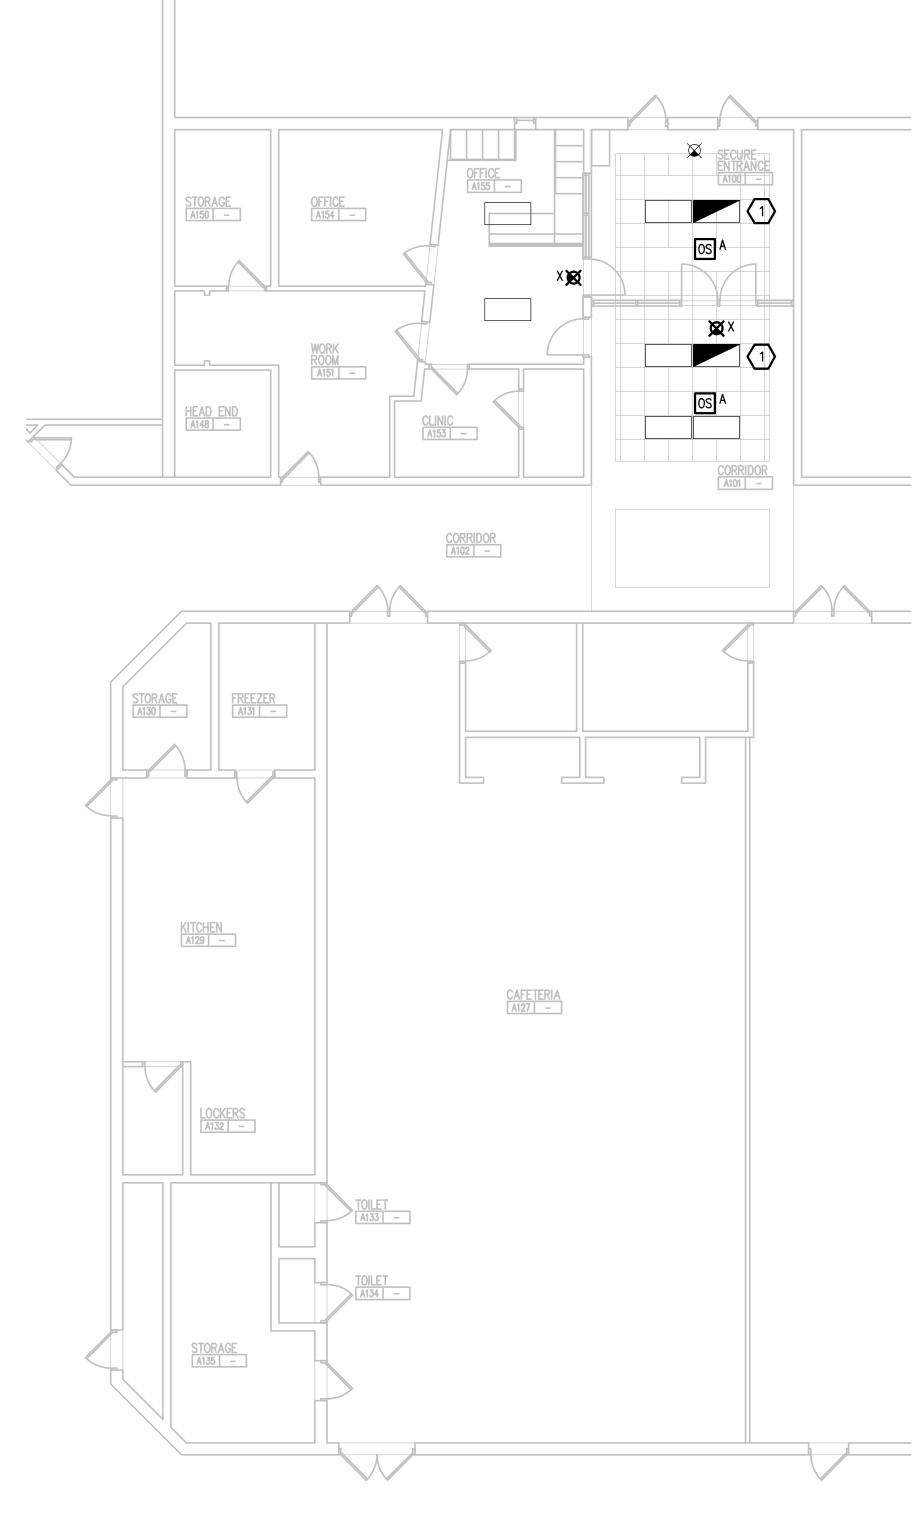




PARTIAL LIGHTING NEW WORK PLAN


GENERAL NOTES:

- 1. THESE DRAWINGS REPRESENT THE GENERAL EXTENT AND ARRANGEMENT OF SYSTEMS, BUT ARE NOT TO BE CONSIDERED FABRICATION DRAWINGS. COORDINATE WITH OTHER TRADES, AND PROVIDE EACH SYSTEM COMPLETE, INCLUDING ALL NECESSARY COMPONENTS, FITTINGS, AND OFFSETS.
- 2. INSTALL SYSTEMS SUCH THAT REQUIRED CLEARANCE AND SERVICE ACCESS SPACE IS PROVIDED AROUND ALL MECHANICAL AND ELECTRICAL EQUIPMENT, AND AROUND ANY COMPONENTS WHICH REQUIRE SERVICE ACCESS.
- 3. COORDINATE AND PROVIDE ACCESS DOORS WITHIN INACCESSIBLE CEILING, SHAFT, AND CHASE AREAS FOR ALL COMPONENTS WHICH REQUIRE SERVICE ACCESS. REFER

TO ARCHITECTURAL DRAWINGS FOR CEILING TYPES.

- 4. PROVIDE SUPPLEMENTARY STEEL AS REQUIRED FOR THE PROPER SUPPORT OF ALL
- 5. COORDINATE THE MOUNTING HEIGHTS OF DEVICES WITH ARCHITECTURAL ELEVATIONS AND THE TRADES INSTALLING THE WORK.
- 6. REFER TO MECHANICAL SCHEDULE SHEETS FOR ELECTRICAL REQUIREMENTS FOR MECHANICAL EQUIPMENT. PROVIDE ALL CONNECTIONS, STARTERS, DISCONNECTS, ETC. AS REQUIRED BY SCHEDULES AND WHERE NOTED ELSEWHERE. VERIFY REQUIREMENTS OF ALL MECHANICAL EQUIPMENT WITH SHOP DRAWINGS SUBMITTALS. NOTIFY ENGINEER OF ANY CONFLICTS BETWEEN EQUIPMENT SUBMITTALS AND ELECTRICAL DRAWINGS. WHERE CIRCUIT SIZES ARE SHOWN ON THE ELECTRICAL DRAWINGS THAT DIFFER FROM WHAT IS INDICATED ON THE MECHANICAL SCHEDULES, PROVIDE THE CIRCUIT OF HIGHER AMPACITY.
- 7. PROVIDE THE DESIGN AND INSTALLATION FOR A COMPLETE AND FUNCTIONAL FIRE ALARM SYSTEM IN ACCORDANCE WITH SPECIFICATIONS, DRAWINGS, AND ALL APPLICABLE CODES. THE FIRE ALARM VENDOR SHALL PROVIDE LAYOUT DRAWINGS INDICATING THE REQUIRED QUANTITIES AND LOCATIONS OF MANUAL PULL STATIONS, NOTIFICATION APPLIANCES, SMOKE AND HEAT DETECTORS, CONTROL MODULES, INTERFACE MODULES, MODULES FOR SPRINKLER FLOW AND TAMPER SWITCHES, ALL CONTROL PANELS, POWER SUPPLIES, ADDITIONAL DEVICES AND EQUIPMENT REQUIRED. COORDINATE LOCATIONS OF DEVICES WITH ARCHITECTURAL FINISHES AND REFLECTED CEILING PLANS, INCLUDING ADDITIONAL SMOKE AND HEAT DETECTORS REQUIRED FOR NON-SMOOTH CEILING APPLICATIONS. INCLUDE ALLOWANCES FOR ADJUSTMENT OF DEVICES BY THE ARCHITECT AT THE TIME OF SUBMITTAL TO COORDINATE WITH BUILDING FINISHES AND OTHER CEILING ELEMENTS.
- 8. CIRCUIT EXIT LIGHTS TO UNSWITCHED HOT LEG OF ADJACENT CIRCUIT SERVING

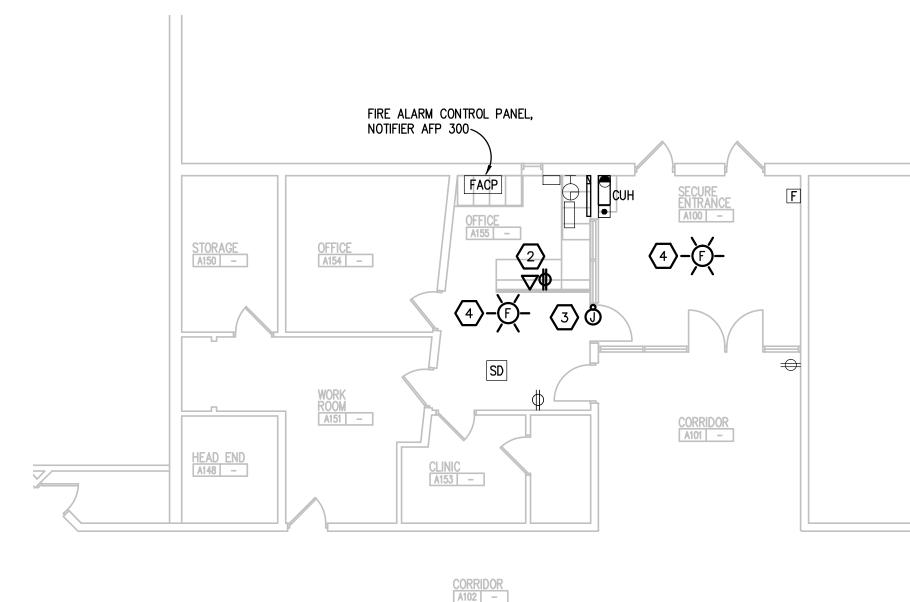

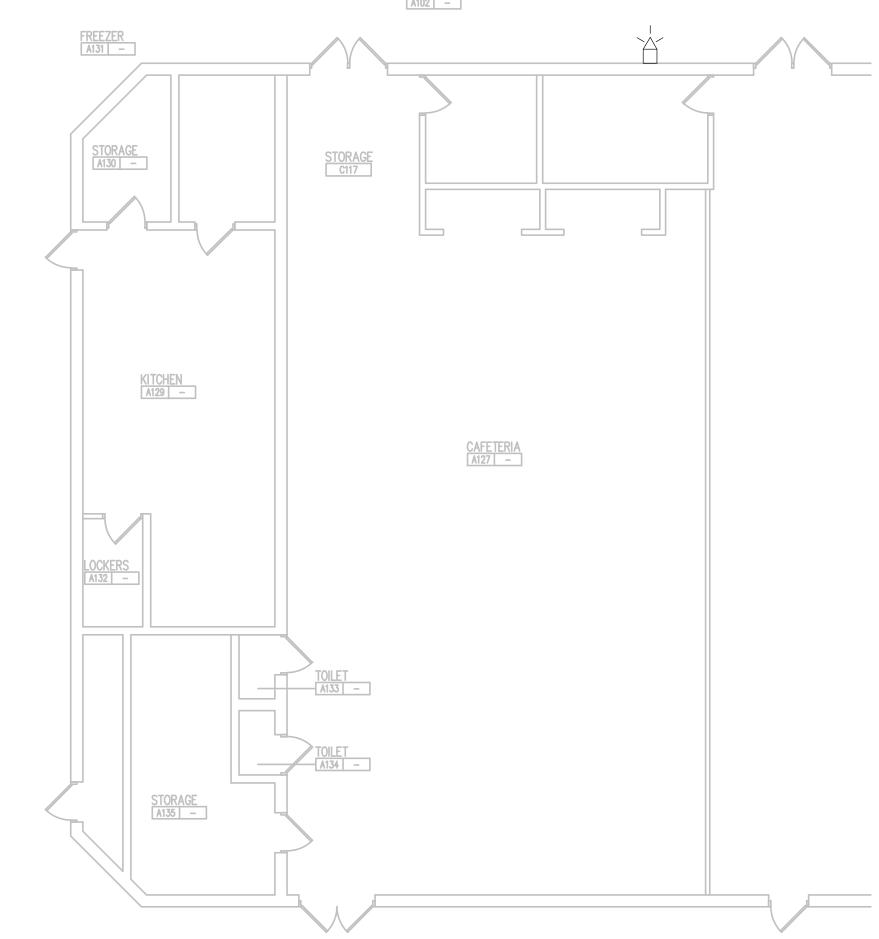



PARTIAL POWER NEW WORK PLAN

EXAMPLE 2 CONSTRUCTION KEY NOTES:

- 1. CIRCUIT LIGHTING TO MAINTAINED BRANCH CIRCUIT. MODIFY SWITCH LEG AS REQUIRED FOR EMERGENCY AND OCCUPANCY SENSOR. EXTEND CIRCUITING AS REQUIRED. PROVIDE GROUND WIRE PER NEC. PROVIDE EXISTING FIXTURE WITH NEW 1400 LUMEN EMERGENCY BATTERY UNIT. PROVIDE WITH VISIBLE TEST SWITCH,
- BODINE OR EQUAL. 2. EXTEND CIRCUIT AS REQUIRED FROM EXISTING WIREMOLD V4000.
- 3. PROVIDE 1/2"CONDUIT INTO DOOR FRAME FROM ACCESSIBLE CEILING FOR ELECTRIC DOOR STRIKE. COORDINATE WIRING REQUIREMENTS WITH DOOR HARDWARE CONTRACTOR. EXTEND EXISTING 120V CIRCUIT FROM ADA DOOR TO NEW JUNCTION BOX IN CEILING SPACE ABOVE DOOR. WIRING TO DOOR CONTROLS BY OTHERS.
- 4. PROVIDE SYNC MODULE SO THAT ALL NEW AND EXISTING FA NOTIFICATION DEVISES THAT ARE VISIBLE SYNC PER NFPA. COORDINATE WITH NOTIFIER FOR ALL REQUIRED PARTS AND PIECES.



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REGISTRATION SEAL

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PROJECT TITLE

Allen Elementary Remodel

Southgate Community Schools Southgate, Michigan

DRAWING TITLE PARTIAL ELECTRICAL **PLANS**

ISSUE DAT	E3
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04-04-16	BP No. 2-BIDS


DATE:	ISSUED FOR:
DRAWN	SC
CHECKED	GJZ

APPROVED GJZ

PROJECT NO.

DRAWING NO.

THE FOLLOWING DIMENSION EQUALS
ONE INCH WHEN PRINTED TO SCALE.

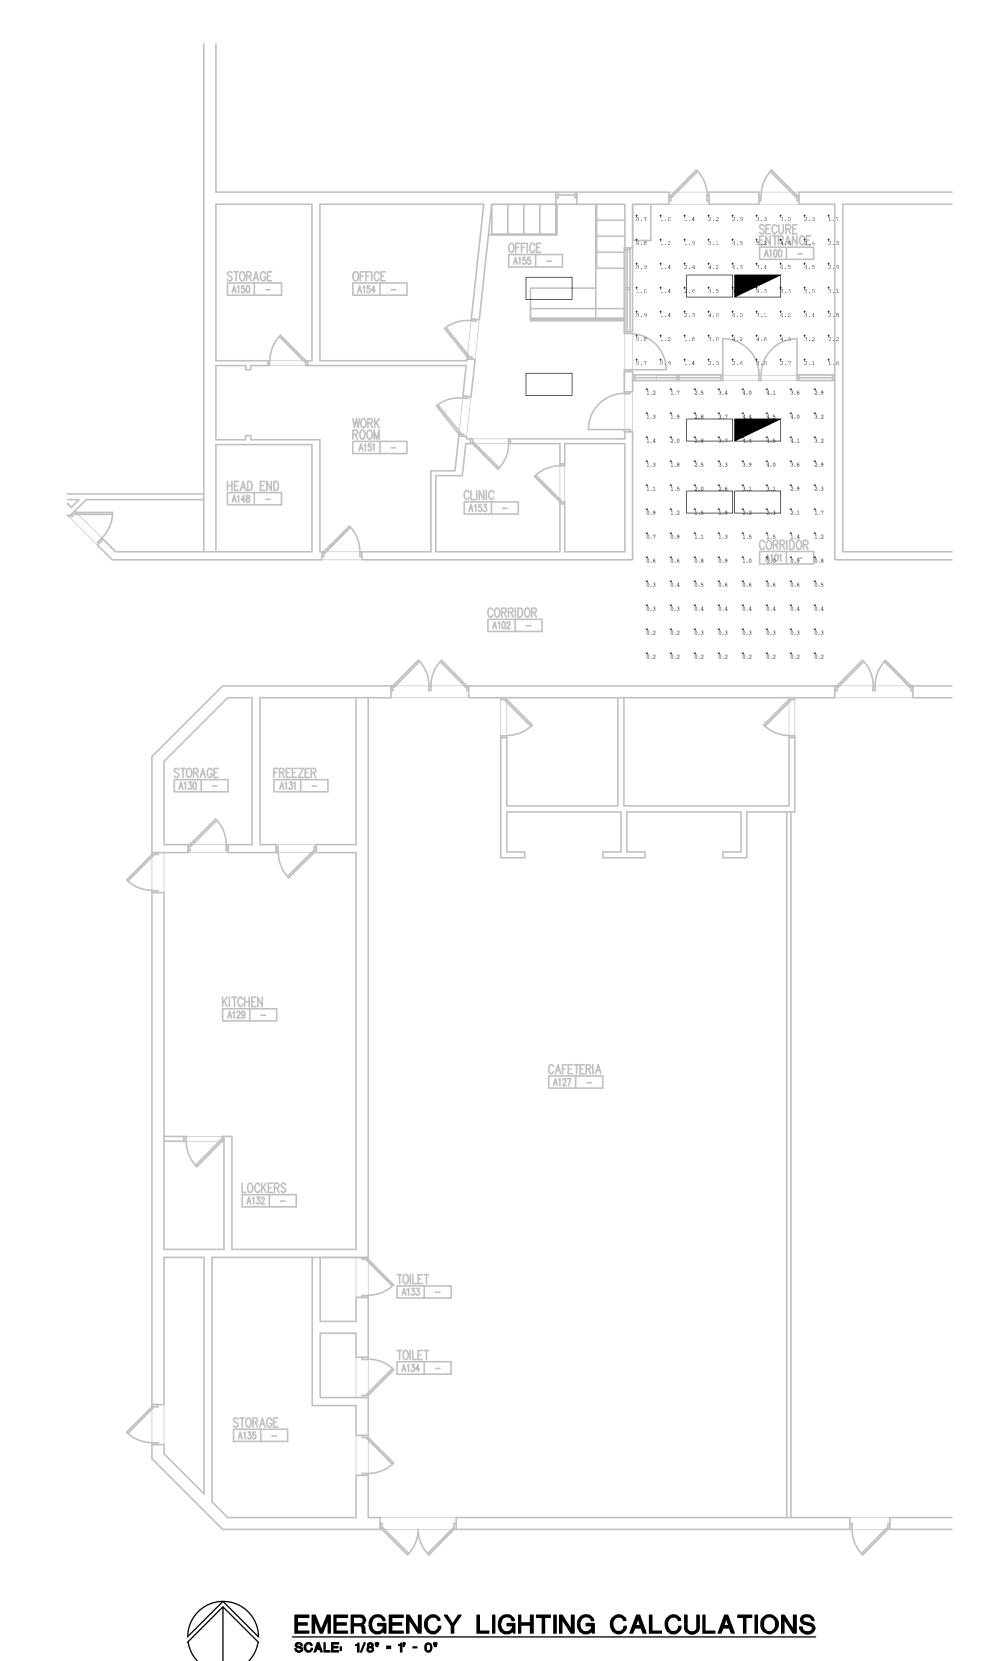

Label	CalcType	Units	Avg	Max	Min	Avg/Min	Max/Min
Corridor A101_Floor	Illuminance	FC	1.65	4.5	0.2	8.25	22.50
Secure Entrance A100_Workplane	Illuminance	Fc	3.17	8.3	0.7	4.53	11.86



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PROJECT TITLE

Allen Elementary Remodel

Southgate Community Schools Southgate, Michigan

DRAWING TITLE
EMERGENCY LIGHTING
CALCULATIONS

ISSUE DAT	ES
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04 04 16	DD No. 2 DIDC

DATE: ISSUED FOR:

CHECKED GJZ

APPROVED GJZ

APPROVED G

PROJECT NO. 16009

DRAWING NO.

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