ADDENDUM

Project Name:	Kosciuszko Middle School Toilet Room Upgrades	Addendum No:	One (1)
Project Number:	16-118	Issue Date:	April 29, 2016
Project Location:	Hamtramck, Michigan		

To the Contract Documents for the requested Kosciuszko Middle School Toilet Room Upgrades

This Addendum forms a part of the above described Contract Documents and supersedes, supplements or clarifies parts thereof to the extent defined by the terms set forth in this Addendum.

This addendum consists of (2) typed pages and the following attachments:

Drawings:	Architectural: A0-04, A3-01, A4-01 and A9-01 (4 drawings)
	Mechanical: P100 and P101 (2 drawings)
	Electrical: E101 and E600 (2 drawing)

SPECIFICATIONS

Item SP1	Specification Section 000200 – Material Finish / Color Schedule (Issued) A. Added Material Finish / Color Schedule in it's entirety
	URAL DRAWINGS:
Item A1	Drawing A0-04; Schedules, Door, Frame and Wall Types (revised and reissued this Addendum) A. Revised Room Finish Schedule as indicated B. Added signage schedule and details

Item A2	 Drawing A3-01; Partial New Work Floor Plans (revised and reissued this Addendum) A. Revised floor plans as indicated B. Added interior elevation C. Added section detail 6/A3-01
Item A3	Drawing A4-01; Partial Reflected Ceiling Plans (revised and reissued this Addendum) A. Revised ceiling plans as indicated
Item A4	Drawing A9-01; Partial Reflected Ceiling Plans (revised and reissued this Addendum) A. Revised finish floor plans as indicated

MECHANICAL DRAWINGS:

- Item M1 Drawing P-100; Partial Underground Plumbing Plan (revised and reissued this Addendum) A. Add electric water cooler (EWC-1) sanitary piping Area A
 - B. Clarify EWC-1 sanitary piping in Area B

	C. Revised domestic hot water and cold water piping serving boys and girls restrooms in Area A and Area B to route underground.D. Revised key note 1 to include hot and cold water piping
Item M2	Drawing P-101 First Floor Plumbing Plan (revised and reissued this Addendum) A. Added electric water cooler (EWC-1) in Area A
	B. Revised domestic hot and cold water piping serving the boys and girls restrooms in Areas A and B to route underground

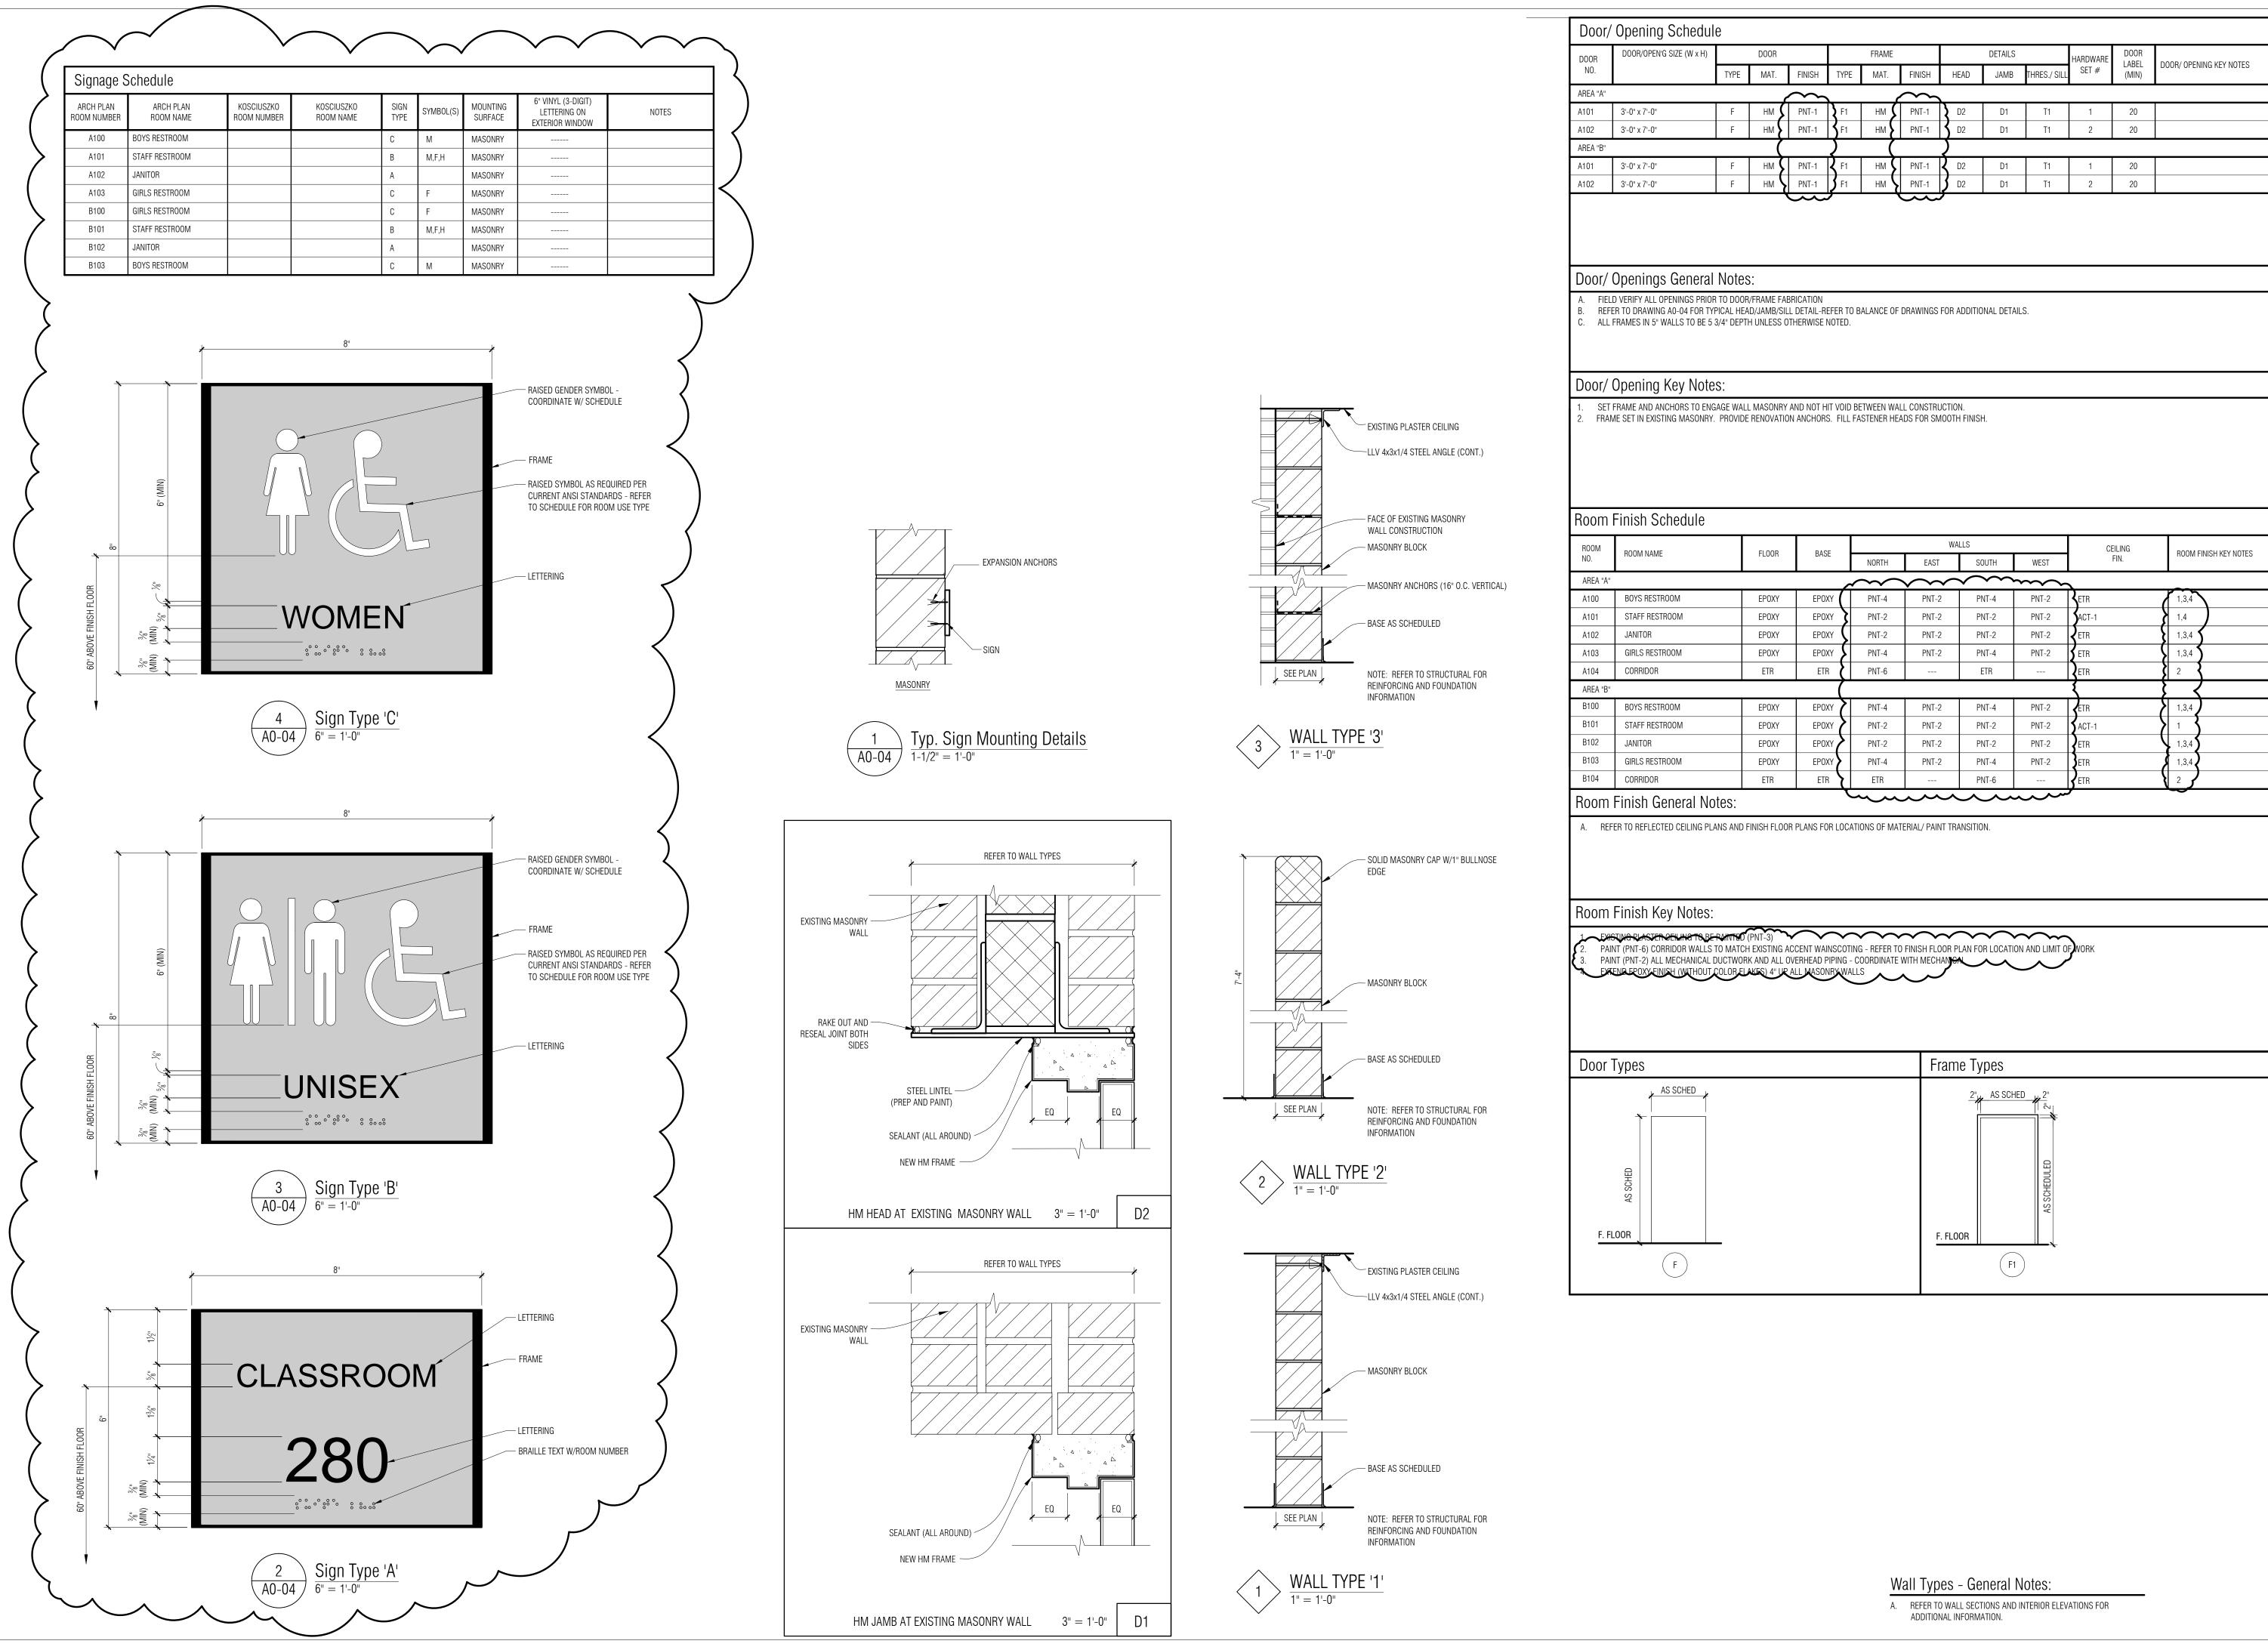
ELECTRICAL DRAWINGS:

- Item E1Drawing E101; Partial First Floor Electrical Plan (revised and reissued this addendum)A. Added EWC-1 in Area A
 - B. Added receptacle and key note for Alternate No.1
- Item E1Drawing E-600; Electrical, Details and Schedules (revised and reissued this addendum)A. Update panel schedule to accommodate modifications to plans

END OF ADDENDUM

MATERIAL FINISH / COLOR SCHEDULE

Spec Section	ltem	Description	Product Specified	Finish / Color	Location (refer to drawings for exact locations)	Remarks
099123	INTERIOR I	PAINTING				
	PNT-1	Paint	Sherwin Williams	SW6531 - Indigo	Door and Frames	
	PNT-2	Paint	Sherwin Williams	SW7557 - Summer White	Wall - Field	
	PNT-3	Paint	Sherwin Williams	SW7005 - Pure White	Ceilings	
	PNT-4	Paint	Sherwin Williams	SW6387 - Compatible Cream	Walls - Accent	
	PNT-5	Paint	Sherwin Williams	SW7005 - Pure White	Ceilings	
	PNT-6	Paint	Sherwin Williams	Match existing accent wainscoting	Corridor	
	PNT-7	Paint	Performance Epoxy Coat	Refer to spec	Toilet Rooms, Janitor	



	DOOR			FRAME			DETAILS		HARDWARE	DOOR LABEL	
YPE	MAT.	FINISH	TYPE	MAT.	FINISH	HEAD	JAMB	THRES./ SILL	SET #	(MIN)	DOOR/ OPENING KEY NOTES
F	нм 🖌	PNT-1	F 1	нм 🖌	PNT-1	D 2	D1	T1	1	20	
F	нм 🖌	PNT-1	S F1	НМ 🖌	PNT-1	5 D2	D1	T1	2	20	
	(\sum	(\sum					
F	нм 🖌	PNT-1	Հ F1	нм 🖌	PNT-1	ζ D2	D1	T1	1	20	
F	нм 🖌	PNT-1	5 F1	нм 🝾	PNT-1	5 D2	D1	T1	2	20	
		$\overline{}$,			/					

	DAOF		WA	ILLS	CEILING		
FLOOR	BASE	NORTH	EAST	EAST SOUTH		FIN.	ROOM FINISH KEY NOTES
		$\sim\sim$	\sim	\sim	\sim	\mathbf{c}	
EPOXY	EPOXY	PNT-4	PNT-2	PNT-4	PNT-2	ETR	1,3,4
EPOXY	EPOXY	PNT-2	PNT-2	PNT-2	PNT-2	ACT-1	1,4
EPOXY	EPOXY	PNT-2	PNT-2	PNT-2	PNT-2	ETR	1,3,4
EPOXY	EPOXY	PNT-4	PNT-2	PNT-4	PNT-2	S ETR	1,3,4
ETR	ETR 🕻	PNT-6		ETR		ETR	2
	(4	\rightarrow \langle
EPOXY	EPOXY	PNT-4	PNT-2	PNT-4	PNT-2	ETR	1,3,4
EPOXY	EPOXY	PNT-2	PNT-2	PNT-2	PNT-2	ACT-1) 1)
EPOXY	EPOXY	PNT-2	PNT-2	PNT-2	PNT-2	ETR	1,3,4
EPOXY	EPOXY	PNT-4	PNT-2	PNT-4	PNT-2	ETR	1,3,4
ETR	ETR Y	ETR		PNT-6		ETR	2

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KEY PLAN

OWNER Hamtramck Public Schools

PROJECT NAME

Kosciuszko Middle School Toilet Room Upgrades

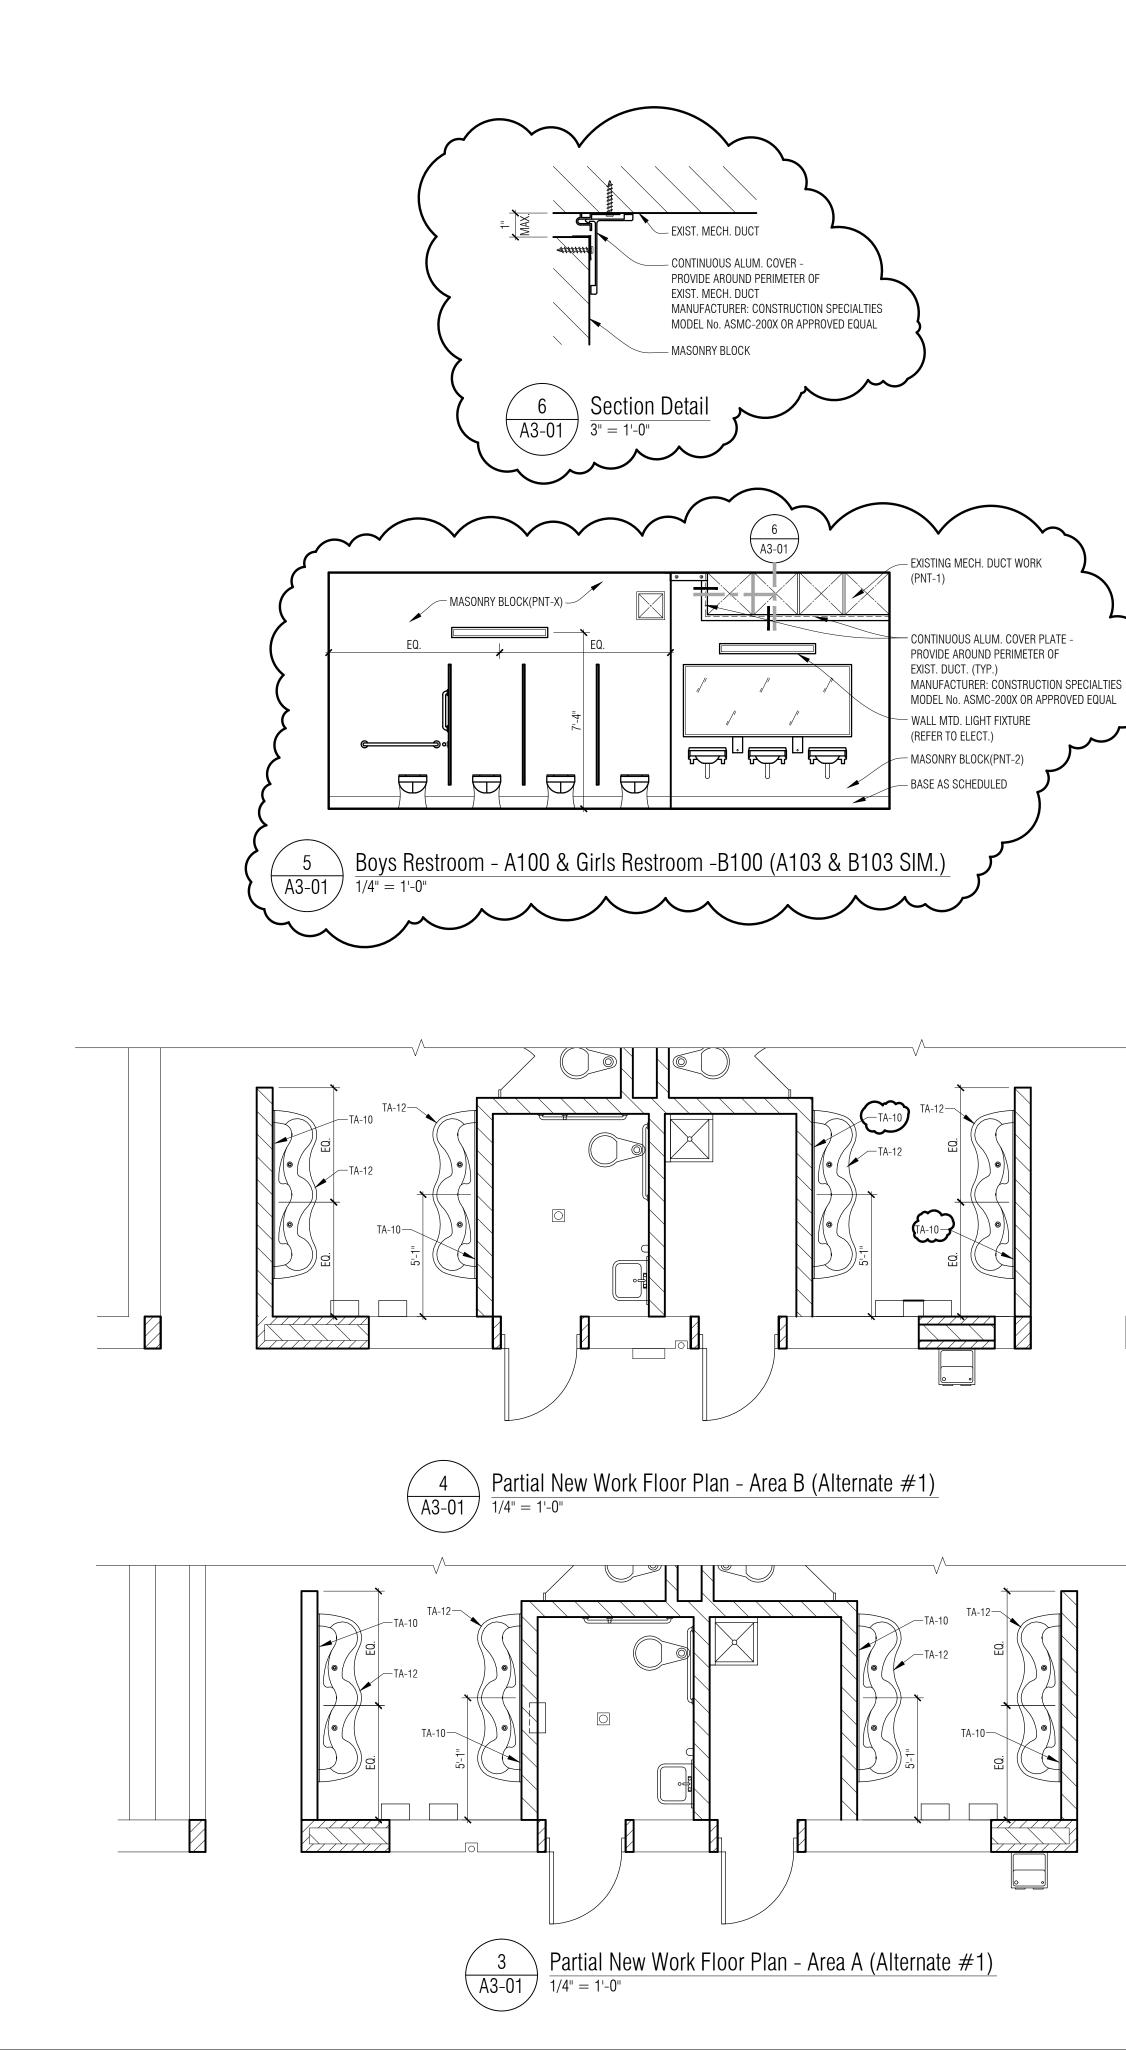
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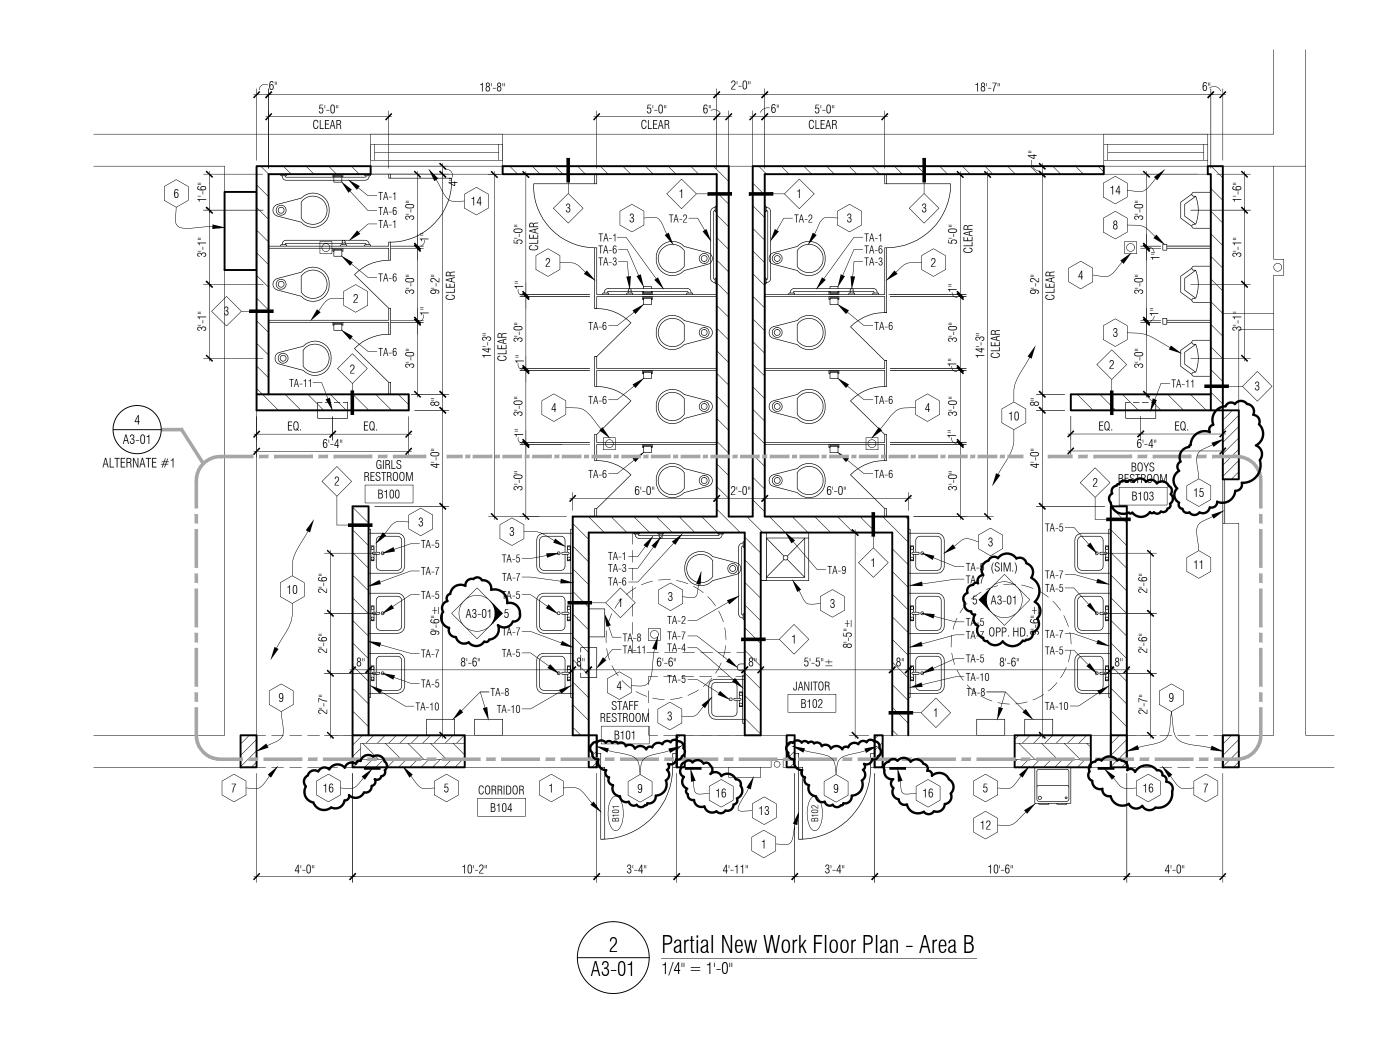
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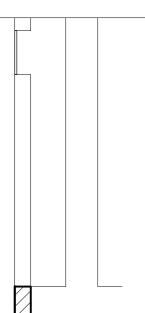
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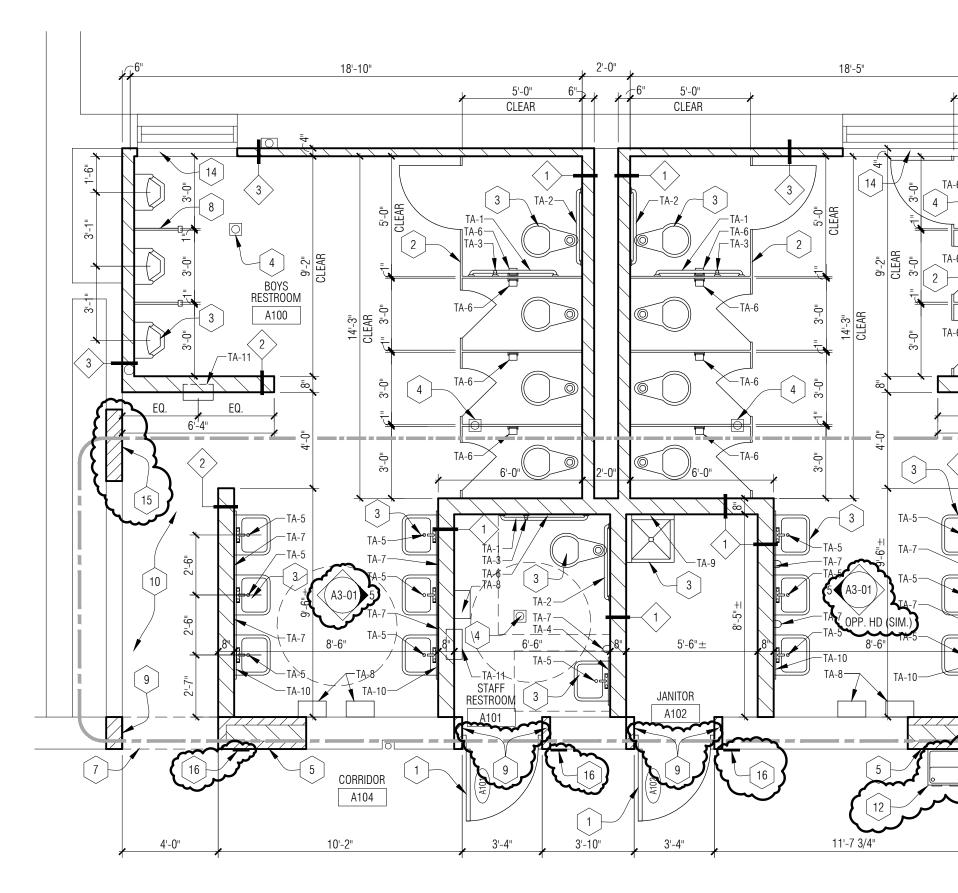
drawn by JTS
CHECKED BY ACS
APPROVED BY MAM
SHEET NAME SCHEDULES, DOOR, FRAME & WALL TYPES

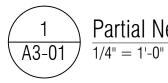
SHEET NO. A0-04











Partial New Work Floor Plan - Area A

FLOOR PLAN - GENERAL NOTES:

- A. ALL PLAN DIMENSIONS ARE NOMINAL TO FACE OF WALL. WALL THICKNESSES ARE SHOWN NOMINAL - SEE WALL TYPES FOR ACTUAL THICKNESS.
- B. COORDINATE SIZE AND LOCATION OF ALL DUCT, SHAFT AND LOUVER OPENINGS IN WALLS AND FLOORS WITH MECHANICAL AND ELECTRICAL. PROVIDE ALL REQUIRED LINTELS FOR OPENINGS.
- C. ALL EXPOSED CORNERS OF MASONRY BLOCK ARE TO BE BULLNOSED.
- D. DO NOT SCALE DRAWINGS. USE DIMENSIONS PROVIDED. IF A CONFLICT IS ENCOUNTERED OR A REQUIRED DIMENSION IS NOT PROVIDED, REQUEST A CLARIFICATION FROM THE ARCHITECT.
- E. EXISTING MASONRY WALL INTERSECTIONS WHICH ARE LEFT EXPOSED AFTER DEMOLITION OF ADJACENT MASONRY CONSTRUCTION MUST BE PATCHED AND REPAIRED WITH NEW MASONRY OR EXISTING BRICK VENEER, TOOTH-IN TO MATCH EXISTING COURSING AND BOND PATTERN, TYPICAL AT ALL LOCATIONS.
- F. FIRE RATED PARTITIONS ARE INDICATED ON CODE PLANS.
- G. REFER TO MECHANICAL / ELECTRICAL DRAWINGS FOR INSTALLATION OF NEW EQUIPMENT, WIRING, ETC. AT EXISTING WALLS. ALL ITEMS ARE TO BE INSTALLED WITHIN EXISTING WALLS - REMOVE AND REINSTALL MASONRY (TOOTH-IN) AT ALL LOCATIONS.
- H. REFER TO MECHANICAL / ELECTRICAL DRAWINGS FOR REMOVAL OF EXISTING EQUIPMENT WITHIN EXISTING CONSTRUCTION -TOOTH-IN NEW MASONRY BLOCK AND AND PREP FOR NEW FINISH.
- I. FIELD VERIFY ALL EXISTING OPENINGS TO RECEIVE NEW WORK PRIOR TO FABRICATION OF ANY FRAME TYPES - NOTIFY ARCHITECT OF ANY DISCREPANCIES.

FLOOR PLAN - KEY NOTES:

- 1 NEW H.M. DOOR AND H.M. FRAME IN NEW OPENING REFER TO DOOR SCHEDULE - COORDINATE WITH FIELD CONDITIONS
- 2 TOILET PARTITION SYSTEM
- 3 PLUMBING FIXTURE COORDINATE WITH MECHANICAL
- 4 FLOOR DRAIN COORDINATE WITH MECHANICAL
- 5 TOOTH-IN NEW BRICK AND BLOCK MASONRY AT AREA OF REMOVED WALL TO MATCH EXISTING - COORDINATE WITH EXISTING FIELD CONDITIONS - MATCH BRICK COURSING
- 6 TOOTH-IN NEW BRICK AND BLOCK MASONRY AT AREA OF REMOVED DOOR AND FRAME TO MATCH EXISTING - COORDINATE WITH EXISTING FIELD CONDITIONS - MATCH BRICK COURSING
- 7 NEW OPENING IN EXISTING MASONRY WALL
- 8 URINAL SCREEN SYSTEM
- 9 TOOTH-IN NEW BRICK AT AREA OF NEW MASONRY OPENING TO MATCH EXISTING - COORDINATE WITH EXISTING FIELD CONDITIONS - MATCH EXISTING BRICK COURSING
- 10 NEW EPOXY FLOOR FINISH

5'-0" CLEAR

GIRLS RESTROOM

A103

4'-0"

-{ 5]

A3-01

ALTERNATE #1

- 11 NEW WALL RETURN AIR GRILLE (LOW ON WALL) PAINT TO MATCH WALL COLOR
- 12 NEW DRINKING FOUNTAIN COORDINATE WITH MECHANICAL
- 13 EXISTING ELECTRICAL PANEL PROTECT DURING CONSTRUCTION PHASE
- SOLID MASONRY BLOCK WINDOW SILL W/ 1" BUL

TOOTH-IN NEW BRICK AND BLOCK MASONRY AT AREA OF REMOVED EXHAUST FAN (HIGH ON WALL) COORDINATE WITH MECHANICAL

- 16 ROOM IDENTIFICATION SIGNAGE REFER TO DRAWING A0-04 FOR SCHEDULE AND DETAILS

LEGEND - TOILET ACCESSORIES

- TA-1 42" GRAB BAR (HORIZONTAL)
- TA-2 36" GRAB BAR (HORIZONTAL)
- TA-3 18" GRAB BAR (VERTICAL)
- TA-4 24"W X 36"H MIRROR
- TA-5 UNDER-LAVATORY GUARD
- TA-6 TOILET TISSUE DISPENSER
- TA-7 SOAP DISPENSER
- TA-8 ELECTRIC HAND DRYER
- TA-9 MOP AND BROOM HOLDER 3 HOLDERS
- TA-10 36"H x 84"W MIRROR
- TA-11 SEMI-RECESSED WASTE RECEPTACLE
- TA-12 LAVATORY SYSTEM SEE MECHANICAL (ALTERNATE #1)

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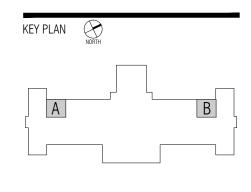
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OWNER

Hamtramck Public Schools

PROJECT NAME

Kosciuszko Middle School Toilet Room Upgrades

2333 Burger Hamtramck, MI 48212

PROJECT NO.

16-118

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04/29/2016

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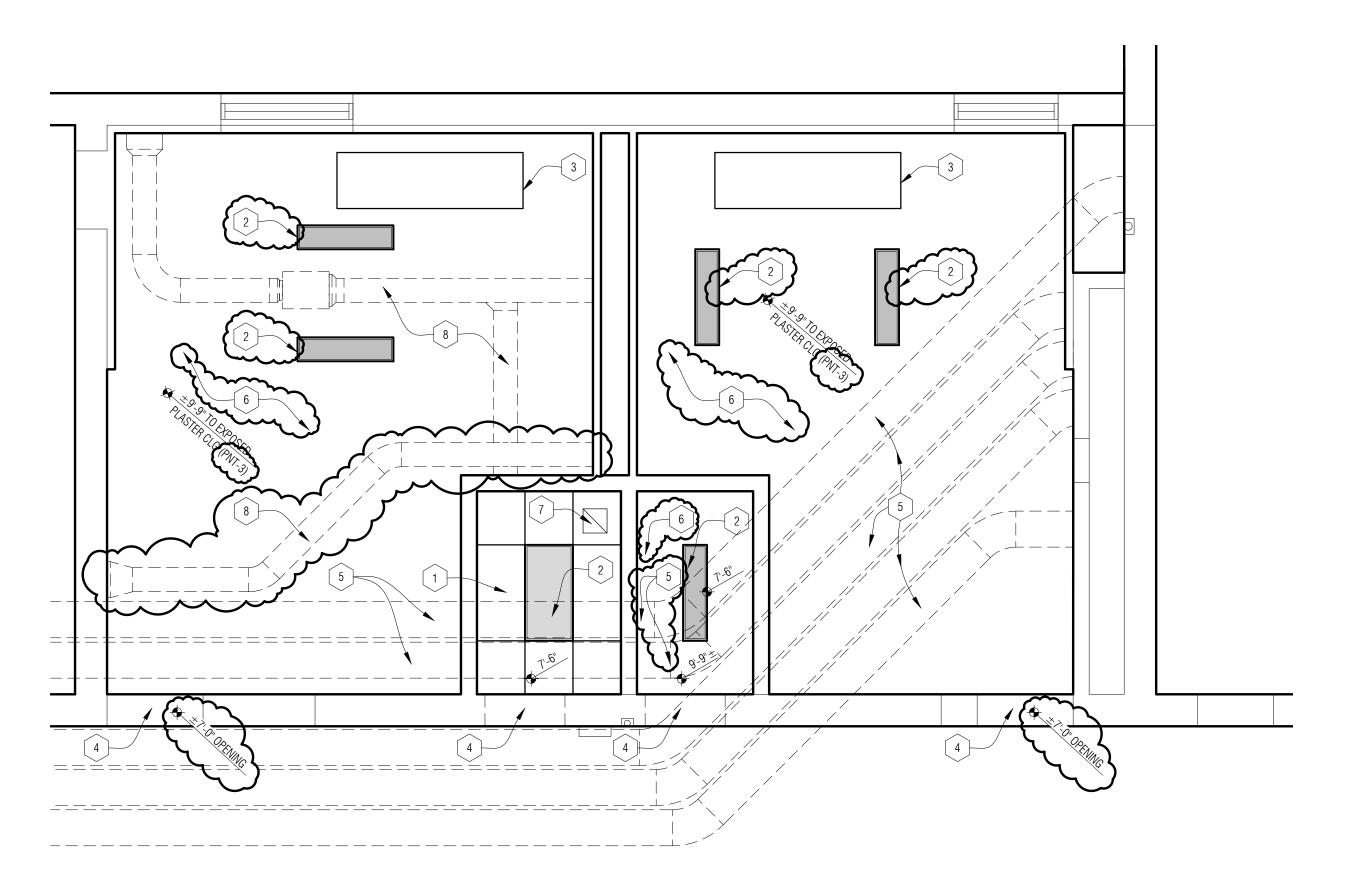
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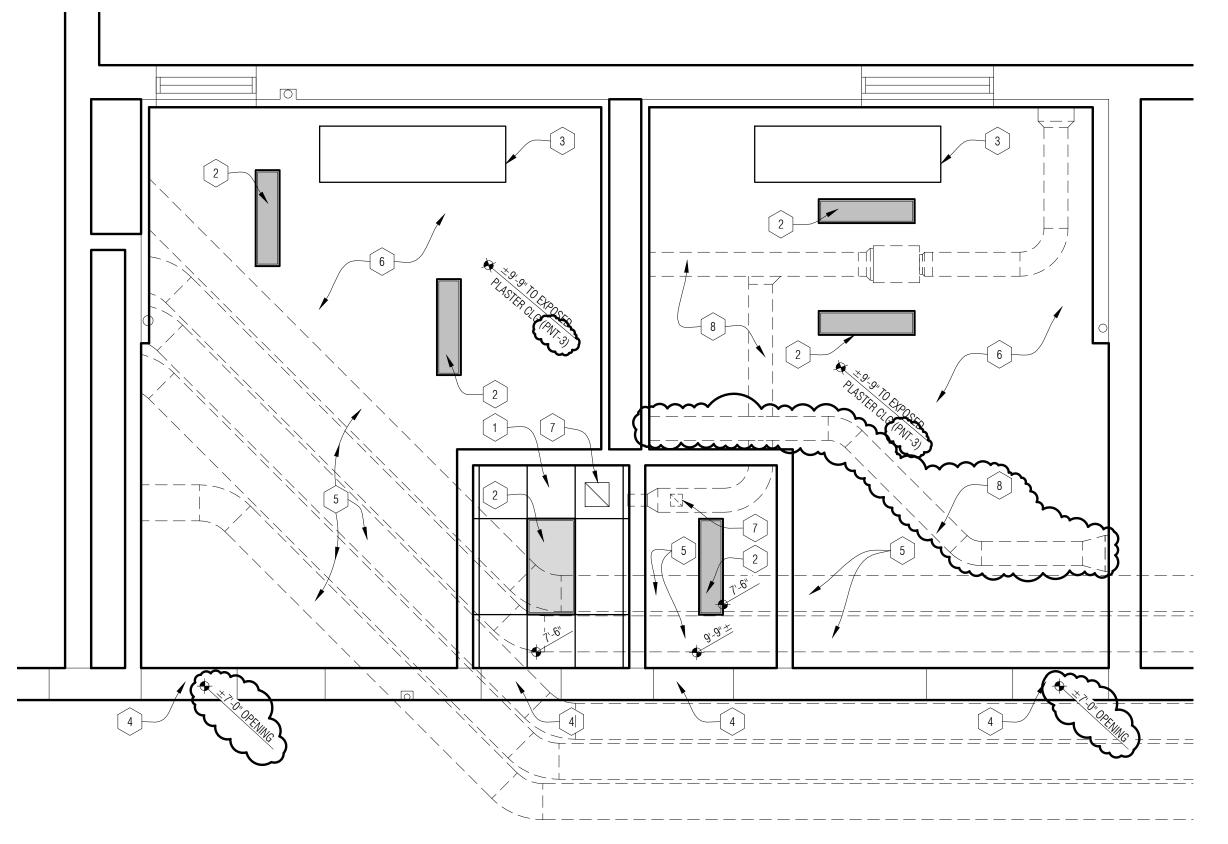
ACS

APPROVED BY MAM

SHEET NAME

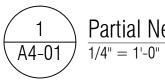
PARTIAL NEW WORK FLOOR PLANS







 $2 \\ A4-01$ Partial Reflected Ceiling Plan - Area B $\frac{1}{1/4"} = 1'-0"$



Partial New Work Floor Plan - Area A

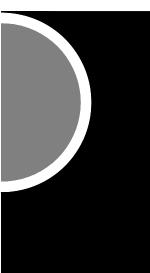
REFLECTED CEILING PLAN - GENERAL NOTES:

- A. REFER TO FLOOR PLANS FOR ROOM NAMES, NUMBERS AND ROOM DIMENSIONS.
- B. REFER TO ELECTRICAL FOR LIGHT FIXTURE TYPES AND SPECIFICATIONS.
- C. REFER TO MECHANICAL FOR DIFFUSERS, REGISTERS, AND RETURNS.
- D. ALL LIGHT FIXTURES ARE TO BE CENTERED WITHIN CEILING TILE AND GYP SOFFIT U.O.N.
- E. CEILING GRID IS TO BE CENTERED IN ROOM U.O.N.
- F. COORDINATE EXACT LOCATION OF LIGHT FIXTURES BETWEEN TRADES

REFLECTED CEILING PLAN - KEY NOTES:

- ACOUSTICAL CEILING TILE AND GRID (ACT-1).
- 2 LIGHT FIXTURE COORDINATE WITH ELECTRICAL
- 3 EXISTING CEILING MOUNTED RADIATOR TO REMAIN PREP AND
- CLEAN MTL TO RECEIVE NEW PAINT COLOR PAINT COMPLETE INCLUDING ALL HANGERS, BRACKETS, ETC. (PNT-2).
- 4 EXPOSED STEEL LINTEL PAINT TO MATCH ADJACENT MASONRY.
- 5 EXISTING DUCTWORK TO REMAIN PREP AND CLEAN MTL TO RECEIVE NEW PAINT COLOR - PAINT COMPLETE INCLUDING ALL HANGERS, BRACKETS, ETC (PNT-2).
- 6 EXISTING PLASTER TO REMAIN PREP AND CLEAN CEILING TO RECEIVE NEW PAINT COLOR - PAINT COMPLETE INCLUDING ALL HANGERS, BRACKETS, ETC. (PNT-2). PATCH AND REPAIR CEILING AS NEEDED FROM DEMOLITION AND NEW WORK - COORDINATE WITH MECHANICAL AND ELECTRICAL FOR LOCATION AND LIMIT OF WORK
- 7 EXHAUST FAN REFER TO MECHANICAL
- [8] NEW DUCTWORK (PNT-2) REFER TO MECHANICAL

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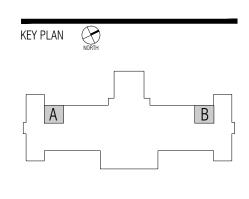
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04/29/2016

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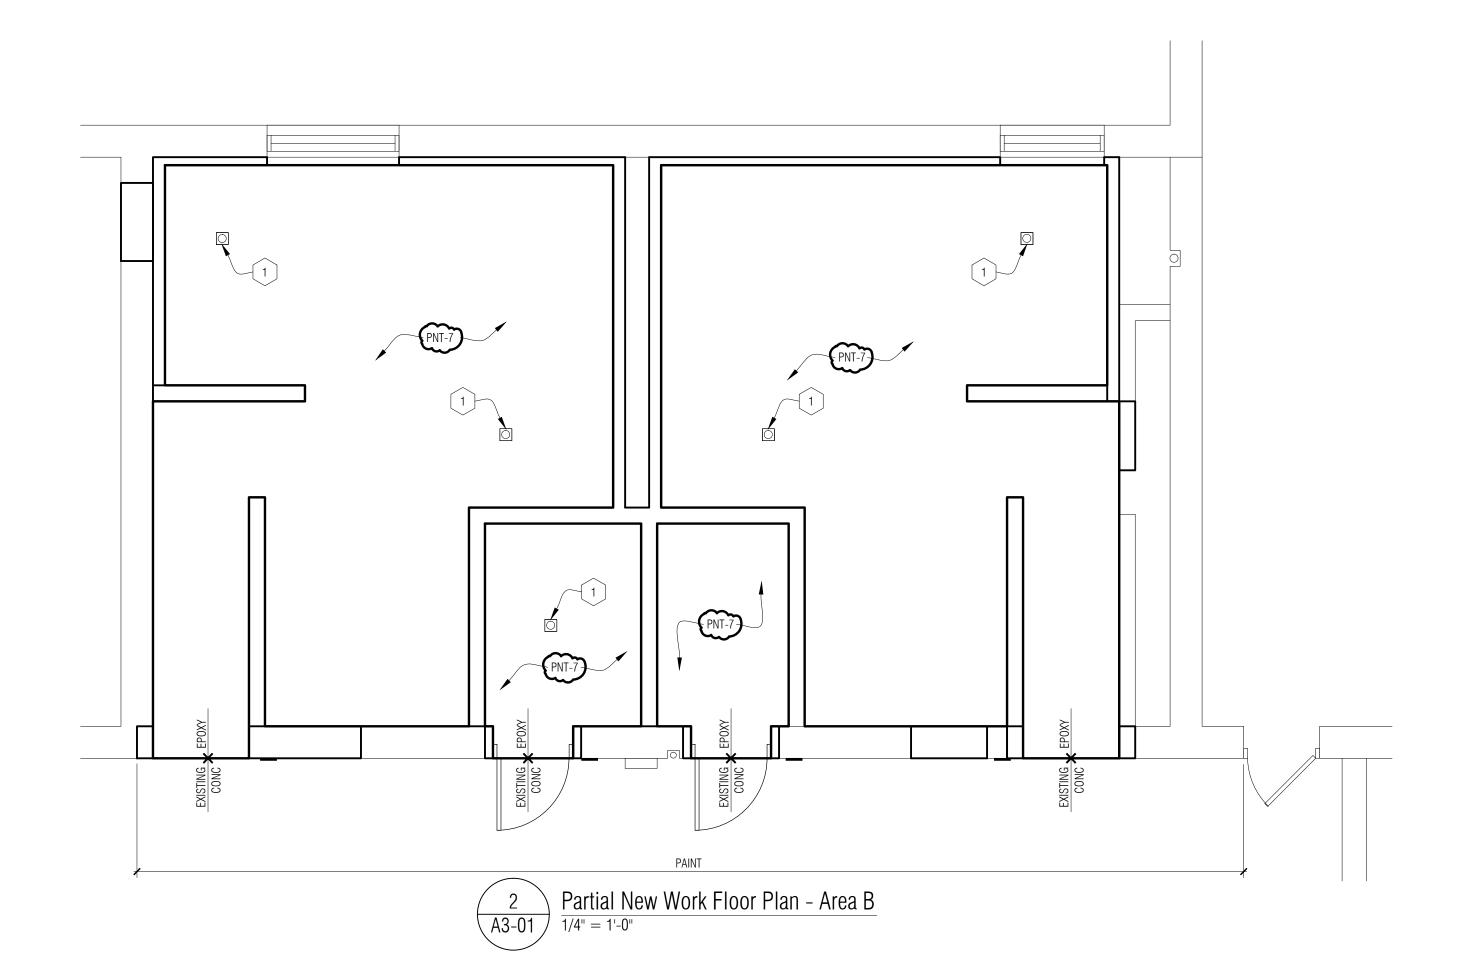
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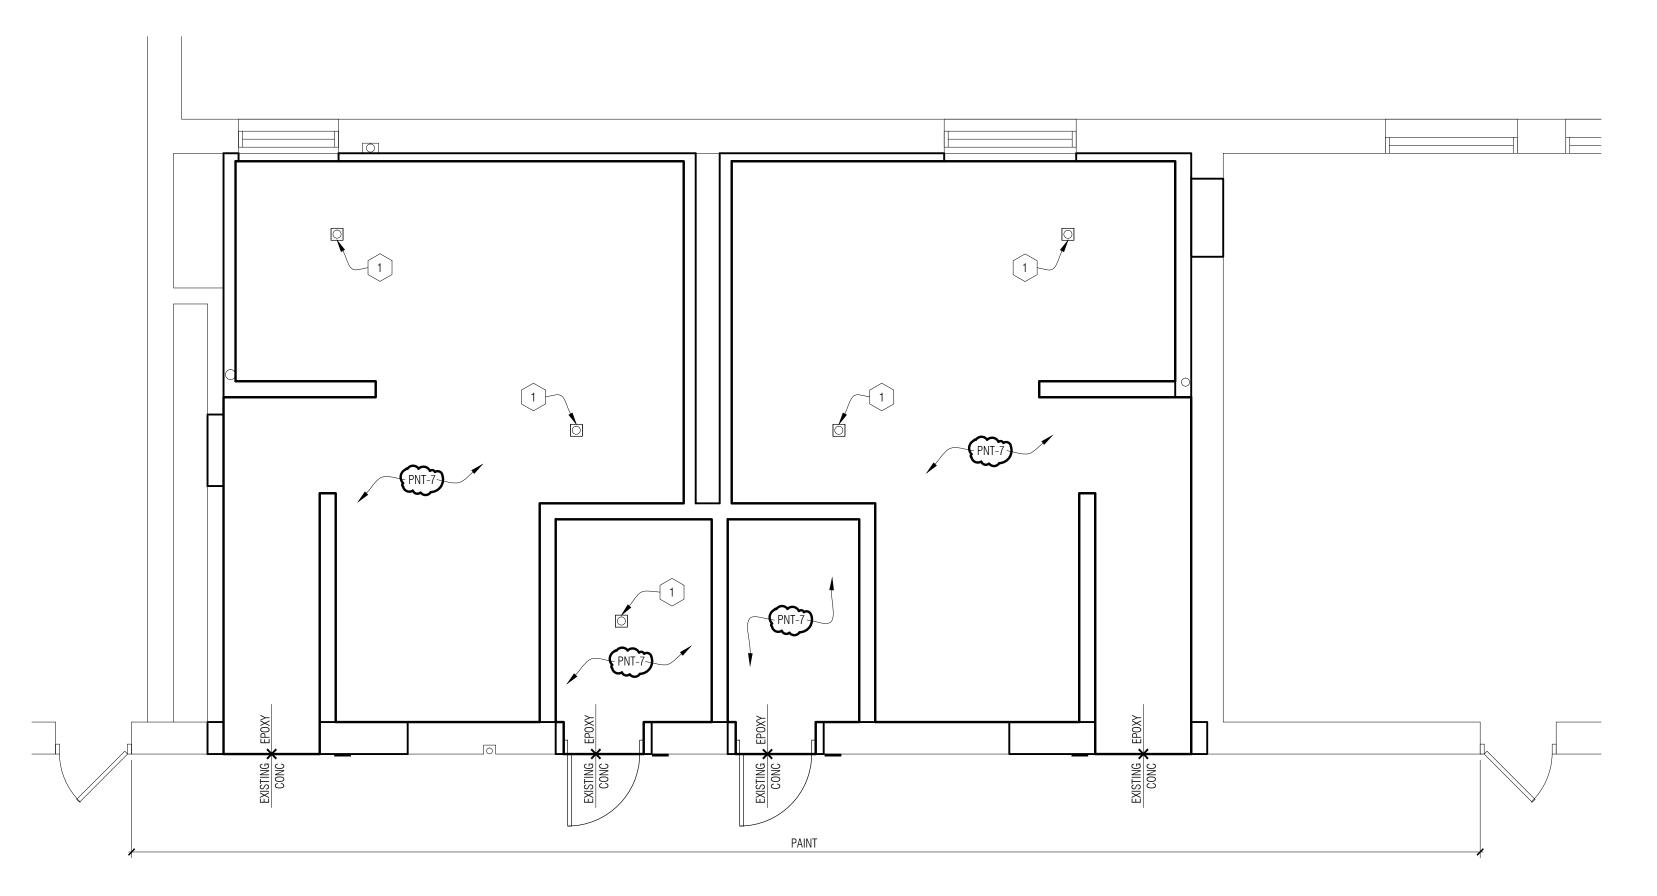
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SHEET NAME

PARTIAL REFLECTED CEILING PLANS

SHEET NO. A4-01





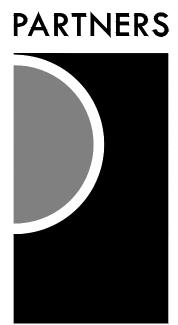
 $\begin{array}{c} 1\\ \hline A3-01 \end{array} \begin{array}{c} Partial New Work Floor Plan - Area A\\ \hline 1/4" = 1'-0" \end{array}$

FINISH FLOOR PLAN - GENERAL NOTES:

- A. REFERENCE ROOM FINISH SCHEDULE AND MATERIAL FINISH / COLOR SCHEDULE (SPEC SECTION 000200) FOR ADDITIONAL FINISH INFORMATION.
- B. UNLESS OTHERWISE NOTED, FLOOR FINISHES TRANSITION UNDER THE CENTERLINE OF DOORS (WHEREVER APPLICABLE).

FINISH FLOOR PLAN - KEY NOTES:

1 FLOOR DRAIN - REFER TO MECH. PROVIDE POSITIVE SLOPE TO DRAIN - VERIFY LOCATION IN FIELD



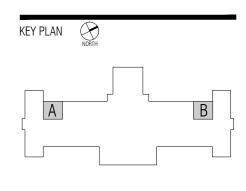
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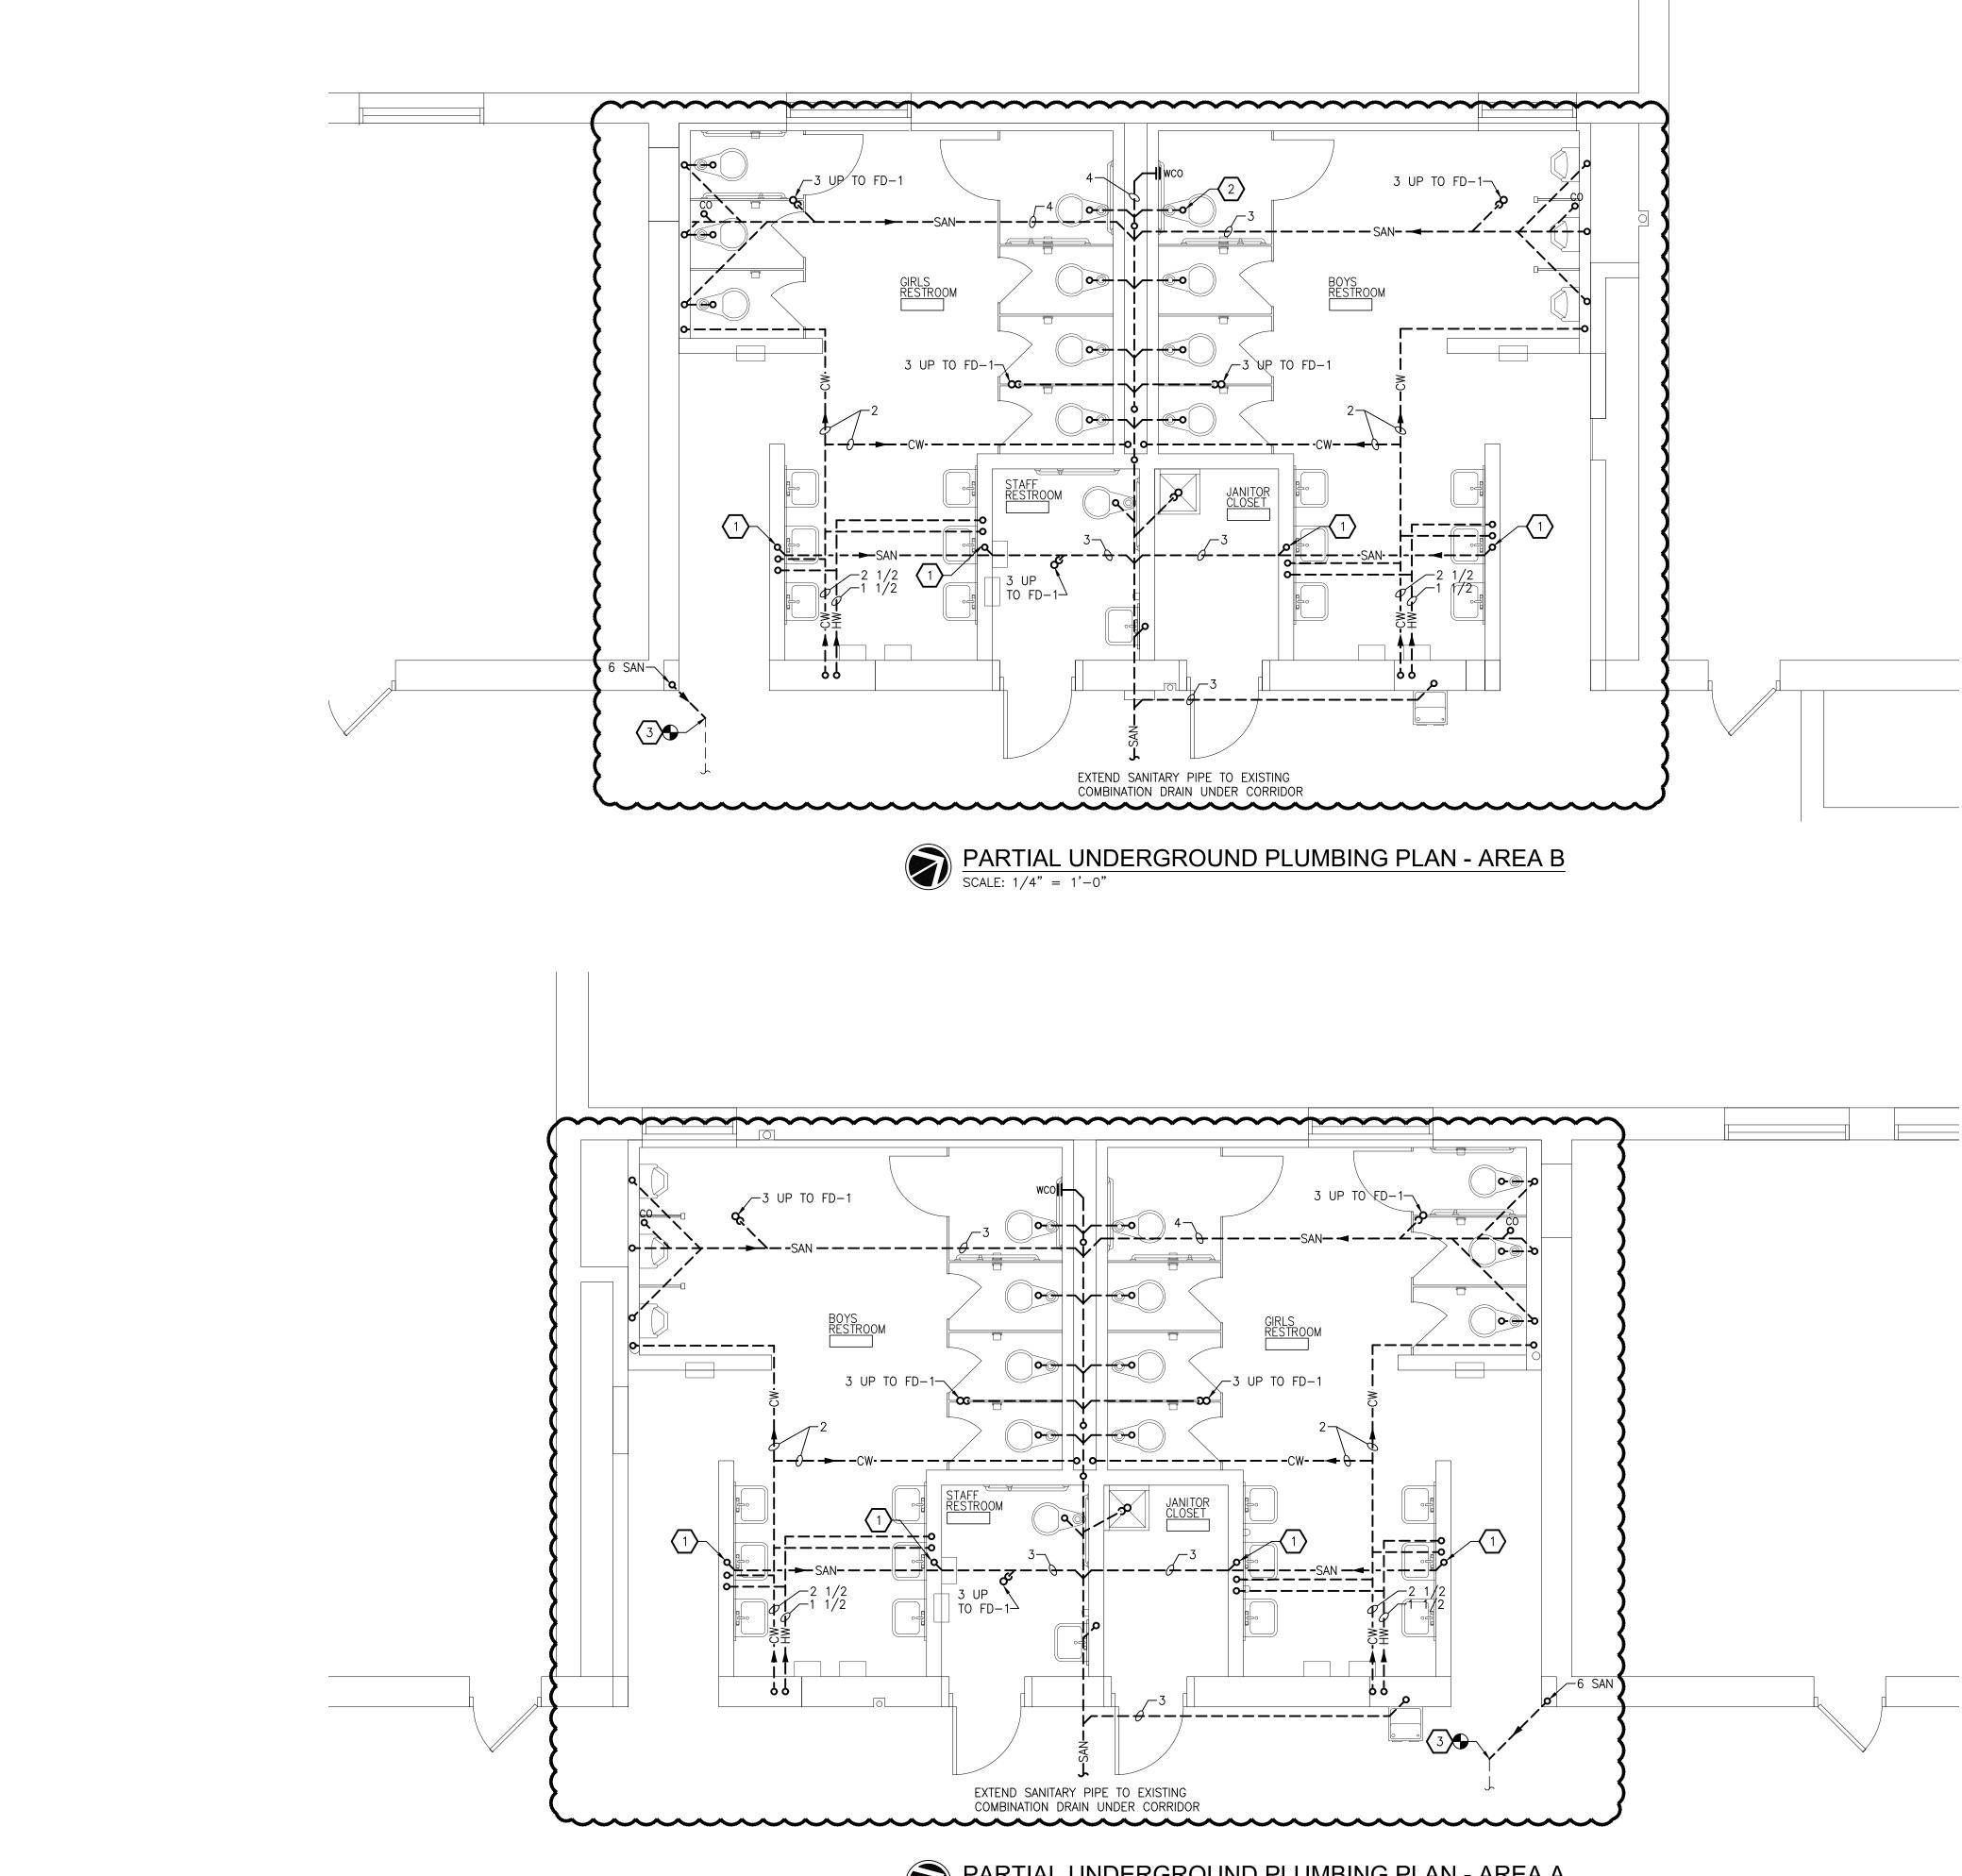
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SHEET NAME

PARTIAL FINISH FLOOR PLANS

SHEET NO. **A9-01**



 $\sum_{\text{SCALE: } 1/4" = 1'-0"} \frac{\text{PARTIAL UNDERGROUND PLUMBING PLAN - AREA A}}{\text{SCALE: } 1/4" = 1'-0"}$

PLUMBING GENERAL NOTES

- 1. THESE DRAWINGS ARE DIAGRAMMATIC & INDICATE THE GENERAL EXTENT OF THE WORK. PROVIDE PLUMBING SYSTEMS COMPLETE AND PER APPLICABLE CODES INCLUDING REQUIRED COMPONENTS, OFFSETS REQUIRED TO AVOID THE STRUCTURE, ETC.
- 2. REFER TO ARCHITECTURAL PLANS FOR SPECIFICATIONS OF AND EXACT LOCATIONS OF FIXTURES (STANDARD AND BARRIER FREE), SINKS, ETC.
- 3. CONTRACTOR SHALL COORDINATE THE INSTALLATION OF PLUMBING AND PIPING WITH THE WORK OF ALL OTHER TRADES.
- 4. PIPING SHALL NOT BE LOCATED OVER ELECTRICAL EQUIPMENT/PANELS. PROVIDE REQUIRED CLEARANCE IN FRONT OF ELECTRICAL EQUIPMENT. PIPING SHALL NOT INTERFERE WITH ELECTRICAL EQUIPMENT CLEARANCE.
- 5. PIPING SHALL NOT BE INSTALLED IN A LOCATION THAT RESTRICTS THE ACCESS TO MECHANICAL DEVICES REQUIRING ACCESS.
- 6. CONTRACTOR SHALL PROVIDE SUPPLEMENTARY STEEL AS REQUIRED FOR THE PROPER SUPPORT OF ALL MECHANICAL SYSTEMS.
- 7. HOT AND COLD WATER PIPING RUN-OUTS TO LAVS AND SINKS SHALL BE 3/4" UNLESS NOTED OTHERWISE. REFER TO SPECIFICATIONS FOR FIXTURE CONNECTION SIZES.
- 8. PROVIDE CODE REQUIRED CLEARANCE FOR ALL CLEANOUTS INSTALLED IN SANITARY WASTE AND VENT PIPING.
- 9. MINIMUM UNDERGROUND PIPE SIZE SHALL BE 3".
- 10. PROVIDE VALVES ON ALL BRANCH PIPING SERVING GROUP TOILET ROOMS. PROVIDE FULL OPEN VALVES AND SHUT OFF VALVES PER PLUMBING CODE.

KEYED NOTES

3" SANITARY AND 3/4" HOT AND COLD WATER UP TO LAVATORIES. ROUTE PIPING IN WALL. REFER TO FIXTURE SCHEDULE FOR CONNECTION SIZES.

 $\langle 2 \rangle$ 4" SANITARY UP TO WATER CLOSET.

 $\langle 3 \rangle$ RE-CONNECT TO EXISTING 6" SANITARY DRAIN.

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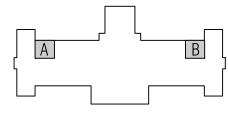
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KEY PLAN 🔀



OWNER

Hamtramck Public Schools

PROJECT NAME

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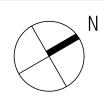
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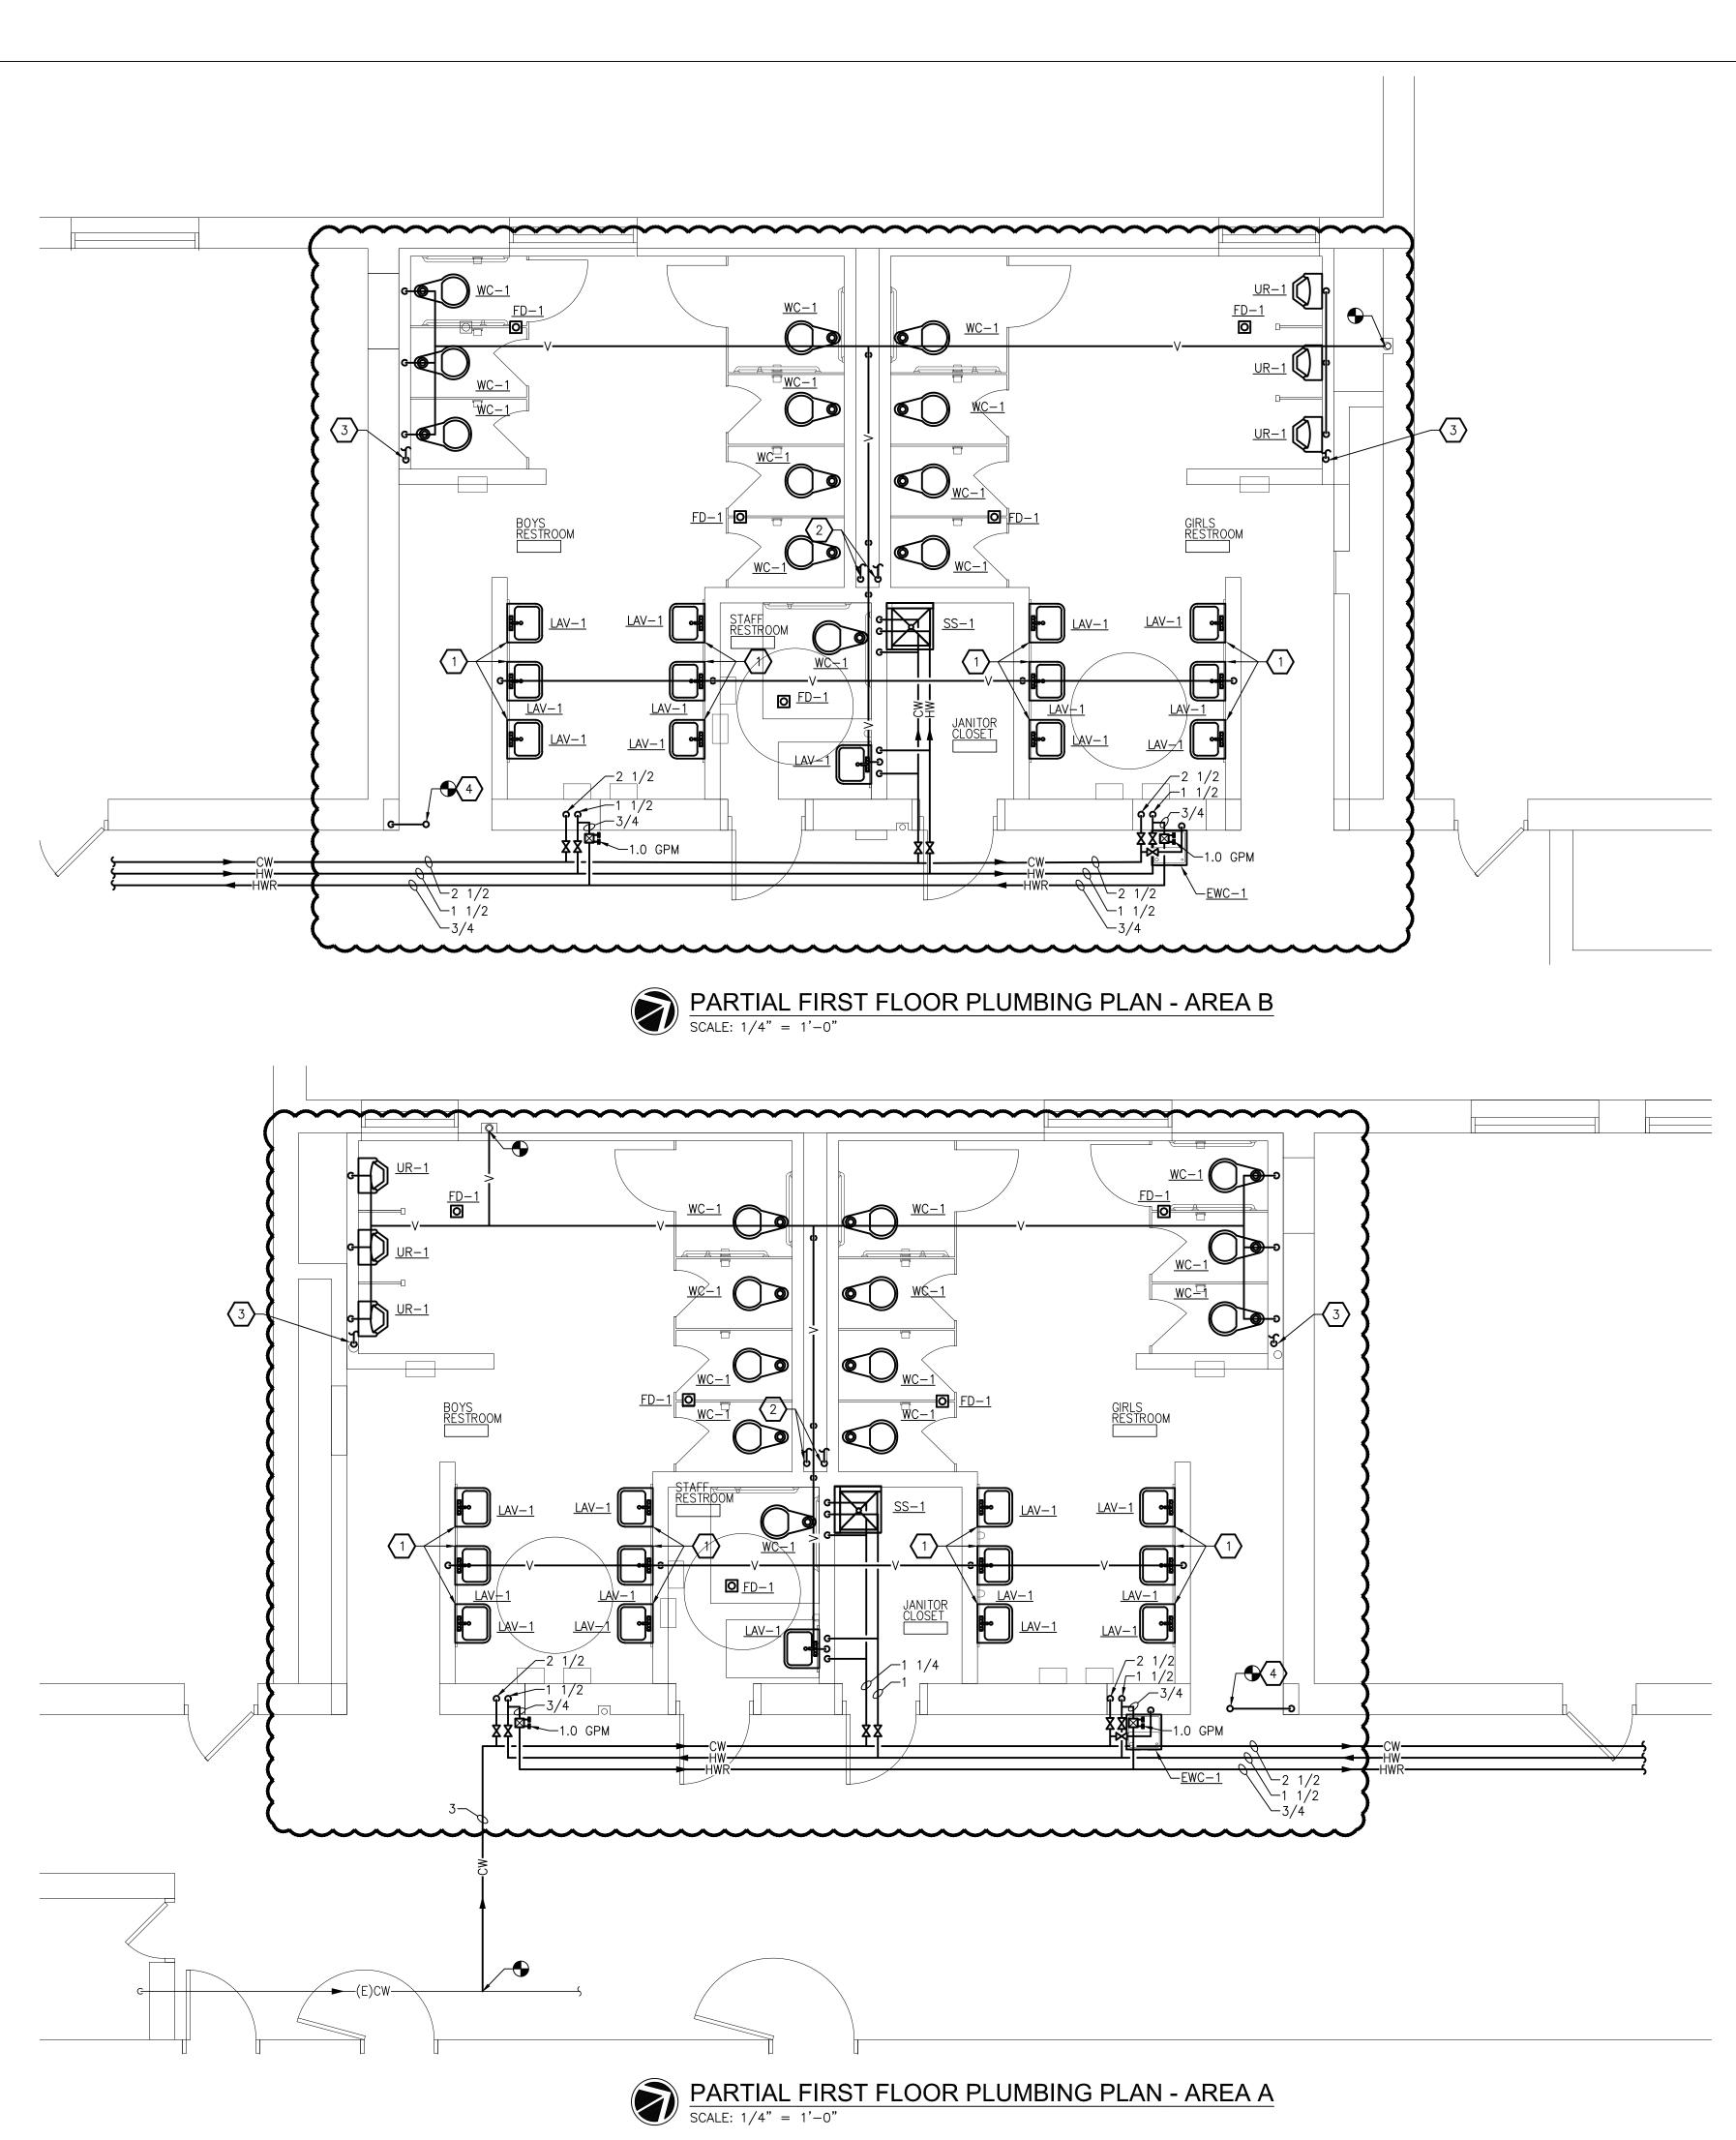
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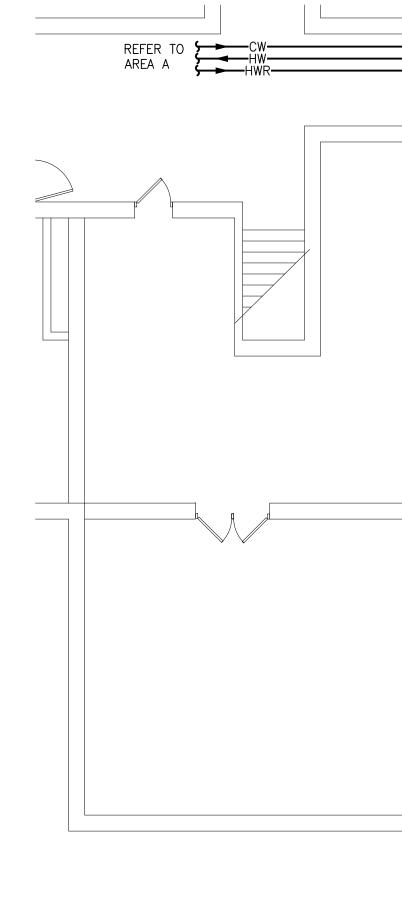
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PARTIAL UNDERGROUND PLUMBING PLAN

SHEET NO. P100





	PLUMBING GENERAL NOTES	PARTNERS
1.	THESE DRAWINGS ARE DIAGRAMMATIC & INDICATE THE GENERAL EXTENT OF THE WORK. PROVIDE PLUMBING SYSTEMS COMPLETE AND PER APPLICABLE CODES INCLUDING REQUIRED COMPONENTS, OFFSETS REQUIRED TO AVOID THE STRUCTURE, ETC.	
2.	REFER TO ARCHITECTURAL PLANS FOR SPECIFICATIONS OF AND EXACT LOCATIONS OF FIXTURES (STANDARD AND BARRIER FREE), SINKS, ETC.	
3.	CONTRACTOR SHALL COORDINATE THE INSTALLATION OF PLUMBING AND PIPING WITH THE WORK OF ALL OTHER TRADES.	
4.	PIPING SHALL NOT BE LOCATED OVER ELECTRICAL EQUIPMENT/PANELS. PROVIDE REQUIRED CLEARANCE IN FRONT OF ELECTRICAL EQUIPMENT. PIPING SHALL NOT INTERFERE WITH ELECTRICAL EQUIPMENT CLEARANCE.	
5.	PIPING SHALL NOT BE INSTALLED IN A LOCATION THAT RESTRICTS THE ACCESS TO MECHANICAL DEVICES REQUIRING ACCESS.	
6.	CONTRACTOR SHALL PROVIDE SUPPLEMENTARY STEEL AS REQUIRED FOR THE PROPER SUPPORT OF ALL MECHANICAL SYSTEMS.	PARTNERS in Architecture, PLC
7.	HOT AND COLD WATER PIPING RUN-OUTS TO LAVS AND SINKS SHALL BE 3/4" UNLESS NOTED OTHERWISE. REFER TO SPECIFICATIONS FOR FIXTURE CONNECTION SIZES.	65 MARKET STREET MOUNT CLEMENS, MI 48043 P 586.469.3600 F 586.469.3607
8.	PROVIDE CODE REQUIRED CLEARANCE FOR ALL CLEANOUTS INSTALLED IN SANITARY WASTE AND VENT PIPING.	Statement of Intellectual Property The ideas, concepts, drawings and thoughts conveyed
9.	MINIMUM UNDERGROUND PIPE SIZE SHALL BE 3".	herein are the intellectual property of PARTNERS in Architecture, PLC, 65 Market Street, Mount Clemens, MI,
10.	PROVIDE VALVES ON ALL BRANCH PIPING SERVING GROUP TOILET ROOMS. PROVIDE FULL OPEN VALVES AND SHUT OFF VALVES PER PLUMBING CODE.	48043 (P 586.469.3600). This set of drawings, in whole or in part, may not be reproduced, without the written consent of PARTNERS in Architecture, PLC. This information is protected under U.S. Copyright Law, all rights reserved.
	KEYED NOTES	© Copyright 2015 CONSULTANT
$\langle 1 \rangle$	ALTERNATE: PROVIDE BRADLEY MG-3 EXPRESS LAVATORY SYSTEM IN LIEU OF THREE INDIVIDUAL LAVATORY SINKS.	
$\langle 2 \rangle$	ROUTE 2" COLD WATER PIPE IN CHASE UNDIMINISHED TO FURTHEST FIXTURE. REFER TO PLUMBING FIXTURE SCHEDULE FOR FIXTURE PIPE CONNECTION SIZE.	SES
$\langle 3 \rangle$	ROUTE 2" COLD WATER PIPE IN WALL UNDIMINISHED TO FURTHEST FIXTURE. REFER TO PLUMBING FIXTURE SCHEDULE FOR FIXTURE PIPE CONNECTION SIZE.	Strategic Energy Solutions 4000 W. Eleven Mile Road Berkley, MI 48072 Phone 248.399.1900 Fax 248.399.1901
$\langle 4 \rangle$	CONNECT TO EXISTING 6" SANITARY VENT ABOVE.	www.sesnet.com © 2015 SES, INC. SES Project # 16 0357 02
		KEY PLAN
		NORTH
		A B MECHANICAL ROOM
		owner Hamtramck Public Schools PROJECT NAME

2

-EXISTING DOMESTIC WATER HEATER

PARTIAL FIRST FLOOR PLUMBING PLAN SCALE: 1/8" = 1'-0"

EXISTING MECH RM

SHEET NO. P101

FIRST FLOOR PLUMBING PLAN

SHEET NAME

APPROVED BY TMV

DRAWN BY RRS _____ CHECKED BY RRS

Kosciuszko

Middle School

2333 Burger Hamtramck, MI 48212

PROJECT NO.

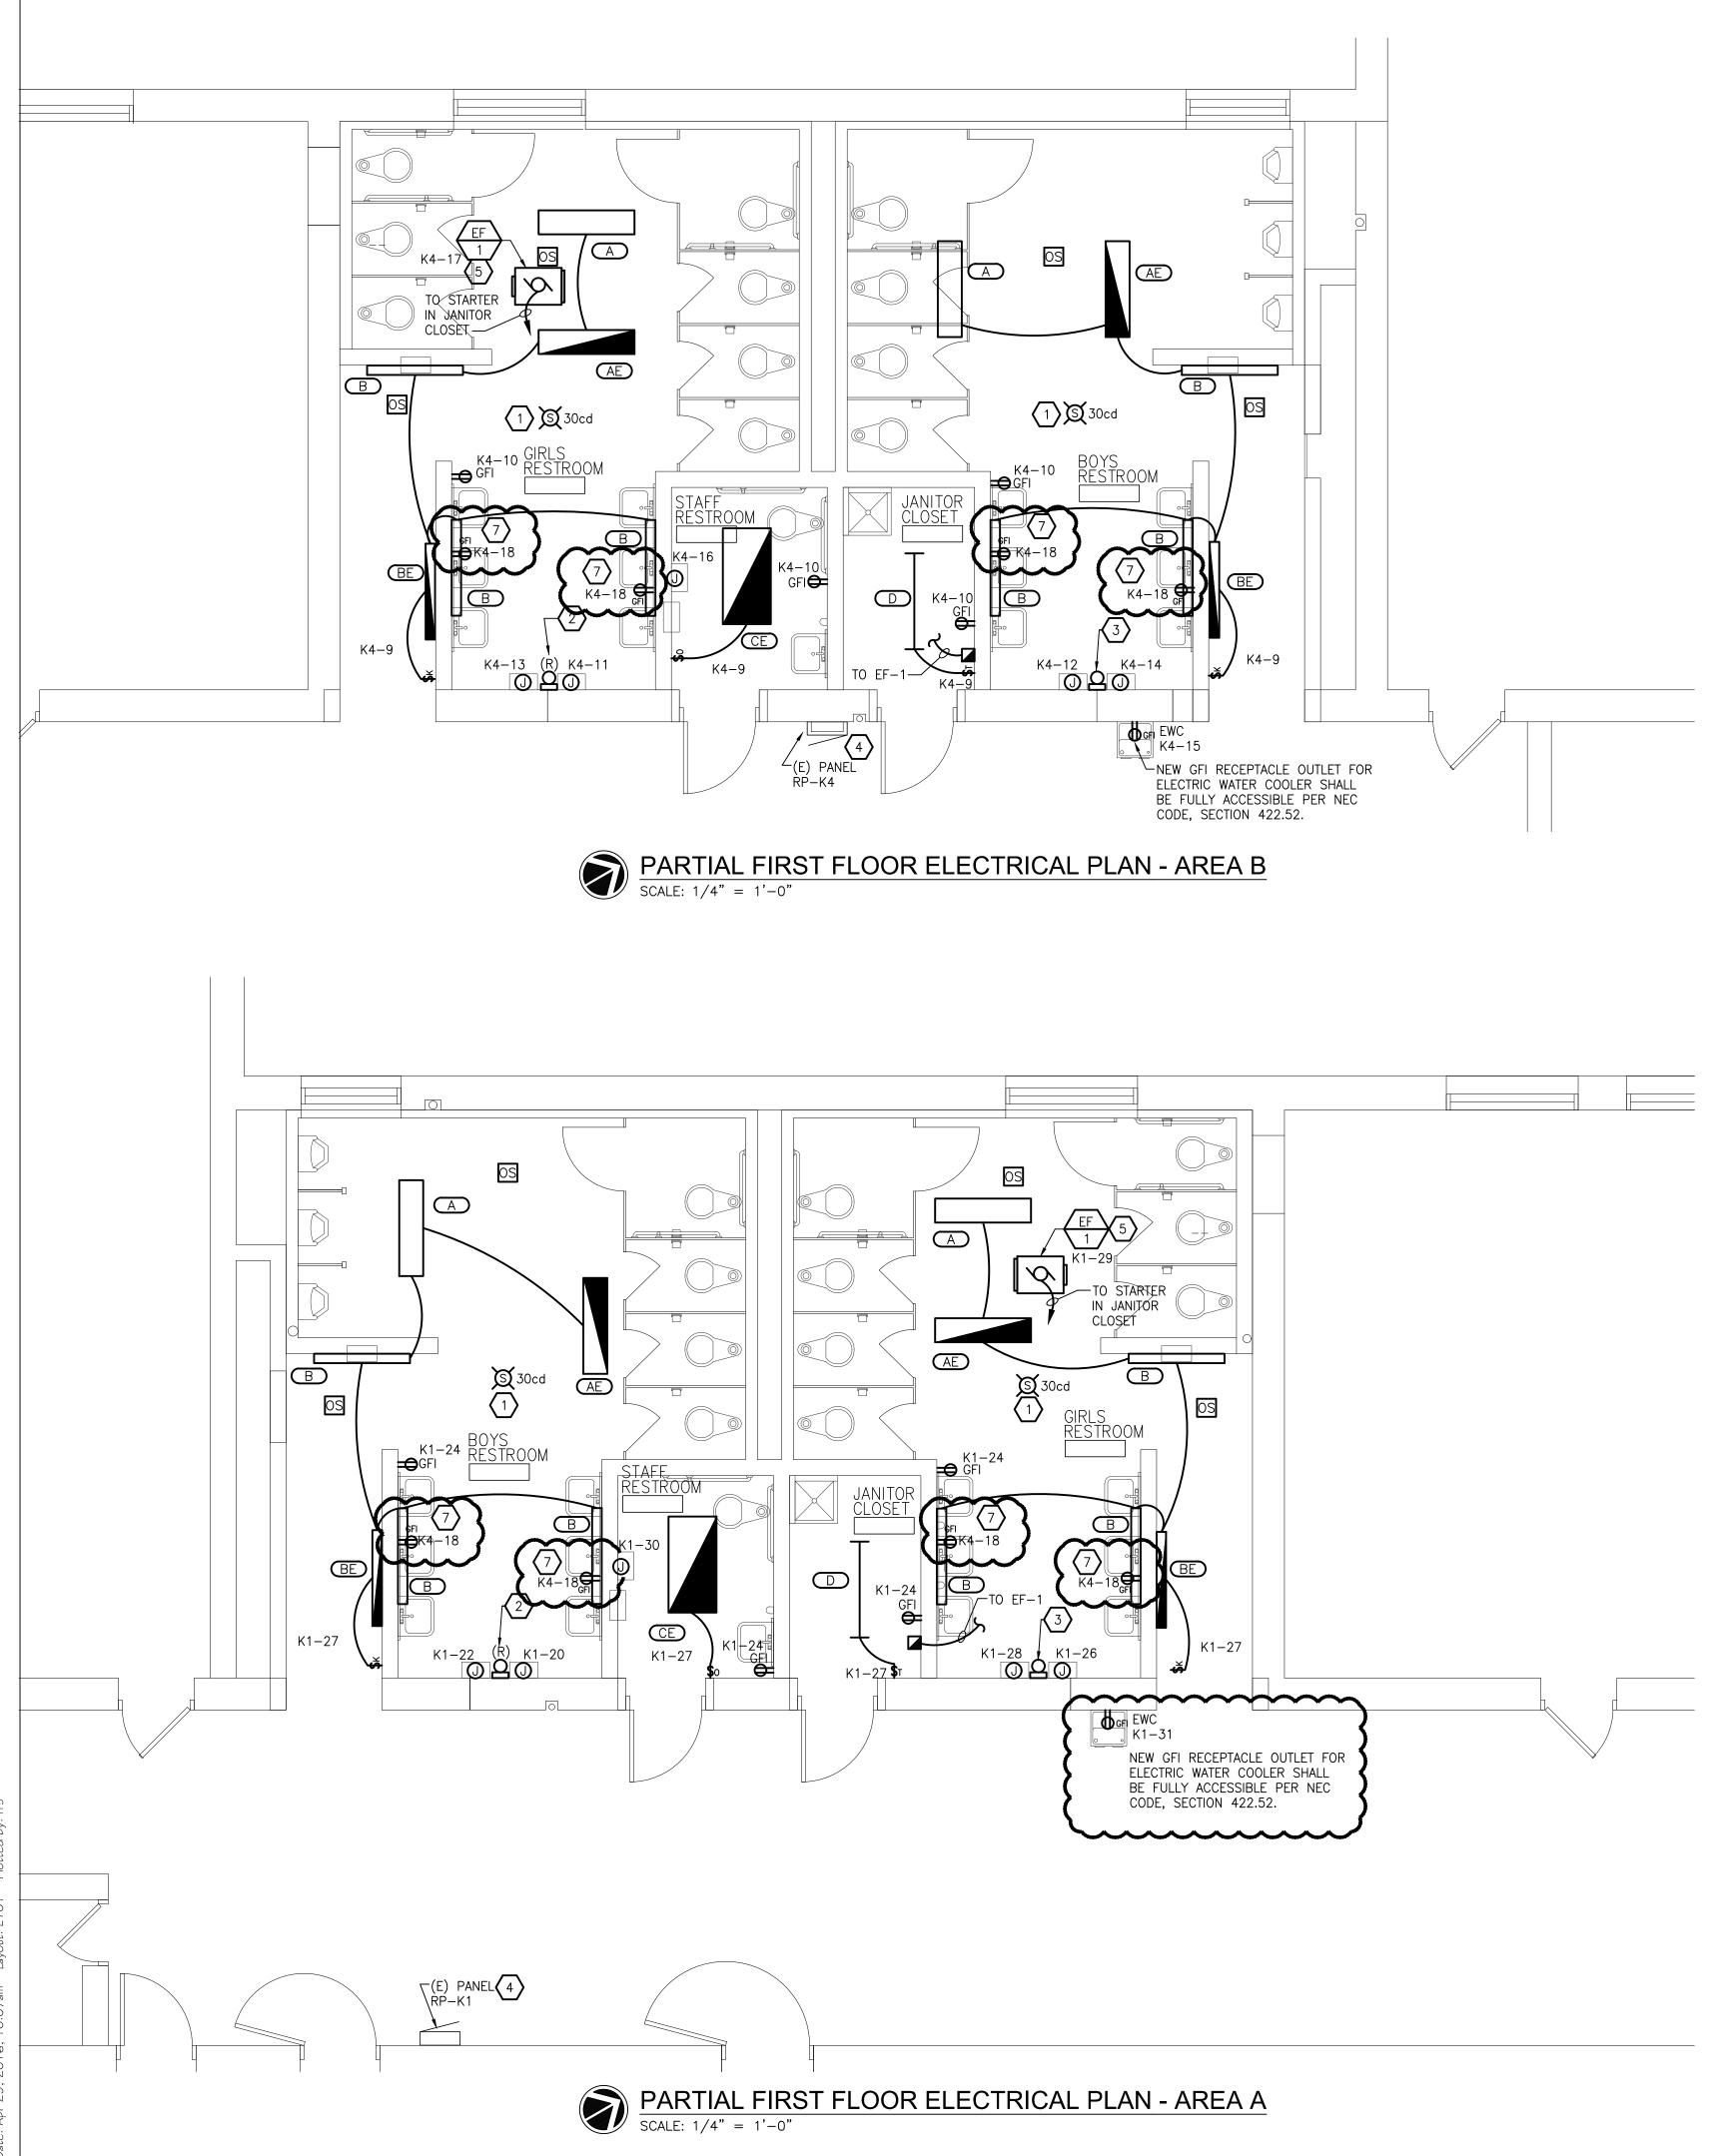
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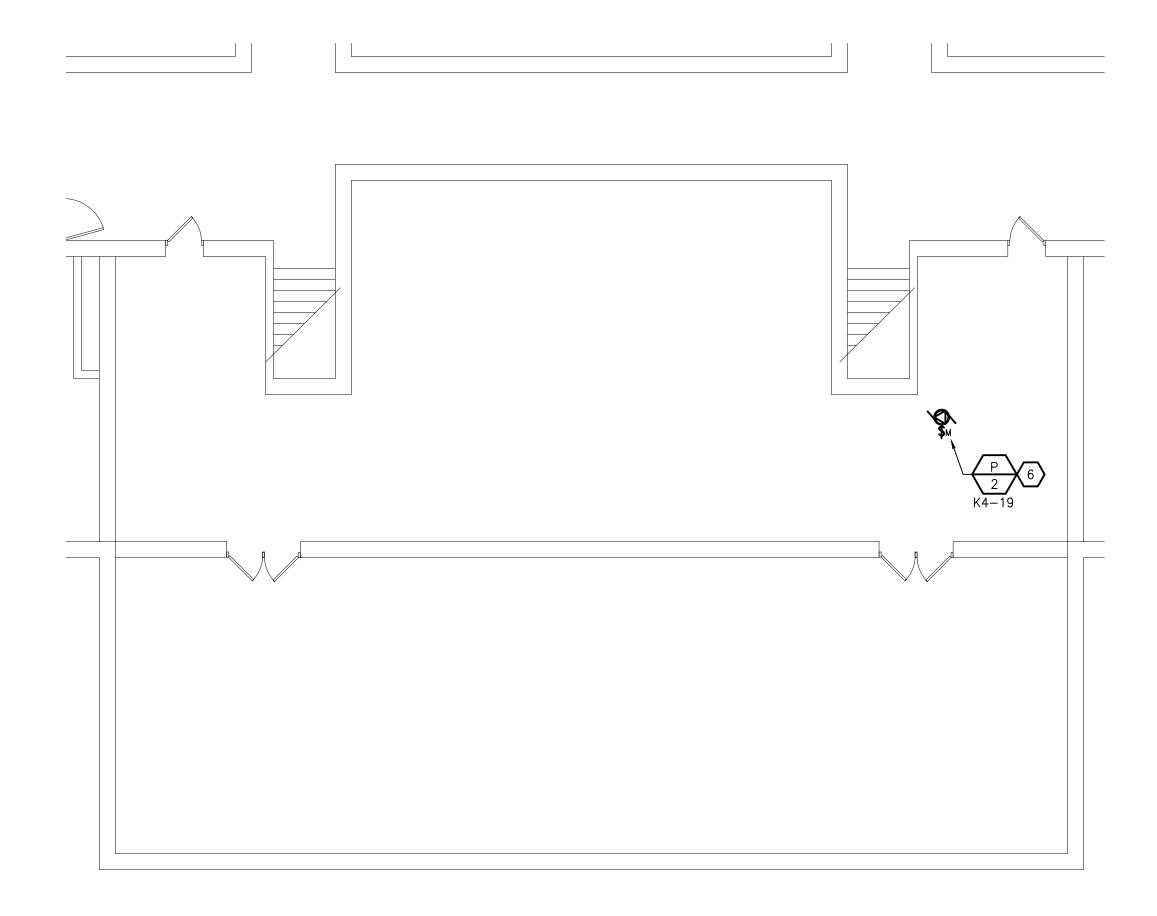
ISSUES / REVISIONS

Toilet Room Upgrades

 Bidding - Construction
 04/22/2016

 Addendum No. 1
 04/29/2016







ELECTRICAL GENERAL NOTES

- 1. REFER TO ARCHITECTURAL REFLECTED CEILING PLAN FOR EXACT LOCATION OF ALL LIGHTING FIXTURES UNLESS OTHERWISE NOTED.
- 2. SEE LUMINAIRE SCHEDULE ON ELECTRICAL GENERAL INFORMATION SHEET.
- 3. EXIT LIGHTS AND EMERGENCY BATTERY UNITS SHALL BE UNCONTROLLED AND
- TIED AHEAD OF LOCAL AREA LIGHTING SWITCH, UNLESS CIRCUITED OTHERWISE.
- 4. WHERE MORE THEN ONE LIGHT SWITCH IS INDICATED TO BE INSTALLED AT THE SAME LOCATION, THEY SHALL BE GROUPED UNDER ONE COMMON FACEPLATE.
- 5. ALL ELECTRICAL DEVICES SHOWN ON THIS PLAN SHALL BE NEW UNLESS OTHERWISE NOTED.
- 6. ANY 120 VOLT BRANCH CIRCUIT FEEDER LONGER THAN 75'-0" TO LAST DEVICE SHALL BE SIZED TO THE NEXT LARGER STANDARD AWG SIZE. E.C. SHALL FIELD VERIFY ALL LENGTHS OF FEEDERS.
- 7. ALL RECEPTACLES SHALL BE 20A. RATED.
- 8. ALL DISCONNECT SWITCHES SHALL BE HEAVY DUTY TYPE.
- 9. ALL RECEPTACLES WITHIN 6'-0" OF SINK OR OTHER WATER SUPPLY SHALL BE GFCI TYPE RECEPTACLE.
- 10. REFER TO ARCHITECTURAL FLOOR PLAN AND ELEVATIONS FOR EXACT LOCATION OF DEVICES.
- 11. ALL JUNCTION BOXES SERVING BRANCH CIRCUIT WIRING SHALL BE LABELED WITH CIRCUITS SERVED.
- 12. ALL 120 VOLT CIRCUITS SHALL UTILIZE A SEPARATE NEUTRAL.
- 13. ALL CONDUITS SERVING 120 VOLTS OR GREATER SHALL INCLUDE A GROUND WIRE.
- 14. ALL CONDUITS SHALL BE ROUTED CONCEALED UNLESS NOTED OTHERWISE.
- 15. ALL ELECTRICAL EQUIPMENT MOUNTED ON THE FLOOR SHALL BE MOUNTED ON A 4" CONCRETE HOUSE KEEPING PAD.
- 16. ALL BRANCH CIRCUIT WIRING SHALL BE 2#12, 1#12GND IN 3/4" CONDUIT, UNLESS NOTED OTHERWISE.

KEYED NOTES

- 1 NEW CEILING MOUNTED FIRE ALARM STROBE, 15cd, CONNECT TO NEW FIRE ALARM CONTROL PANEL IN OFFICE AREA, REFER TO RISER DIAGRAM.
- 2 RELOCATED SCHOOL BELL TO BE WALL MOUNTED, EXTEND CONDUIT AND WIRING TO THIS NEW LOCATION REFER TO DEMOLITION PLANS WIRING TO THIS NEW LOCATION, REFER TO DEMOLITION PLANS.
- 3 NEW SCHOOL BELL TO MATCH EXISTING, CONNECT TO EXISTING SCHOOL BELL SYSTEM, PROVIDE NEW CONDUIT AND WIRING TO THIS NEW LOCATION.
- 4 EXISTING PANEL TO BE REUSED FOR NEW CIRCUITS, REFER TO PANEL SCHEDULE SHEET E600.
- 5 NEW EXHAUST FAN EF-1 AND CONNECT TO CIRCUIT NUMBER AS SHOWN. RUN 2#12+1#12GND-3/4C" PROVIDE NEW HOA SWITCH CONNECT TO TIMECLOCK 2#12+1#12GND-3/4C". PROVIDE NEW HOA SWITCH, CONNECT TO TIMECLOCK.
- 6 NEW EXHAUST FAN P-1 AND CONNECT TO CIRCUIT NUMBER AS SHOWN. RUN 2#12+1#12GND-3/4C". DISCONNECT SWITCH BY ELECTRICAL CONTRACTOR AND STARTER" BY MECHÁNICAL CONTRACTOR.
- (7) ALTERNATE 1: PROVIDE DEDICATED 20A-1P BREAKER TO SERVE BRADLEY MG-3 LAVATORY SYSTEM.

$\sum_{\text{SCALE: } 1/8" = 1'-0"} \frac{\text{PARTIAL FIRST FLOOR ELECTRICAL PLAN}}{\text{SCALE: } 1/8" = 1'-0"}$

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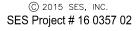
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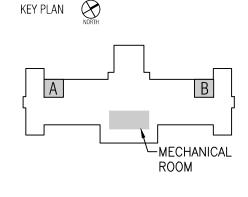
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Hamtramck Public Schools

PROJECT NAME

OWNER

Kosciuszko Middle School Toilet Room Upgrades

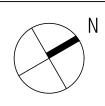
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PROJECT NO.

ISSUES / REVISIONS

Bidding - Construction 04/22/2016 Addendum No. 1 04/29/2016



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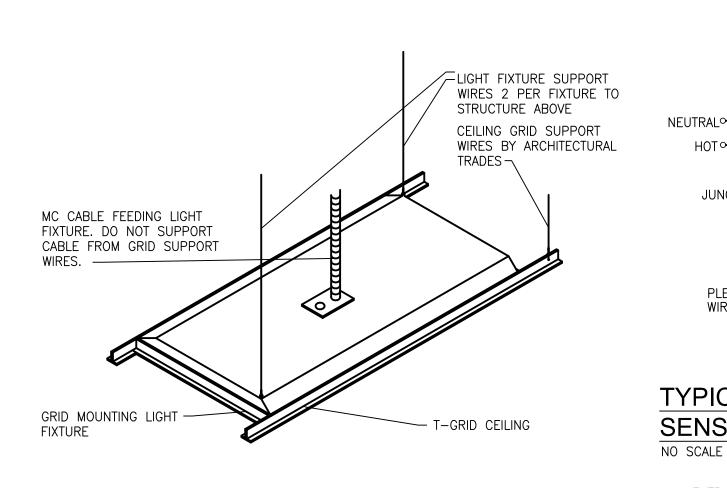
CHECKED BY

APPROVED BY

FAA

SHEET NAME PARTIAL FIRST FLOOR ELECTRICAL PLAN SHEET NO. E101

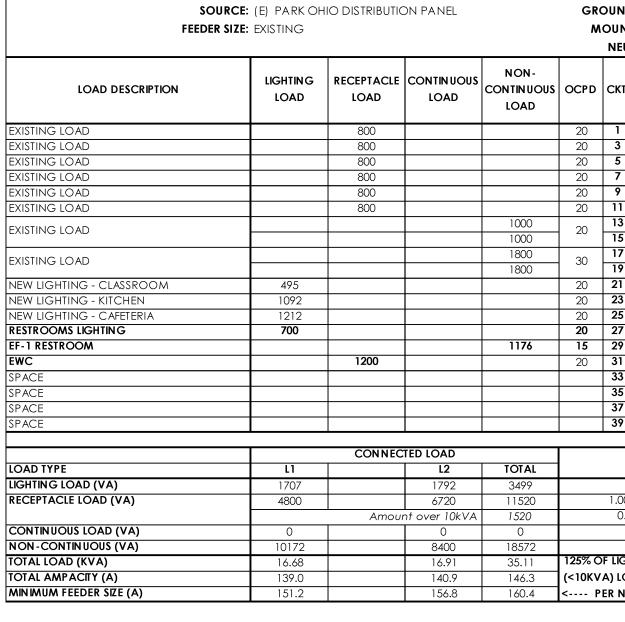
LOCAT SOU	AME: (E) RP ION: CORRIDOR IRCE: (E) PARK OI SIZE: EXISTING		ON PANEL		GRO MO		: 100 : Stand <i>a</i> : Surfac			,		L-L VOLTAGE -N VOLTAGE PHASE WIRE RUPT RATING	:: 120 :: 1 :: 3	LOCAT		RRIDOR NEAR KITCHEN PARK OHIO DISTRIBUTION		
LOAD DESCRIPTION	LIGHTING LOAD	RECEPTACLE	CONTIN UOUS LOAD	NON- CONTINUOUS LOAD				OCPD	NON- CONTINUOUS LOAD			LIGHTIN G LOAD	LOAD DESCRIPTION	LOAD DESCRIPTION	LIGHTING LOAD	RECEPTACLE	cc	
EXISTING CIRCUIT		360			20	1	2	20			360		EXISTING CIRCUIT	EXISTING LOAD		800		
EXISTING CIRCUIT		360				3	4				360		EXISTING CIRCUIT	EXISTING LOAD		800		
EXISTING CIRCUIT		360				5	6				360		EXISTING CIRCUIT	EXISTING LOAD		800		
EXISTING CIRCUIT		360				7	8				360		EXISTING CIRCUIT	EXISTING LOAD		800		
	700	560				9	10				720		BOYS AND GIRLS RECEPTACLES	EXISTING LOAD		800		
GIRLS HAND DRYER	700			1500			10		1500		720		BOYS HAND DRYER	EXISTING LOAD		800		
					-	11								EXISTING LOAD				
		1000		1500		13	14		1500				BOYS HAND DRYER					
		1200				15	16		1500				STAFF HAND DRYER	EXISTING LOAD				
EF-1, RESTROOMS				1176		17	18	20	1600				LAVATORY SENSOR FAUCETS (ALTERNATE 1)					
P-1, MECHANICAL ROOM				200		19	20						SPACE	NEW LIGHTING - CLASSROOM	495			
SPACE						21	22						SPACE	NEW LIGHTING - KITCHEN	1092			
SPACE						23	24						SPACE	NEW LIGHTING - CAFETERIA	1212			
SPACE						25	26						SPACE	RESTROOMS LIGHTING	700			
SPACE						27	28						SPACE	EF-1 RESTROOM				
SPACE						29	30						SPACE	EWC		1200		
														SPACE				
		CONNEC	TED LOAD			DEMA				DEMAN	ID LOAD			SPACE				
LOAD TYPE	L1		L2	TOTAL	1	FACT	OR	Γ	L1		L2	TOTAL	7	SPACE				
LIGHTING LOAD (VA)	700		0	700		1.0	0		700		0	700		SPACE				
RECEPTACLE LOAD (VA)	2160		2640	4800		1.00 (FIRST	t 10KVA)		2160		2640	4800	RECEPTACLE DEMAND FACTOR PER					
		Amou	nt over 10kVA	0		0.50 (> 1	IOKVA)		0		0	0	ARTICLE 220.44 OF THE NEC			CONNEC	TED	
CONTINUOUS LOAD (VA)	0		0	0		1.0	0		0		0	0		LOAD TYPE	L1			
NON-CONTINUOUS (VA)	5776		4700	10476		0.8	0		4621		3760	8381	1	LIGHTING LOAD (VA)	1707			
OTAL LOAD (KVA)	8.64		7.34	15.98	125% OF	LIGHT/CC	ONT AND	RECEPT	7.48		6.40	13.88	1 1	RECEPTACLE LOAD (VA)	4800			
	72.0		61.2	66.6					62.3		53.3	57.8	1 1			Amou	nt c	
MINIMUM FEEDER SIZE (A)	77.9		66.7	72.3	< PEI	-			68.3		58.8	63.6	1 1	CONTINUOUS LOAD (VA)	0			
(- 7			- 200						- 210		- 3.0			NON-CONTINUOUS (VA)	10172			
														TOTAL LOAD (KVA)	16.68			
														ΤΟΤΑΙ ΑΜΡΑΟΠΥ (Α)	139.0			
															151.2			

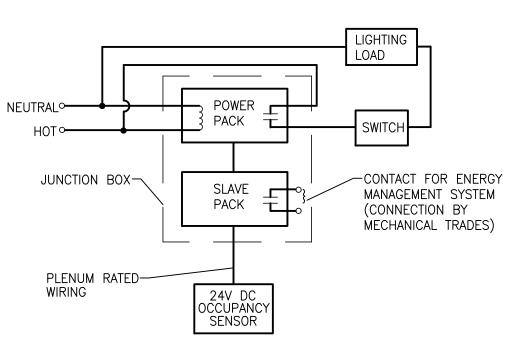


T-GRID FIXTURE MOUNTING DETAIL NO SCALE

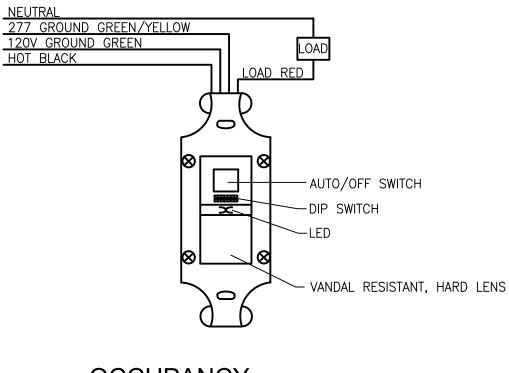
ELECTRICAL FIXTURES

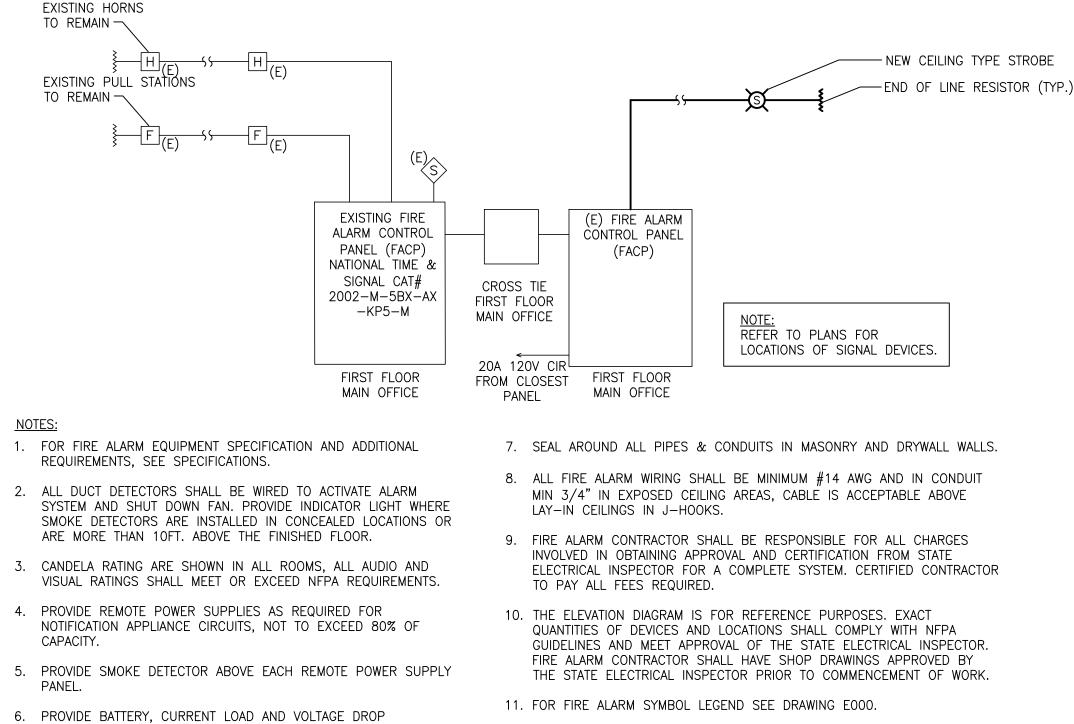
- 1. LIGHT FIXTURES WEIGHING LESS THAN 10 POUNDS SHALL HAVE ONE 12 GAUGE HANGER WIRE CONNECTED FROM THE FIXTURE TO THE STRUCTURE ABOVE. THIS WIRE MAY BE SLACK.
- 2. LIGHT FIXTURE WEIGHING MORE THAN 10 POUNDS AND LESS THAN 56 LBS. SHALL HAVE 12 GAUGE WIRES ATTACHED AT OPPOSING CORNERS OF THE LIGHT FIXTURE TO THE STRUCTURE ABOVE. THESE WIRES MAY BE SLACK.
- 3. LIGHT FIXTURES WEIGHING MORE THAN 56 POUNDS SHALL BE SUPPORTED BY DIRECTLY FROM THE STRUCTURE ABOVE. THESE WIRES MUST BE TAUT.
- 4. PENDANT MOUNTED FIXTURES SHALL BE DIRECTLY SUPPORTED FROM THE STRUCTURE ABOVE USING A 9 GAUGE WIRE OR AN APPROVED ALTERNATE SUPPORT WITHOUT USING THE CEILING SUSPENSION SYSTEM FOR DIRECT SUPPORT.
- 5. TANDEM FIXTURES MAY UTILIZE COMMON WIRES.





TYPICAL CEILING MOUNTED OCCUPANCY SENSOR WIRING DIAGRAM





12. PROVIDE COVER WITH SIREN FEATURE TO ALL NEW FIRE ALARM MANUAL PULL STATION.

OCCUPANCY **SENSOR SCHEMATIC** NO SCALE

NO SCALE

CALCULATIONS PER SPECIFICATIONS.

SSI ID I NTI	NC BU NC	3: S	00 TAND URFA(L	-L VOLTAGE N VOLTAGE PHASE WIRE	: 120 : 1 : 3
			00% 2 Скт	OCPD	NON- CONTINUOUS LOAD	CONTINUOUS LOAD	AIN SC INTERR RECEPTACLE LOAD	UPT RATING LIGHTING LOAD	
			2	20			800		existing load
Γ			4	20			800		EXISTING LOAD
			6	20			800		existing load
			8	20			800		existing load
			10	20			800		existing load
			12	20			800		existing load
			14	15	1000				existing load
			16		1000				
			18	20	696				EF-4 (WATER METER ROOM)
			20	20	1500				BOYS HAND DRYER
			22	20	1500				BOYS HAND DRYER
			24	20			720		BOYS AND GIRLS RECEPTACLES
			26	20	1500				GIRLS HAND DRYER
			28	20	1500				GIRLS HAND DRYER
			30	20	1500				STAFF HAND DRYER
			32	20	1600				LAVATORY SENSOR FAUCETS (ALTERNATE 1)
			34						SPACE
_			36						SPACE
			38						SPACE
_			40						SPACE
D	EN		D			DEMAN	D LOAD		7
F	AC	TOF	2		L1		L2	TOTAL	1
		.00			1707		1792	3499	1
			OKVA)		4167		5833	10000	RECEPTACLE DEMAND FACTOR PER
0.50 (> 10KVA)		317		443	760	ARTICLE 220.44 OF THE NEC			
1.00		0		0	0]			
		.80			8138		6720	14858]
				RECEPT	14.33		14.79	29.12]
				R LOAD	119.4		123.2	121.3]
ЗC	C A	RTIC	LE 215	.2>	131.6		139.1	135.4	

FIRE ALARM RISER

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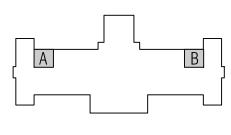
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KEY PLAN 🔀



OWNER

Hamtramck Public Schools

PROJECT NAME

Kosciuszko Middle School Toilet Room Upgrades

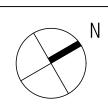
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PROJECT NO.

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SHEET NAME ELECTRICAL

DETAILS AND SCHEDULES

SHEET NO. E600