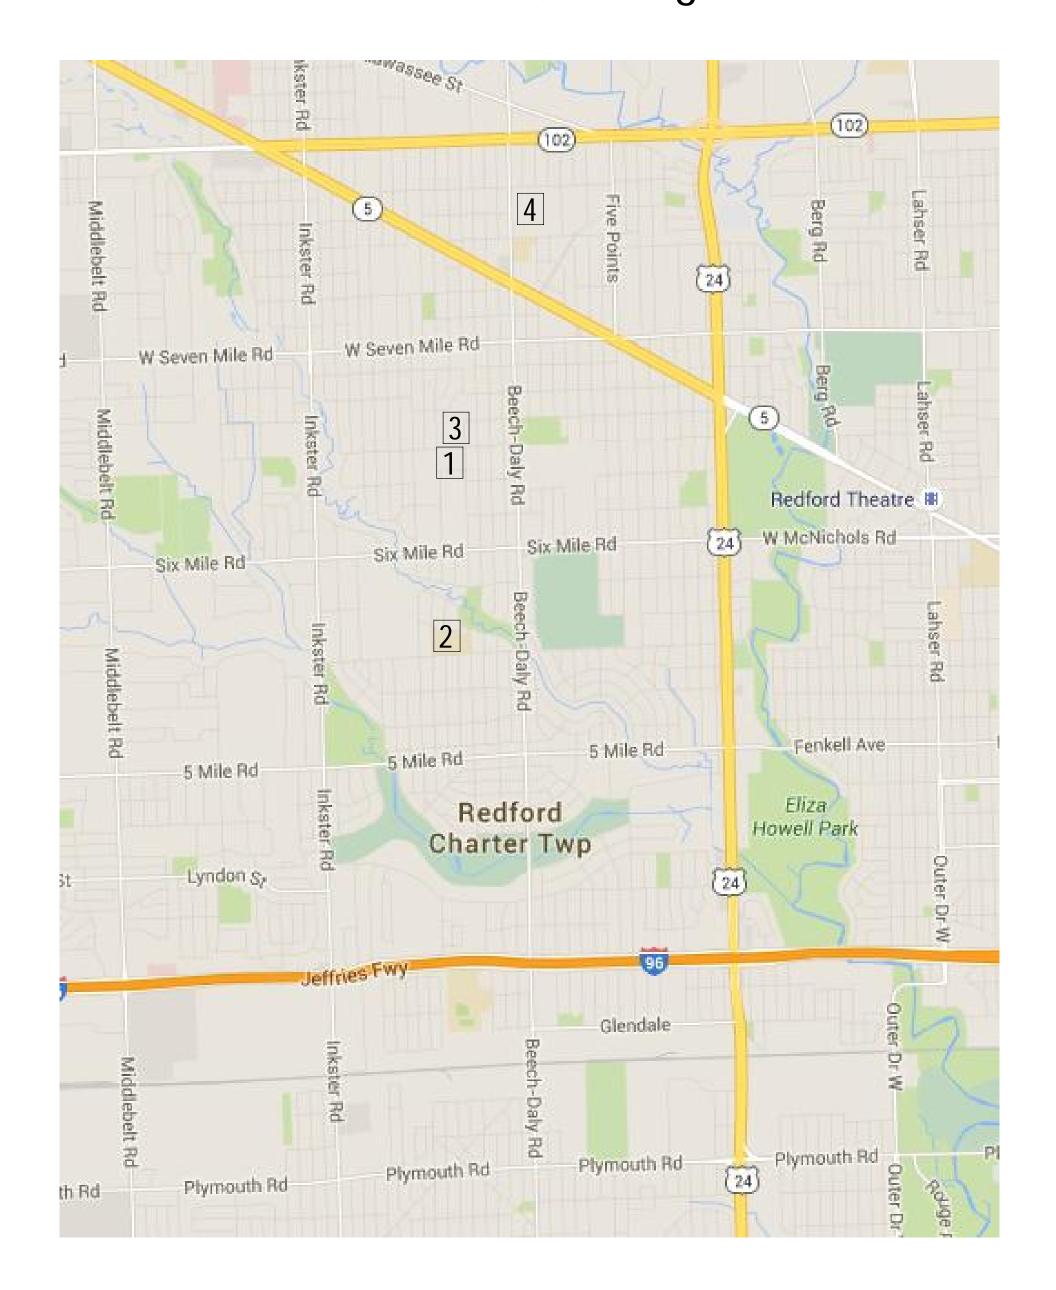
Redford Union Schools Kitchen Improvements and Generators

Redford Union Schools

Redford, Michigan



- Redford Union High School
 17711 Kinloch Street Redford, MI 48240
- Hilbert Middle School
 26440 Puritan Avenue Redford, MI 48239
- MacGowan Elementary School
 18255 Kinloch Street Redford, MI 48240
- 19990 Beech Daly Road Redford, MI 48240

ARCHITECTURAL

A1.21 PARTIAL PLANS
A1.22 BEECH ELEMENTARY PARTIAL PLANS AND DETAILS
A2.21 DETAILS, ENGINEERING SYMBOLS, AND MATERIALS SCHEDULE

MECHANICAL/ELECTRICAL

- ME1.01 HILBERT MIDDLE SCHOOL GENERATOR PLAN DETAILS AND SCHEDULES
- ME1.02 MACGOWAN ELEMENTARY SCHOOL GENERATOR PLAN DETAILS AND SCHEDULES ALT No. 1
- ME1.03 HIGH SCHOOL GENERATOR PLAN DETAILS AND SCHEDULES

 ME1.04 BEECH ELEMENTARY SCHOOL GENERATOR PLAN DETAILS AND SCHEDULES

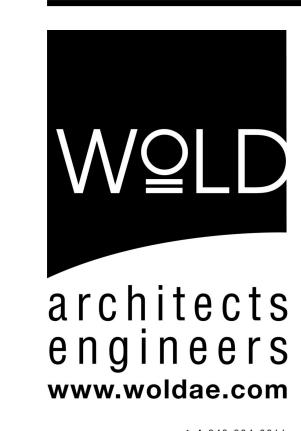
FOOD SERVICE

- FOOD SERVICE EQUPMENT LAYOUT AND SCHEDULE
 PLUMBING/VENTILATION PLAN FOR FOOD SERVICE
- FOOD SERVICE EQUIPMENT ELEVATION DETAILS
 ELECTRICAL ROUGH-IN PLAN FOR FOOD SERVICE

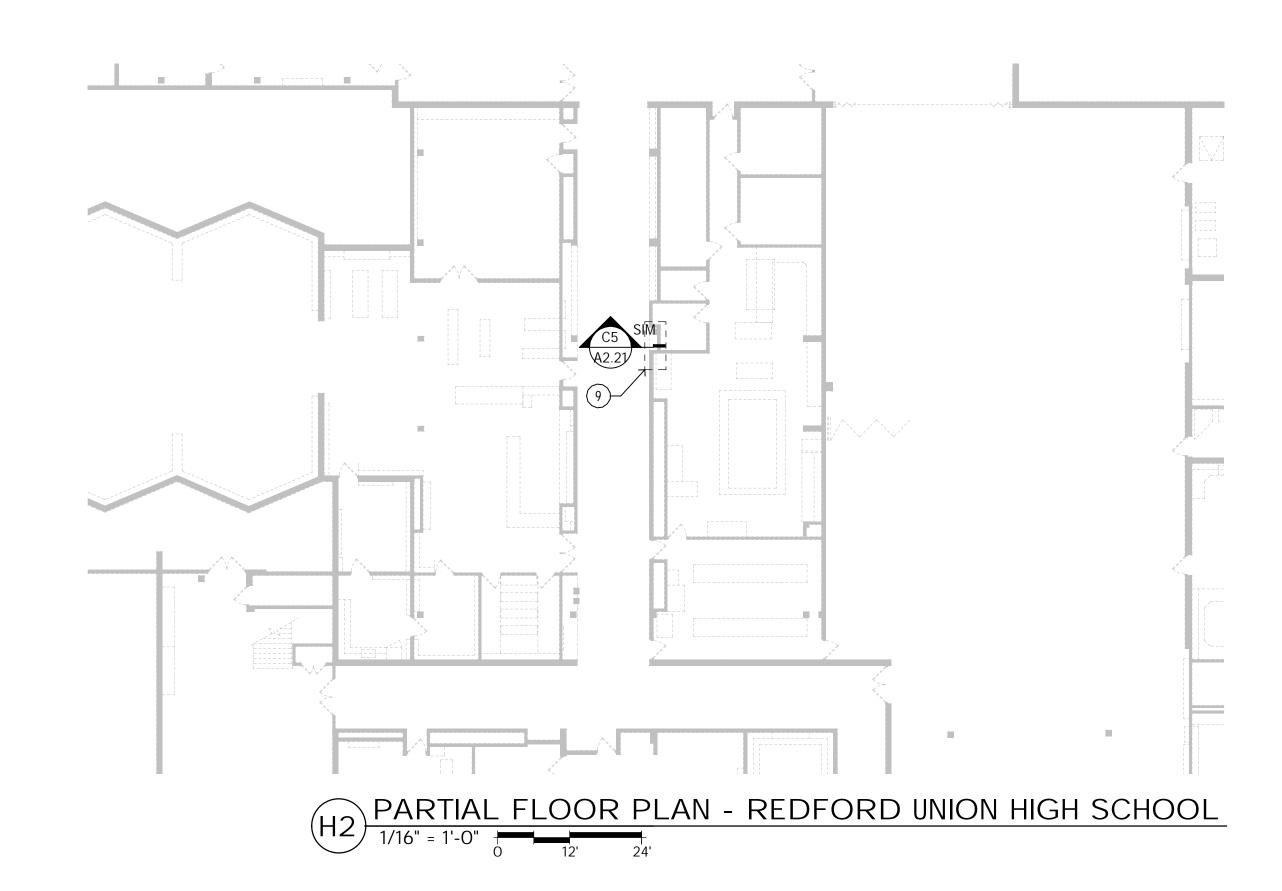
Schools Kitchen
Improvements and
Generators
Redford Union High School
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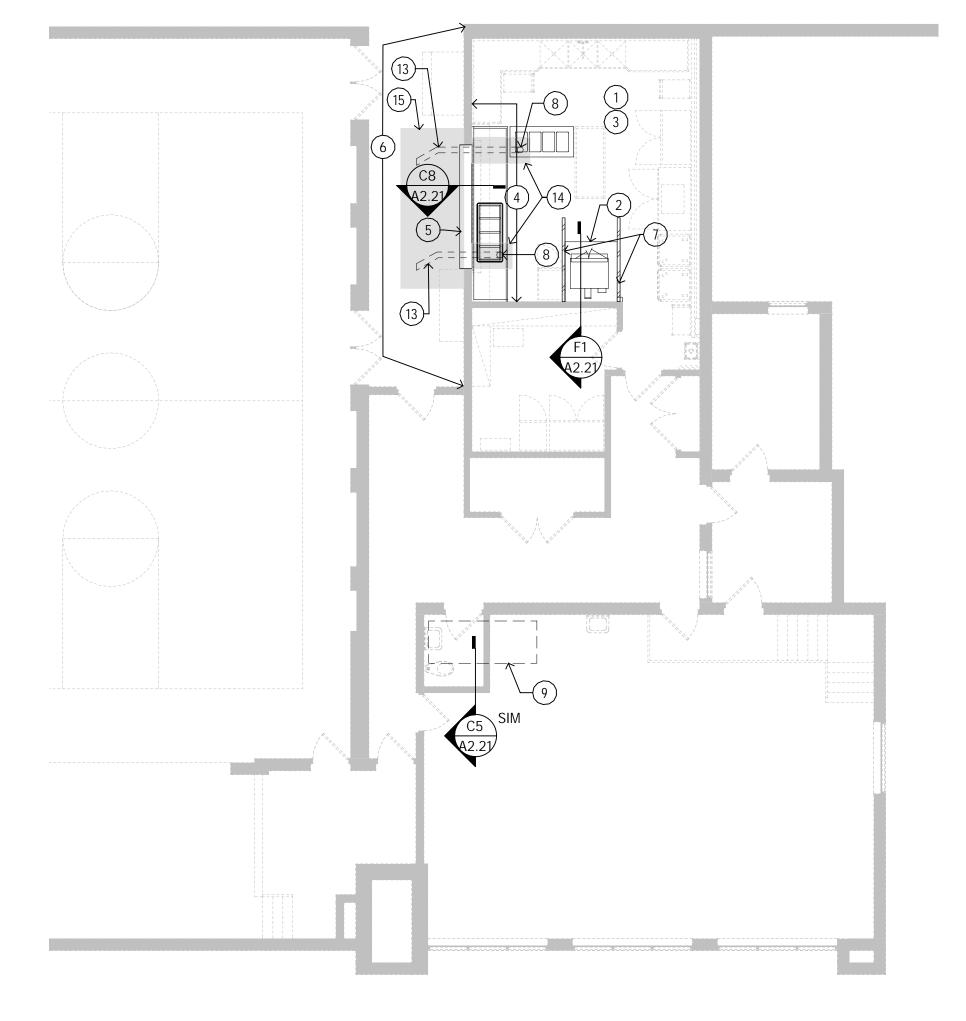
Redford Union

Redford Union Schools



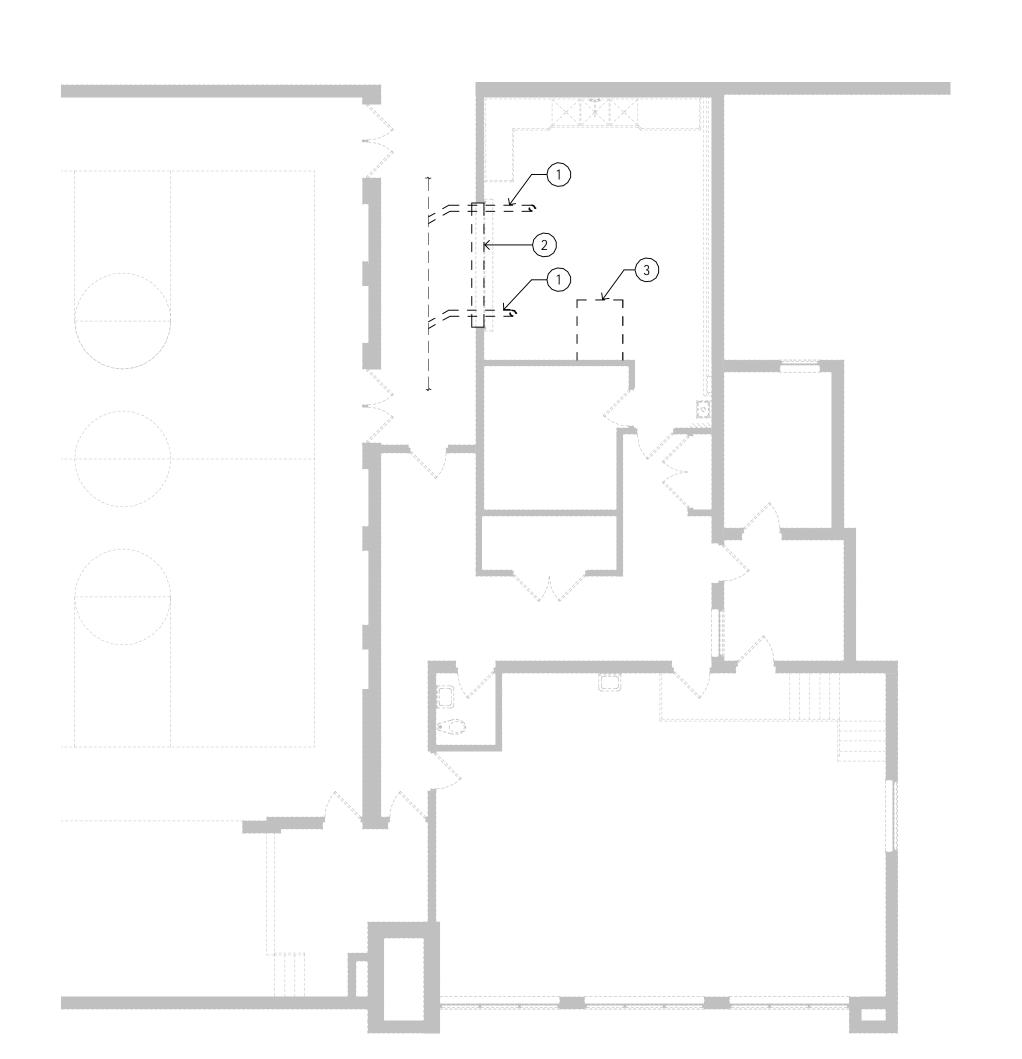
tel 2 10 North Crooks Road fax 2 lawson, MI 48017 mail \circ \circ 2 \circ \circ 3 \circ \circ 4 \circ \circ 5





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PARTIAL FLOOR PLAN - MACGOWAN ELEMENTARY



PARTIAL DEMOLITION PLAN - MACGOWAN ELEMENTARY

FLOOR PLAN GENERAL NOTES:

- REFER TO DETAILS OF CONSTRUCTION FOR:
 A. ABBREVIATIONS, MATERIAL SYMBOLS
 B. MOUNTING HEIGHTS
 - B. MOUNTING HEIGHTS
 C. LINTEL SCHEDULE
 D. MATERIAL FINISH/COLOR SCHEDULE
 - C. LINTEL SCHEDULE
 D. MATERIAL FINISH/COLOR SCHEDULE
 E. WALL TYPES
 F. MARKER BD TYPES AND MOUNTING HTS
 THE ABOVE SECTIONS ARE LISTED FOR
 - REFERENCE ONLY, AND ARE NOT EXCLUSIVE
 TO AREAS OF WORK. ALL DETAILS SHALL BE
 REVIEWED FOR SCOPE OF WORK.
 ALL PLAN DIMENSIONS ARE NOMINAL TO
 - REVIEWED FOR SCOPE OF WORK.

 2. ALL PLAN DIMENSIONS ARE NOMINAL TO FACE OF WALL. WALL THICKNESSES ARE SHOWN NOMINAL, SEE WALL TYPES FOR ACTUAL THICKNESS.
 - 3. ALL GYP. WALLS ARE TO BE 5 INCHES THICK UNLESS OTHERWISE NOTED.

 4. ALL CONCRETE BLOCK WALLS ARE TO BE 8
 - INCHES THICK UNLESS OTHERWISE NOTED.

 5. COORDINATE SIZE AND LOCATION OF ALL DUCT AND SHAFT OPENINGS IN WALLS AND FLOORS W/ MECH. AND ELEC. PROVIDE ALL REQUIRED LINTELS FOR OPENINGS. SEE LINTEL SCHEDULE.
 - 6. FIELD VERIFY ALL MILLWORK OPENINGS.
 7. SET FLOOR DRAINS 3/4" BELOW FINISHED CONCRETE FLOORS UNLESS OTHERWISE NOTED. PROVIDE CONSISTENT SLOPE FROM WALL TO DRAIN BY SLOPING
 - FROM WALL TO DRAIN BY SLOPING CONCRETE, MIN. 1/4" PER FOOT. 8. VERIFY LOCATION, SIZE AND QUANTITYOF ALL MECHANICAL AND ELECTRICAL
 - EQUIPMENT PADS.

 9. ALL DOOR/SIDELITE OPENINGS TO BEGIN 4"
 FROM ADJACENT WALL UNLESS OTHERWISE
 NOTED.

PARTIAL FLOOR PLANS KEY NOTES:

- 1 REFERENCE KITCHEN CONSULTANT SHEETS FOR EQUIPMENT INFORMATION. TYPICAL ALL AREAS.
- 2 LOCATION OF NEW HOOD. EXISTING CEILING IS 1"
 ROCK LATHE AND PLASTER WITH COLD-ROLLED
 STEEL FRAMING. CUT CEILING FOR INSTALLATION
 OF HOOD AND ASSOCIATED MECHANICAL
 COMPONENTS. REFER TO DETAIL _ FOR NEW
 STEEL FRAMING TO SUPPORT HOOD. PROVIDE
 ADDITIONAL METAL STUD FRAMING TO SUPPORT
 EXISTING CEILING SYSTEM AS NEEDED. VERIFY
 ALL CONDITIONS IN FIELD PRIOR TO BID.

 3 REPAINT CEILING OF ENTIRE ROOM WITH EPOXY
- PAINT TO MATCH EXISTING. VERIFY THAT SURFACE IS PREPARED TO RECEIVE EPOXY PAINT FINISH.

 4 REPAINT ENTIRE WALLS INDICATED WITH EPOXY PAINT TO MATCH EXISTING COLOR. VERIFY THAT

SURFACE IS PREPARED TO RECEIVE EPOXY PAINT

- PROVIDE NEW COUNTER AT 31" A.F.F. REFER TO DETAIL FOR ADDITIONAL INFORMATION.
- 6 REPAINT THIS ENTIRE WALL AFTER INSTALLATION OF NEW SERVICE COUNTER IS COMPLETED. MATCH ADJACENT WALL COLORS.
- 7 PROVIDE STEEL ANGLES TO SUPPORT NEW HOOD.
- (8) REFER TO MECHANICAL PLANS FOR ADDITIONAL INFORMATION ON NEW FLOOR DRAIN IN THIS LOCATION.
- 9 LOCATION OF NEW GENERATOR TO BE MOUNTED ON ROOF. REFER TO ENGINEERING DRAWINGS FOR ADDITIONAL INFORMATION.
- (10) REFER TO ENGINEERING DRAWINGS FOR MORE INFORMATION ON NEW GROUND MOUNTED GENERATOR IN THIS LOCATION. RESTORE SOIL AND GRASS AS REQUIRED AFTER INSTALLATION.
- REMOVE AND REINSTALL FENCE AS REQUIRED FOR INSTALLATION OF NEW GENERATOR AND
- PROVIDE WATERPROOF CAULKING AT ALL NEW WALL PENETRATIONS FOR GENERATOR CONNECTIONS.
- (13) BACKFILL AND POUR NEW CONCRETE. FURNISH AND INSTALL FINISH FLOOR MATERIAL TO MATCH EXISTING QUARRY TILE IN KITCHEN AND VCT IN HALLWAY. SUBMIT FINISH SAMPLES FOR APPROVAL.
- 14) PATCH MINIMUM OF 20 SQUARE FEET OF QUARRY TILE IN KITCHEN.
- 15) PATCH MINIMUM OF 70 SQUARE FEET OF VCT THIS

DEMOLITION LEGEND

WALL TO REMAIN

WALL TO BE REMOVED

DOOR TO REMAIN

DOOR, FRAME, AND HARDWARE TO BE REMOVED UNLESS NOTED OTHERWISE

— — — DESIGNATED ITEM TO BE REMOVED

DESIGNATED ITEM TO REMAIN

DEMOLITION GENERAL NOTES

DEMOLITION NOTES AND PLANS ARE PROVIDED AS A GUIDE ONLY.
 CONTRACTOR TO VERIFY EXISTING CONDITIONS AND EXAMINE
 DRAWINGS AND DETAILS TO DETERMINE EXTENT AND LIMITS OF
 DEMOLITION REQUIRED TO ACCOMMODATE NEW CONSTRUCTION.

2. CONTRACTOR IS RESPONSIBLE FOR COORDINATION OF ALL
ASPECTS OF DEMOLITION. CONTRACTOR TO REVIEW ALL DRAWINGS
FOR ADDITIONAL DETAILS AND CONSTRUCTION SEQUENCING NOTES.
MECHANICAL AND ELECTRICAL DEMOLITIONS ARE SHOWN ON

MECHANICAL AND ELECTRICAL DRAWINGS.

3. REFER TO MECHANICAL AND ELECTRICAL FOR ADDITIONAL

DEMOLITION NOTES.

4. CONTRACTOR TO COORDINATE DEMOLITION WITH DETAILS AND STRUCTURAL DRAWINGS TO INSTALL NEW LINTELS OR STRUCTURAL COMPONENTS TO SUPPORT EXISTING STRUCTURE.

5. PROVIDE AND COORDINATE ALL DEMOLITION AND RECONSTRUCTION WITH NEW WORK PLAN DIMENSIONS AND INSTALLATION OF NEW MATERIALS AND FINISHES, AS REQUIRED, WHETHER INDICATED ON DRAWINGS OR NOT.

6. PROVIDE SMOOTH AND CLEAN SUBSTRATE TO ALL AREAS RECEIVING NEW FINISHES. COORDINATE WORK WITH PLANS AND THE ROOM FINISH SCHEDULE.

7. ALL RELATED WOOD BLOCKING SUPPORT STRUCTURE, HARDWARE CONNECTION DEVICES, ADHESIVES, AND/OR MASTIC SHALL BE REMOVED FROM SURFACES AT ITEMS NOTED FOR REMOVAL. PROVIDE SURFACES ACCEPTABLE FOR PATCHING AND/OR NEW WORK

8. DEMOLITION NOTES WITHOUT ARROWS INDICATE THAT THE NOTE APPLIES TO THE ENTIRE ROOM.

DEMOLITION PLAN KEY NOTES:

1 REFER TO ENGINEERING DRAWINGS FOR INFORMATION ON SAWCUTTING OF FLOOR FOR INSTALLATION OF NEW FLOOR DRAINS IN KITCHEN.

REMOVE EXISTING SERVICE COUNTER, SUBSTRATE, AND ADHESIVES AND/OR FASTENERS TO EXPOSE BARE CONCRETE MASONRY UNIT BELOW. PREPARE TO RECEIVE ADDITIONAL COURSE OF MASONRY AS NEEDED.

REMOVE CEILING AS NEEDED TO ACCOMMODATE NEW HOOD AND SUPPORTS IN THIS LOCATION.

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Redford Union Schools

17715 Brady Street Redford, MI 48240

architects

www.woldae.com

Clawson, MI 48017 mail@woldae.com

710 North Crooks Road

tel 248 284 0611

fax 248 284 0615

S:_Michigan (T Drive)\Michigan\Redford Union\154007_Kitchen and Generators\Redford

A

Scale: As indicated

I hereby certify that this plan, specification or report was prepared by me or under my direct supervision and that I am a duly Licensed

Registration Number Arch Num Date Issue Date

Revisions

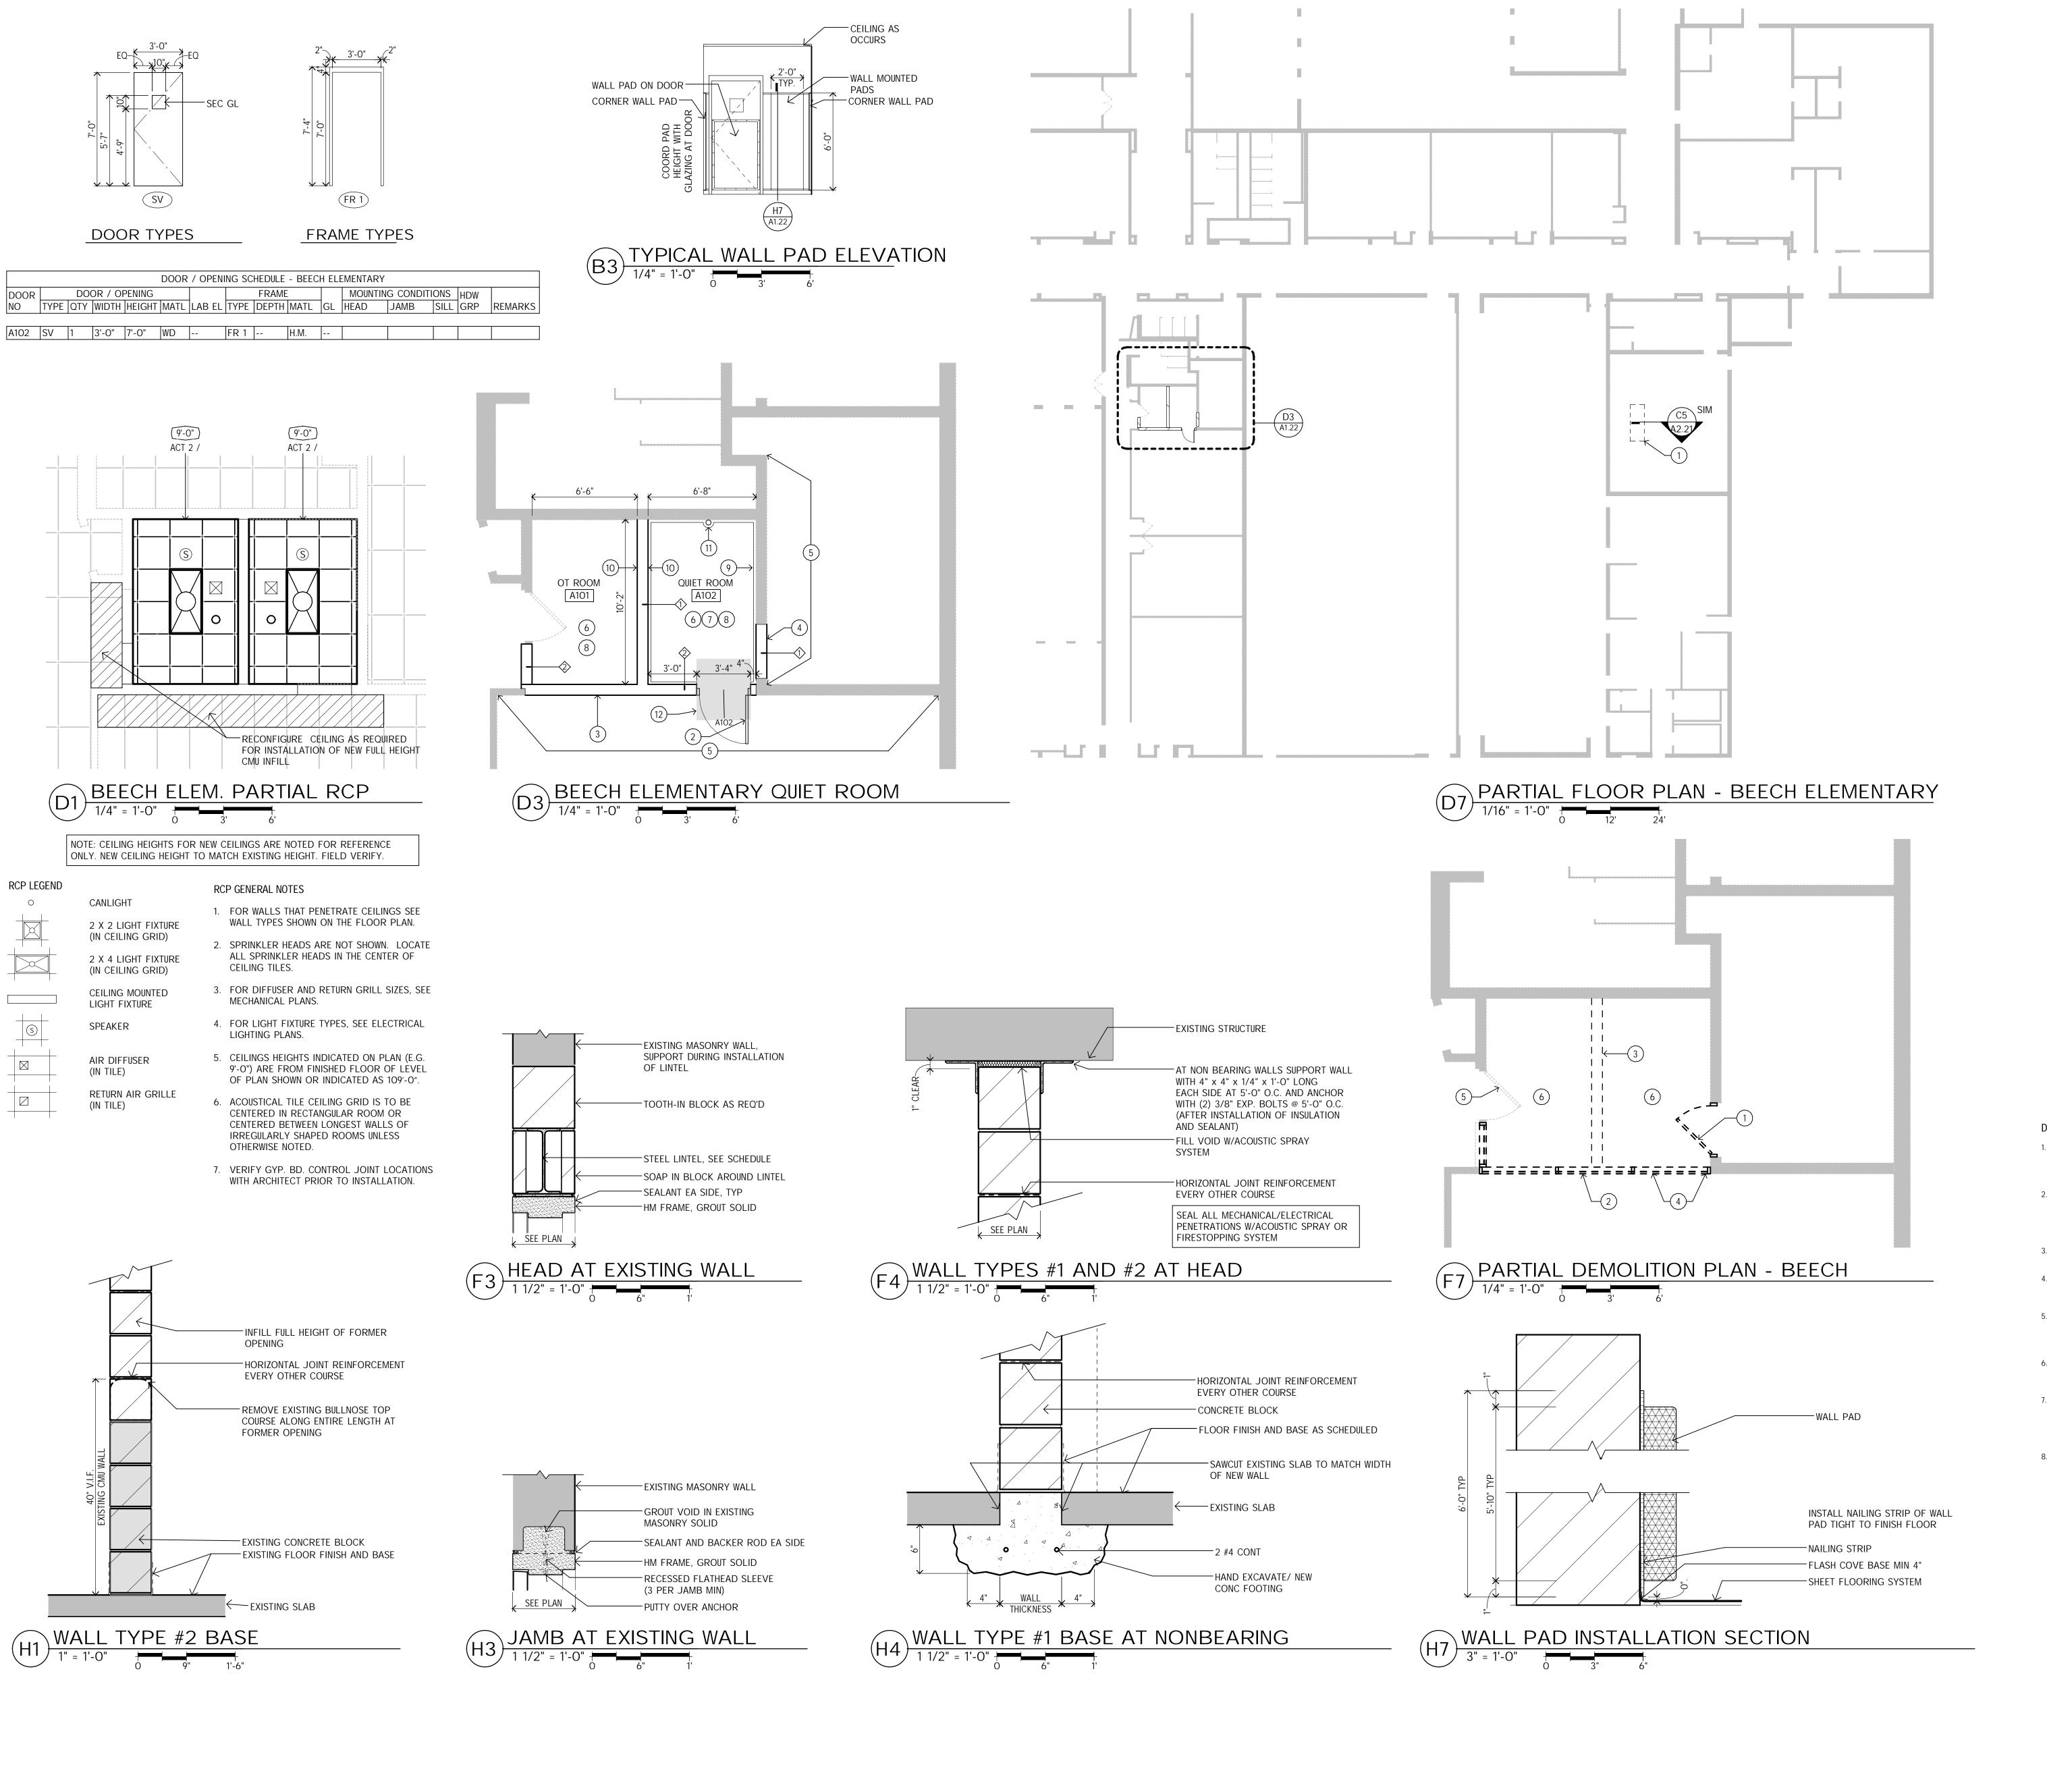
under the laws of the State of MICHIGAN

Date: September 21 2015

PARTIAL PLANS

Drawn: Author

Check: Checker



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FLOOR PLAN GENERAL NOTES:

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- 1. REFER TO DETAILS OF CONSTRUCTION FOR: A. ABBREVIATIONS, MATERIAL SYMBOLS B. MOUNTING HEIGHTS
- C. LINTEL SCHEDULE D. MATERIAL FINISH/COLOR SCHEDULE E. WALL TYPES F. MARKER BD TYPES AND MOUNTING HTS THE ABOVE SECTIONS ARE LISTED FOR
- REFERENCE ONLY, AND ARE NOT EXCLUSIVE TO AREAS OF WORK. ALL DETAILS SHALL BE REVIEWED FOR SCOPE OF WORK. 2. ALL PLAN DIMENSIONS ARE NOMINAL TO
- SHOWN NOMINAL, SEE WALL TYPES FOR ACTUAL THICKNESS. 3. ALL GYP. WALLS ARE TO BE 5 INCHES THICK

FACE OF WALL. WALL THICKNESSES ARE

- UNLESS OTHERWISE NOTED. 4. ALL CONCRETE BLOCK WALLS ARE TO BE 8 INCHES THICK UNLESS OTHERWISE NOTED.
- 5. COORDINATE SIZE AND LOCATION OF ALL DUCT AND SHAFT OPENINGS IN WALLS AND FLOORS W/ MECH. AND ELEC. PROVIDE ALL REQUIRED LINTELS FOR OPENINGS. SEE LINTEL SCHEDULE.
- 6. FIELD VERIFY ALL MILLWORK OPENINGS. 7. SET FLOOR DRAINS 3/4" BELOW FINISHED CONCRETE FLOORS UNLESS OTHERWISE NOTED. PROVIDE CONSISTENT SLOPE FROM WALL TO DRAIN BY SLOPING CONCRETE, MIN. 1/4" PER FOOT.
- 8. VERIFY LOCATION, SIZE AND QUANTITYOF ALL MECHANICAL AND ELECTRICAL EQUIPMENT PADS.
- 9. ALL DOOR/SIDELITE OPENINGS TO BEGIN 4" FROM ADJACENT WALL UNLESS OTHERWISE

PARTIAL FLOOR PLANS KEY NOTES:

- (1) LOCATION OF NEW GENERATOR TO BE MOUNTED ON ROOF. REFER TO ENGINEERING DRAWINGS FOR ADDITIONAL INFORMATION.
- (2) NEW 36" WOOD DOOR WITH HOLLOW METAL FRAME IN THIS LOCATION.
- (3) INFILL WALL AT FORMER LOCATION OF WOOD FRAME WINDOW SYSTEM WITH CONCRETE BLOCK. ALIGN MORTAR JOINTS WITH EXISTING WALL JOINTS TO MINIMIZE CONTRAST BETWEEN EXISTING AND INFILL.
- (4) INFILL WALL AT FORMER LOCATION OF DOOR WITH CONCRETE BLOCK. ALIGN MORTAR JOINTS WITH EXISTING WALL JOINTS TO MINIMIZE CONTRAST BETWEEN EXISTING AND INFILL.
- (5) REPAINT ENTIRE WALL AFTER INFILLING OPENING. MATCH EXISTING PAINT COLOR.
- (6) PAINT ALL WALLS IN THIS ROOM.
- 7) INSTALL MATS AT ALL WALLS IN THIS ROOM. (8) REPAIR CEILING AS NEEDED AFTER CONSTRUCTION OF NEW WALL. SEE ENGINEERING DRAWINGS FOR INFORMATION ON RECONFIGURING LIGHTING, MECHANICAL, AND FIRE SAFETY
- (9) INSTALL NEW FULL-LENGTH MIRROR IN THIS LOCATION.
- (10) PROVIDE VINYL COVE BASE ON EACH SIDE OF

REQUIREMENTS IN THIS ROOM.

- NEW WALL.
- (11) BUILD PADDING AROUND EXISTING PIPE. (12) PATCH VCT AT NEW DOOR TO MATCH EXISTING.

DEMOLITION LEGEND

WALL TO REMAIN

_ _ _ _ WALL TO BE REMOVED DOOR TO REMAIN DOOR, FRAME, AND HARDWARE TO BE REMOVED UNLESS NOTED OTHERWISE

— — — DESIGNATED ITEM TO BE REMOVED

DESIGNATED ITEM TO REMAIN

DEMOLITION GENERAL NOTES

- 1. __ DEMOLITION NOTES AND PLANS ARE PROVIDED AS A GUIDE ONLY. CONTRACTOR TO VERIFY EXISTING CONDITIONS AND EXAMINE DRAWINGS AND DETAILS TO DETERMINE EXTENT AND LIMITS OF DEMOLITION REQUIRED TO ACCOMMODATE NEW CONSTRUCTION.
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- REFER TO MECHANICAL AND ELECTRICAL FOR ADDITIONAL DEMOLITION NOTES.
- CONTRACTOR TO COORDINATE DEMOLITION WITH DETAILS AND STRUCTURAL DRAWINGS TO INSTALL NEW LINTELS OR STRUCTURAL COMPONENTS TO SUPPORT EXISTING STRUCTURE.
- PROVIDE AND COORDINATE ALL DEMOLITION AND RECONSTRUCTION WITH NEW WORK PLAN DIMENSIONS AND INSTALLATION OF NEW MATERIALS AND FINISHES, AS REQUIRED, WHETHER INDICATED ON DRAWINGS OR NOT.
- PROVIDE SMOOTH AND CLEAN SUBSTRATE TO ALL AREAS RECEIVING NEW FINISHES. COORDINATE WORK WITH PLANS AND THE ROOM FINISH SCHEDULE.
- 7. ALL RELATED WOOD BLOCKING SUPPORT STRUCTURE, HARDWARE CONNECTION DEVICES, ADHESIVES, AND/OR MASTIC SHALL BE REMOVED FROM SURFACES AT ITEMS NOTED FOR REMOVAL. PROVIDE SURFACES ACCEPTABLE FOR PATCHING AND/OR NEW
- 8. DEMOLITION NOTES WITHOUT ARROWS INDICATE THAT THE NOTE APPLIES TO THE ENTIRE ROOM.

DEMOLITION PLAN KEY NOTES:

- (1) REMOVE EXISTING DOOR, FRAME, AND
- HARDWARE. (2) REMOVE EXISTING WOOD FRAMED WINDOW SYSTEM. PREPARE OPENING FOR INFILL AS
- NEEDED. (3) SAWCUT FLOOR, REFER TO DETAIL G4/A1.22. DEMOLISH CEILING DIRECTLY ABOVE THIS AREA
- AS REQUIRED TO FACILITATE INSTALLATION OF NEW WALL. (4) REMOVE PORTION OF WALL BELOW EXISTING WINDOW SYSTEM IN THIS LOCATION TO
- ACCOMMODATE NEW DOOR, REFER TO CONSTRUCTION PLAN FOR EXTENTS. (5) PROTECT EXISTING WOOD DOOR AND FRAME DURING DEMOLITION.
- (6) DEMOLISH EXISTING CEILING. SEE MECHANICAL AND ELECTRICAL FOR REMOVAL OF EXISTING FIXTURES AND DEVICES.

Redford Union Schools Kitchen Improvements and Generators

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Redford Union Schools 17715 Brady Street Redford, MI 48240



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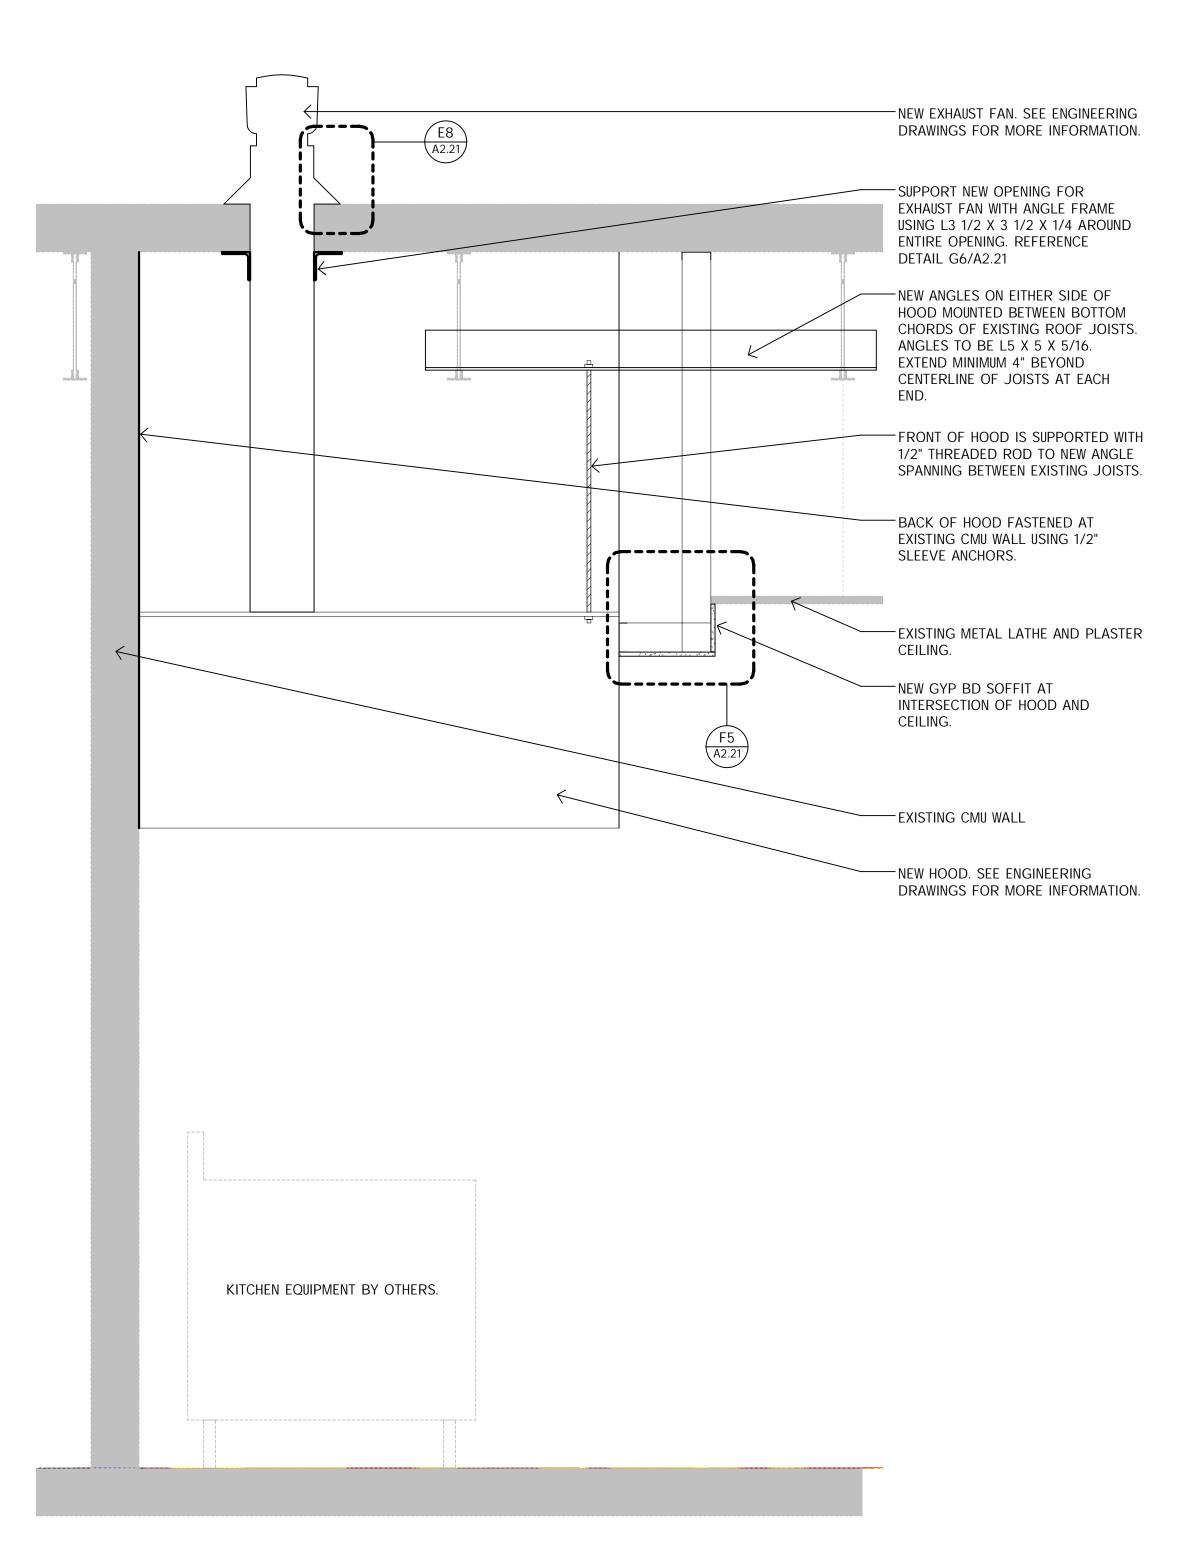
710 North Crooks Road **fax** 248 284 0615 Clawson, MI 48017 mail@woldae.com

I hereby certify that this plan, specification or report was prepared by me or under my direct supervision and that I am a duly Licensed ARCHITECT under the laws of the State of MICHIGAN

Revisions Comm: 154007 Date: September 21 2015 Drawn: Author Check: Checker

BEECH ELEMENTARY PARTIAL PLANS AND DETAILS

A



		MATERIAL FINISH/ C	OFOR 2CHEDOFE	
	Item	Manufacturer	Color/ Finish	Location Used
08 14 00	Wood Doors			
	Prefinished Stained Wood Door	Marshfield	Color to match existing doors	Beech Elementary
08 71 00	Finish Hardware			
	Butt Hinges-Interior	As specified	US26D on steel	Beech Elementary
	Pulls And Push Plates/ Bars	As specified	US32D on stainless steel	Beech Elementary
	Coordinators	As specified	USP on steel	Beech Elementary
	Closers	As specified	Sprayed AL on cast iron or aluminum	Beech Elementary
	Protective Plates	As specified	US32D on stainless Steel	Beech Elementary
	Overhead Stops	As specified	US26D on brass, bronze, or steel	Beech Elementary
	Magnetic Holders	As specified	Sprayed SA on cycolac	Beech Elementary
	Thresholds	As specified	Mill aluminum	Beech Elementary
	Miscellaneous	As specified	US26D on brass or bronze	Beech Elementary
09 30 00	Tile			
	Quarry Tile	As specified	Color to match existing	MacGowan Elementary
	Grout- Quarry tile	As specified	Color to match existing	MacGowan Elementary
09 65 00	Resilient Flooring			
	VCT 1	Armstrong	Color to match existing as selected from manufacturer's standard colors	MacGowan Elementary Beech Elementary
	Vinyl Base	Roppe	Color to match existing as selected from manufacturer's standard colors	Beech Elementary
	Reducer/ Transition Strips	Roppe	Color to match existing as selected from manufacturer's standard colors	Beech Elementary
09 91 00	Paint			
	PT 5-Interior Misc. Metals	Sherwin Williams	Color to match existing door frames	Beech Elementary
	PT 6A-Walls	Sherwin Williams	Color(s) as needed to match existing	Beech Elementary
	PT 6B-Walls	Sherwin Williams	Color(s) as needed to match existing	MacGowan Elementary
	PT 7-Soffits	Sherwin Williams	Color to match ceiling	MacGowan Elementary
	PT 8-Ceilings	Sherwin Williams	Color to match existing	MacGowan Elementary
11 66 23	Gymnasium Equipment			
	Wall Pads	Porter	Color: 08 Beige	Beech Elementary

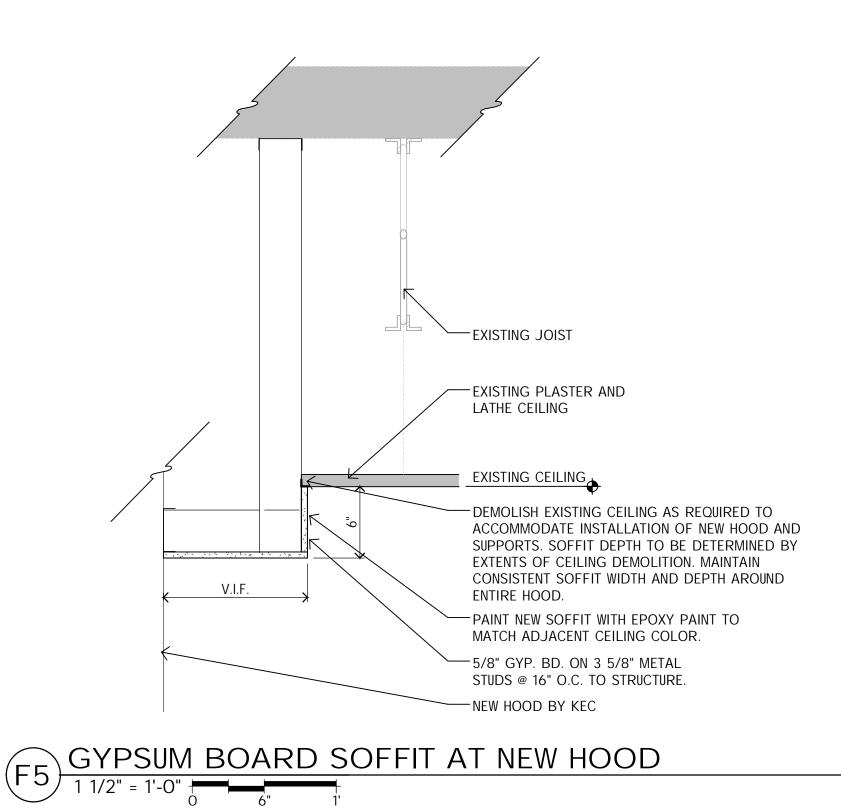
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NOTE: ALL FINISHES LISTED ON THE MATERIAL FINISH/COLOR SCHEDULE ARE FOR REFERENCE ONLY, FINAL SELECTIONS WILL BE MADE DURING SHOP

NEW GENERATOR — -WELDED PLATE SEALED WATERTIGHT SEE ENGINEERING - INSULATE VOID TO PREVENT CONDENSATION DRAWINGS FOR ATTACHMENT - MINIMUM OF 2 HIGH INFORMATION. DOMED, CAPPED, & GASKETED FASTENERS PER SIDE STRUCTURAL — - REMOVABLE SHEET METAL MEMBER. PROVIDE COUNTERFLASHING (6) POSTS AT FASTENERS 8" O.C. EACH GENERATOR LOCATION ROOF MEMBRANE SHEETS EXTENDED A MIN OF 2" ABOVE TOP OF CANT FLASHING SHEETS TO A MIN HEIGHT OF 8" ABOVE ROOF SURFACE ROOF MEMBRANE SHEETS -WOOD CANT TO BRACE -WOOD NAILERS AND CURB THERMAL INSULATION -WOOD BLOCKING AS REQUIRED EXISTING STRUCTURAL FRAMING AND WALL LOCATIONS VARY BY LOCATION. REFERENCE ENGINEERING DRAWINGS FOR ATTACHMENT INFORMATION. *NOTE: ALL ROOFS ARE UNDER WARRANTY. COORDINATE WITH MANUFACTURER TO MAINTAIN EXISTING WARRANTY.

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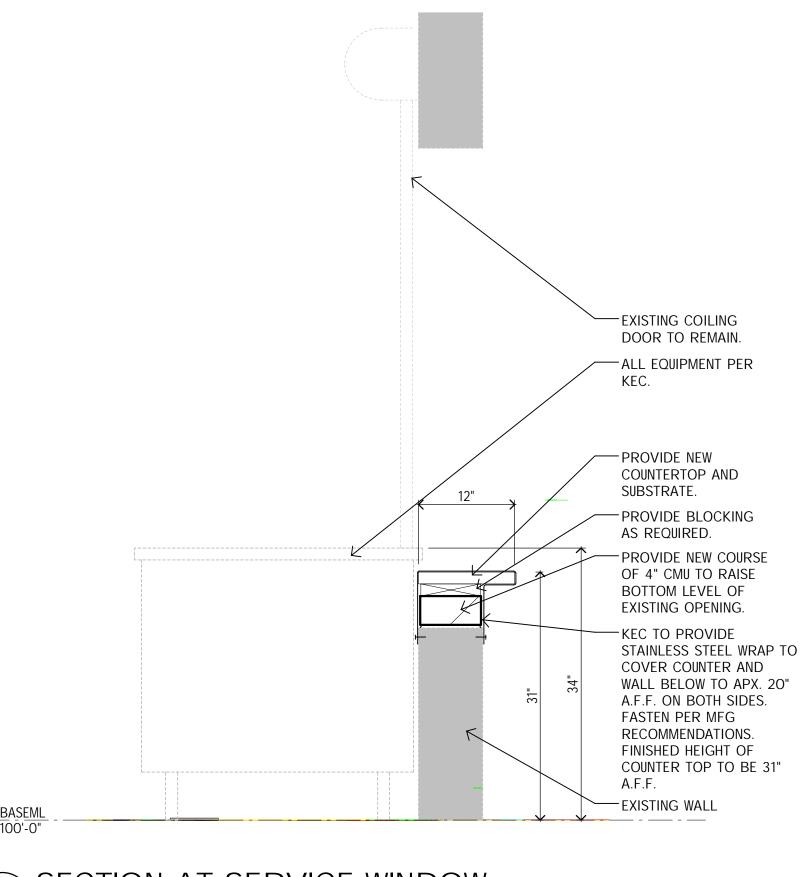
SECTION AT STRUCTURAL ROOF PENETRATION, TYP.



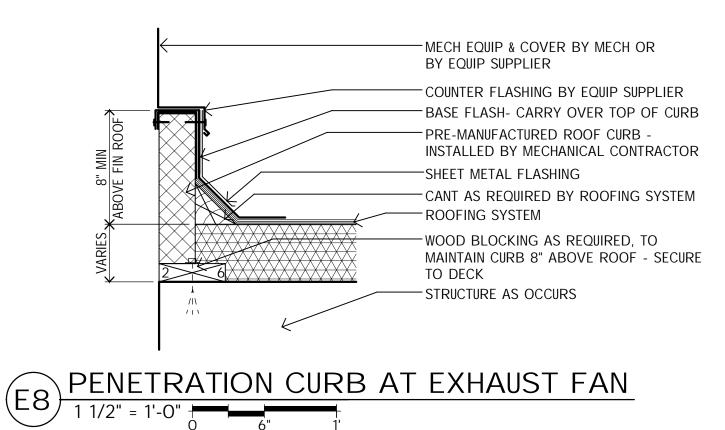
THREE PHASE MOTOR — PANELBOARD SPECIAL NEMA 230 VOLT RECEPTACLE C CONDUIT DUPLEX RECEPTACLE MFG MANUFACTURE PB PULL BOX EM EMERGENCY S SINGLE POLE SWITCH NG NATURAL GAS FUSED DISCONNECT SWITCH WH WATER HEATER — G— NATURAL GAS PIPING → HOME RUN

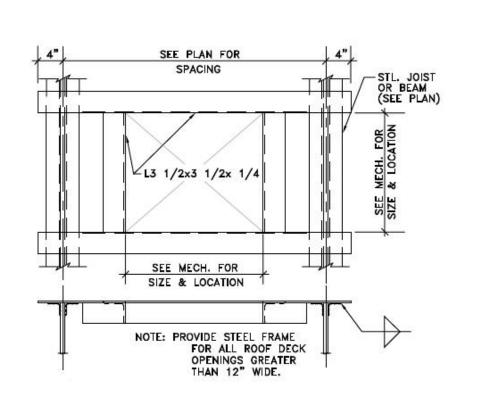
EX EXISTING → SHUT- OFF VALVE PNL PANEL ---- ELBOW DROPPING DOWN ATS AUTOMATIC TRANSFER SWITCH → VALVE IN RISER E ELECTRICAL MATURE GAS METER

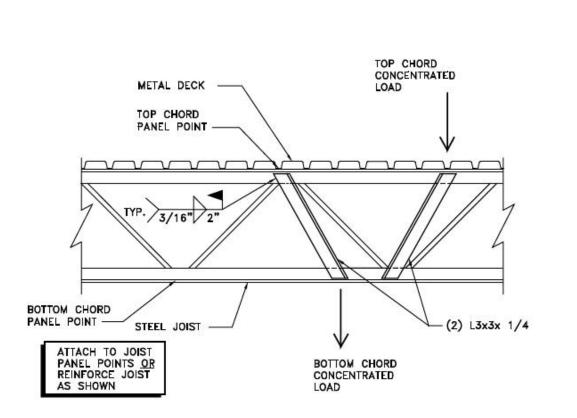
POWER CONNECTION © NATURE GAS REGULATOR = GROUND FD FLOOR DRAIN GND GROUND — — SAN— — SANITARY PIPING BELOW FLOOR



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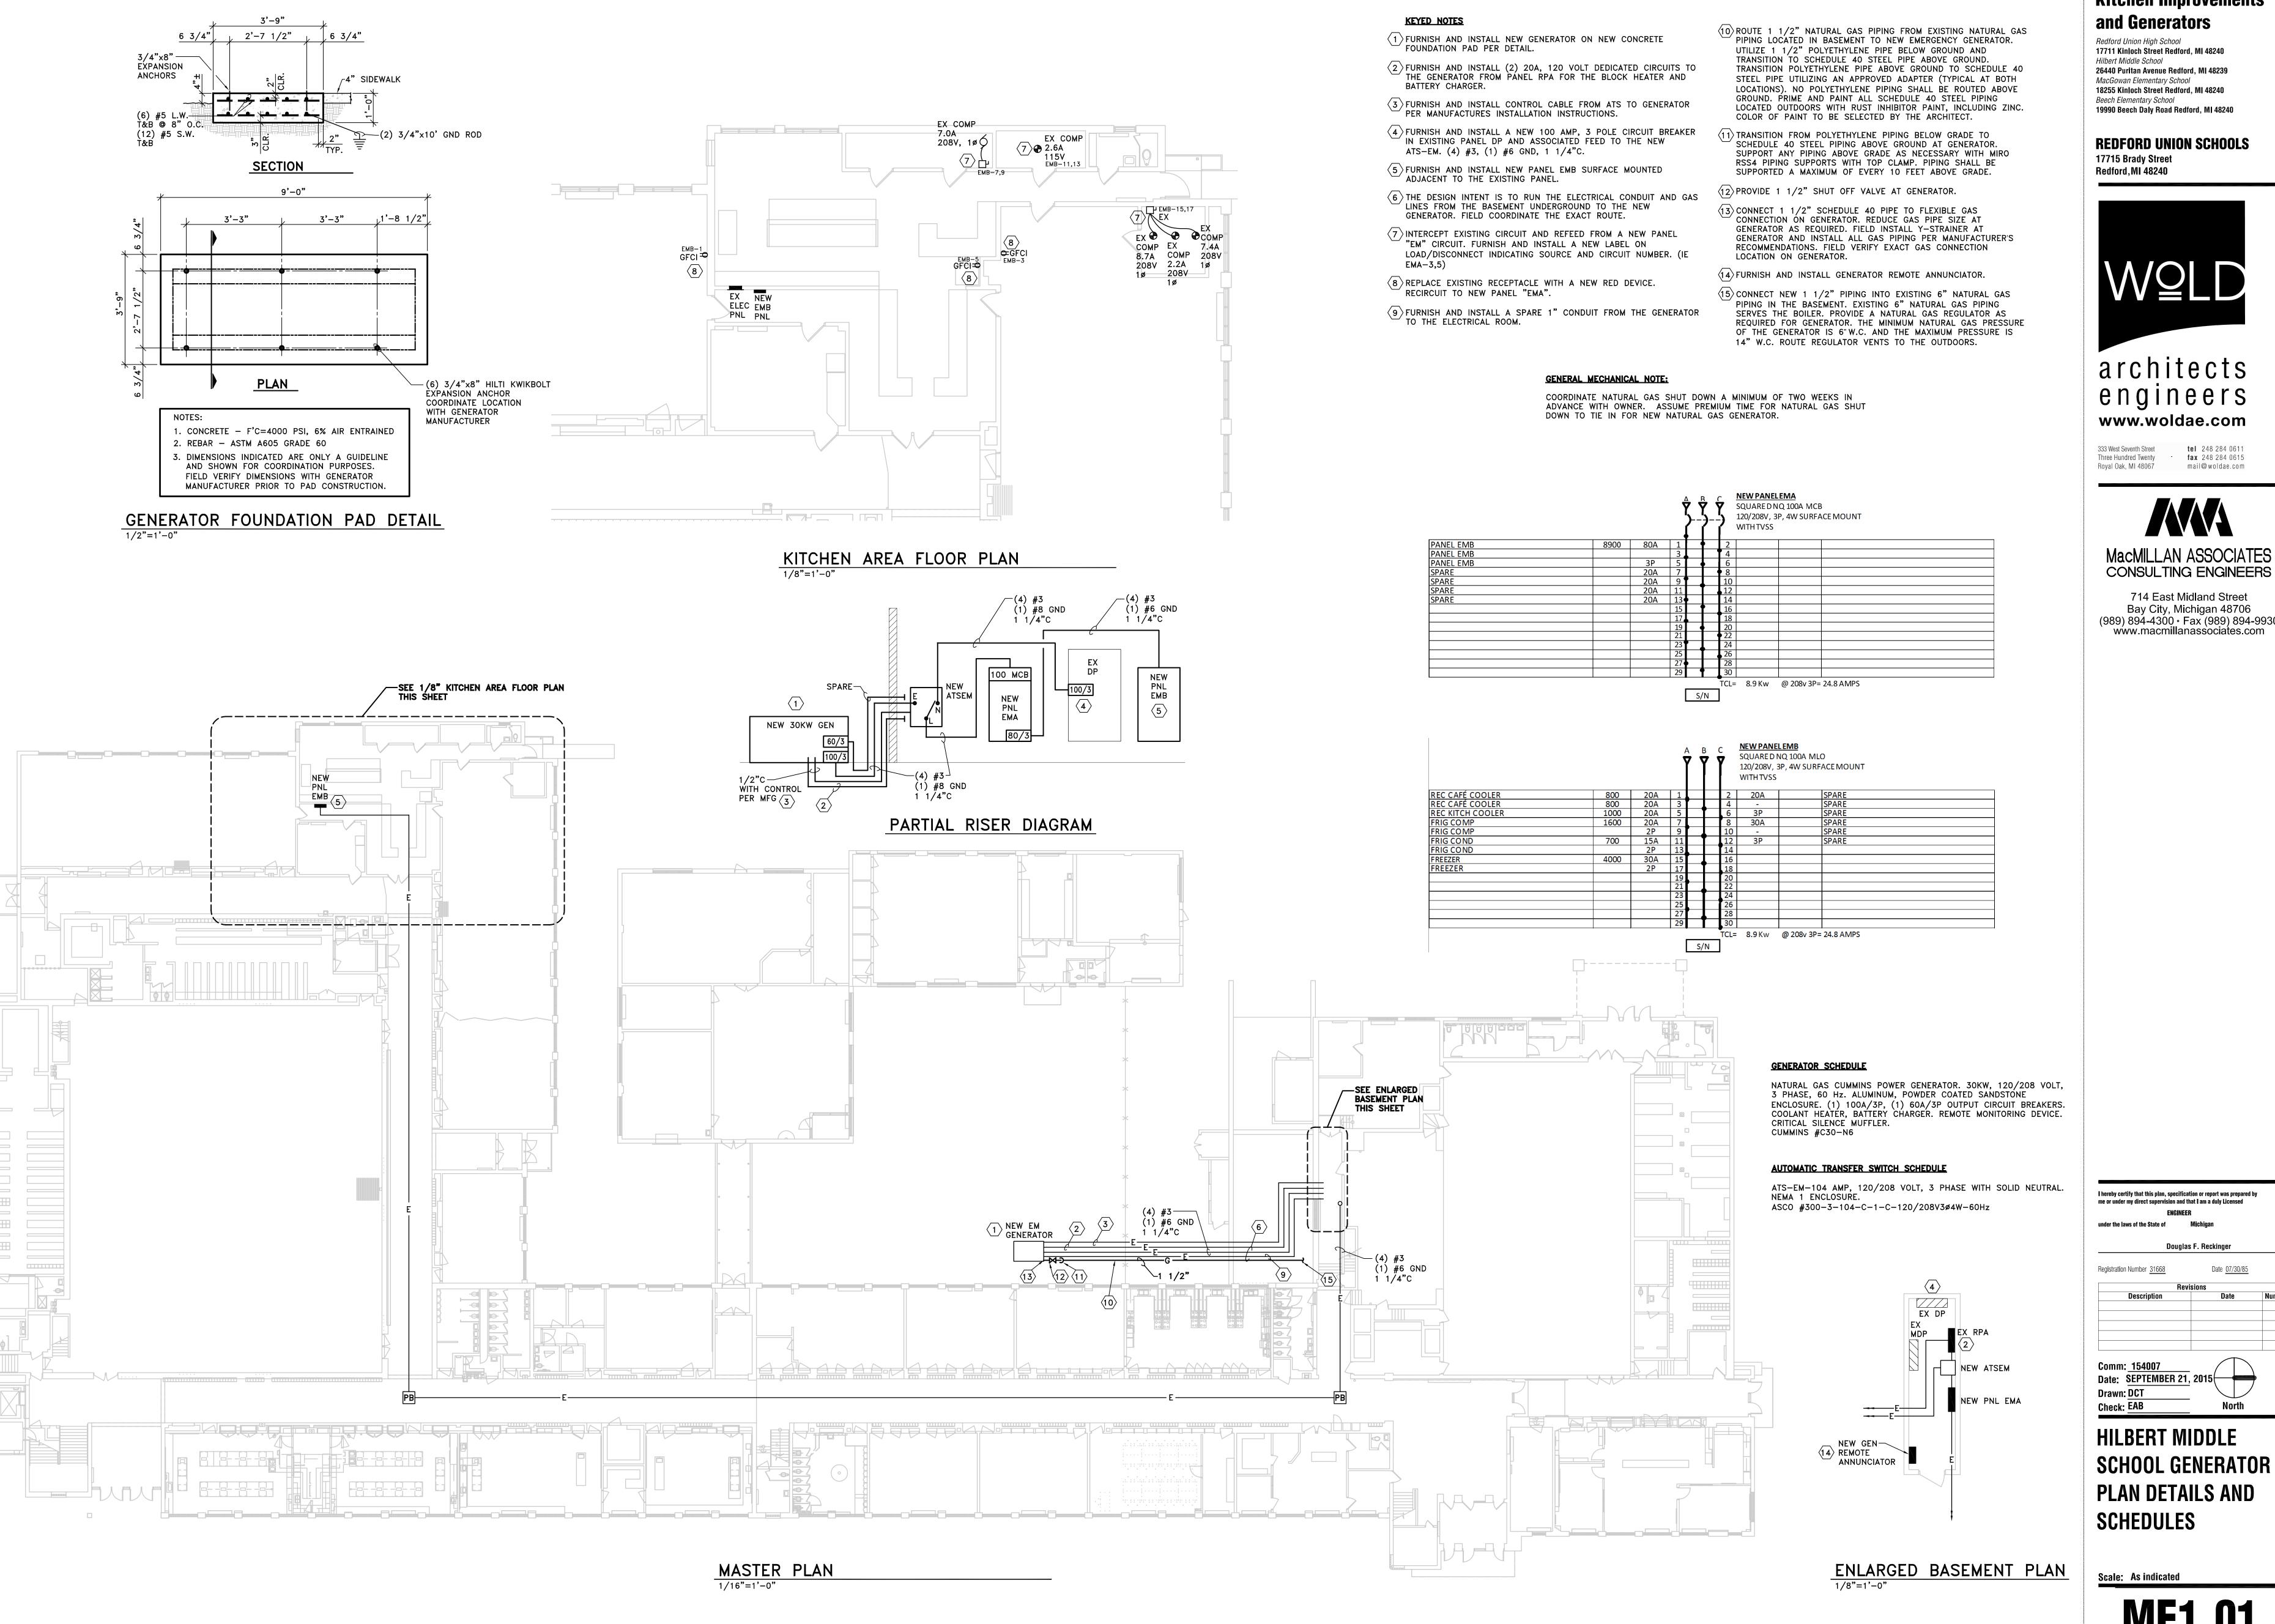
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Registration Number Arch Num Date Issue Date Revisions Comm: 154007

Date: September 21 2015 Check: Checker

DETAILS, **ENGINEERING** SYMBOLS, AND **MATERIALS**

SCHEDULE



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REDFORD UNION SCHOOLS 17715 Brady Street



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333 West Seventh Street tel 248 284 0611 Three Hundred Twenty fax 248 284 0615 Royal Oak, MI 48067 mail@woldae.com



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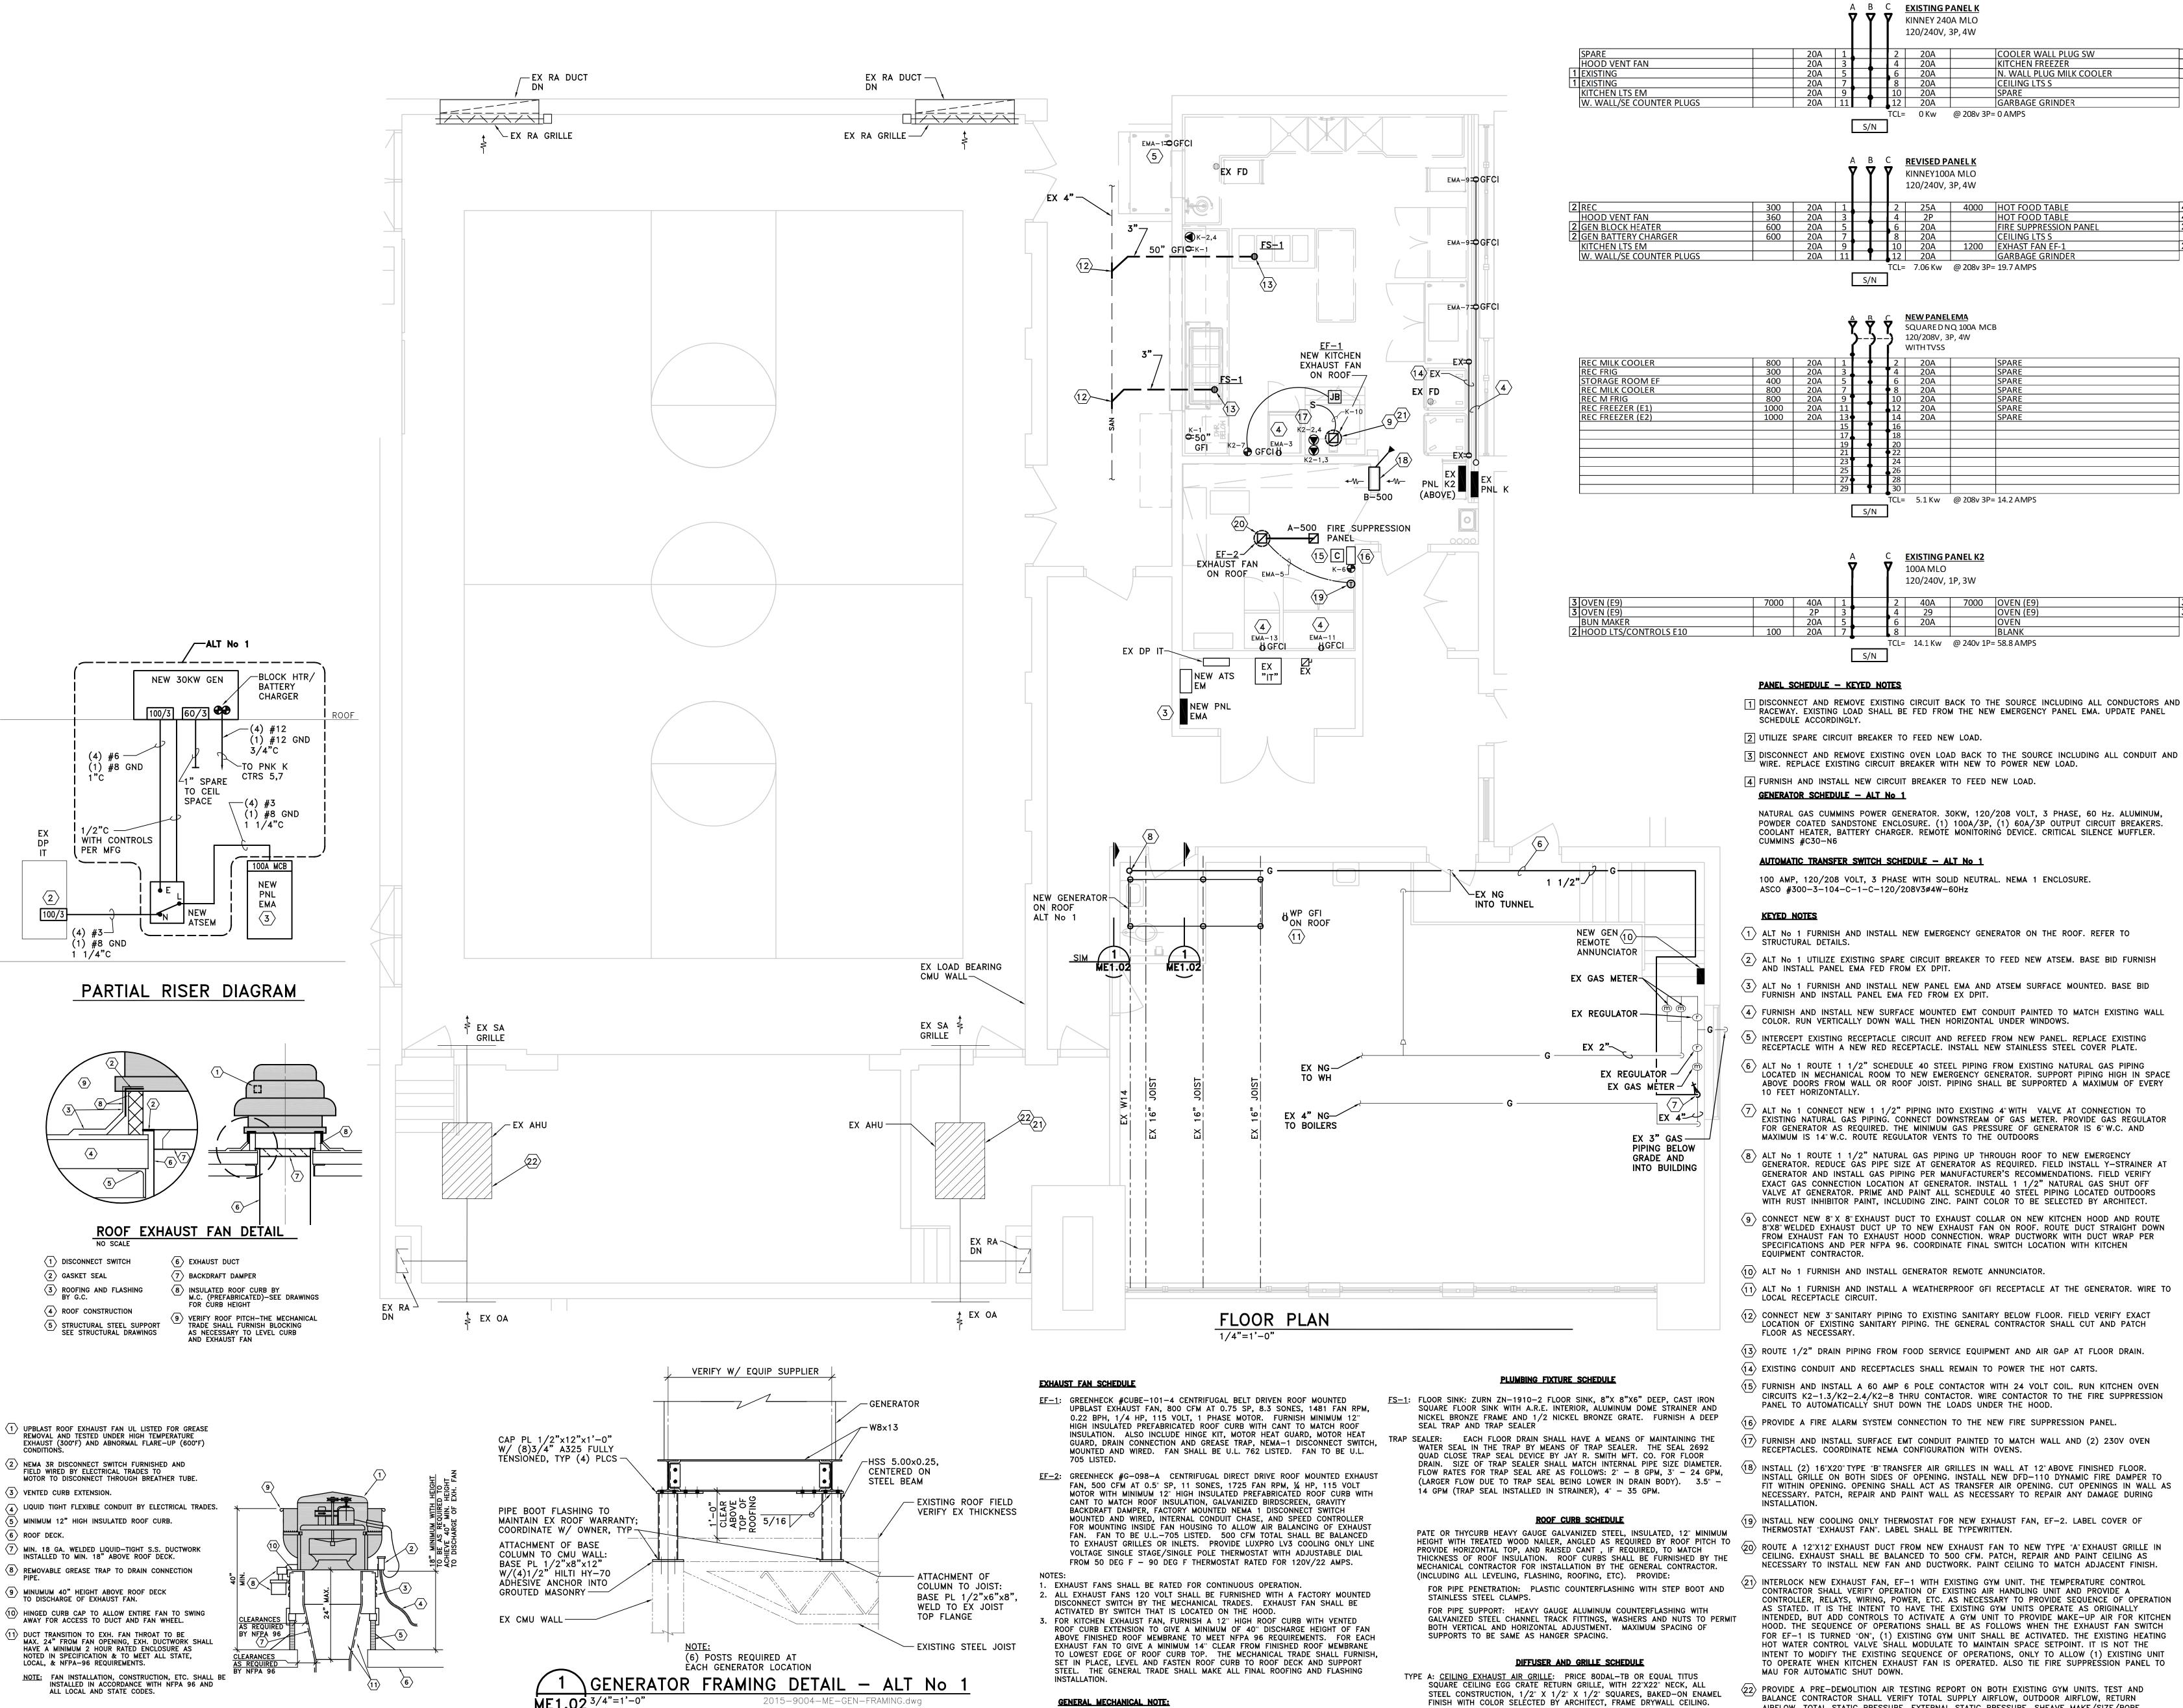
under the laws of the State of

Registration Number 31668

Date: SEPTEMBER 21, 2015

Drawn: DCT

HILBERT MIDDLE SCHOOL GENERATOR PLAN DETAILS AND **SCHEDULES**



COORDINATE NATURAL GAS SHUT DOWN A MINIMUM OF TWO WEEKS IN

DOWN TO TIE IN FOR NEW NATURAL GAS GENERATOR.

ADVANCE WITH OWNER. ASSUME PREMIUM TIME FOR NATURAL GAS SHUT

TYPE B: WALL RETURN OR EXHAUST GRILLE: PRICE 530DL (530DS) OR EQUAL

HORIZONTAL BLADES SET AT 35 DEGREES.

TITUS WALL RETURN OR EXHAUST GRILLE, ALL STEEL CONSTRUCTION,

BAKED-ON ENAMEL FINISH WITH COLOR BY ARCHITECT. ONE SET OF

KITCHEN HOOD EXHAUST FAN DETAIL

Redford Union Schools Kitchen Improvements

and Generators Redford Union High School

Redford, MI 48240

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714 East Midland Street Bay City, Michigan 48706 (989) 894-4300 · Fax (989) 894-9930 www.macmillanassociates.com

100 AMP, 120/208 VOLT, 3 PHASE WITH SOLID NEUTRAL. NEMA 1 ENCLOSURE. ASCO #300-3-104-C-1-C-120/208V3ø4W-60Hz

EXISTING PANEL K KINNEY 240A MLO

120/240V, 3P, 4W

TCL= 0 Kw @ 208v 3P= 0 AMPS

TCL= 7.06 Kw @ 208v 3P= 19.7 AMPS

REVISED PANEL K KINNEY100A MLO

120/240V, 3P, 4W

<u>NEW PANELEMA</u>

120/208V, 3P, 4W

WITHTVSS

SQUAREDNQ 100A MCB

TCL= 5.1 Kw @ 208v 3P= 14.2 AMPS

TCL= 14.1 Kw @ 240v 1P= 58.8 AMPS

EXISTING PANEL K2

120/240V, 1P, 3W

100A MLO

OOLER WALL PLUG SW TCHEN FREEZER . WALL PLUG MILK COOLER

IRE SUPPRESSION PANE

EILING LTS S

GARBAGE GRINDE

- $\langle 1 \rangle$ ALT No 1 FURNISH AND INSTALL NEW EMERGENCY GENERATOR ON THE ROOF. REFER TO
- (2) ALT No 1 UTILIZE EXISTING SPARE CIRCUIT BREAKER TO FEED NEW ATSEM. BASE BID FURNISH AND INSTALL PANEL EMA FED FROM EX DPIT.
- (3) ALT No 1 FURNISH AND INSTALL NEW PANEL EMA AND ATSEM SURFACE MOUNTED. BASE BID FURNISH AND INSTALL PANEL EMA FED FROM EX DPIT.
- COLOR. RUN VERTICALLY DOWN WALL THEN HORIZONTAL UNDER WINDOWS. (5) INTERCEPT EXISTING RECEPTACLE CIRCUIT AND REFEED FROM NEW PANEL. REPLACE EXISTING
- RECEPTACLE WITH A NEW RED RECEPTACLE. INSTALL NEW STAINLESS STEEL COVER PLATE. $\langle 6 \rangle$ ALT No 1 ROUTE 1 1/2" SCHEDULE 40 STEEL PIPING FROM EXISTING NATURAL GAS PIPING
- $\langle 7 \rangle$ alt no 1 connect new 1 1/2" piping into existing 4" with $\,$ valve at connection to EXISTING NATURAL GAS PIPING. CONNECT DOWNSTREAM OF GAS METER. PROVIDE GAS REGULATOR
- FOR GENERATOR AS REQUIRED. THE MINIMUM GAS PRESSURE OF GENERATOR IS 6" W.C. AND MAXIMUM IS 14" W.C. ROUTE REGULATOR VENTS TO THE OUTDOORS
- GENERATOR, REDUCE GAS PIPE SIZE AT GENERATOR AS REQUIRED, FIELD INSTALL Y-STRAINER AT GENERATOR AND INSTALL GAS PIPING PER MANUFACTURER'S RECOMMENDATIONS. FIELD VERIFY EXACT GAS CONNECTION LOCATION AT GENERATOR. INSTALL 1 1/2" NATURAL GAS SHUT OFF VALVE AT GENERATOR. PRIME AND PAINT ALL SCHEDULE 40 STEEL PIPING LOCATED OUTDOORS WITH RUST INHIBITOR PAINT, INCLUDING ZINC. PAINT COLOR TO BE SELECTED BY ARCHITECT.
- (9) CONNECT NEW 8" X 8" EXHAUST DUCT TO EXHAUST COLLAR ON NEW KITCHEN HOOD AND ROUTE 8"X8" WELDED EXHAUST DUCT UP TO NEW EXHAUST FAN ON ROOF. ROUTE DUCT STRAIGHT DOWN FROM EXHAUST FAN TO EXHAUST HOOD CONNECTION. WRAP DUCTWORK WITH DUCT WRAP PER SPECIFICATIONS AND PER NFPA 96. COORDINATE FINAL SWITCH LOCATION WITH KITCHEN EQUIPMENT CONTRACTOR.
- (10) ALT No 1 FURNISH AND INSTALL GENERATOR REMOTE ANNUNCIATOR.
- $\langle 12 \rangle$ connect new 3" sanitary piping to existing sanitary below floor. Field verify exact LOCATION OF EXISTING SANITARY PIPING. THE GENERAL CONTRACTOR SHALL CUT AND PATCH
- (13) ROUTE 1/2" DRAIN PIPING FROM FOOD SERVICE EQUIPMENT AND AIR GAP AT FLOOR DRAIN.
- (15) FURNISH AND INSTALL A 60 AMP 6 POLE CONTACTOR WITH 24 VOLT COIL. RUN KITCHEN OVEN CIRCUITS K2-1.3/K2-2.4/K2-8 THRU CONTACTOR. WIRE CONTACTOR TO THE FIRE SUPPRESSION PANEL TO AUTOMATICALLY SHUT DOWN THE LOADS UNDER THE HOOD.
- $|\hat{f 16}
 angle$ provide a fire alarm system connection to the new fire suppression panel
- 17) FURNISH AND INSTALL SURFACE EMT CONDUIT PAINTED TO MATCH WALL AND (2) 230V OVEN RECEPTACLES. COORDINATE NEMA CONFIGURATION WITH OVENS.
- 18) INSTALL (2) 16"X20" TYPE "B" TRANSFER AIR GRILLES IN WALL AT 12" ABOVE FINISHED FLOOR. INSTALL GRILLE ON BOTH SIDES OF OPENING. INSTALL NEW DFD-110 DYNAMIC FIRE DAMPER TO FIT WITHIN OPENING. OPENING SHALL ACT AS TRANSFER AIR OPENING. CUT OPENINGS IN WALL AS NECESSARY. PATCH, REPAIR AND PAINT WALL AS NECESSARY TO REPAIR ANY DAMAGE DURING
- (19) INSTALL NEW COOLING ONLY THERMOSTAT FOR NEW EXHAUST FAN, EF-2. LABEL COVER OF THERMOSTAT "EXHAUST FAN". LABEL SHALL BE TYPEWRITTEN.
- (20) ROUTE A 12"X12" EXHAUST DUCT FROM NEW EXHAUST FAN TO NEW TYPE "A" EXHAUST GRILLE IN CEILING, EXHAUST SHALL BE BALANCED TO 500 CFM, PATCH, REPAIR AND PAINT CEILING AS NECESSARY TO INSTALL NEW FAN AND DUCTWORK. PAINT CEILING TO MATCH ADJACENT FINISH.
- (21) INTERLOCK NEW EXHAUST FAN, EF-1 WITH EXISTING GYM UNIT. THE TEMPERATURE CONTROL CONTRACTOR SHALL VERIFY OPERATION OF EXISTING AIR HANDLING UNIT AND PROVIDE A CONTROLLER, RELAYS, WIRING, POWER, ETC. AS NECESSARY TO PROVIDE SEQUENCE OF OPERATION AS STATED. IT IS THE INTENT TO HAVE THE EXISTING GYM UNITS OPERATE AS ORIGINALLY INTENDED, BUT ADD CONTROLS TO ACTIVATE A GYM UNIT TO PROVIDE MAKE-UP AIR FOR KITCHEN HOOD. THE SEQUENCE OF OPERATIONS SHALL BE AS FOLLOWS WHEN THE EXHAUST FAN SWITCH FOR EF-1 IS TURNED "ON", (1) EXISTING GYM UNIT SHALL BE ACTIVATED. THE EXISTING HEATING HOT WATER CONTROL VALVE SHALL MODULATE TO MAINTAIN SPACE SETPOINT. IT IS NOT THE INTENT TO MODIFY THE EXISTING SEQUENCE OF OPERATIONS, ONLY TO ALLOW (1) EXISTING UNIT TO OPERATE WHEN KITCHEN EXHAUST FAN IS OPERATED. ALSO TIE FIRE SUPPRESSION PANEL TO MAU FOR AUTOMATIC SHUT DOWN.
- 22 PROVIDE A PRE-DEMOLITION AIR TESTING REPORT ON BOTH EXISTING GYM UNITS. TEST AND BALANCE CONTRACTOR SHALL VERIFY TOTAL SUPPLY AIRFLOW, OUTDOOR AIRFLOW, RETURN AIRFLOW, TOTAL STATIC PRESSURE, EXTERNAL STATIC PRESSURE, SHEAVE MAKE/SIZE/BORE, NUMBER OF BELTS MAKE/SIZE, MOTOR HP, FAN RPM, SUPPLY FAN MOTOR MANUFACTURER/TYPE, AMPERAGE, VOLTAGE, ACTUAL MOTOR AMPERAGE AND VOLTAGE, AIR HANDLER UNIT MAKE, MODEL AND SERIAL NUMBER OF BOTH EXISTING UNITS. SEND ALL INFORMATION TO ENGINEER FOR REVIEW BEFORE COMMENCING ANY CONTROL WORK.

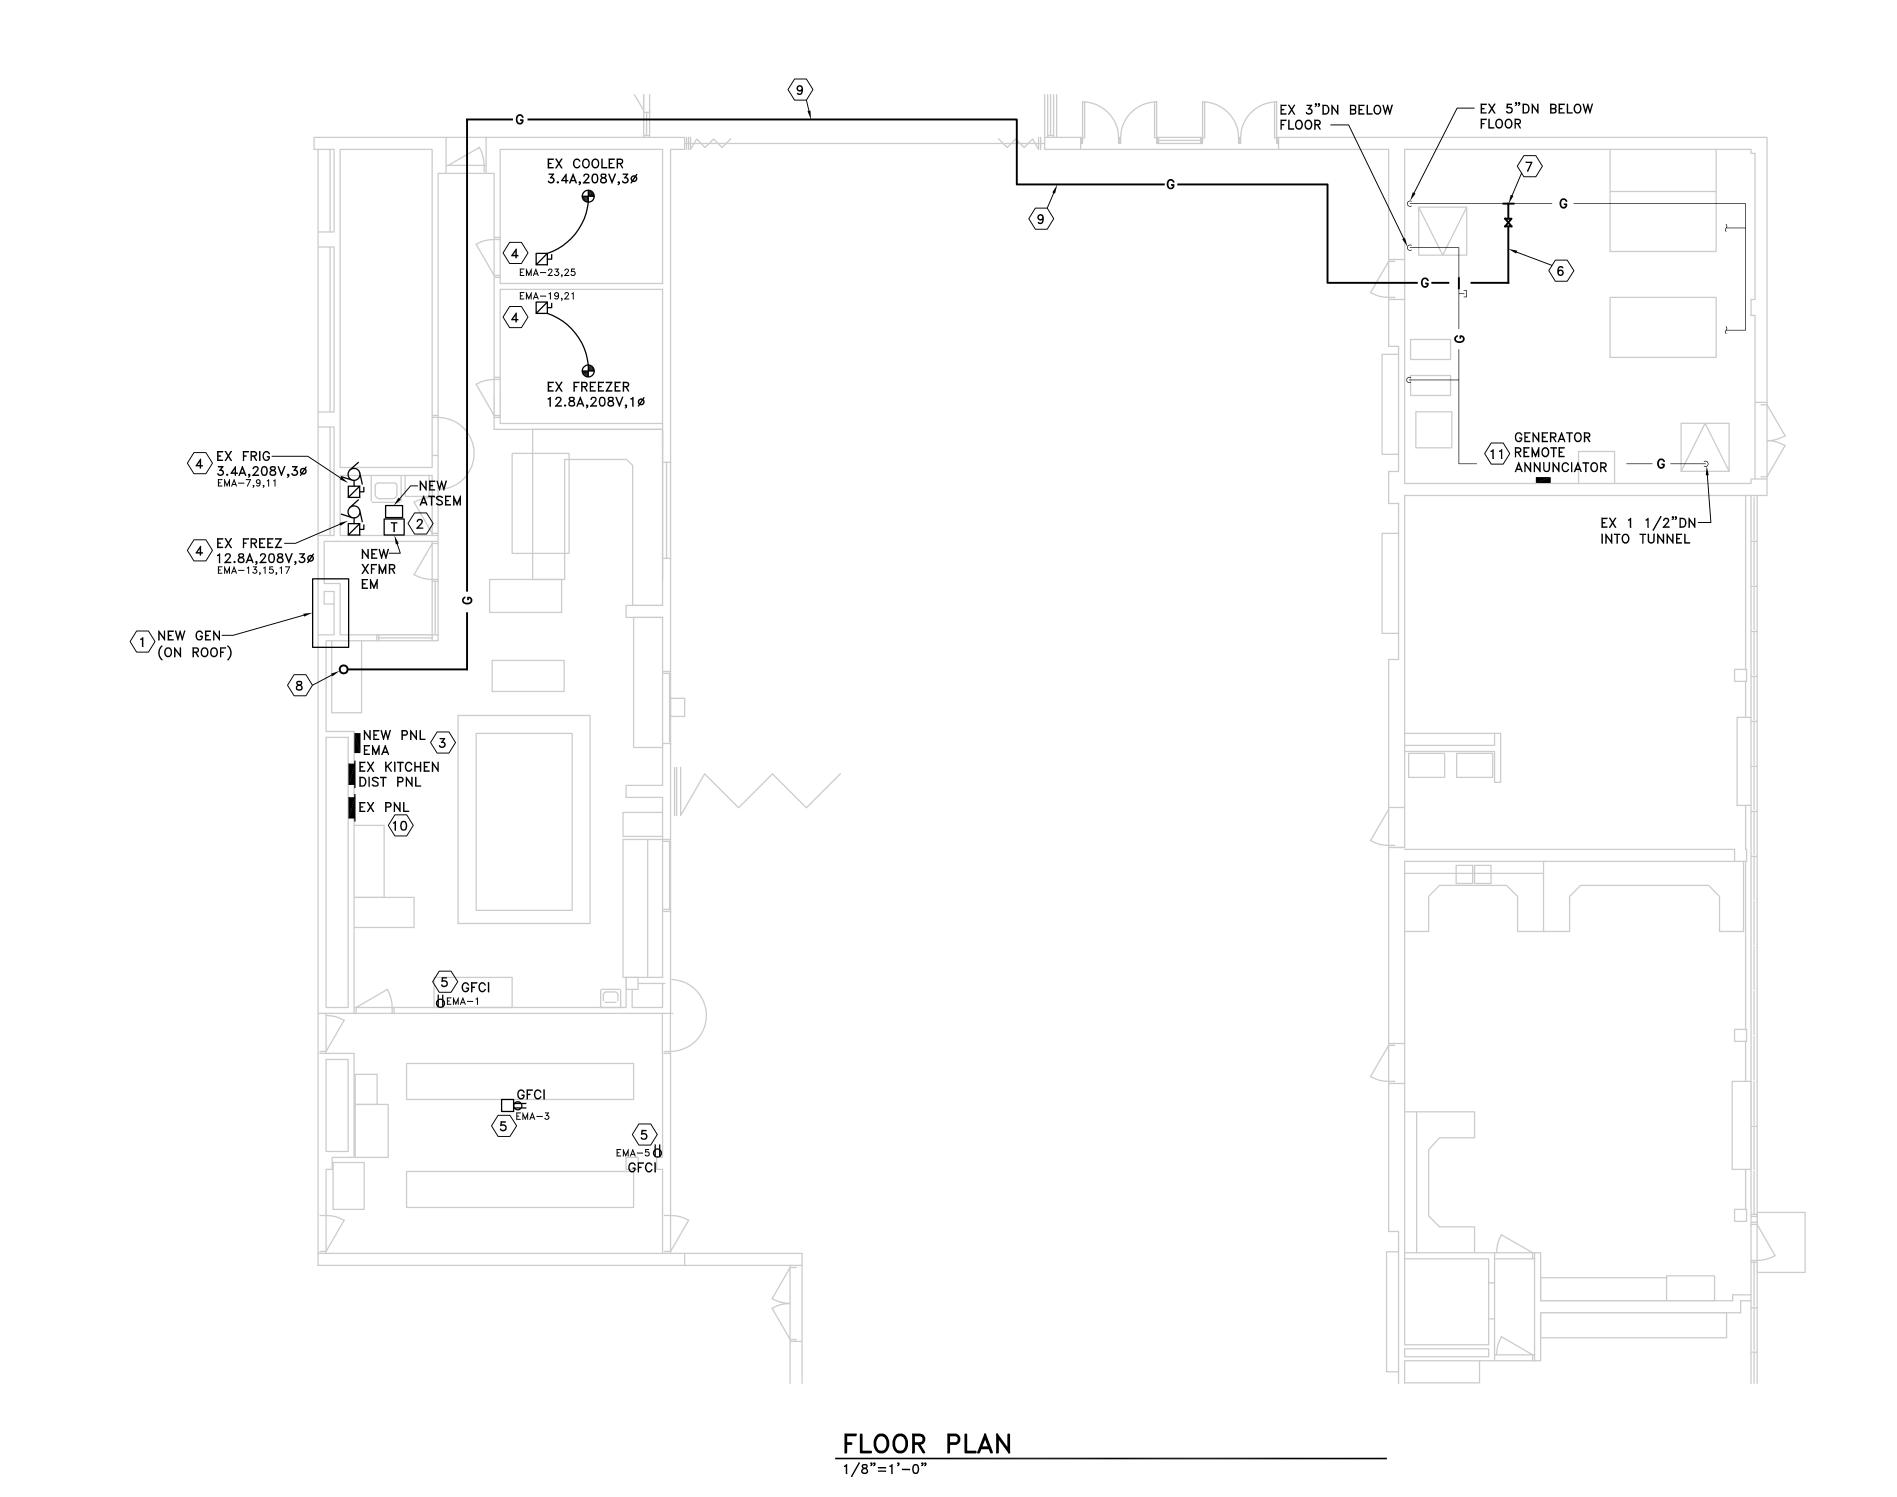
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ınder the laws of the State of Douglas F. Reckinger

Registration Number 31668

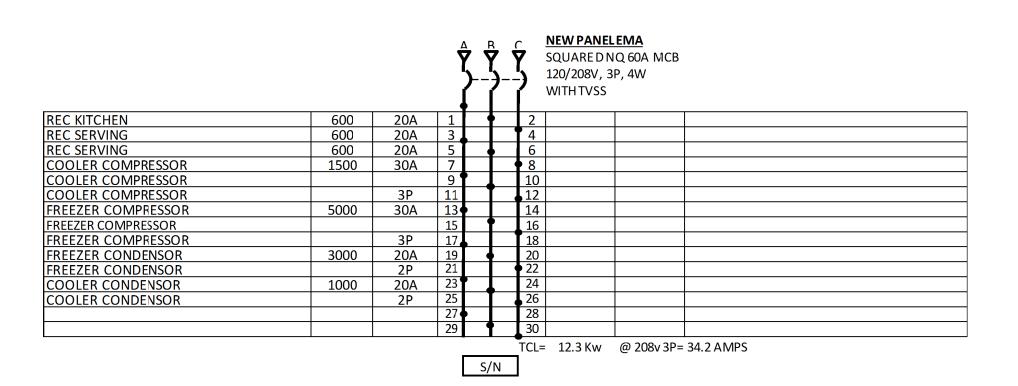
Date: SEPTEMBER 21, 2015 Drawn: DCT Check: EAB

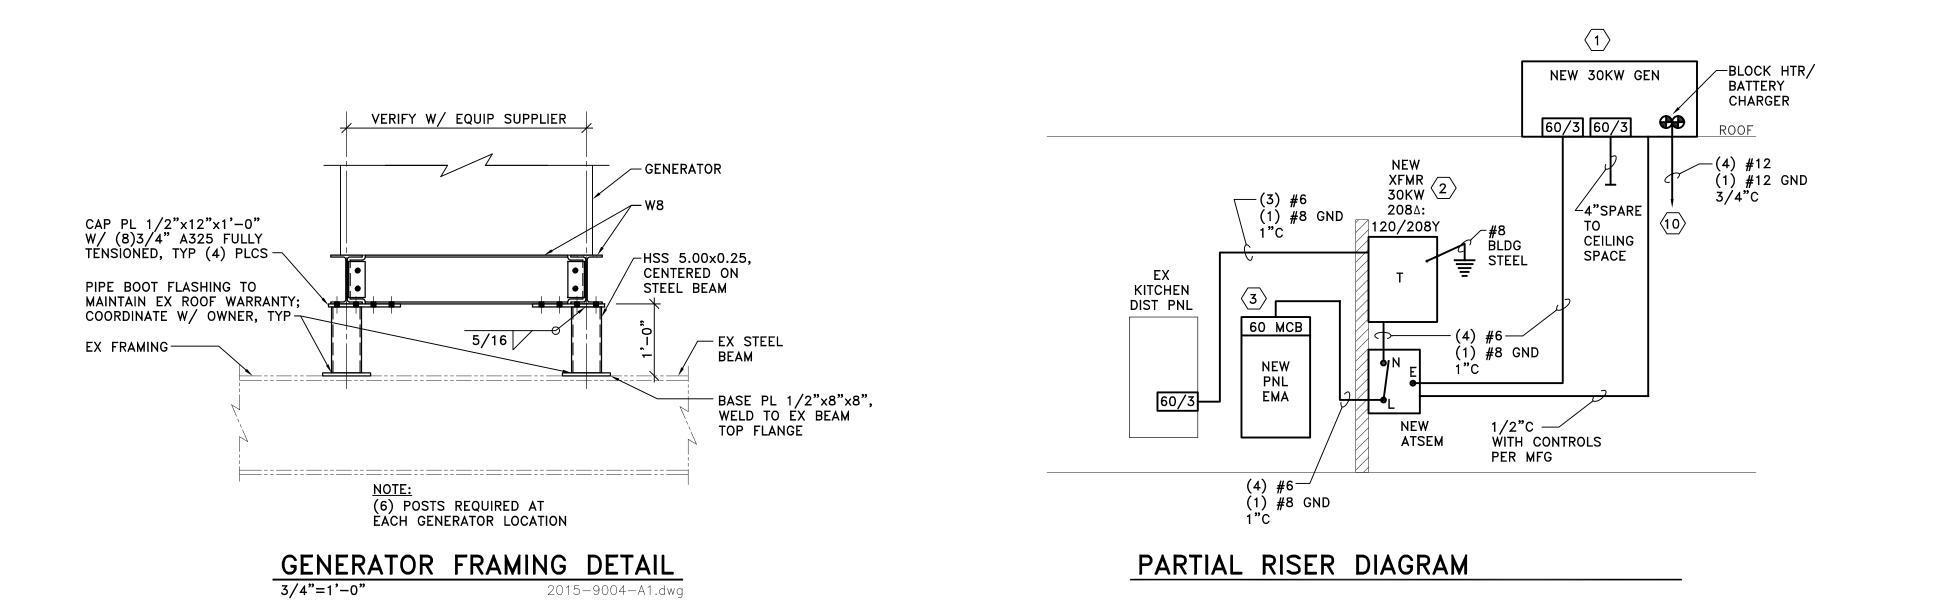
MACGOWAN **ELEMENTARY SCHOOL GENERATOR PLAN DETAILS AND SCHEDULES**



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KEYED NOTES

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- 1 FURNISH AND INSTALL NEW EMERGENCY GENERATOR ON THE ROOF. REFER TO STRUCTURAL DETAILS.
- 2 FURNISH AND INSTALL NEW WALL MOUNT TRANSFORMER WITH NEW ATS-EM BELOW. SQUARE D #EE30T211H-WMB361362
- 3 FURNISH AND INSTALL NEW PANEL EMA SURFACE MOUNTED ADJACENT TO EXISTING KITCHENS DIST. PANEL.
- 4 INTERCEPT EXISTING CIRCUIT AND REFEED FROM NEW PANEL.
- 5 INTERCEPT EXISTING RECEPTACLE CIRCUIT AND REFEED FROM NEW PANEL. REPLACE EXISTING RECEPTACLES WITH A NEW RED RECEPTACLE. PROVIDE NEW STAINLESS STEEL COVER PLATE.
- ROUTE 1 1/2" SCHEDULE 40 STEEL PIPING FROM EXISTING
 NATURAL GAS PIPING LOCATED IN MECHANICAL ROOM TO NEW
 EMERGENCY GENERATOR. SUPPORT PIPING HIGH IN MECHANICAL
 ROOM ABOVE DOORS FROM WALL OR ROOF JOIST. PIPING SHALL BE
 SUPPORTED A MAXIMUM OF EVERY 10 FEET HORIZONTALLY.
- CONNECT NEW 1 1/2" PIPING INTO EXISTING 5". UTILIZE A 1 1/2" SHUT OFF VALVE AT CONNECTION TO EXISTING NATURAL GAS PIPING. PROVIDE A NATURAL GAS REGULATOR AS REQUIRED FOR GENERATOR. THE MINIMUM NATURAL GAS PRESSURE OF THE GENERATOR IS 6" W.C. AND THE MAXIMUM PRESSURE IS 14" W.C. ROUTE REGULATOR VENTS TO THE OUTDOORS.
- 8 ROUTE 1 1/2" NATURAL GAS PIPING UP THROUGH ROOF TO NEW EMERGENCY GENERATOR. REDUCE GAS PIPE SIZE AT GENERATOR AS REQUIRED. FIELD INSTALL Y-STRAINER AT GENERATOR AND INSTALL GAS PIPING PER MANUFACTURER'S RECOMMENDATIONS. FIELD VERIFY EXACT GAS CONNECTION LOCATION AT GENERATOR. INSTALL 1 1/2" NATURAL GAS SHUT OFF VALVE AT GENERATOR. PRIME AND PAINT ALL SCHEDULE 40 STEEL PIPING LOCATED OUTDOORS WITH RUST INHIBITOR PAINT, INCLUDING ZINC. COLOR OF PAINT TO BE SELECTED BY ARCHITECT.
- 9 ROUTE ALL NATURAL GAS PIPING ABOVE CEILING. FIELD VERIFY EXACT ROUTE. REMOVE AND REPLACE CEILING TILE OR T-BAR GRID AS NECESSARY. THE CONTRACTOR SHALL BE RESPONSIBLE FOR FURNISHING AND REPLACING ANY DAMAGED CEILING TILE.
- THE GENERATOR FROM PANEL A FOR THE BLOCK HEATER AND BATTERY CHARGER.
- 11 FURNISH AND INSTALL GENERATOR REMOTE ANNUNCIATOR.

EXISTING KITCHEN DIST. PANEL

SQUARE D QMB SAFEFLEX, 208V, 3ø

1 30A/3P EX LOAD

2 30A/3P EX LOAD

3 30A/3P EX LOAD

4 30A/3P EX LOAD

5 30A/3P EX LOAD

6 60A/3P EX LOAD

1 7 30A/3P EX COOLER

1 8 30A/3P EX FREEZER

10 304/3P FY LOAD

10 30A/3P EX LOAD

11 30A/3P EX LOAD

12 60A/3P EX LOAD

REVISED KITCHEN DIST. PANEL

SQUARE D QMB SAFEFLEX, 208V, 3ø

1 30A/3P EX LOAD

2 30A/3P EX LOAD

3 30A/3P EX LOAD

4 30A/3P EX LOAD

5 30A/3P EX LOAD

6 60A/3P EX LOAD

2 7 60A/3P ATS-EM

─ 8 30A/3P SPARE

9 30A/3P EX LOAD

10 30A/3P EX LOAD

11 30A/3P EX LOAD

12 30A/3P EX LOAD

PANEL KEYED NOTES

1 DISCONNECT AND REMOVE EXISTING LOAD.

2 FURNISH AND INSTALL A NEW FUSIBLE SWITCH TO FEED NEW

GENERATOR SCHEDULE

NATURAL GAS CUMMINS POWER GENERATOR. 30KW, 120/208 VOLT, 3 PHASE, 60 Hz. ALUMINUM, POWDER COATED SANDSTONE ENCLOSURE. (2) 60A/3P OUTPUT CIRCUIT BREAKERS. COOLANT HEATER, BATTERY CHARGER. REMOTE MONITORING DEVICE. CRITICAL SILENCE MUFFLER. CUMMINS #C30-N6

AUTOMATIC TRANSFER SWITCH SCHEDULE

104 AMP, 120/208 VOLT, 3 PHASE WITH SOLID NEUTRAL. NEMA 1 ENCLOSURE.
ASCO #300-3-104-C-1-C-120/208V3ø4W-60Hz

GENERAL MECHANICAL NOTE:

COORDINATE NATURAL GAS SHUT DOWN A MINIMUM OF TWO WEEKS IN ADVANCE WITH OWNER. ASSUME PREMIUM TIME FOR NATURAL GAS SHUT DOWN TO TIE IN FOR NEW NATURAL GAS GENERATOR.

Redford Union Schools Kitchen Improvements and Generators

Redford Union High School
17711 Kinloch Street Redford, MI 48240
Hilbert Middle School
26440 Puritan Avenue Redford, MI 48239
MacGowan Elementary School
18255 Kinloch Street Redford, MI 48240
Beech Elementary School

REDFORD UNION SCHOOLS
17715 Brady Street

Redford, MI 48240

19990 Beech Daly Road Redford, MI 48240



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under the laws of the State of Michigan

Douglas F. Reckinger

Registration Number 31668 Date 07/30/85

Revisions

Description Date N

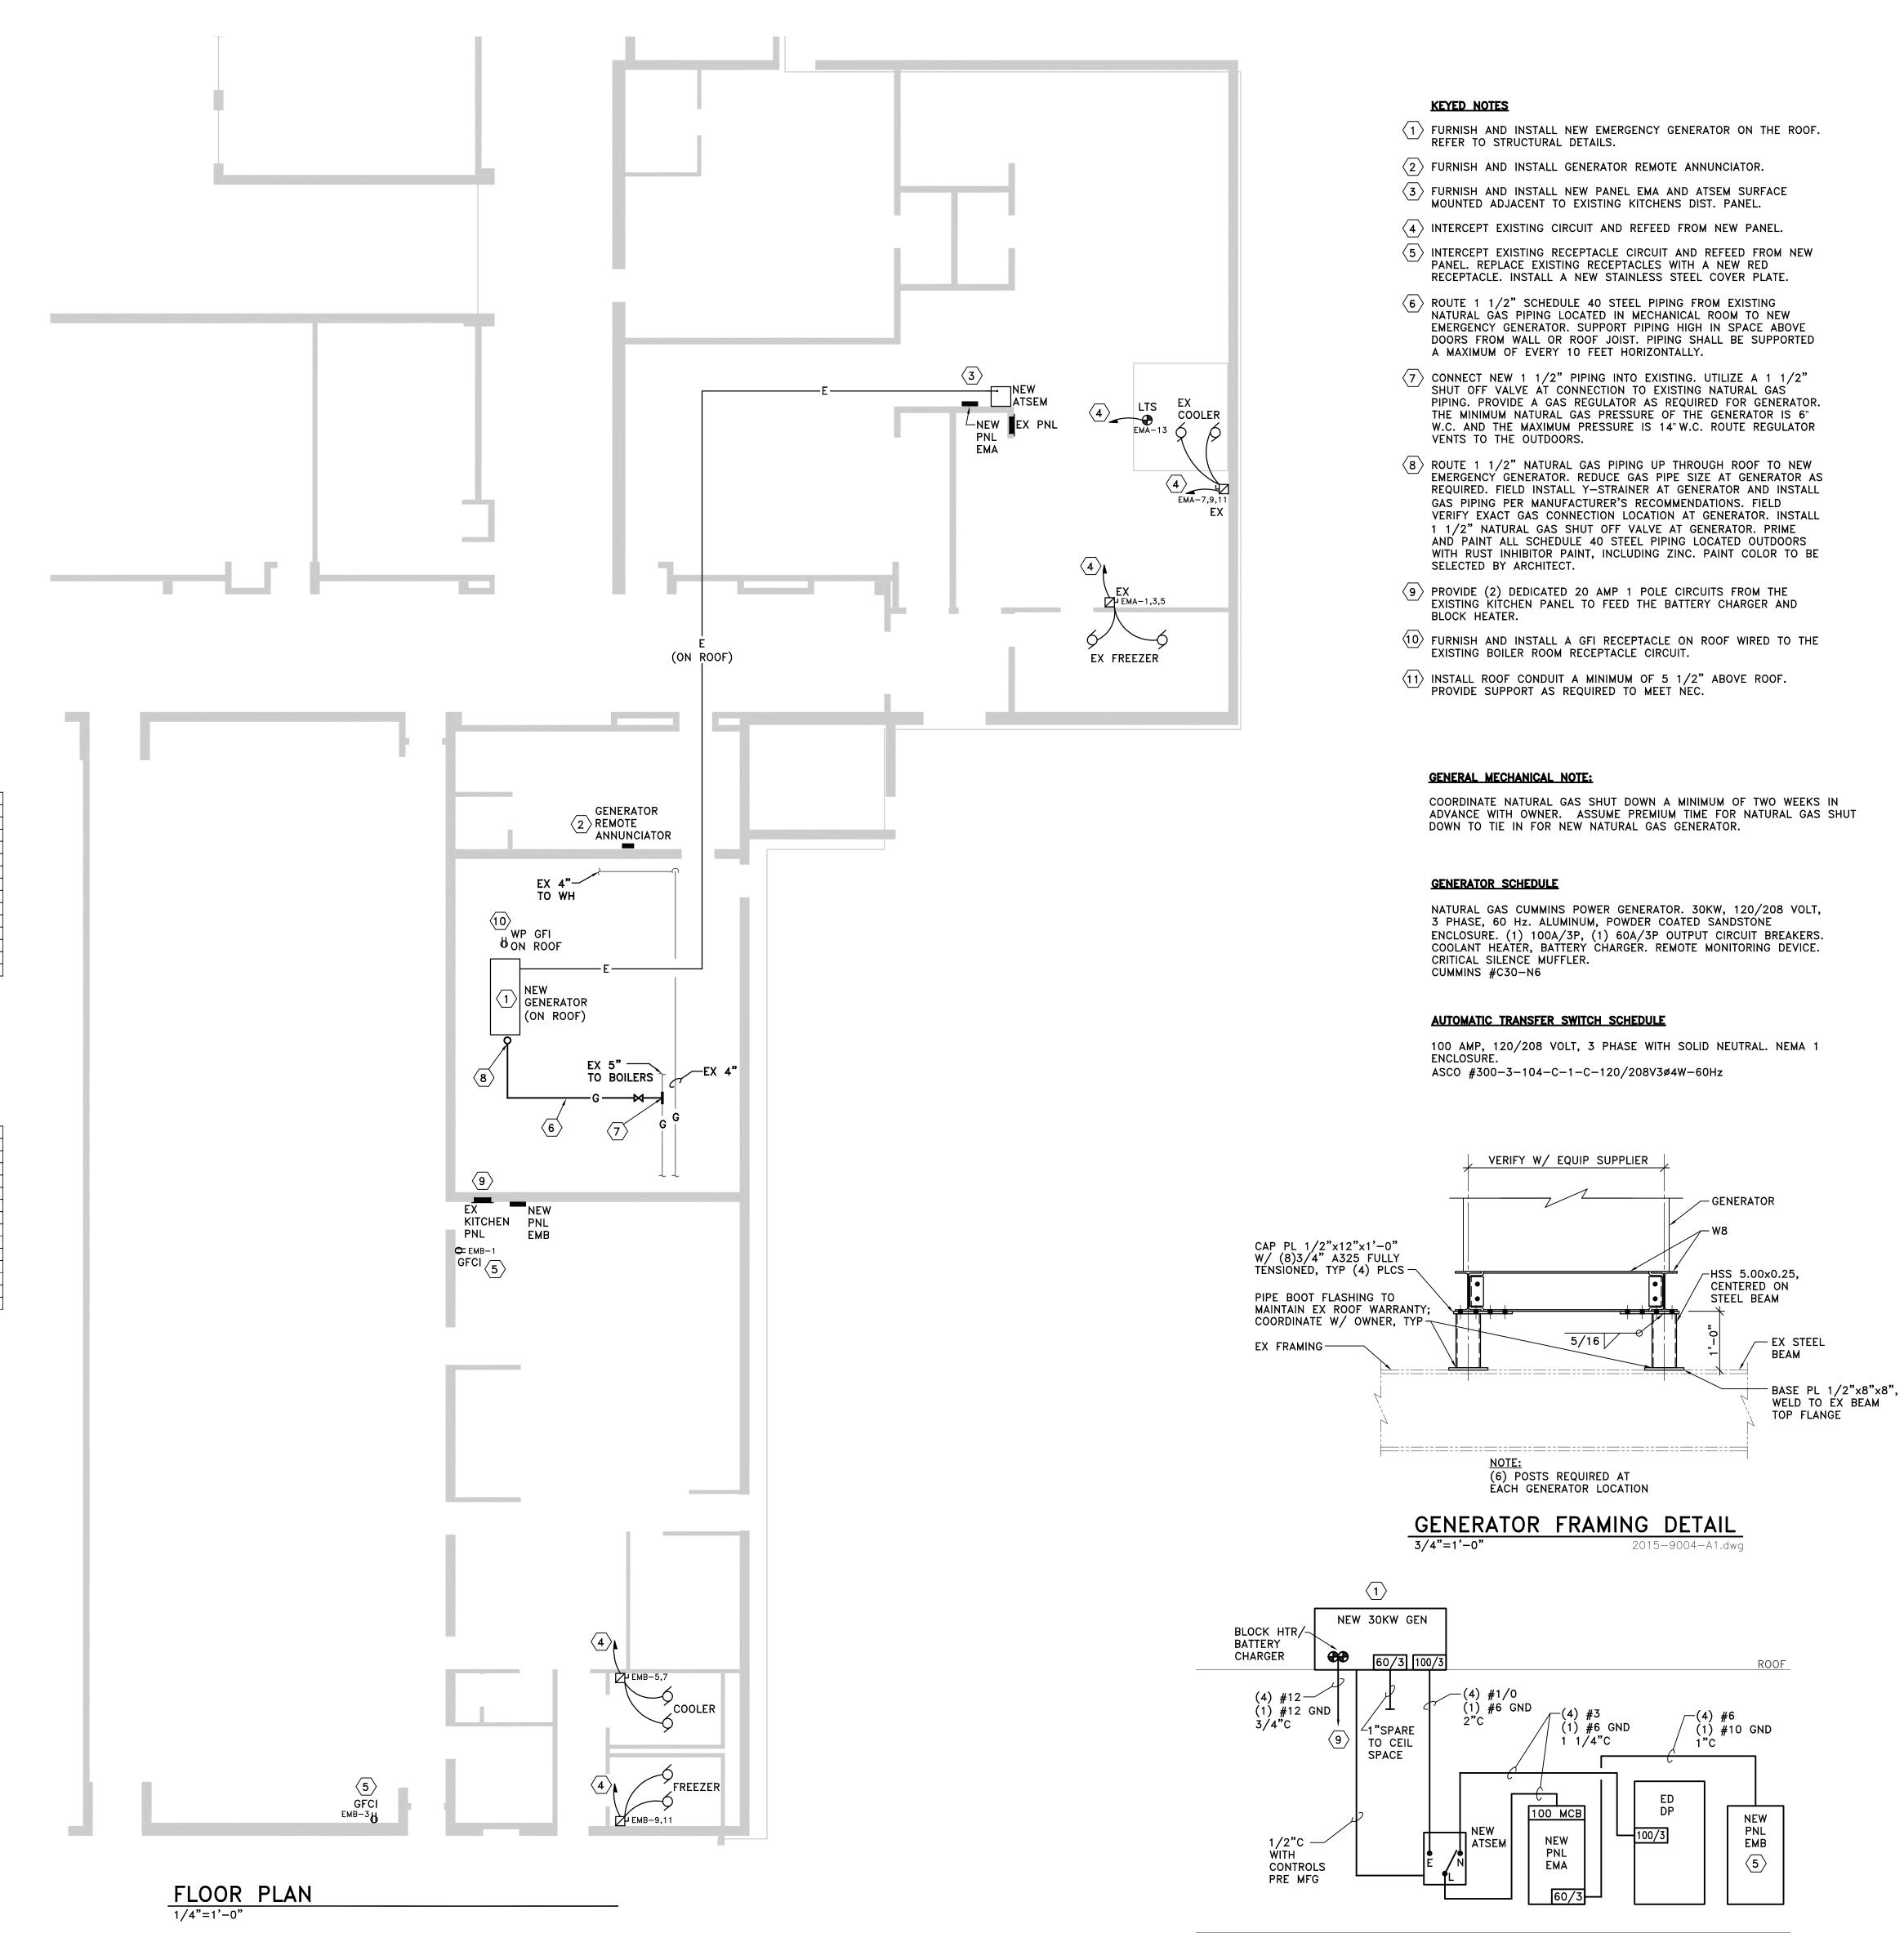
Comm: 154007
Date: SEPTEMBER 21, 2015
Drawn: DCT

HIGH SCHOOL
GENERATOR PLAN
DETAILS AND

Scale: As indicated

SCHEDULES

ME1.03



SQUAREDNQ, 100A MCB

2 60A 8400 EMB

TCL= 17.6 Kw @ 208v 3P= 49 AMPS

TCL= 8.4 Kw @ 208v 3P= 23.4 AMPS

A B C <u>NEW PANEL EMB</u>

SQUARE DNQ, 100A MLO 120/208V, 3P, 4W WITHTVSS

120/208V, 3P, 4W

WITHTVSS

WALK IN COOLER

WALK IN COOLER

PARTIAL RISER DIAGRAM

Redford Union Schools Kitchen Improvements and Generators

Redford Union High School 17711 Kinloch Street Redford, MI 48240 Hilbert Middle School

17711 Kinloch Street Redford, MI 48240
Hilbert Middle School
26440 Puritan Avenue Redford, MI 48239
MacGowan Elementary School
18255 Kinloch Street Redford, MI 48240
Beech Elementary School
19990 Beech Daly Road Redford, MI 48240

REDFORD UNION SCHOOLS
17715 Brady Street

Redford, MI 48240



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Douglas F. Reckinger

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Revisions

Description

Date

Comm: 154007

Date: SEPTEMBER 21, 2015

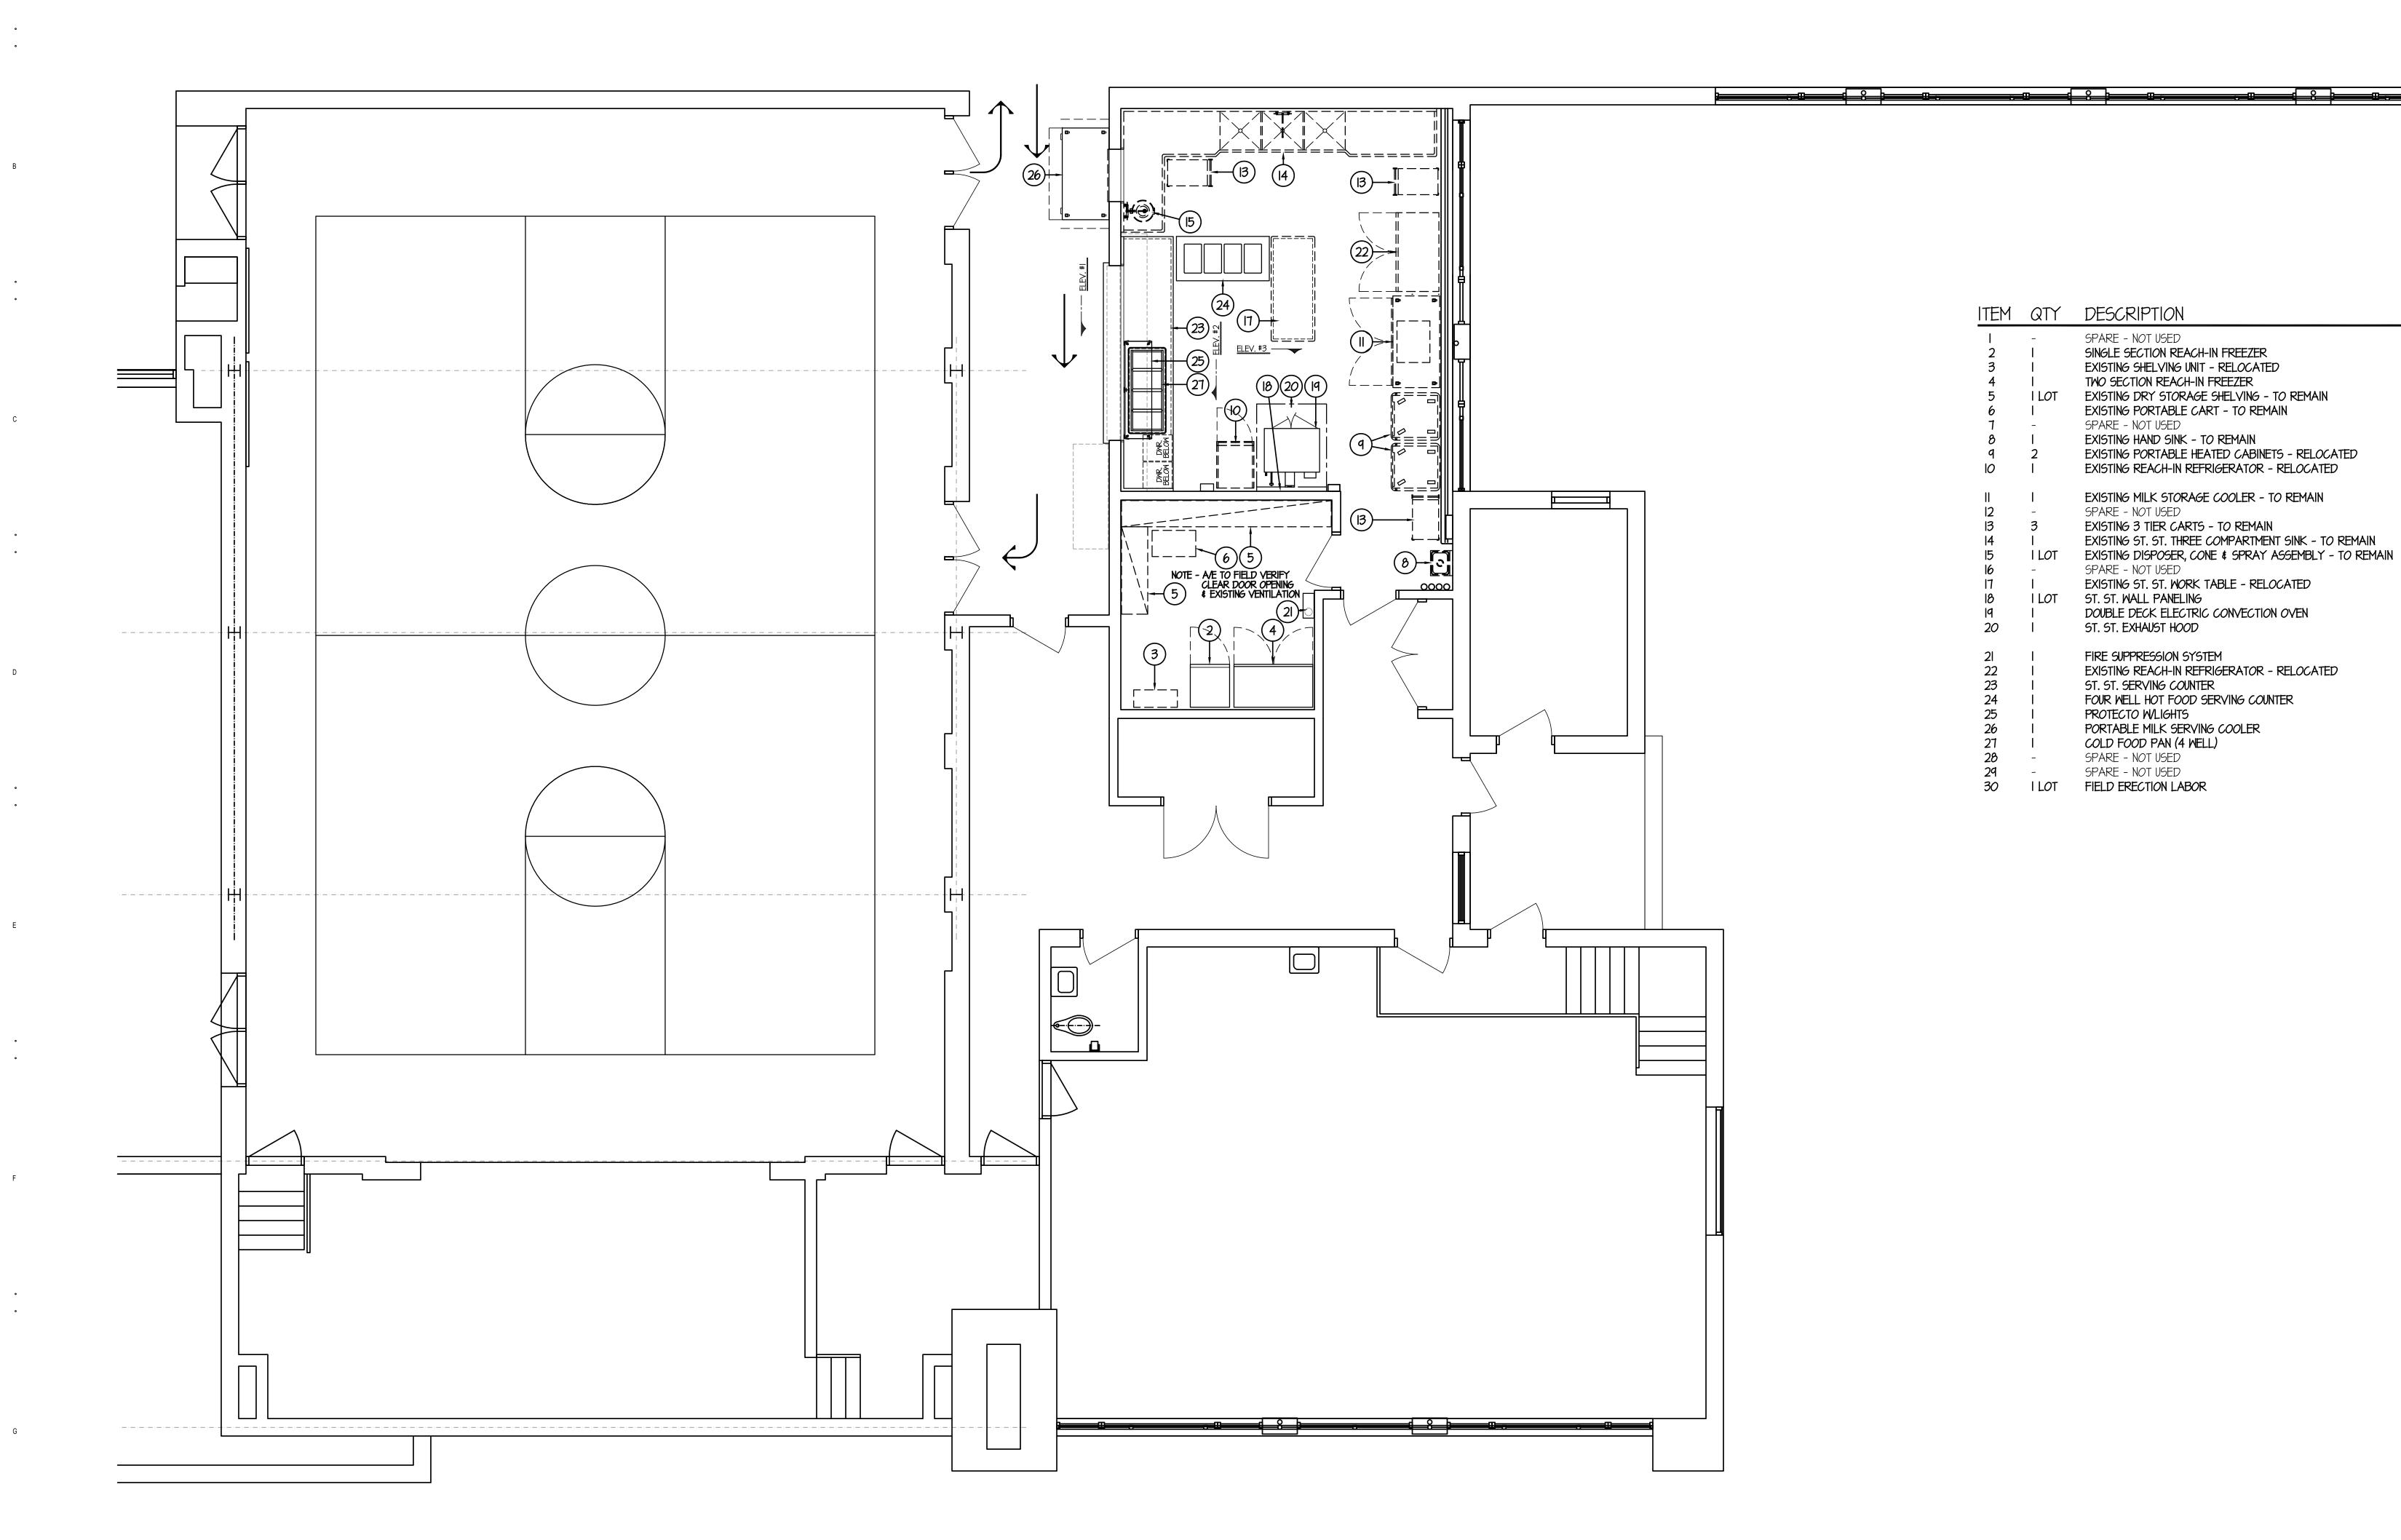
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Check: EAB

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SCHOOL GENERATOR
PLAN DETAILS AND
SCHEDULES

Scale: As indicat

ME1.04

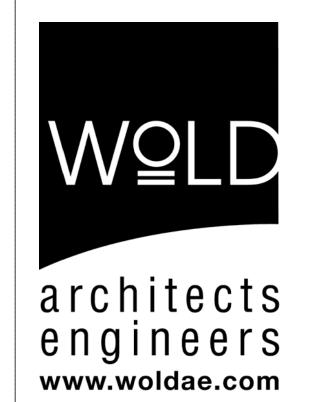


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MacGowan Elementary School Kitchen Improvements 18255 Kinloch Redford, MI 48240

Redford Union School District

17715 Brady St. Redford, Ml 48240



333 West Seventh Street tel 248 284 0611 Three Hundred Twenty
Royal Oak, MI 48067

Royal Oak, MI 48067

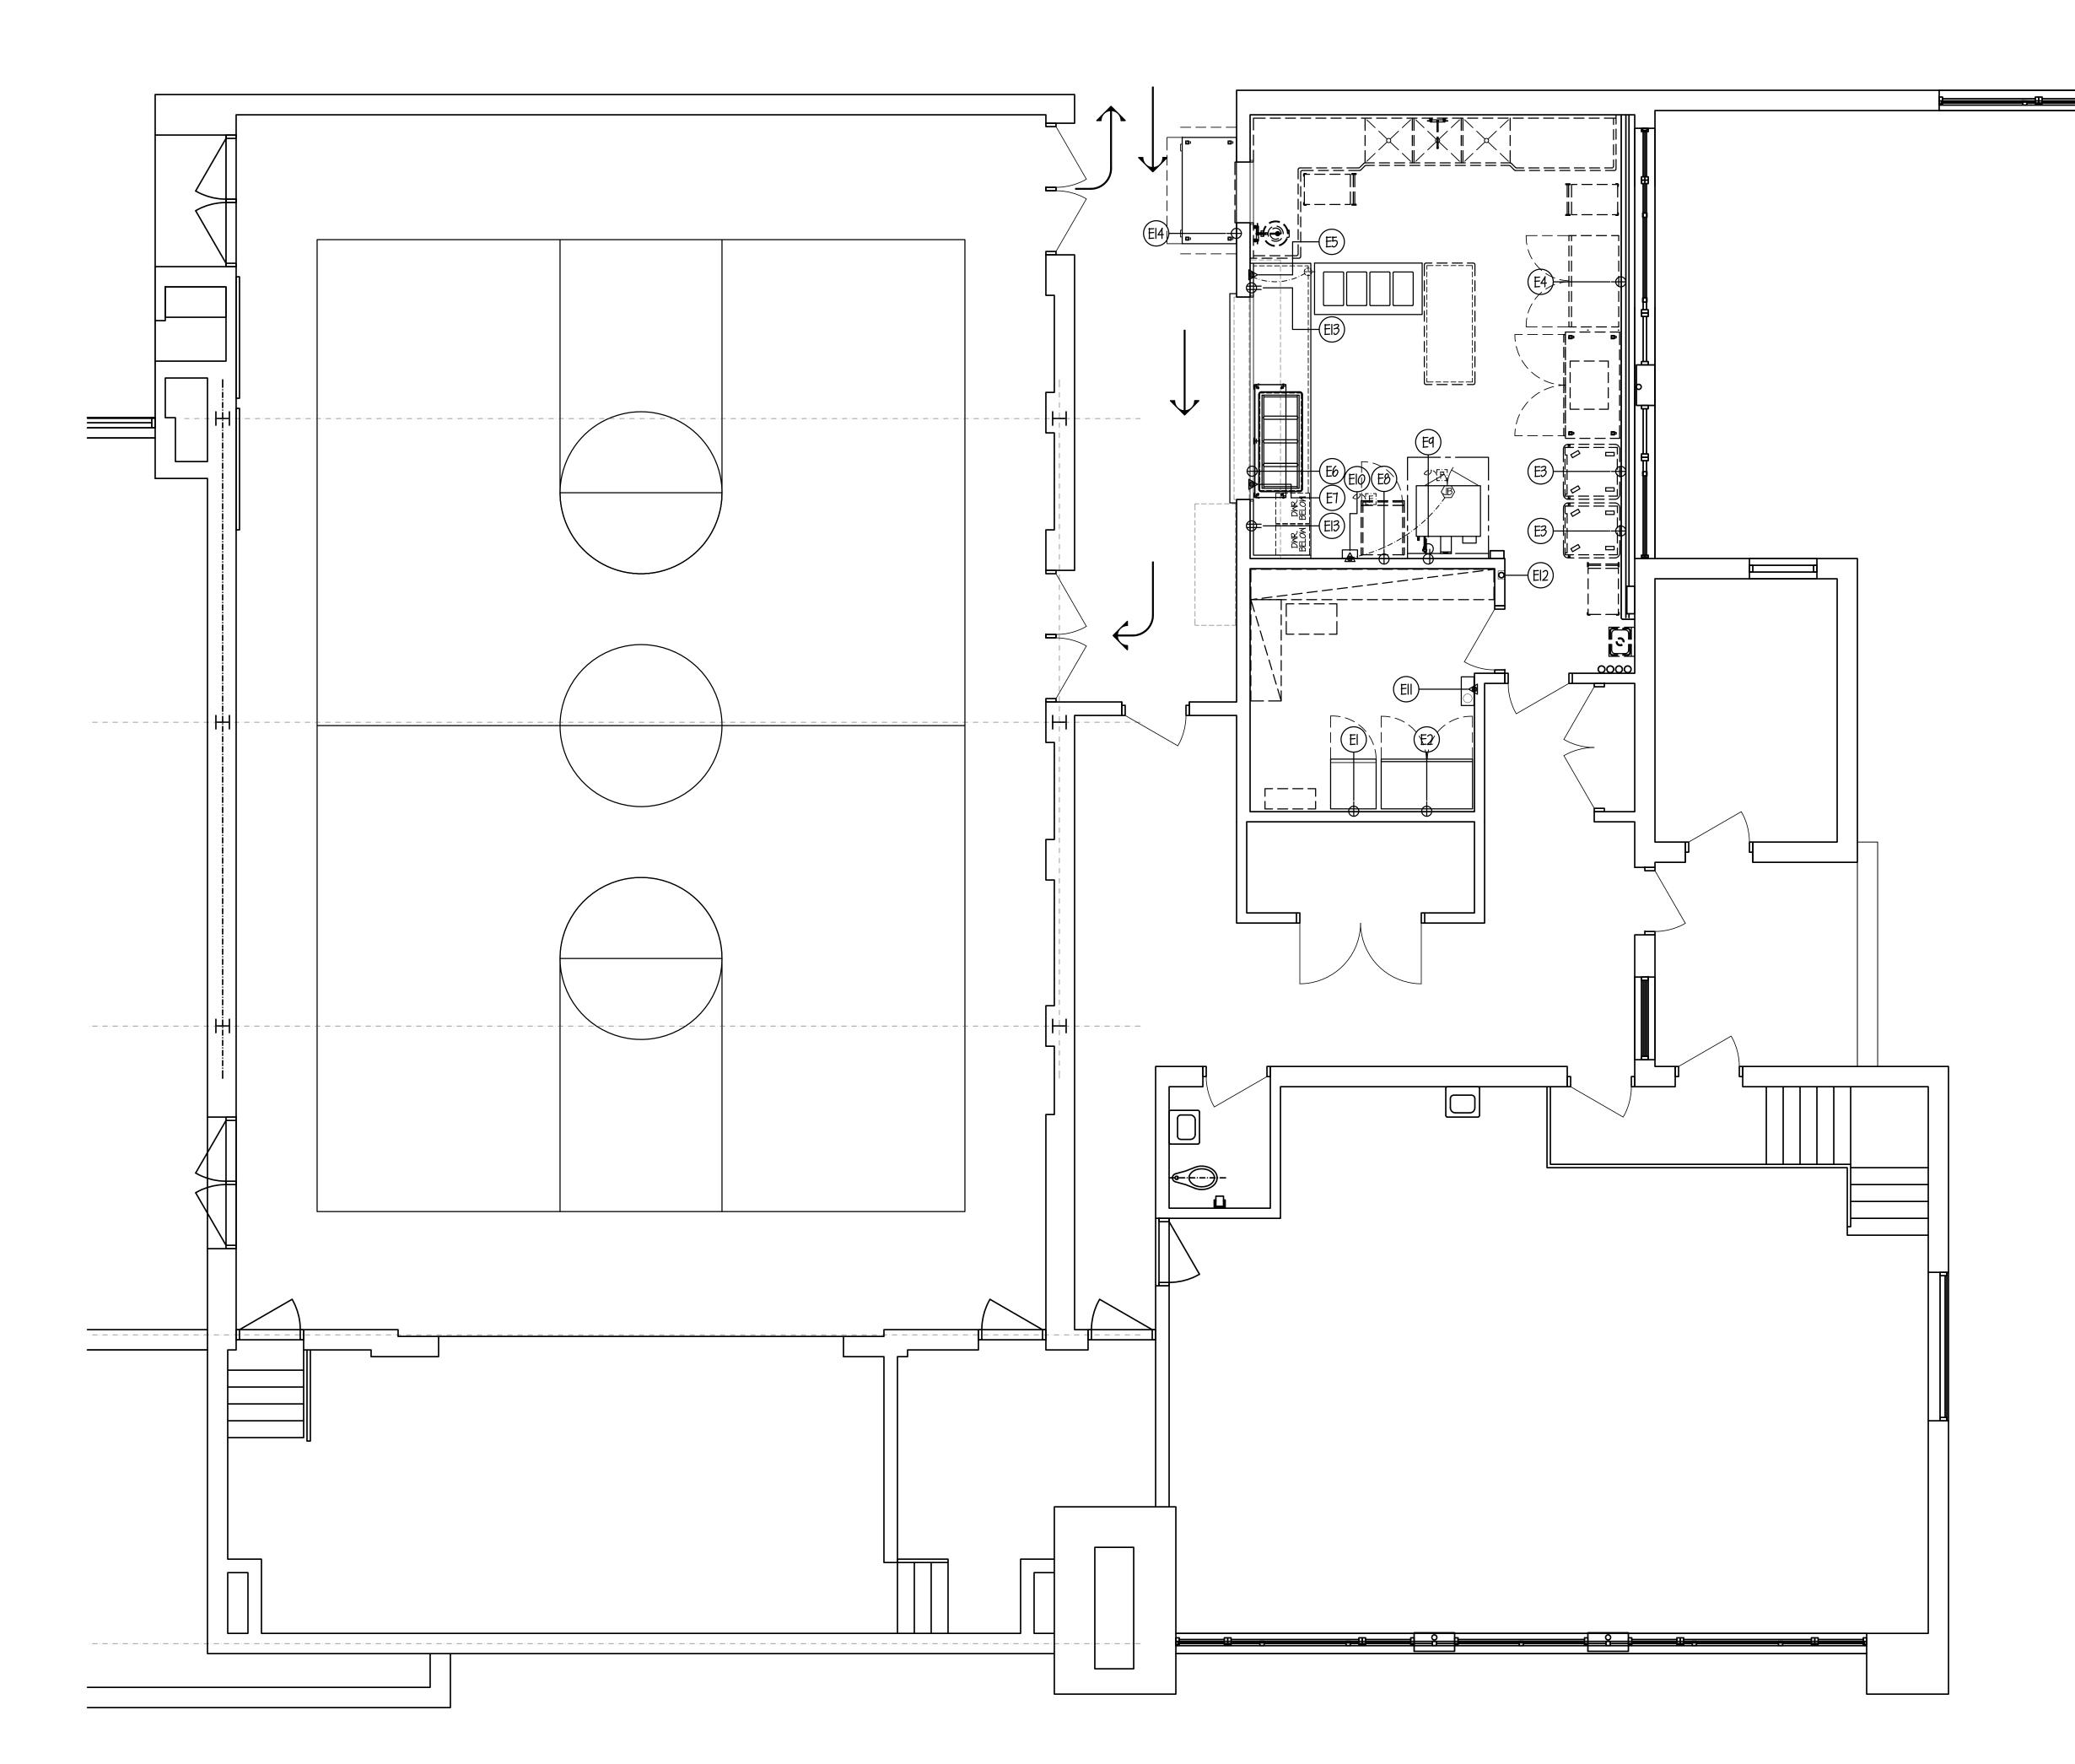
Royal Oak, MI 48067

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FOOD SERVICE **EQUIPMENT**

LAYOUT AND SCHEDULE





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ELECTRICAL NOTES

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- 7.2 AMP (LOAD) 120V-1 ph. SINGLE RECEPTACLE FLUSH IN WALL 7'-3" A.F.F. FOR SINGLE SECTION FREEZER.

- 7.8 AMP (LOAD) 120V-1 ph. SINGLE RECEPTACLE FLUSH IN WALL 18" A.F.F. FOR COLD FOOD PAN.

- EIO 20 AMP (CIRCUIT) 120V-1ph. COND. CONN. OUT OF WALL FOR HOOD SYSTEM, LIGHTS & TEMPERATURE LIGHT & FAN CONTROL SWITCHES & BOX FURN. BY F.S.E.C. & INST'D BY ELECT. TRADES.
- (EII) 6.0 AMP (LOAD) 120V-1 ph. COND. CONN. OUT OF WALL 84" A.F.F. FOR FIRE SUPPRESSION SYSTEM.

TO BE SHOWN BY ELECT. ENGINEER.

72" OF A SINK MUST BE GFCI PROTECTED BY ELECT. TRADES.

GENERAL NOTE for ROUGH-IN PLAN

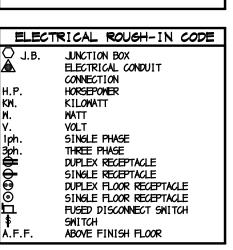
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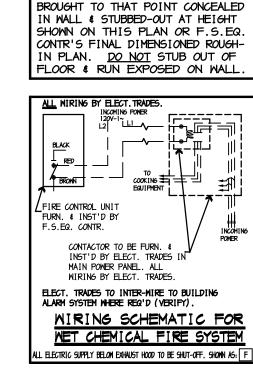
ALL SERVICES SHOWN WITH SYMBOLS

CENTERED ON WALL SHOULD BE



JOBSITE AT TIME OF FINAL CONN'S FOOD SERVICE EQUIP. CONTR. SHALL CONTACT ELECTRICAL ENGINEER BEFORE DRAWING ROUGH-PLAN TO VERIFY EXACT VOLTAGES AVAILABLE ON JOBSITE. THIS CHECK MUST BE MADE TO INSURE PROPER VOLTAGES TO ALL EQUIPMENT.





1/2" DIA. EMPTY CONDUIT BY ELECT. TRADES TO EXTEND UP THRU WALL & CUT ABOVE FIN. CEILING.

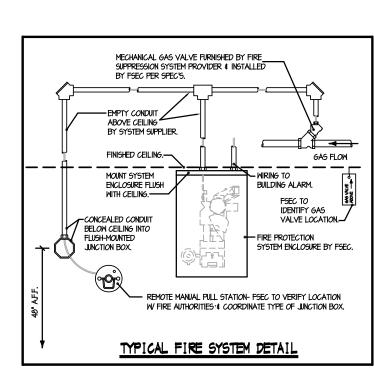
4" OCTAGONAL BOX W SCREMS IN 2 & 8 O'CLOCK POSITION- FURN. & INST'D BY ELECT. TRADES.

REMOTE FIRE PULL STATION, CABLES, ETC. ALL FURN. & INST'D BY F.S.EQ. CONTR.

VERIFY EXACT TYPE OF BOX W/ INSTALLER.

REMOTE FIRE PULL STATION

for WET CHEMICAL FIRE SYSTE



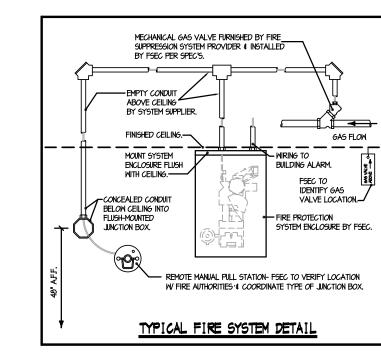


- (E2) II.O AMP (LOAD) 120V-1 ph. SINGLE RECEPTACLE FLUSH IN WALL 7'-3" A.F.F. FOR TWO SECTION FREEZER.
- 20 AMP (CIRCUIT) 120V-1 ph. SINGLE RECEPTACLE FLUSH IN WALL 18" A.F.F. FOR EXISTING HOT CARTS. FIELD VERIFY EXISTING EQUIPMENT FOR EXACT REQUIREMENTS.
- [E4] 10.0 AMP (LOAD) 120V-1 ph. SINGLE RECEPTACLE FLUSH IN WALL 18" A.F.F. FOR EXISTING REFRIGERATOR. FIELD VERIFY EXISTING EQUIPMENT FOR EXACT REQUIREMENTS.
- 19.2 AMP (LOAD) 208V-I ph. COND. CONN. OUT OF WALL, ELEC. TRADES TO CONNECT TO SINGLE RECEPTACLE PRE-WIRED IN COUNTER FOR HOT FOOD TABLE.
-) I.O AMP (LOAD) I20V-I ph. COND. CONN. OUT OF WALL 18" A.F.F. FOR PROTECTO W/LIGHTS.
- (E8) 10.0 AMP (LOAD) 120V-I ph. SINGLE RECEPTACLE FLUSH IN WALL 18" A.F.F. FOR EXISTING REFRIGERATOR. FIELD VERIFY EXISTING EQUIPMENT FOR EXACT REQUIREMENTS.
- E9 TWO (2) 34.0 AMP (LOAD) 208V-I ph. SINGLE RECEPTACLES FLUSH IN WALL 36" A.F.F. FOR DOUBLE DECK CONVECTION OVEN.
- SENSOR. HOOD LIGHTS PRE-WIRED BY F.S.E.C. TO J.B. ON TOP W/ FINAL CONN. BY ELECT. TRADES. ELECT. TRADES TO PROVIDE POWER & INTER-WIRING TO EXHAUST FANS/MAKE-UP AIR UNITS.
- SEE DETAIL THIS SHEET.
- (EI2) 4" J-BOX FURN. & INST'D. BY ELEC. TRADES, FLUSH IN WALL 48" A.F.F. FOR FIRE SYSTEM REMOTE PULL STATION BY F.S.E.C. SEE DETAIL THIS SHEET.
- EI3) 20 AMP (CIRCUIT) 120V-1 ph. DUPLEX RECEPTACLE FLUSH IN WALL 50" A.F.F. FOR GENERAL USE. FIELD VERIFY EXISTING OUTLET LOCATIONS, RE-USE WHERE POSSIBLE
- (EI4) 4.8 AMP (LOAD) 120V-1 ph. SINGLE RECEPTACLE FLUSH IN WALL 18" A.F.F. FOR MILK COOLER.

ALL ADDITIONAL RECEPTACLES, CONN.'s, WIRING, ETC.

ALL 120V DUPLEX RECEPTACLES WITHIN KITCHEN AREAS & WITHIN

ELECT. TRADES TO FURN. & INSTALL ALL LINE DISCONNECT SWITCHES AS REQUIRED TO MEET STATE & LOCAL CODE.





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Redford Union School District

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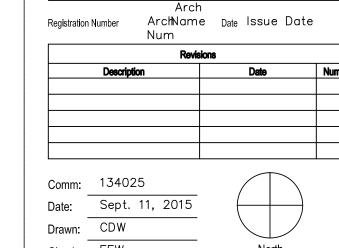
School Kitchen

Improvements

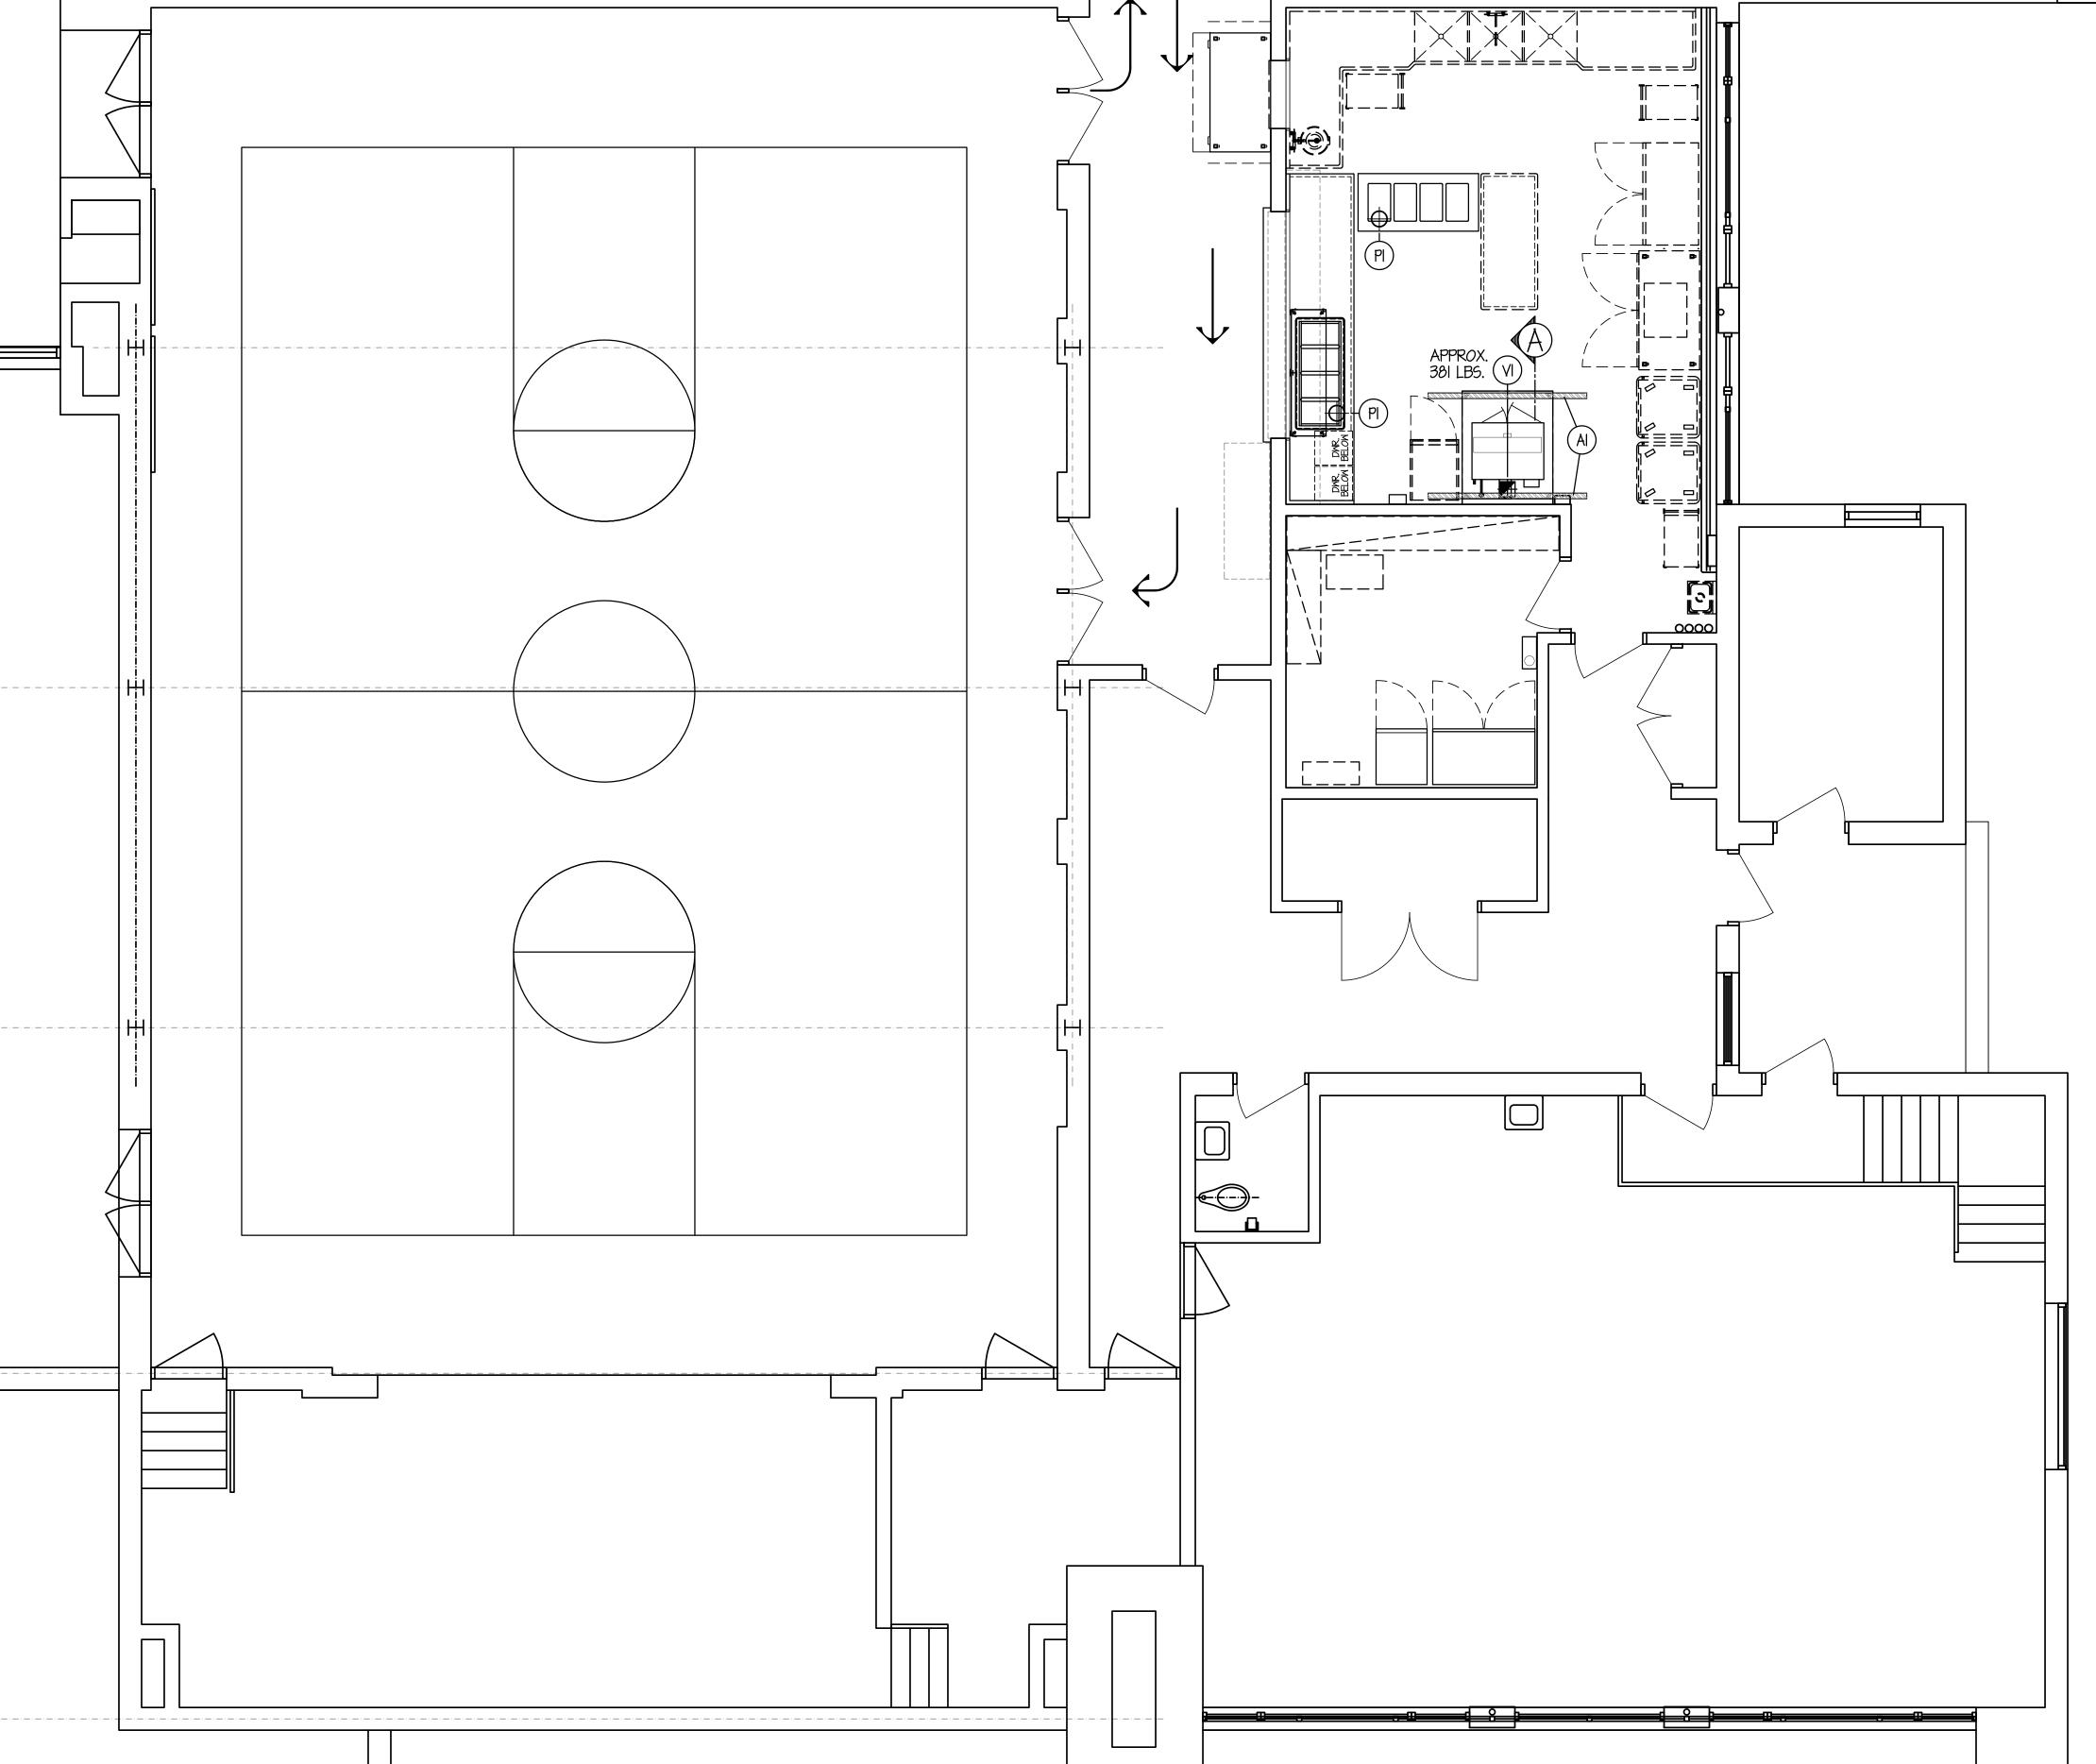
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ELECTRICAL **ROUGH-IN** PLAN FOR FOOD SERVICE



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PLUMBING NOTES

(PI) 8-1/2" DIA. I.W. - TYPE #6. SEE SCHEDULE THIS SHEET.

PLUMB. TRADES TO RUN ALL DRAIN/WASTE/CONDENSATE LINES FROM EQUIPMENT TO NEAREST F.D./F.S./I.W./H.O.

ALL ADDITIONAL PIPING, DRAINS, F.D.'s, ETC. TO BE SHOWN BY MECH. ENGINEER.

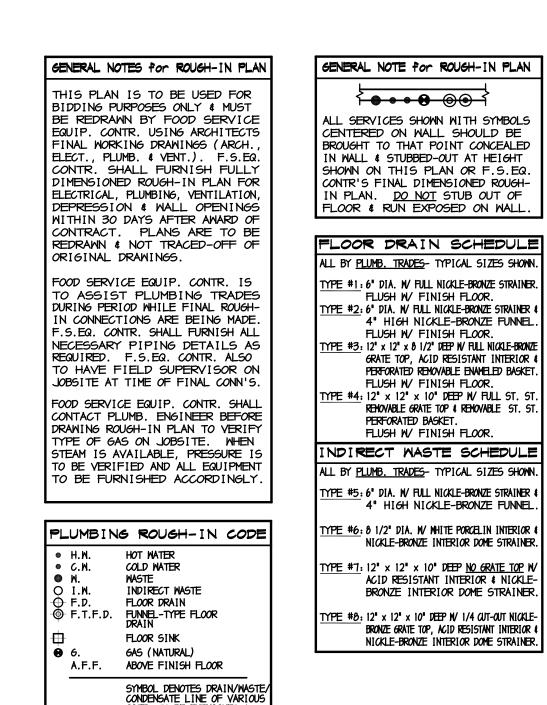
ALL ADDITIONAL P.R.V.S, ATMOSPHERIC V.B.S, V.B.S, SHUT-OFF VALVES, SHOCK-STOPS, ETC., TO BE FURN. & INST'D BY PLUMB. TRADES.

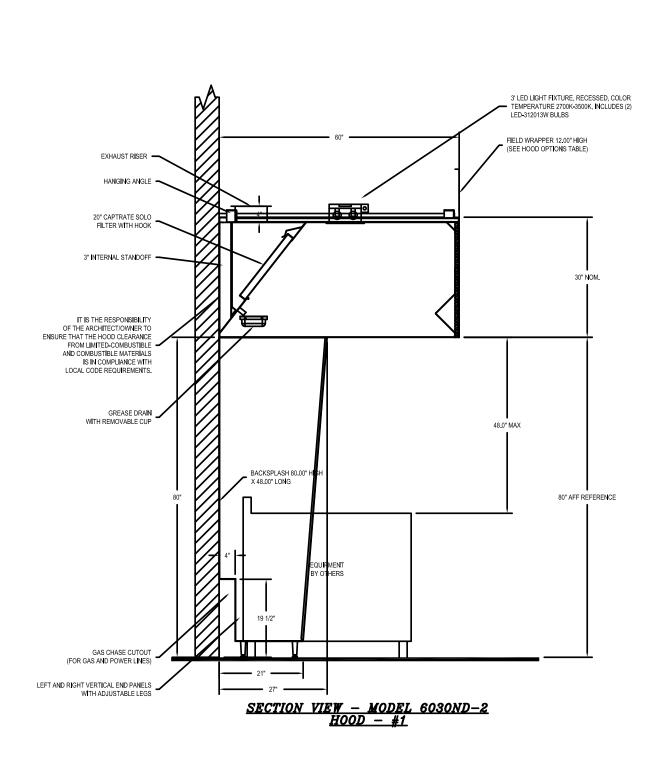
VENTILATION NOTES

VI) 8" x 8" EXHAUST DUCT- 720 CFM (MIN.) TOTAL @ -0.396" S.P. AT DUCT COLLAR. NOTE... DUCTWORK STATIC MUST BE ADDED.

ARCHITECTURAL NOTES

(2) TWO HANGER CHANNELS FURN. & INST'D BY ARCH. TRADES- SECURED TO BUILDING STRUCTURAL TO SUPPORT EXHAUST HOODS (WEIGHTS AS SHOWN). F.S.E.C. TO VERIFY ALL SIZES & LOCATIONS.

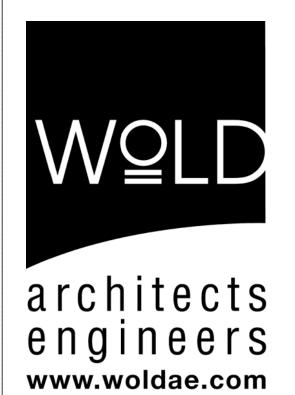




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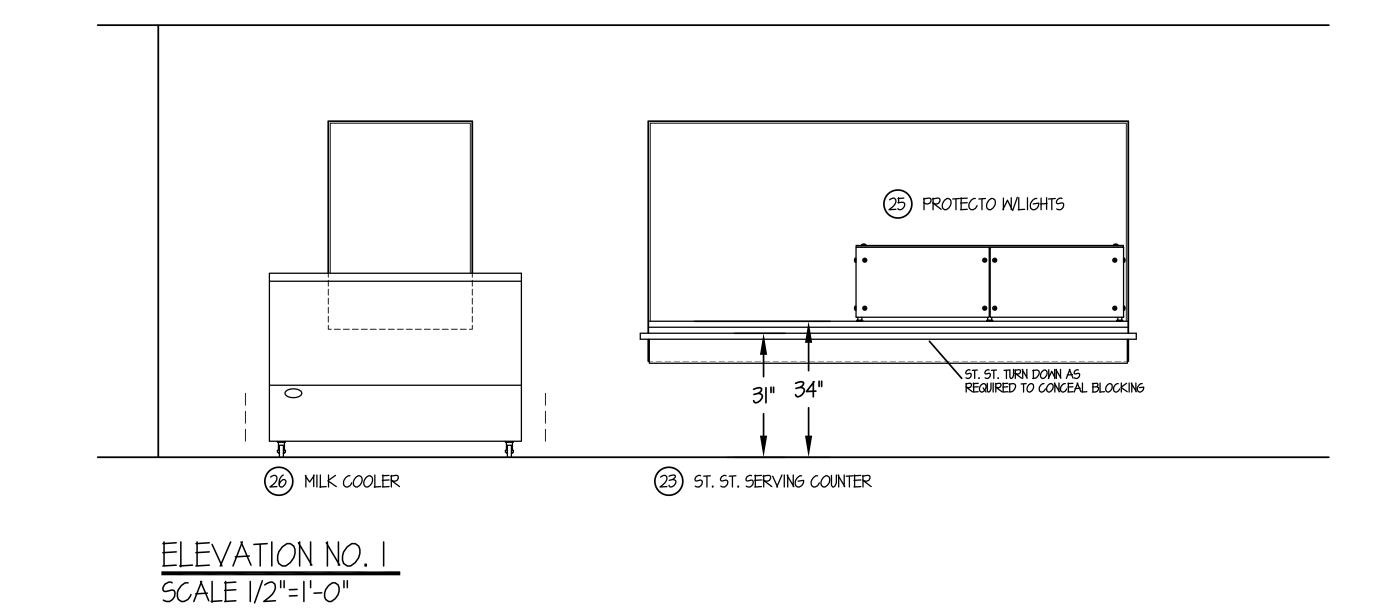
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Royal Oak, MI 48067 mail@woldae.com

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PLUMBING/ VENTILATION PLAN FOR FOOD SERVICE



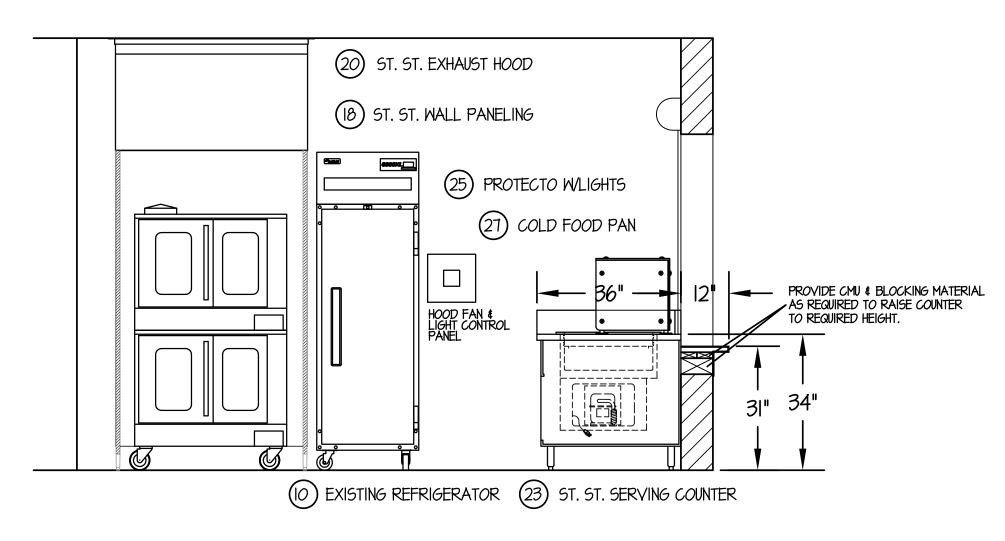


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ELEVATION NO. 2 SCALE 1/2"=1'-0"

25) PROTECTO WLIGHTS

23) ST. ST. SERVING COUNTER 27) COLD FOOD PAN



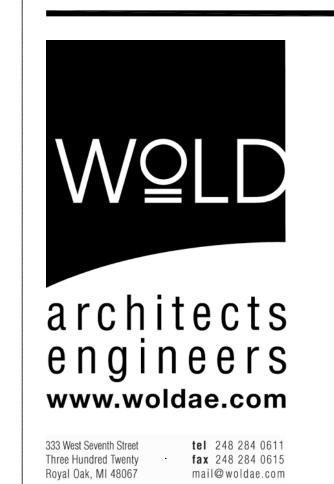
(15) EXISTING DISPOSER
(14) EXISTING THREE COMPARTMENT SINK

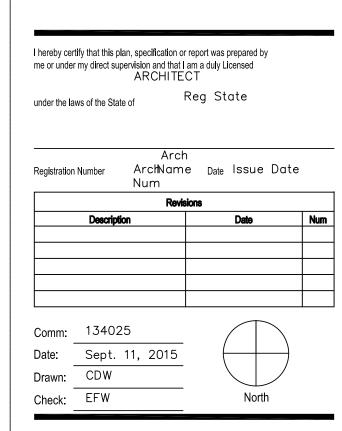
ELEVATION NO. 3 SCALE 1/2"=1'-0"

MacGowan Elementary School Kitchen Improvements
18255 Kinloch Redford, MI 48240

Redford Union School District

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FOOD SERVICE EQUIPMENT ELEVATION DETAILS

