



٨		F		M		R (CONT.)	
A AFF	ABOVE FINISHED FLOOR	Γ FWP	FABRIC WRAPPED PANEL		MACNETIC	∏ (CONT.) RD	ROOF DRAIN
ARF	ABOVE REFERENCE FLOOR	FB	FACE BRICK	MAG MH	MAGNETIC MANHOLE	RS RFG	ROOF SUMP ROOFING
ACCT AP	ACCENT ACCESS PANEL	FOC FF	FACE OF CONCRETE FACTORY FINISH	MFR MAR	MANUFACTURE(R) MARBLE	RM	ROOM
AC ACT	ACOUSTICAL ACOUSTICAL TILE (OR ACTIVE)	FS F°	FAR SIDE DEGREES FAHRENHEIT	MAR T. MKB	MARBLE THRESHOLD MARKER BOARD	RO RUB	ROUGH OPENING RUBBER
ADD	ADDENDUM	FT	FEET/FOOT	MAS	MASONRY	RB	RUBBER BASE (OR RESILIENT BASE
ADD'L ADJ	ADDITIONAL ADJACENT	F I N FE	Finish(ed) Fire extinguisher	MO MAT	MASONRY OPENING MATERIAL(S)	S	
AGG	AGGREGATE	FEC FVC	FIRE EXTINGUISHER CABINET	MAX	MAXIMUM		CANITADV
A/C ALT	AIR CONDITIONING ALTERNATE OR ALTERNATIVE	FLD	FIRE VALVE CABINET FIELD	MECH MC	MECHANICAL MEDICINE CABINET	SAN SND	SANITARY SANITARY NAPKIN DISPENSER
AL,ALUM ANCH	ALUMINUM ANCHOR, ANCHORAGE	FHS FPR	FIRE HOSE STATION FIRE PROOFING	MED MEM	MEDIUM MEMBER	SNWR	SANITARY NAPKIN WASTE RECEPTACLE
AB ANOD	ANCHOR BOLT ANODIZED	FL FD	FLOOR(ING) FLOOR DRAIN	MEMB	MEMBRANE	SCH SJ	SCHEDULE SCORED JOINT
ARCH	ARCHITECT(URAL)	FLUOR	FLUORESCENT	MET MDS	METAL METAL DIVIDER STRIP	S.CONC	SEALED CONCRETE
ASPH AUTO	ASPHALT AUTOMATIC	FTG FDN	FOOTING FOUNDATION	ML MET T.	METAL LATH METAL THRESHOLD	SEAL SECT	SEALER SECTION
5		FA FSRS	FRESH AIR FULLY-ADHERED	MEZZ	MEZZANINE MILLIMETER(S)	SS SHT	SERVICE SINK SHEET
В			SHEET ROOFING SYSTEM	mm M I N	MINIMUM	SL0	SHORT LEG OUTSTANDING
B.F.	BARRIER FREE	FURR	FURR(ED), (ING)	MIR MISC	MIRROR MISCELLANEOUS	SIM SK	SIMILAR SINK
BP BP _L	BASE PLATE OR BEARING P _I	G		MISC	MISCELLANEOUS IRON	SB STC	SOIL BORING SOUND TRANSMISSION CLASS
BRG BM	BEARING BENCH MARK OR BEAM	GA	GAGE, GAUGE	MON. MCC	MONITOR(ED) MOTOR CONTROL CENTER	S	SOUTH
BETW	BETWEEN	GAL GALV	GALLON GALVANIZED	MTD MULL	MOUNT(ED), (ING) MULLION	SPC SPK	SPACER, SPACING SPEAKER
BIT BLKG	BITUMINOUS BLOCKING	GL	GLASS, GLAZING	WOLL	WOLLION	SPEC(S)	SPECIFICATION(S)
BD BS	BOARD BOTH SIDES	GR g	GRADE, GRADING GRAM			SPEC'D SQ	SPECIFIED SQUARE
BOT	воттом	GRD GYP	GROUND GYPSUM	N		cm ² SF	SQUARE CENTIMETER SQUARE FOOT (OR STOREFRONT)
BC BRK	BOTTOM OF CURB BR IC K	GYP L	GYPSUM LATH	NAT	NATURAL		(OR SPORTS FLOORING)
BLDG BL	BUILDING BUILDING LINE	GP GWB	GYPSUM PLASTER GYPSUM WALL BOARD	NCA NEG	NATURAL COLOR ANODIZED NEGAT I VE	STAG SST	STAGGERED STAINLESS STEEL
	DUILDING LINE	1.1		NRC	NOISE REDUCTION	STD STA	STANDARD STATION
C		Н		NONCOMB	COEFFICIENT NONCOMBUSTIBLE	STL	STEEL
CABT	CABINET	HDCP HDBD	HANDICAP(PED) HARDBOARD	NOM N	NOMINAL NORTH	STN STOR	STONE STORAGE
CR CPT	CARD READER CARPET(ED)	HDWE	HARDWARE	NA	NOT APPLICABLE	SD ST	STORM DRAIN STREET
CES CI	CARPET EDGE STRIP CAST IRON	HWD HTG	HARDWOOD HEATING	NIC NTS	NOT IN CONTRACT NOT TO SCALE	STRUCT	STRUCTURAL
CIP	CAST-IN-PLACE	H&V HVAC	HEATING & VENTILATING HEATING/VENTILATION/	NO (#)	NUMBER	SA SUPP	SUPPLY AIR SUPPORTS
CB CLG	CATCH BASIN CEILING		AIR CONDITIONING	0		SUSP SW	SUSPENDED SWITCH
CEM	CEMENT	HT H	HEIGHT HIGH	0		SWBD	SWITCHBOARD
C TO C CM	CENTER TO CENTER CENTIMETER(S)	HP HS	HIGH POINT HIGH STRENGTH	OFF	OFFICE	SWGR SYM	SWITCHGEAR SYMMETRY(ICAL)
C° CER	DEGREES CENTIGRADE CERAMIC	HC	HOLLOW CORE	O/C OPG	ON CENTER(S) OPENING		
CT	CERAMIC TILE	HM HOR I Z	HOLLOW METAL HOR I ZONTAL	OPP OPP HD	OPPOSITE OPPOSITE HAND	T	
CHAN CHDK PL	CHANNEL CHECKERED PLATE	HP HB	HORSE POWER HOSE BIBB	ORIG	ORIGINAL	TKB	TACKBOARD
CL CLOS	CLEAR(ANCE) CLOSET	HW	HOT WATER	Oz OS	OUNCE OUTSIDE	TP	TANGENT POINT
CO	CLEAN OUT	HWH HR	HOT WATER HEATER HOUR	OA OD	OUTSIDE AIR OUTSIDE DIAMETER	TEL TV	TELEPHONE TELEV I SION
CHK CW	COAT HOOK COLD WATER			OH	OVERHEAD	TEMP TERR	Temperature, Tempered Terrazzo
COL COMB	COLUMN COMBINATION	l				TT	TERRAZZO TILE
COMP	COMPRESS(ED),(ION),(IBLE)	IN(") INCL	INCH(ES) INCLUDE(D), (ING)	Б		THERM THK	THERMOSTAT THICK(NESS)
CONCE CONC	CONCEALED CONCRETE	INFO	INFORMATION	Р		THRES THRU	THRESHOLD THROUGH/THOUGHOUT
CMU	CONCRETE MASONRY UNIT	I D INSUL	INSIDE DIMENSION INSULATE(D), (ION)	PH	PHYSICALLY HANDICAPPED	TO I L TPH	TOILET TOILET PAPER HOLDER
CONN	(CONCRETE BLOCK) CONNECTION	ICA	INTEGRAL COLOR ANODIZED	PT PR	PAINT(ED) (OR POINT) PAIR	TOL	TOLERANCE
CONST CONST JT	CONSTRUCTION CONSTRUCTION JOINT	INT	INTERIOR/INTERNAL	PNL PTD	PANEL PAPER TOWEL DISPENSER	T&G T&B	TONGUE AND GROOVE TOP & BOTTOM
CONT CONTR	CONTINUOUS OR CONTINUE	INTERM INV	Intermediate Invert	PTD/R	PAPER TOWEL DISPENSER &	TE TOC	TOP ELEVATION TOP OF CONCRETE
CJ	CONTRACT(OR) CONTROL JOINT	I RR	IRRIGATION	PKG	RECEPTACLE COMBINATION PARKING	TC	TOP OF CURB
CORR CTR	CORRUGATED OR CORRIDOR CENTER	1		PBD PARTN	Particle Board Partition	TOS TWC	TOP OF STEEL TOWEL & WASTE CABINET
CTSK CF	COUNTERSUNK CUBIC FOOT	J		PE	PASSENGER ELEVATOR	TRAN	TRANSFORMER TREAD
CY	CUBIC YARD	JC JT	JANITOR'S CLOSET JOINT	PERM PLAS	PERMANENT PLASTER	TYP	TYPICAL
CYL	CYLINDER	JST	JOIST	PL P	PLASTIC LAMINATE PLATE	1.1	
D		JB	JUNCTION BOX	PLBG	PLUMBING	U	
DPR	DAMPER	K		PLWD POL	PLYWOOD POLISHED	UH UON	UNIT HEATER UNLESS OTHERWISE NOTED
DP DL	DAMPROOFING DEAD LOAD	kg	KILOGRAMS	PVC lb/#	POLYVINYL CHLORIDE POUND(S)	UR	URINAL
DET	DETAIL	KV	KILOVOLT KILOVOLT/AMPERE	PCF	POUNDS PER CUBIC FOOT	V	
DIAG ∅	DIAGONAL DIAMETER	KVA KW	KILOWATT(S)	PPF PLF	POUNDS PER FOOT POUNDS PER LINEAL FOOT	•	
DIFF DIM	DIFFUSER DIMENSION	KWH kg/m	KILOWATT-HOUR KILOGRAM PER METER	PSF PC	POUNDS PER SQUARE FOOT PRECAST CONCRETE	VA VB	VALVE VAPOR BARR I ER
D/W	DISHWASHER	kg/cm 2	KILOGRAM PER SQUARE	PRE-FAB	PREFABRICATE(D)	VR VAR	VAPOR RETARDER VARNISH
DO DN	DOOR OPENING DOWN	К	CENTIMETER KIPS			VERT	VERTICAL
DT DWG	DRAIN TILE DRAWING	KSI KIT	KIPS PER SQUARE INCH KITCHEN	Q		VEST VIN	VESTIBULE VINYL
DF DWG	DRINKING FOUNTAIN	KO	KNOCKOUT	QT	QUARRY TILE	VCT VT	VINYL COMPOSITION TILE
С		1		QB	QUARRY TILE BASE	VWC	VINYL TILE VINYL WALL COVERING
E		L		QTR	QUARTER	VIT VRS	VITREOUS VINYL RESILIENT STRIP
EA EF	EACH EACH FACE	LAB LAM	Laboratory Laminate(d)	R			
EW	EACH WAY	LAV	LAVATORY		RADIUS. RADIATOR. RADIATION	W	
E ELEC	EAST ELECTR I C(AL)	LCC LH	LEAD COATED COPPER LEFT HAND	RAD RC	RAINWATER CONDUCTOR	WAIN	WAINSCOT
EWC EL	ELECTRIC WATER COOLER ELEVATION	LHR L	LEFT HAND REVERSE LENGTH	RECVG REC	RECEIVING RECESS(ED)	WHYD WH	WALL HYDRANT WATER HEATER
ELEV	ELEVATOR	LT	LIGHT	REF	REFERENCE	WC WM	WATER CLOSET WATER MAIN
EMER ENC	EMERGENCY ENCLOS(E), (URE)	LTG LP	LIGHTING LIGHTING PANEL	REFL REFR	REFLECT(ED), (IVE), (OR) REFRIGERATOR	WP	WATERPROOFING
EP	EPOXY	LIN LSWD	LINEAR, LINEAL LINEAR SUSPENDED WOOD CEILING	REG REINF	REGISTER REINFORCE(D), (ING)	WR WS	WATER RESISTANT WATERSTOP
EQ EQUIP	EQUAL EQUIPMENT	LL	L I VE LOAD	REQD	REQUIRED	WT WWF	WEIGHT WELDED WIRE FABRIC
ESC EPDM	ESCALATOR ETHYLENE PROPYLENE	LG LLBB	LONG LONG LEGS BACK	res i l Rt	RESILIENT RESILIENT TILE	WWM	WELDED WIRE MESH
	DIENE MONOMERS		TO BACK	RA	RETURN AIR	W W/	width, wide, west with
EXH EB	EXHAUST EXPANSION BOLT	LLH LLO	LONG LEG HORIZONTAL LONG LEG OUTSTANDING	REV RH	REVISION(S), REVISED RIGHT HAND	W/0	WITHOUT
EJ EXP CONST	EXPANSION JOINT EXPOSED CONSTRUCTION	LLV LOC	LONG LEG VERTICAL LOCATE/LOCATION	RHR ROW	RIGHT HAND REVERSE RIGHT OF WAY	WD	WOOD
EXP CONST	EXTERIOR	L.P.	LOW POINT	nuw	HIGHT OF WAT		

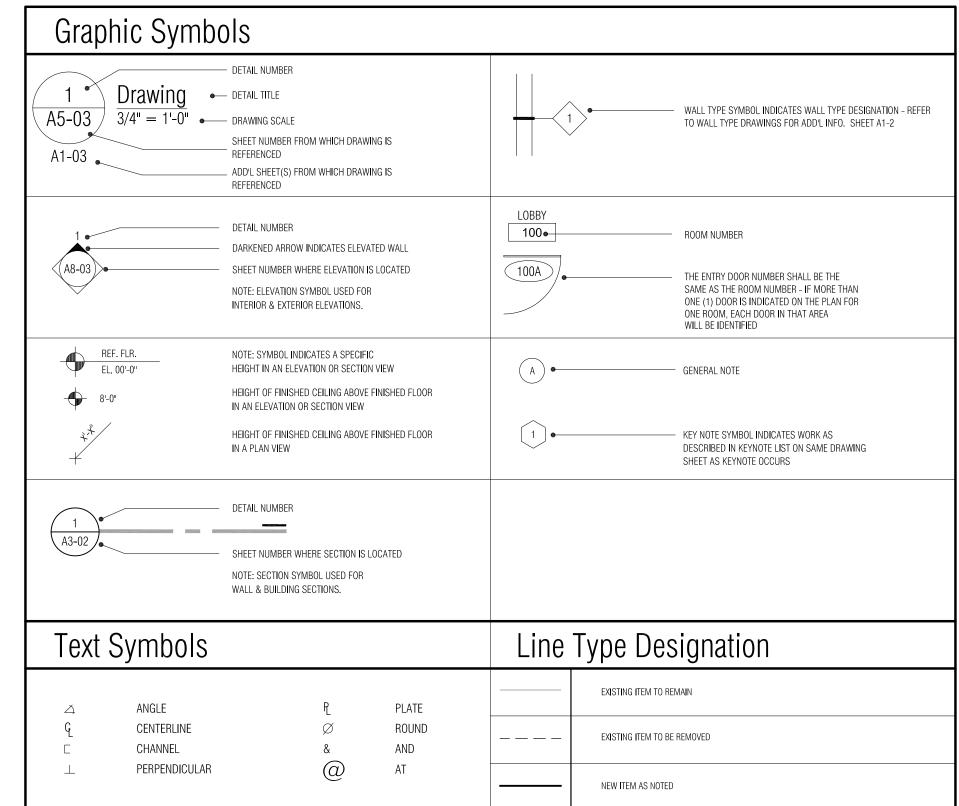

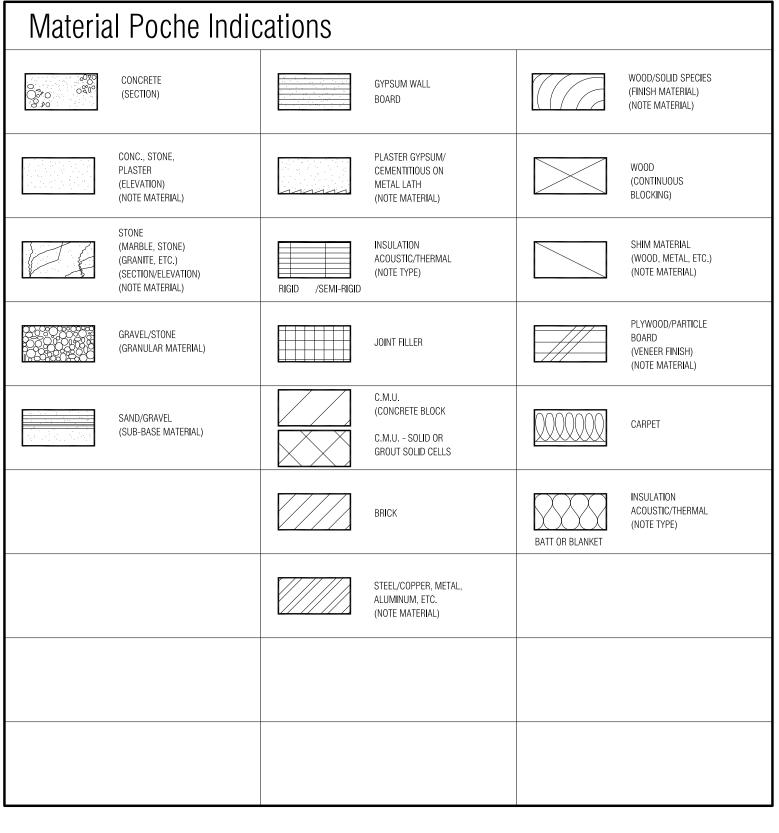

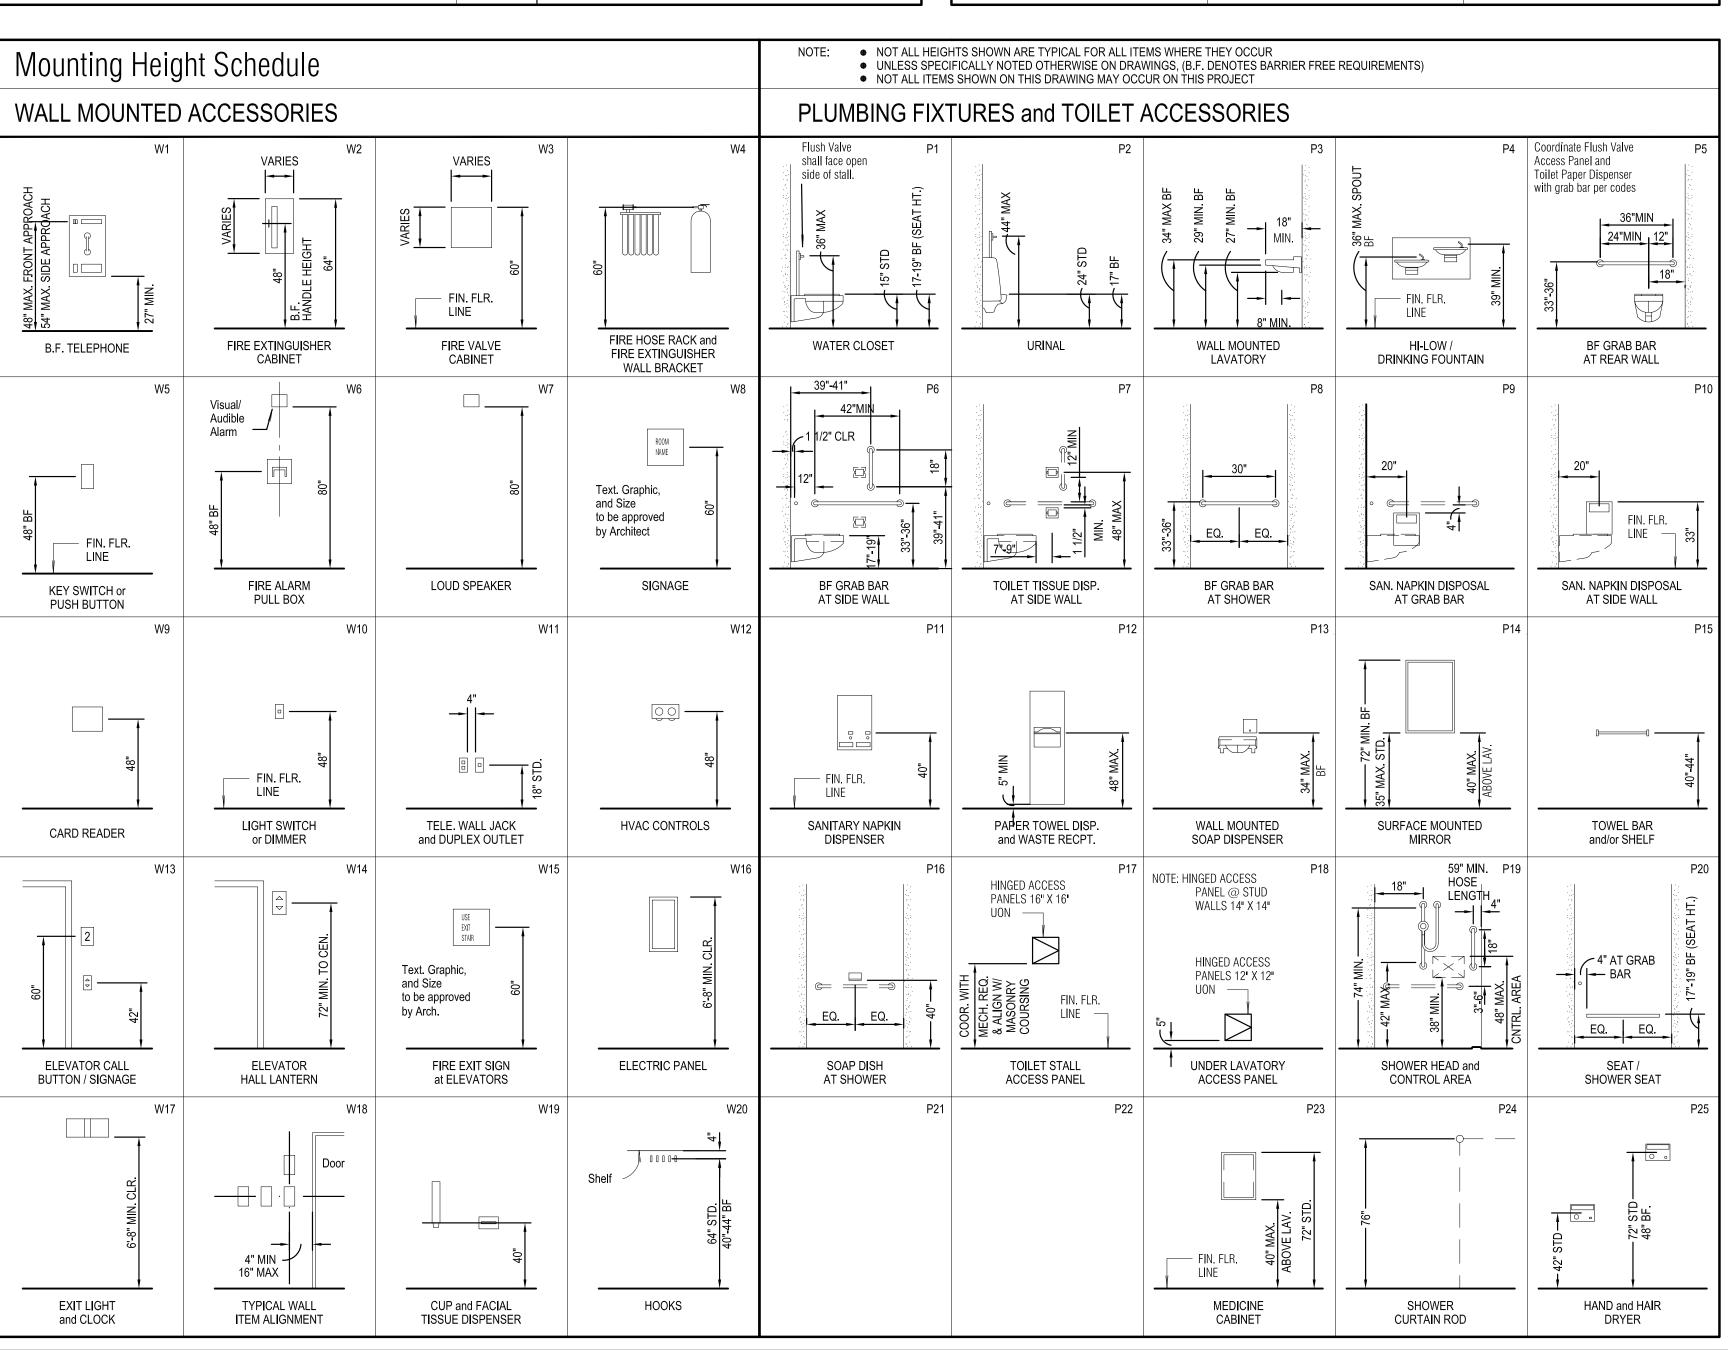

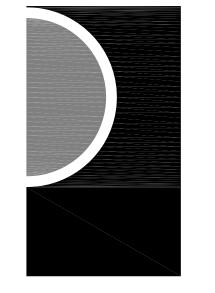

PARTNERS in Architecture, PLC
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Statement of Intellectual Property

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CONSULTANT

KEY PLAN

OWNER

CITY OF NEW BALTMORE

PROJECT NAME

Department of Public Service Building Addition

35389 Cricklewood New Baltimore, MI 48047


PROJECT NO.

13-107

ISSUES / REVISIONS

OWNER REVIEW 5/8/2013

BIDS/CONSTRUCTION 5/17/2013

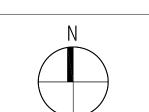

DRAWN BY
KJB

KJB CHECKED BY

APPROVED BY

SHEET NAME
GENERAL
INFORMATION

SHEET NO.
A0-01

BUILDING CODE INFORMATION

OWNER: CITY of NEW BALTIMORE

PROJECT: DPS GARAGE BUILDING ADDITION

ADDRESS: 35389 CRICKLEWOOD, NEW BALTIMORE, MICHIGAN 48047

PROPOSED USE: EXTERIOR WEATHER SHELTER FOR DPW RUCKS AND EQUIPMENT

GOVERNING CODE:

BUILDING: 2009 MICHIGAN BUILDING CODE MECHANICAL: 2009 MICHIGAN MECHANICAL CODE PLUMBING: 2009 MICHIGAN PLUMBING CODE ELECTRICAL: 2008 NATIONAL ELECTRICAL CODE AISC SPECIFICATION FOR THE DESIGN, FABRICATION AND ERECTION OF STRUCTURAL STEEL FOR BUILDINGS (335-89S1)

AISC CODE OF STANDARD PRACTICE FOR BUILDINGS (2009 EDITION) AWS D1.1-2009 STRUCTURAL WELDING CODE AISC STEEL CONSTRUCTION MANUAL. THIRTEENTH EDITION

BUILDING DATA SUMMARY:

CONSTRUCTION TYPE:B-2

USE GROUP: S-1 (STORAGE, MODERATE - MOTOR VECHICAL REPAIR GARAGE) USE GROUP: S-2 (STORAGE, LOW - PARKING GARAGE)

USE GROUP: B (BUSINESS - OFFICE) BUILDING HEIGHT: 1 STORY

CODE ANALYSIS AREA CACULATIONS:

S-1 TOTAL NET AREA = 2,324 SQ FT S-2 TOTAL NET AREA = 6,274 SQ FT B TOTAL NET AREA = 1,459 SQ FT

CHAPTER 3 USE and OCCUPANCY CLASSIFICATION: SECTION 312.1: UTILITY AND MISCELLANEOUS GROUP U

CHAPTER 4 SPECIAL REQUIRMENTS:

SECTION 406.4: ENCLOSED PARKING GARAGES:

SECTION 406...6 REAPIR GARAGES:

CHAPTER 5 GENERAL BUILDING HEIGHT and AREA: ALLOWABLE: PER 2003 MBC TABLE 503

GROUP B / TYPE 2-B AREA OF 23,000 S.F. PER FLOOR

HEIGHT OF 3 STORIES

GROUP S-1 / TYPE 2-B AREA OF 17,500 S.F. PER FLOOR HEIGHT OF 2 STORIES

GROUP S-2 / TYPE 2-B AREA OF 26,000 S.F. PER FLOOR HEIGHT OF 3 STORIES

CHAPTER 6 TYPES of CONSTRUTION:

PER TABLE MBC 601 TYPE 2-B

STRUCTURAL FRAME BEARING WALLS INTERIOR

EXTERIOR NONBEARING WALLS & PARTITIONS

ROOF CONSTRUCTION

0 HR....NA INTERIOR EXTERIOR 0 HR.....NA FLOOR CONSTRUCTION 0 HR....NA

CHAPTER 10 MEANS of EGRESS REQUIREMENTS:

OCCUPANT LOAD MBC TABLE 1004.1.1

B - BUSINESS = 716 S.F. NET / 100 PER OCCUPANT = 8 OCCUPANTS S-1 REPAIR GARAGE = 2,324 S.F. NET / 200 PER OCCUPANT = 12 OCCUPANTS S-2 - PARKING GARAGE = 6,274 S.F. NET / 500 PER OCCUPANT = 13 OCCUPANTS

TOTAL TABULATED OCCUPANT LOAD = 40 OCCUPANTS

EXIT REQUIREMENTS

MBC 1014.2 EGRESS THROUGH INTERVENING SPACES

EGRESS MAY ONLY PASS THRU ROOM OR SPACES WHEN ADJOINING ROOMS ARE ACCESSORY TO ONE AND PROVIDE A DISCERNIBLE PATH OF EGRESS TRAVEL TO AN EXIT.

MBC 1014.3 COMMON PATH OF TRAVEL MAXIMUM OF 75'-0" ALLOWED (PROVIDE 25'-0" MAX)

MBC 1016.1 EXIT ACCESS TRAVEL DISTANCE MAXIMUM OF 200'-0" ALLOWED

DEAD END CORRIDOR

0 HR.....NA

0 HR.....NA

0 HR.....NA

PER MBC 1018.3 = 20'-0" LIMIT MAXIMUM CONDITION

MBC 1020.1 NUMBER OF EXITS

(6) TOTAL DIRECT EXTERIOR

(PROVIDE 75'-0" MAX)

CHAPTER 11 ACCESSIBILITY:

MBC 1101.2 DESIGN

BUILDING AND FACILITIES SHALL BE DESIGNED AND CONSTRUCTED TO BE ACCESSIBLE IN ACCORDANCE WITH 1966 PA 1. MCL125.1351 TO

125.1356, THIS CODE AND ICC/ANSI A 117.1, EXCEPT SECTIONS 611 AND 707

CHAPTER 24 GLASS AND GLAZING:

MBC 2406 SAFETY GLAZING

2406.4 HAZARDOUS LOCATIONS: REQUIRE SAFETY GLAZING

CHAPTER 34 EXISTING STRUCTURES:

2009 MBC 3403.1 EXISTING BUILDINGS OR STURCTURES ALTERATIONS TO ANY BUILDING OR STRUCTURE SHALL


> COMPLY WITH THE REQUIREMENTS OF THE CODE FOR NEW CONSTRUCTION

..... PORTIONS OF THE STRUCTURE NOT ALTERED AND

NOT AFFECTED BY THE ALTERATION ARE NOT REQUIRED TO COMPLY WITH THE CODE REQUIRMENTS FOR A NEW

50% OF THE ENTIRE STRUCTURE / BUILDING.

PARTNERS

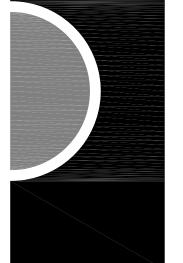

PARTNERS in Architecture, PLC

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Statement of Intellectual Property

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CONSULTANT

NEW BALTMORE

PROJECT NAME

Department of Public Service **Building Addition**

35389 Cricklewood

New Baltimore, MI 48047

PROJECT NO.

13-107

ISSUES / REVISIONS

WALL" CONSTRUCTION PER 2009 MBC SECTION 705.

THIS WALL CONSTRUCTION HAS 90 MINUTE DOOR

AND FRAME PROTECTIVES. PROVIDE FIRE / SMOKE

BARRIER" CONSTRUCTION PER 2009 MBC SECTION 706. THIS WALL CONSTRUCTION HAS 45 MINUTE DOOR AND FRAME PROTECTIVES. PROVIDE FIRE /

SMOKE DAMPERS AS REQUIRED PER 2009 MBC.

PARTITION" CONSTRUCTION PER 2009 MBC SECTION

708. THIS WALL CONSTRUCTION HAS 20 MINUTE

CORRIDORS. PROVIDE FIRE / SMOKE DAMPERS AS

BARRIER" CONSTRUCTION PER 2009 MBC SECTION 708. THIS WALL CONSTRUCTION HAS 90 MINUTE DOOR AND FRAME PROTECTIVES. PROVIDE FIRE /

SMOKE DAMPERS AS REQUIRED PER 2009 MBC.

OCCUPANT LOAD EXITING THROUGH EGRESS

OCCUPANT CAPACITY OF EGRESS COMPONENT

OCCUPANT LOAD OF ROOM OR AREA

DOOR AND FRAME PROTECTIVES FOR ALL


REQUIRED PER 2009 MBC.

FIRE EXTINGUISHER CABINET (75' MAX. TRAVEL DISTANCE)

• **>** (#

DAMPERS AS REQUIRED PER 2009 MBC.

OWNER REVIEW BIDS/CONSTRUCTION 5/17/2013

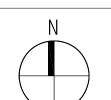


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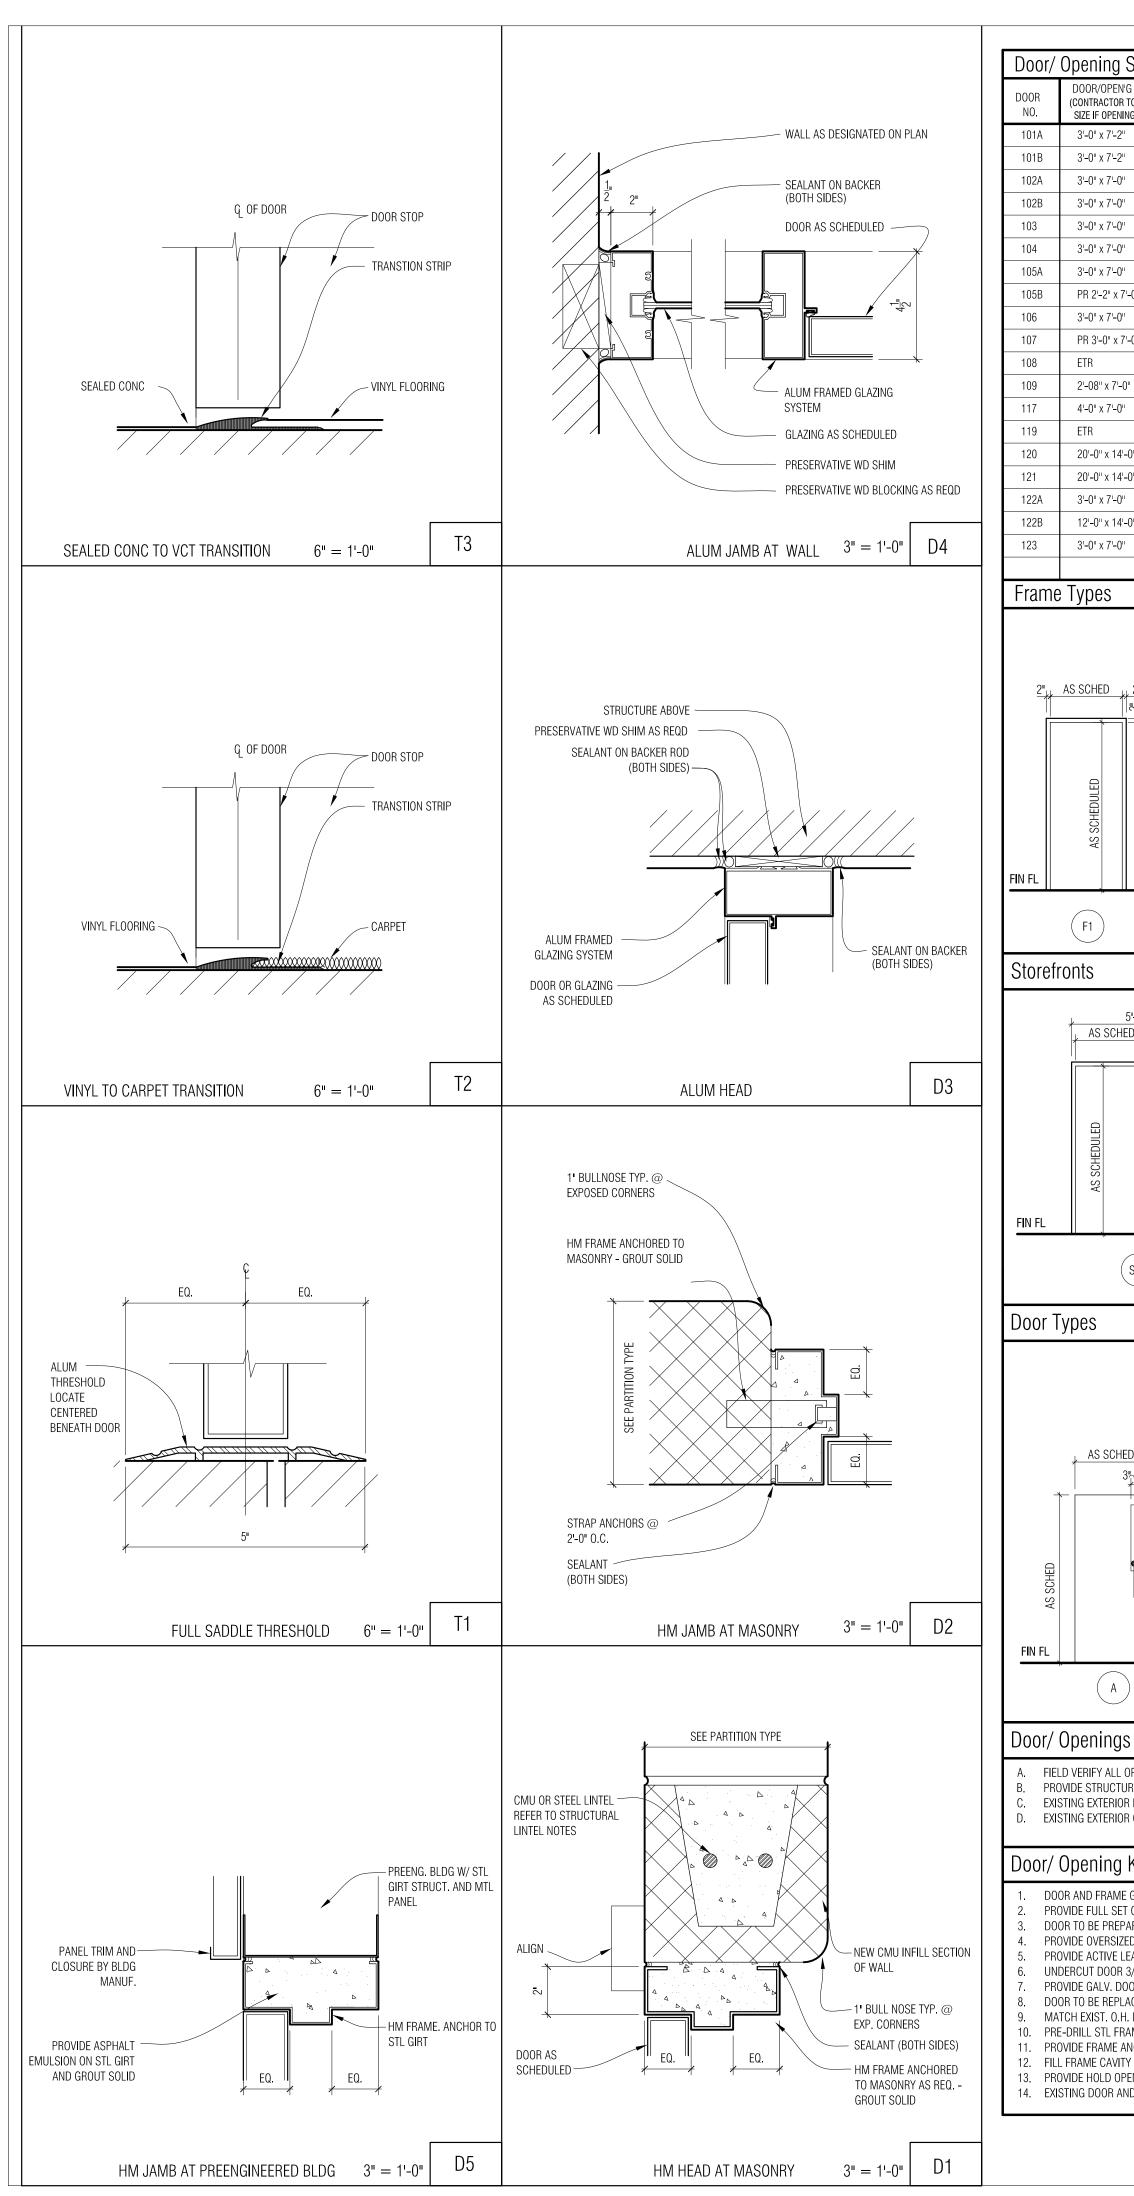
KJB CHECKED BY

APPROVED BY


SHEET NAME LIFE SAFETY PLAN / CODE INFORMATION

SHEET NO. A0-02



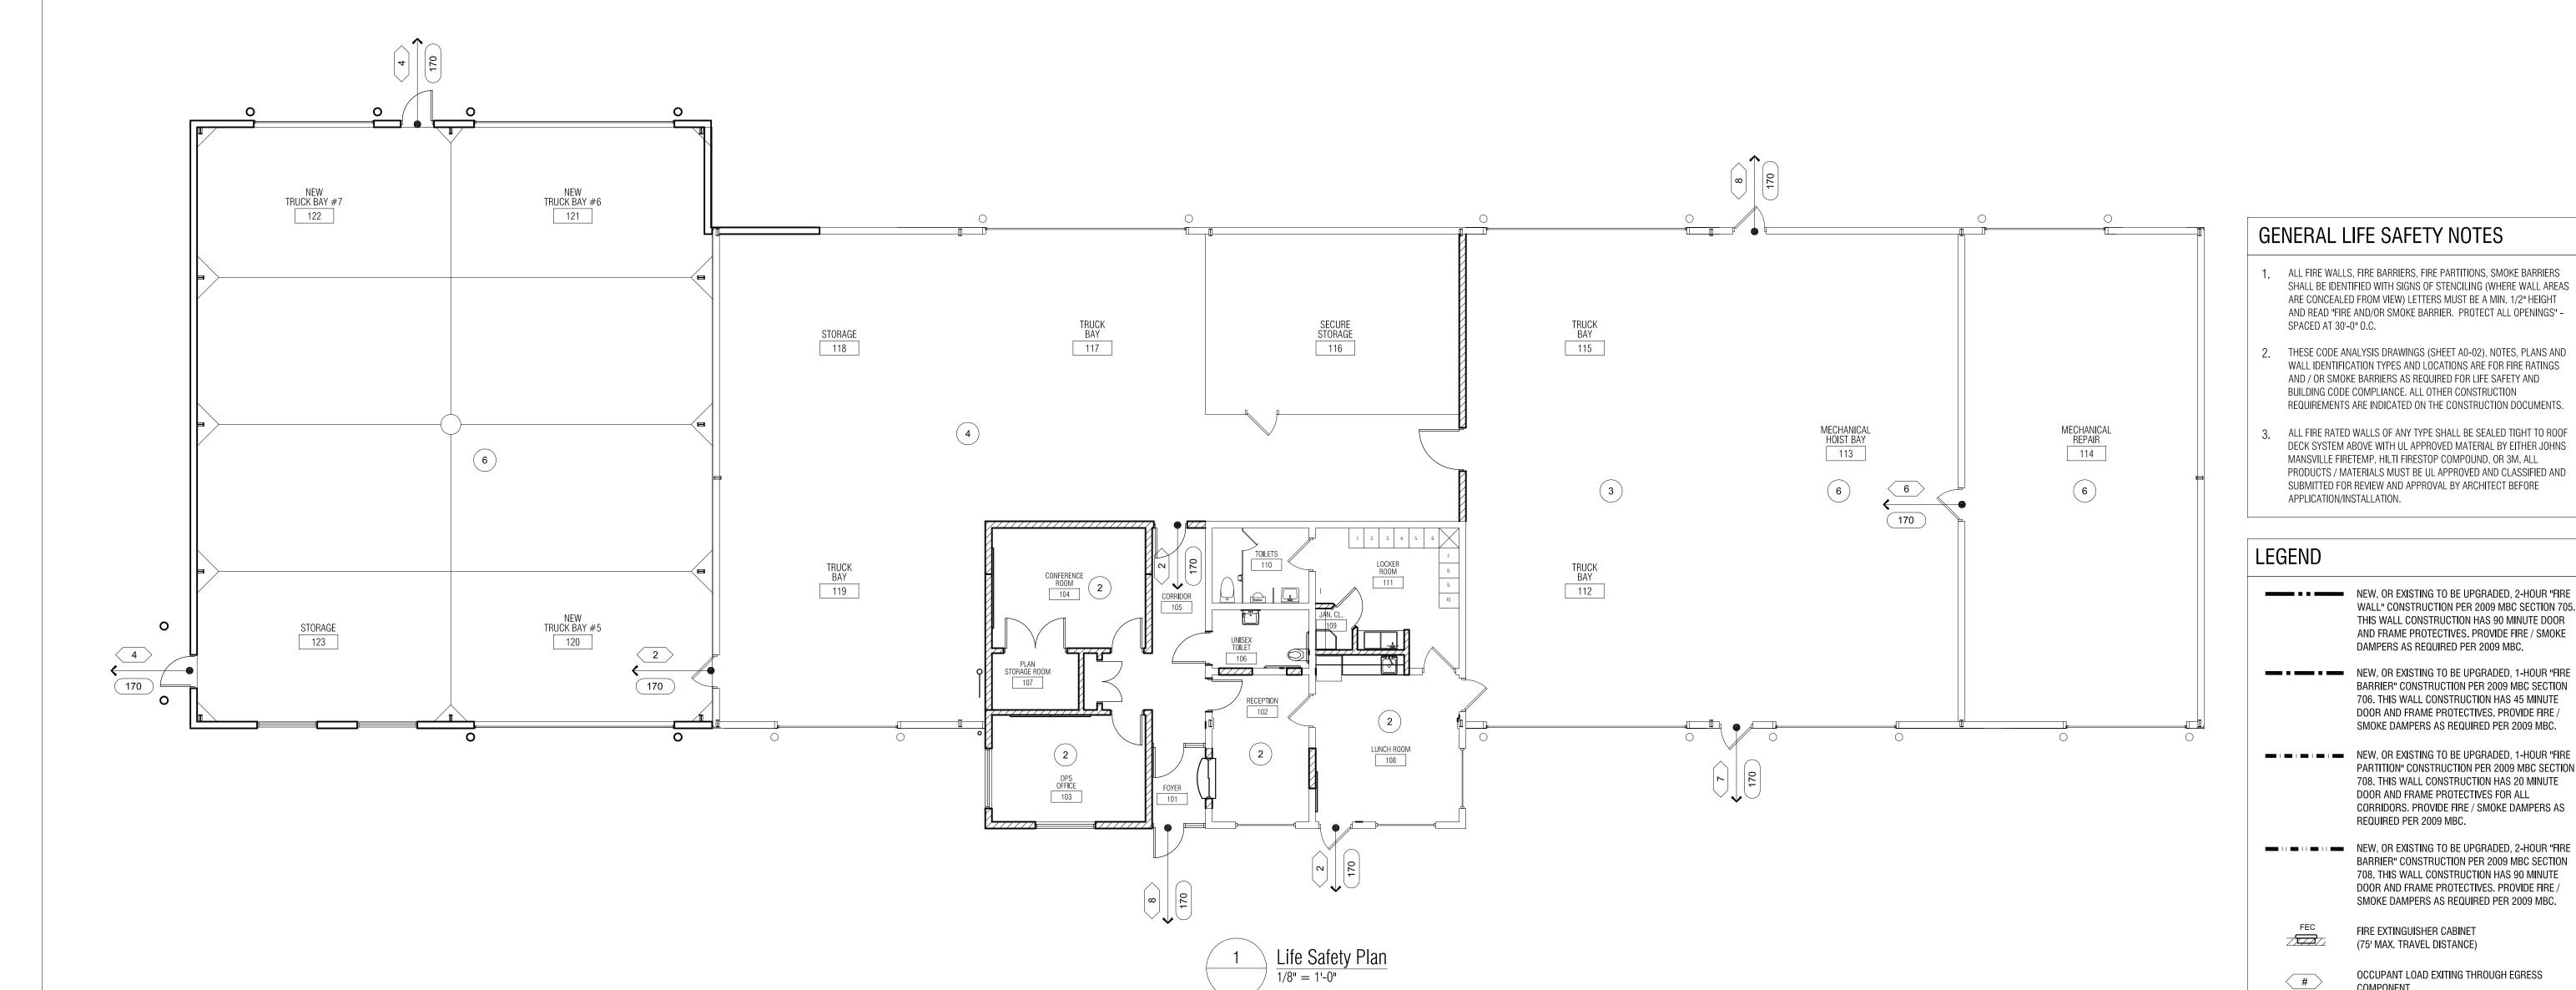

No.		Opening Schedule												Room	Finish Schedule			
MAX 1997-12 C	DOOR NO.	(CONTRACTOR TO VERIFY DOOR	TYPE		FINISH	TYPE		FINISH	HEAD		THRES./ SILI		DOOR/ OPENING KEY NOTES		ROOM NAME	FL00R	BASE	NOE
29 20 20 20 20 20 20 20	101A	3'-0" x 7'-2"	С	ALUM	FF	SF1	ALUM.	FF	D3	D4	T1	01	 1, 2, 3	101	FOYER	VCT-	RB-	PN
Secretary 1					-						<u> </u>		3					PN
1				-	1	1				1		1	-					PN
March Marc					1	+				+		-		104	CONFERENCE ROOM	VCT-	RB	PN
Second Column C					+	1	+	-		+	+	-		105	CORRIDOR	VCT-	RB-	PN
Second S										1		1		106	UNISEX TOILET	VCT-	RB-	PN
Mile					-					+	_			107	PLAN STORAGE ROOM	VCT-	RB-	PN
Company Comp	106	3'-0" x 7'-0"						-	D1	1	_	1		108	LUNCH ROOM	VCT-	RB-	PN
## 2-45-007 1 164 17 12 18 17 10 12 17 2 18 17 10 12 17 2 18 17 17 18 18 17 17 18 18	07	PR 3'-0" x 7'-0"	В	НМ	PNT	F3	НМ	PNT	D1	D2	T2	05	5	109	JAN CLST	QT-	RB-	PN
12 24 27 2 2 28 24 27 2 28 24 28 29 29 29 29 29 29 29	08	ETR	А	НМ		F1	НМ		-	-	T1	-	8, 2, 7, ALTERNATE #2	110	TOILET ROOM	ERT	ETR	E.
19	109	2'-08" x 7'-0"	В	НМ	PNT	F3	НМ	PNT	D1	D2	-	07	6, 7	111	LOCKER ROOM	ERT/QT	ETR/QT	E ⁻
## A STATEMENT CONTROL OF THE PROPERTY OF THE	17	4'-0" x 7'-0"	А	НМ	PNT	F3	НМ	PNT	D1	D2	T2	08	4, 13	115	BAY AREA	ETR	NR	N
29 26.3 c 42.7 1	119		ETR	НМ	PNT	ETR	НМ			<u> </u>		-		116	SECURE STORAGE	ETR	ETR	N
## 150 \$4,777 # ## ## ## ## ## ##			E		1	+		-			<u> </u>	<u> </u>		117	BAY AREA	ETR	NR	N
Table 1 1 1 1 1 1 1 1 1 1 1 1 1 1 1 1 1 1 1			E				+				 	1		119	BAY AREA	ETR	NR	N.
10 10 10 10 10 10 10 10					1						-			120	BAY AREA	CONC/SEAL	NR	N
Tame Types 13 STARCE DOOSEN DIT										1	_	<u> </u>		121	BAY AREA	CONC/SEAL	NR	PN
General Notes: A. BERRAND CERNS HITLES OF BUSIN DIVERSING HITLES OF BUSING HITLE	<u> </u>	3-0 x7-0	В	Пілі	PINI	F1	ПІИ	PINI	וט	02/03	"	10	2, 4, 7, 11, 12, 3	122	BAY AREA	CONC/SEAL	NR	PN
1. PROVIDE ADDITIONAL PRIMER COAT ON MASONRY INFILL AREA. 2. PAINT WALL PRIOR TO MARKER OR TACK BOARD INSTALLATION. 3. PROVIDE FLOOR PREP AT CONCRETE FLOOR INFILL AND REPAR AREAS. 4. PROVIDE MATCHING VCT FLOOR, BASE AND WALT LIKE FINISH HAT REMOVED FIXTU. 5. INFILL FASTENER HOLES IN TILE FINISH WY MATCHING SEALANT IF 5/16° OR LESS 6. PREP EXIST. FLOOR AT REMOVED QUARRY TILE FINISH TO RECEIVE NEW VCT FINIS 7. PRIME/PAINT NEW WALL SURFACE PRIOR TO CASEWORK INSTALLATION. 8. PREP. EXIST. DOOR AND FRAME FOR NEW PAINTED FINISH. 9. PRIME AND PAINT NEW GYPE BD WALL CONSTRUCTION AT MEZZANINE ABOVE. 10. PATCH, REPAIR AND EXTEND QUARRY TILE FINISH AT REMOVED SHOWER UNIT/PL. 11. ALTERNATE #3 FOR NEW ACOUSTIC CEILING AND LIGHTING. REMOVE EXISTING C. 12. PAINT NEW WALL SURFACE. 13. PAINT NEW WALL SURFACE. 14. PAINT EXPOSED METAL WALL PANEL. 15. PAINT NEW MASONRY SILL WALL. 14. PAINT EXPOSED METAL WALL PANEL. 15. PAINT NEW ONLY DOOR AND FRAME.		AS SCHEDULED	AS SCHED		(F	F2					AS SUMEDULED AS			A. REP EXIS B. EXIS C. STE INTE D. PRE INS E. NEV F. PRE REC G. EXIS	AIR AND REFINISH ITEMS OF EX ST/NEW FINISH OF AREA. STING/NEW SERVICE BAY AREAS EL SUPPORT FRAMING AT NEW ERIOR EDGE. PAIR EXISTING CONCRETE FLOC TALLATION OF NEW FLOOR FINIS V EXTERIOR GUARD BOLLARDS TO PARE EXISTING METAL SIDING NOMMENDED BY EXIST. PREENG STING PREENG. METAL ROOF PA	S. STEEL MAIN FRAME A AND EXIST. OVERHEAD OR INCLUDING SHOT BL SH. TO BE PAINTED SAFETY WALL PANELS, GUTTERS . BLDG. MANUFACTURE INELS ARE NOT TO BE P	ND SUBFRAM AND MAN DO ASTING TO RE YELLOW TO M S, DOWSPOUT R, BUTLE BUIL	NG ARE TO DRS IS TO MOVE GR ATCH EXI S, TO REC DING CO.
2. PAINT WALL PRIOR TO MARKER OR TACK BOARD INSTALLATION. 7. PROVIDE FLOOR PREP AT CONCRETE FLOOR INFILL AND REPARA RAES. 4. PROVIDE FLOOR PREP AT CONCRETE FLOOR INFILL AND REPARA RAES. 5. INFILL FASTENER HOLES IN TILE FINISH AT REMOVED FIXTU. 5. INFILL FASTENER HOLES IN TILE FINISH OF A REMOVED OLARRY TILE FINISH TO RECEIVE NEW VCT FINISH. 7. PRIME/PAINT NEW WALL SURFACE PRIOR TO CASEWORK INSTALLATION. 8. PREP, EXIST, DOOR AND FRAME FOR NEW PAINTED FINISH. 9. PRIME AND PAINT NEW GYP BD WALL CONSTRUCTION AT MEZZANINE ABOVE. 10. PATCH, REPAIR AND EXTEND OUARRY TILE FINISH AT REMOVED SHOWER UNIT/PL. 11. ALTERNATE #3 FOR NEW ACOUSTIC CEILING AND LIGHTING, REMOVE EXISTING C. 12. PAINT NEW WALL SURFACE. 13. PAINT NEW MALS OURSTIC CEILING AND LIGHTING, REMOVE EXISTING C. 14. PAINT NEW MALS ONEYS SILL WALL. 14. PAINT EXPOSED METAL WALL PANEL. 15. PAINT NEW OH. DOOR AND FRAME.	oref	onts																
		AS SCHED 2"			3-2"		6'-0"	*						2. PAII 3. PRC 4. PRC 5. INFI 6. PRE 7. PRII 8. PRE 9. PRII 10. PAT 11. ALT 12. PAII 13. PAII	NT WALL PRIOR TO MARKER OR IVIDE FLOOR PREP AT CONCRET IVIDE MATCHING VCT FLOOR, BALL FASTENER HOLES IN TILE FIN PEXIST. FLOOR AT REMOVED QUE/PAINT NEW WALL SURFACE P. EXIST. DOOR AND FRAME FOME AND PAINT NEW GYP BD WACH, REPAIR AND EXTEND QUARIERNATE #3 FOR NEW ACOUSTINT NEW WALL SURFACE. NT NEW MASONRY SILL WALL. NT EXPOSED METAL WALL PANE	TACK BOARD INSTALLA E FLOOR INFILL AND RE ASE AND WALL TILE FIN IISH W/ MATCHING SEA UARRY TILE FINISH TO I PRIOR TO CASEWORK II R NEW PAINTED FINISH ILL CONSTRUCTION AT I RY TILE FINISH AT REMO C CEILING AND LIGHTIN	TION. PAIR AREAS. IISH AT REMOVALANT IF 5/16" RECEIVE NEW NSTALLATION. MEZZANINE AE OVED SHOWEF	or Less. /CT Finisi ove. Unit/Plu

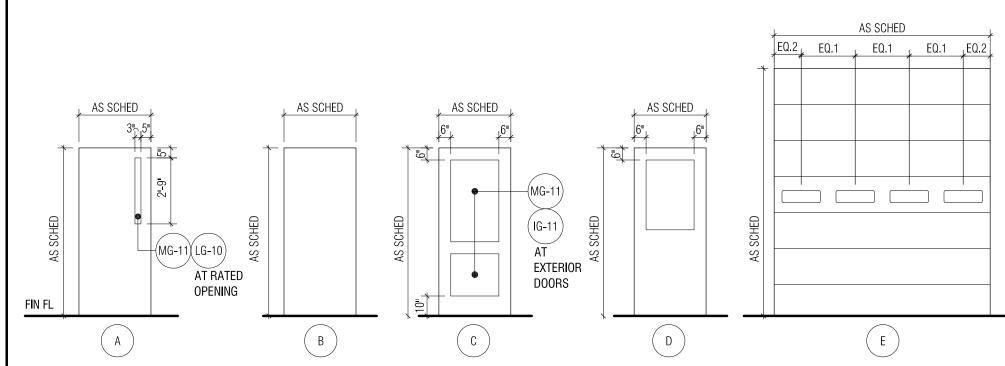

Door/ Openings General Notes:

- FIELD VERIFY ALL OPENINGS PRIOR TO DOOR/FRAME FABRICATION.
- PROVIDE STRUCTURAL STEEL WELDED ANCHORS AT DOOR FRAME INSTALLATION IN PRE-ENG. BLDG. SYSTEM. EXISTING EXTERIOR MAN DOORS AND FRAMES TO BE PAINTED. PREP DOOR/FRAME TO RECEIVE FINISH.
- EXISTING EXTERIOR O.H. DOOR FRAMES TO BE PAINTED. PREP FRAME TO RECEIVE FINISH. REMOVE SPALLING RUSTED AREAS AND REPAIR FRAME PRIOR TO PAINTING. PRIME UNPRIMED SURFACES, V.I.F.


Door/ Opening Key Notes:

- DOOR AND FRAME GLAZING TO BE 1" INSUL. GLASS. MATCH EXISTING WINDOW GLAZING TINT, V.I.F. PROVIDE FULL SET OF WEATHER STRIPPING.
- DOOR TO BE PREPARED FOR FUTURE CARD READER ACCESS. SET AND REINFORCE FRAME FOR FUTURE ELEC. STRIKE W/ CONDUIT PATH INSTALLED IN FRAME.
- PROVIDE OVERSIZED KICK PLATE ON BOTH SIDES OF DOOR. PROVIDE ACTIVE LEAF AND INACTIVE LEAF W/ FLUSH BOLT FLOOR RECEIVER. COORDINATE INSTALLATION IN EXISTING CONC. FLOOR.
- UNDERCUT DOOR 3/4". COORDINATE W/ THRESHOLD AS OCCURS. PROVIDE GALV. DOOR AND FRAME THIS OPENING. PREP FOR PAINT.
- DOOR TO BE REPLACED AS PART OF ALT. #2. COORDINATE HARDWARE LOCATION W/ EXISTING DOOR FRAME TO REMAIN.
- MATCH EXIST. O.H. DOOR WINDOW ELEV./PANEL LOCATION.
- PRE-DRILL STL FRAME AND HEAD FOR WEATHER STRIP INSTALL.
- PROVIDE FRAME ANCHORS FOR MASONRY AND STL STRUCTURE CONNECTION TO PRE-ENG. SUBFRAMING. FILL FRAME CAVITY W/ INSUL. AND SEAL AT EXTERIOR METAL PANEL AND INTERIOR STL SUB FRAME.
- PROVIDE HOLD OPEN ARM ON DOOR CLOSER.
- 14. EXISTING DOOR AND FRAME TO REMAIN. COORDINATE HARDWARE CHANGE W/ EXISTING DOOR/FRAME CONSTRUCTION.

	_ Koom	Finish Schedule								
EY NOTES	ROOM		FLOOR	BASE		WAL	LS		CEILING	
ET NOTES	NO.	ROOM NAME			NORTH	EAST	SOUTH	WEST	FIN.	ROOM FINISH KEY NOTES
	101	FOYER	VCT-	RB-	PNT-	PNT-	PNT-	PNT-	ACT-	1
	102	RECEPTION	CPT-	RB	PNT-	PNT-	PNT-	PNT-	ACT-	1,8
	103	DPS OFFICE	VCT-	RB	PNT-	PNT-	PNT-	PNT-	ACT-	2
	104	CONFERENCE ROOM	VCT-	RB	PNT-	PNT-	PNT-	PNT-	ACT-	2
	105	CORRIDOR	VCT-	RB-	PNT-	PNT-	PNT-	PNT-	ACT-	1,3
	106	UNISEX TOILET	VCT-	RB-	PNT-	PNT-	PNT-	PNT-	ACT-	1,3,4,5
	107	PLAN STORAGE ROOM	VCT-	RB-	PNT-	PNT-	PNT-	PNT	ACT-	3
	108	LUNCH ROOM	VCT-	RB-	PNT-	PNT-	PNT-	PNT	ACT-	1,2,3,6,7,8,9
	109	JAN CLST	QT-	RB-	PNT-	PNT-	PNT-	PNT	ACT-	10
ΓE #2	110	TOILET ROOM	ERT	ETR	ETR	ETR	ETR	ETR	ETR/ALT#3	11
	111	LOCKER ROOM	ERT/QT	ETR/QT	ETR	ETR/PNT	PNT	ETR/PNT	ETR/ALT#3	9, 10,11
	115	BAY AREA	ETR	NR	NA	NA	NA	-PNT-	ETR	12
	116	SECURE STORAGE	ETR	ETR	NA	PNT-	NA	NA	ETR	12
	117	BAY AREA	ETR	NR	NA	NA	PNT-	NA	ETR	12
	119	BAY AREA	ETR	NR	NA	PNT-	PNT-	NA	ETR	12, 8
}	120	BAY AREA	CONC/SEAL	NR	NA	PNT-	PNT-	NA	EXP	13, 14, 8, 15
	121	BAY AREA	CONC/SEAL	NR	PNT	PNT-	NA	NA	EXP	13, 14, 15
	122	BAY AREA	CONC/SEAL	NR	PNT	NA	NA	PNT-	EXP	13, 15, 16
	123	STORAGE	CONC/SEAL	NR	NA	NA	PNT-	PNT-	EXP	13, 15, 16, 17

- THE DEMOLITION OR NEW CONSTRUCTION INSTALLATION. MATCH
- RE TO REMAIN W/ PRIMED FINISH ONLY U.N.O. S TO BE PAINTED WITH THE EXTERIOR COLOR SELECTED TO NEAREST
- GREASE, OIL, DIRT, FINISH MATERIAL ADHESIVES, ETC. FOR
- EXISTING BOLLARDS TO REMAIN.
- RECEIVE NEW PAINTED FINISH, INCLUDING BONDERIZING AGENT
- END PROFILE CAP TRIMS. GUTTERS AND CABLE END TRIMS TO BE
- XTURES. MATCH TILE PATTERN AND COLOR.
- ESS. IF FASTENER HOLE IS GREATER THAN 5/16" REPLACE PENETRATED TILE W/ MATCHING TILE AND GROUT JT. INISH. GRIND FLOOR AS REQ'D.
- G CEILING TILE, GRID, LIGHTS AND DIFFUSERS FOR NEW CEILING LIGHTING AND DIFFUSER INSTALLATION.

PARTNERS

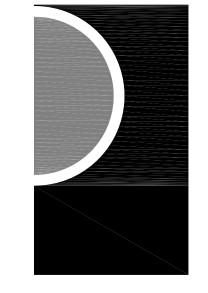

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KEY PLAN

NEW BALTMORE

PROJECT NAME

Department of Public Service **Building Addition**


35389 Cricklewood New Baltimore, MI 48047

PROJECT NO.

13-107

ISSUES / REVISIONS

OWNER REVIEW BIDS/CONSTRUCTION 5/17/2013

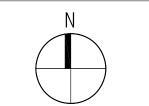


DRAWN BY KJB

CHECKED BY

APPROVED BY

SCHEDULES, FRAME TYPES & WALL TYPES

SHEET NO. A0-03

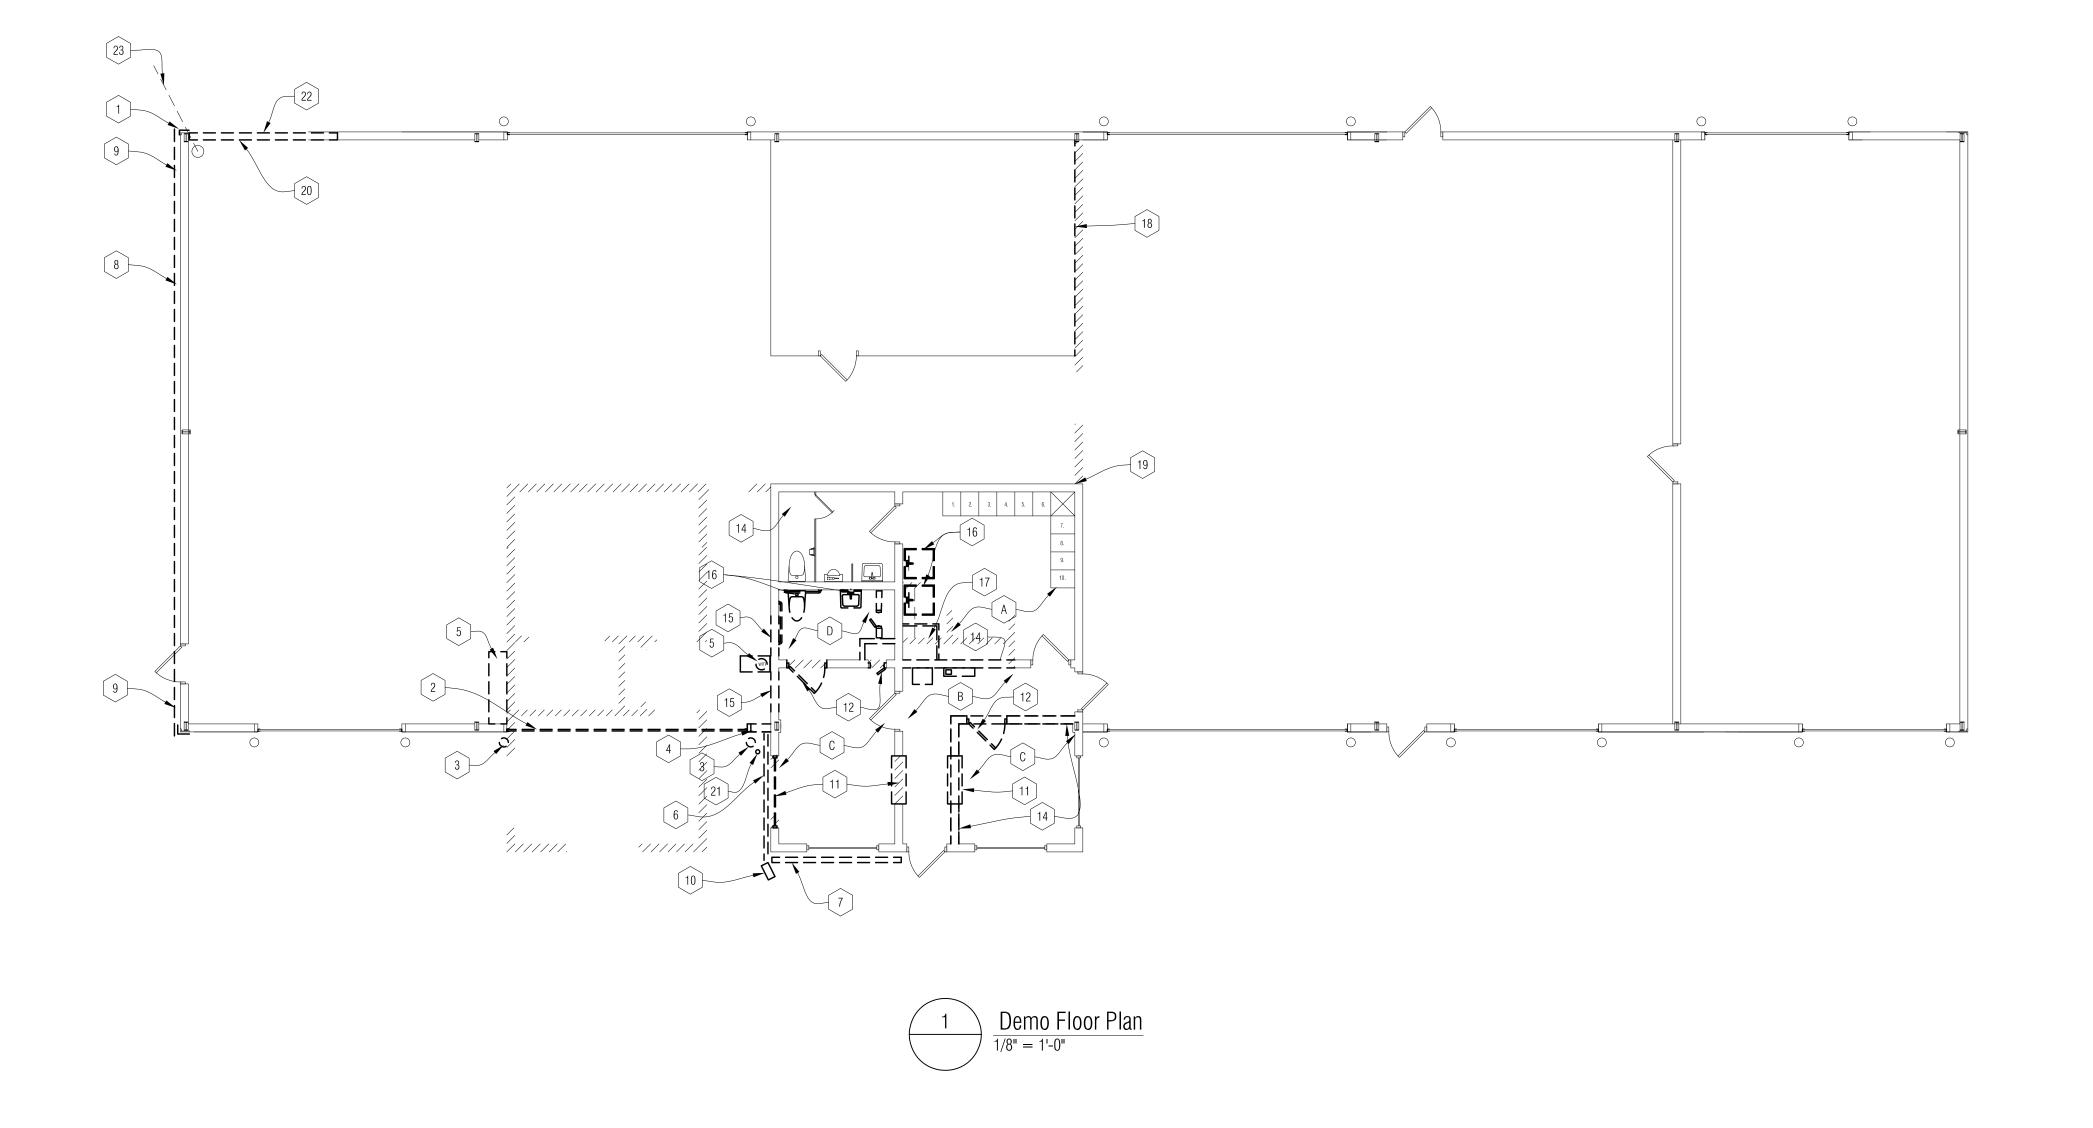

DEMO FLOOR PLAN GENERAL NOTES:


- A. ALL DEMOLITION DRAWINGS AND DEMOLITION DETAILS ARE PROVIDED TO SHOW THE GENERAL SCOPE OF THE DEMOLITION WORK. IT IS THE CONTRACTOR'S RESPONSIBILITY TO PERFORM ALL DEMOLITION WORK NECESSARY TO ACCOMPLISH NEW WORK. THE DEMOLITION DRAWINGS AND DETAILS MAY NOTE TYPICAL ITEMS IN SOME AREAS, WHICH APPLY IN OTHER AREAS (AND ARE DESIGNATED WITH DASHED, HIDDEN OR STRUCK THRU LINES). COORDINATE ALL DEMOLITION WORK WITH ALL ARCHITECTURAL, CIVIL, STRUCT., MECH. AND ELEC. DRAWINGS. CONTRACTOR RESPONSIBLE TO REFERENCE ALL DRAWINGS/ SPECIFICATIONS TO CONFIRM EXTENT OF DEMOLITION WORK.
- B. ALL REMOVED ITEMS, WALLS, FLOORS CEILING, OPENINGS, ETC ARE TO BE PATCHED/REPAIRED AND PREPPED TO RECEIVE NEW WORK AND/OR
- C. WALL REMOVAL THAT TERMINATES INTO A WALL OR CEILING TO REMAIN SHALL BE COMPLETELY REMOVED FREE OF PROJECTIONS, READY TO RECEIVE NEW FINISHES.
- D. DISPOSE OF ALL DEMOLITION MATERIALS LEGALLY OFF-SITE, U.O.N.
- E. CONTRACTOR TO COORD, EXIST, CONC, SLAB REMOVAL THAT IS REQUIRED FOR INSTALLATION OF NEW UNDERGROUND PLUMBING AND DEMOLITION CONTRACTOR.
- F. STRUCTURAL ELEMENTS SHALL NOT BE REMOVED OR MODIFIED UNLESS DIRECTED TO DO SO BY CONSTRUCTION DOCUMENTS - SEE STRUCTURAL.
- G. REFER TO REFLECTED CEILING PLAN SHEETS FOR FURTHER DEMOLITION INFORMATION.
- H. REFER TO NEW WORK PLANS FOR ADDITIONAL DIMENSIONS.
- I. EXISTING FLOOR FINISHES ARE CARPET AND VINYL TILE TO BE REMOVED W/ BASE & MASTIC COMPLETE U.O.N. PREP FLOOR TO RECEIVE NEW
- J. EXISTING GARAGE STRUCTURE IS AN EXISTING PRE-ENGINEERED METAL BUILDING BY BUTLER MANUFACTURING. MODIFICATION AND REMOVAL OF STRUCTURAL ELEMENTS AND CLADDING COMPONENTS SHALL MEET THE REQUIREMENTS AND PROCEDURES OF THE ORIGINAL MANUFACTURER.
- K. REFER TO CIVIL, MECHANICAL, AND ELECTRICAL DRAWINGS FOR ADDITIONAL DEMOLITION WORK.

DEMO FLOOR PLAN KEY NOTES:

- 1 EXISTING EXTERIOR MASONRY COLUMN COVERS TO BE REMOVED AT LOWER SILL WALL INCLUDING GROUT AND ANCHORS FOR REPLACEMENT.
- 2 | EXISTING OVER HEAD DOOR , TRACK, LIFT MECHANISM, AND OPERATION CONTROLS TO BE REMOVED COMPLETE INCLUDING METAL PANEL SIDING AND TRIM CLOSURES. TURN DOOR PANELS AND LIFT MOTOR OVER TO OWNER.
- 3 EXISTING STEEL PIPE BOLLARD TO BE REMOVED.
- 4 EXISTING MASONRY SILL WALL AND METAL PANEL SIDING TO BE REMOVED FOR NEW CONSTRUCTION. COORDINATE PANEL REMOVAL HEIGHT WITH NEW WORK PLAN.
- [5] EXISTING WATER METER AND CONC FLOOR REMOVAL FOR RELOCATION OF WATER METER. REFER TO MECHANICAL.
- 6 EXISTING METAL CLAD FASCIA AND OVERHANG W/ SOFFIT TO BE REMOVED INCLUDING ROOF MODIFICATION FOR NEW ADDITION CONSTRUCTION.
- 7 EXISTING GUTTER AND FASCIA TO BE MODIFIED FOR EXTENSION / TRANSITION TO NEW CONSTRUCTION.
- 8 EXISTING METAL PANEL PANEL GABLE END TRIM TO BE REMOVED FOR NEW ROOF / METAL PANEL INSTALLATION.
- 9 EXISTING ELECTRICAL FIXTURE TO BE REMOVED AND RELOCATED . REFER TO ELECTRICAL .
- 10 EXISTING SECURITY CAMERA TO BE REMOVED AND REINSTALLED.
- [11] EXIST WINDOW, EXTERIOR STONE SILL AND INTERIOR SILL TO BE REMOVED FOR NEW CONSTRUCTION, INCLUDING APPLIED WOOD JAMB
- 12 EXISTING DOOR AND FRAME TO BE REMOVED COMPLETE INCLUDING TOOTHED MASONRY FOR INFILL MATCHING EXISTING MASONRY
- 13 EXISTING EWC TO BE REMOVED AND TURNED OVER TO OWNER.

COORDINATE WITH ELECTRICAL .

- [14] EXISTING BLOCK MASONRY WALL CONSTRUCTION TO BE REMOVED TO UNDERSIDE OF STRUCTURE ABOVE.
- 15 EXISTING MASONRY TO BE REMOVED FOR NEW DOOR OPENING, INCLUDING AREA FOR PRECAST LINTEL INSTALLATION.
- 16 EXISTING PLUMBING FIXTURES AND PIPING TO BE REMOVED. REFE TO MECHANICAL.
- 17 EXISTING PREFAB SHOWER UNIT TO BE REMOVED COMPLETE INCLUDING
- QUARRY TILE BASE. 18 EXISTING CHAIN LINK FENCE WITH POST AND CONNECTION BRACKETS
- TO BE REMOVED COMPLETE. 19 EXISTING PLYWOOD FRAMING CLOSURE AT EXISTING DECK FRAMING TO BE REMOVED , MODIFIED AND REINSTALLED FOR NEW MASONRY
- WALL CONSTRUCTION. 20 EXISTING 4'-0" HIGH MASONRY BLOCK SILL WALL TO BE REMOVED TO FLOOR LINE FOR WALL REPAIR. REFER TO NEW WORK PLAN. REMOVE EXISTING METAL PANEL CONNECTION ANGLE AND INSULATED VAPOR RETARDER AS REQUIRED TO COMPLETE REPAIRS.
- 21 EXISTING ANTENA TO BE REMOVED AND RELOCATED. COORDINATE DISCONNECTION AND REINSTALLATION REQUIREMENTS WITH OWNER.
- 22 PROVIDE TEMPORARY SUPPORT FOR ELEC. CONDUIT AT MASONRY REPAIR. REMOVE AND REINSTALL AS REQ'D.
- 23 EXIST. UNDERGROUND ELEC. FEED TO OUT BUILDING TO REMAIN. PROTECT DURING DEMOLITION AND COVER.

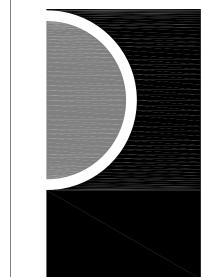

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NEW BALTMORE

PROJECT NAME


Department of Public Service **Building Addition**

35389 Cricklewood New Baltimore, MI 48047

PROJECT NO.

13-107

ISSUES / REVISIONS OWNER REVIEW

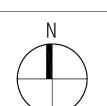

BIDS/CONSTRUCTION 5/17/2013


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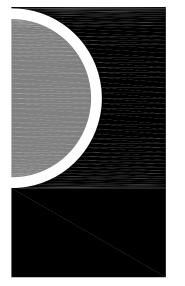
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APPROVED BY

SHEET NAME DEMO FLOOR PLAN

SHEET NO. A1-01



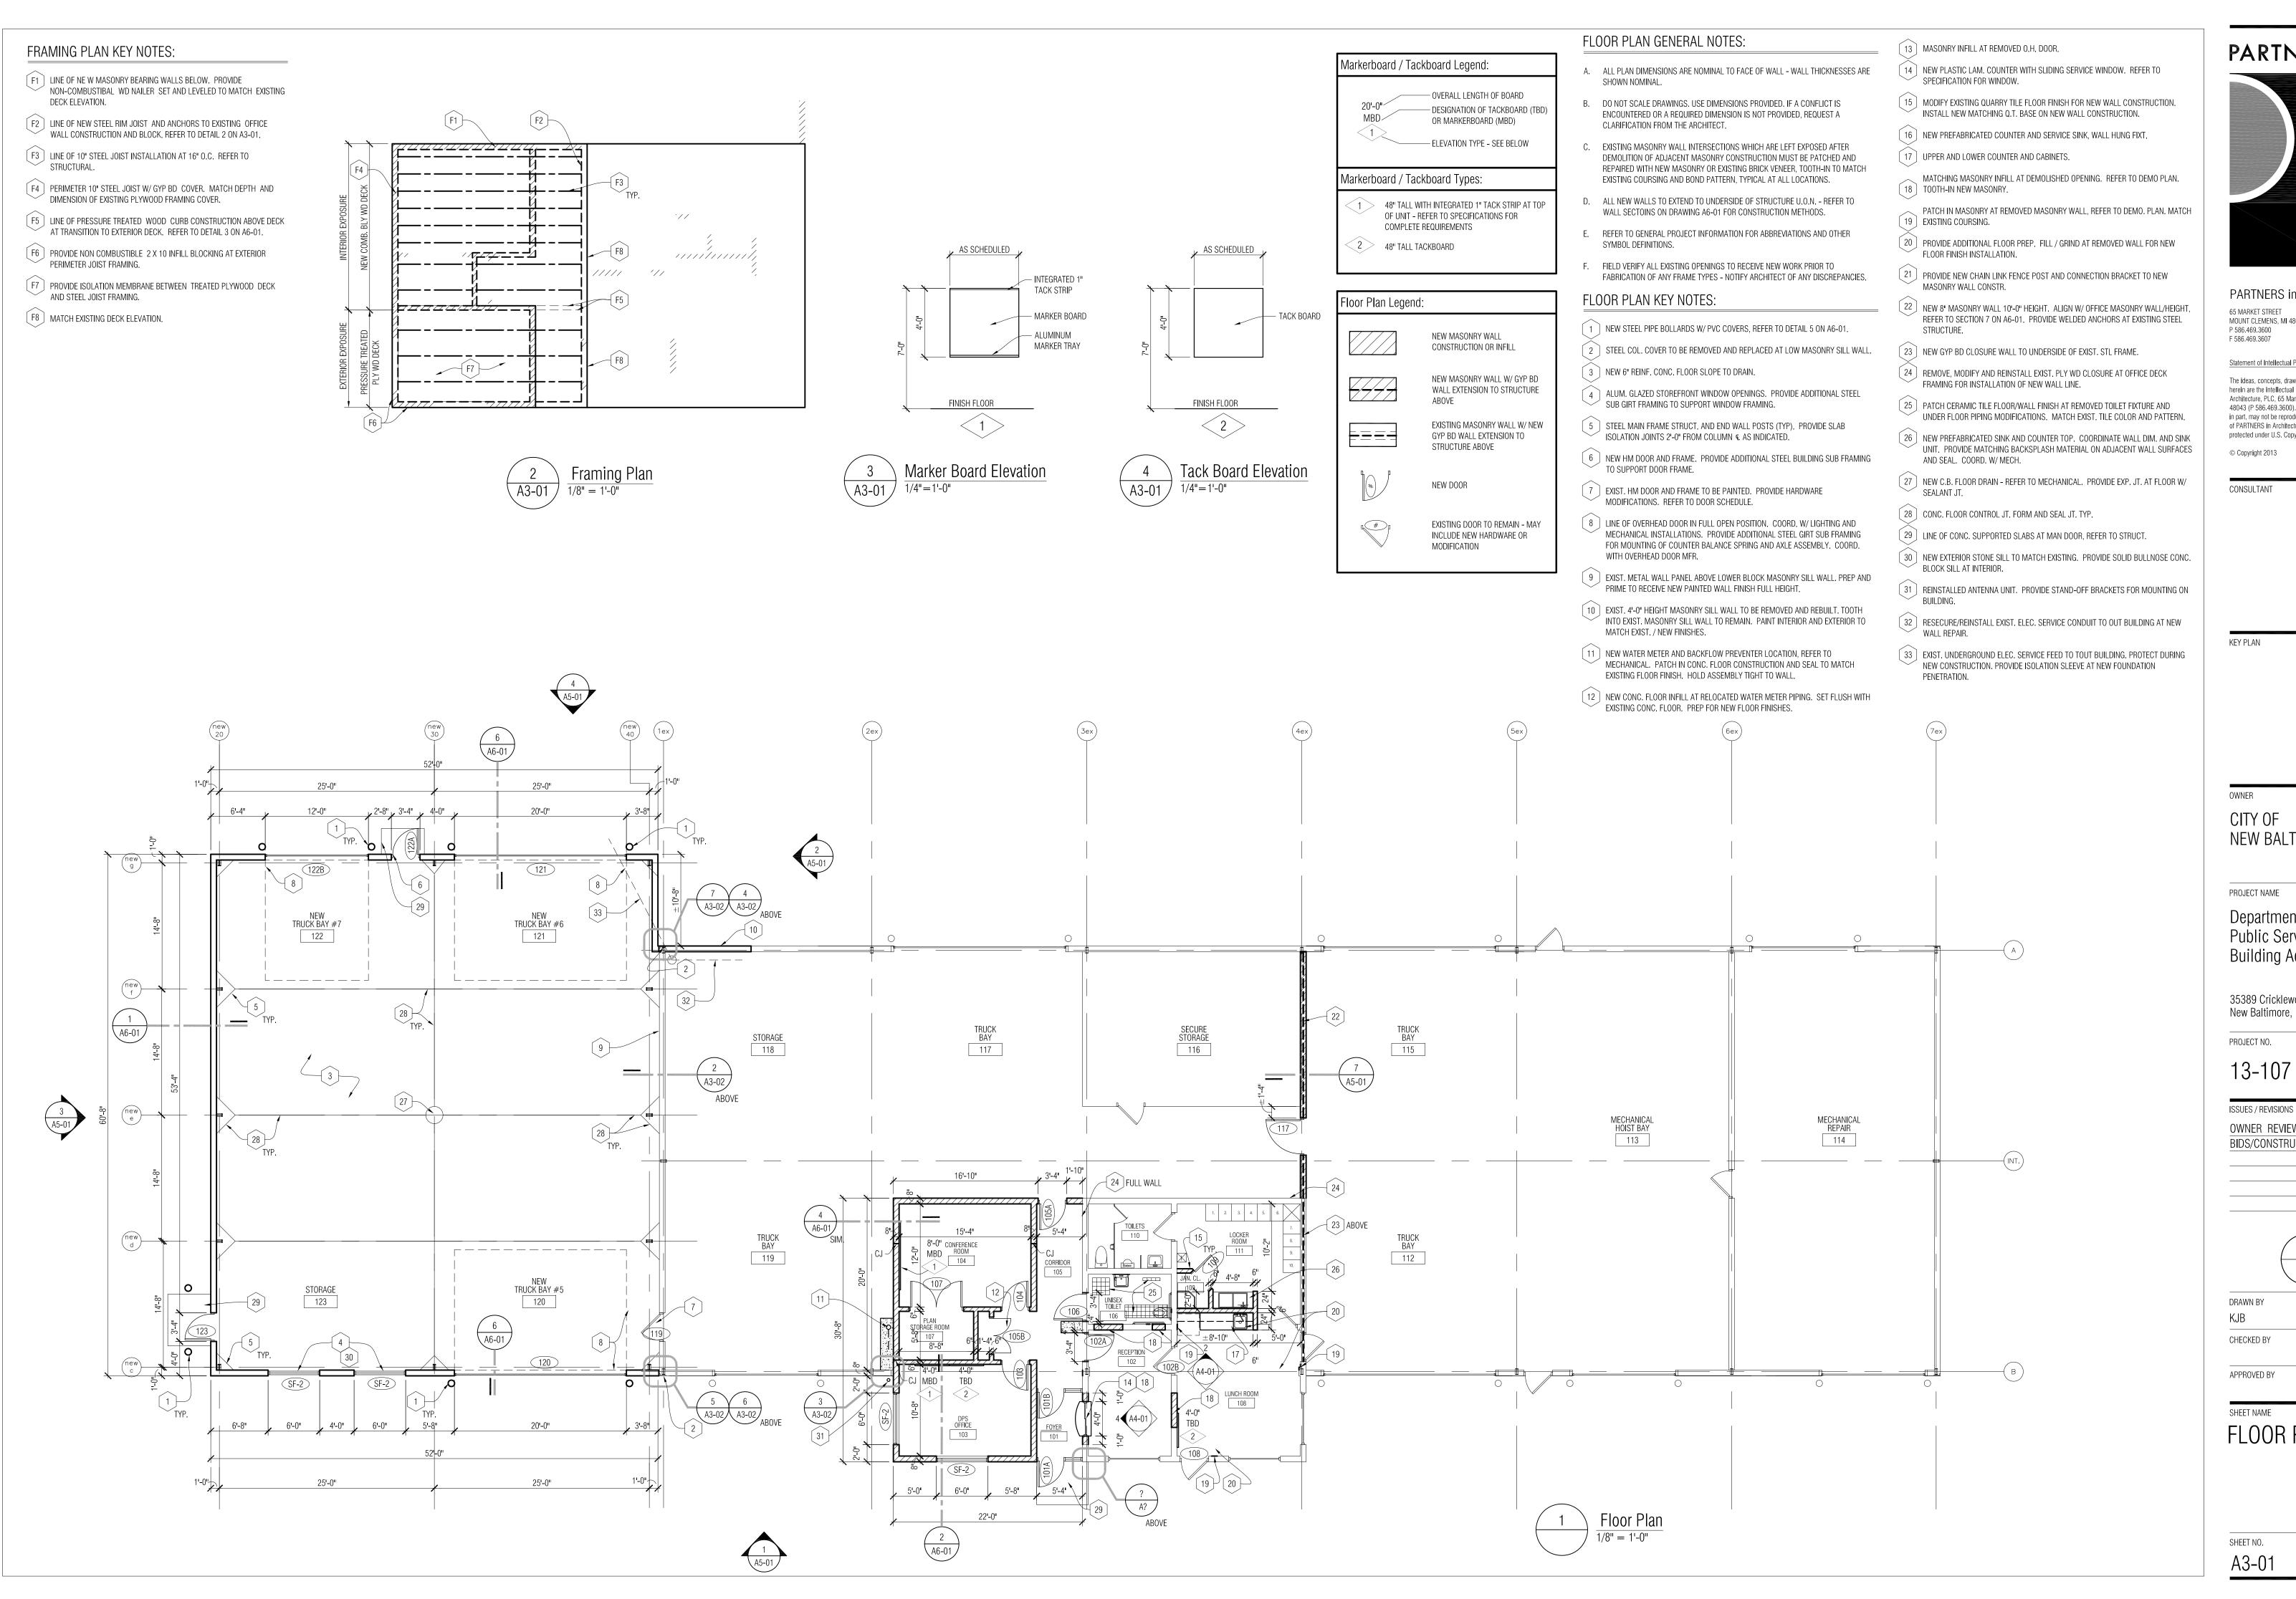

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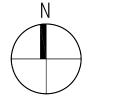
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NEW BALTMORE


Department of Public Service **Building Addition**


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FLOOR PLAN





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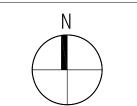
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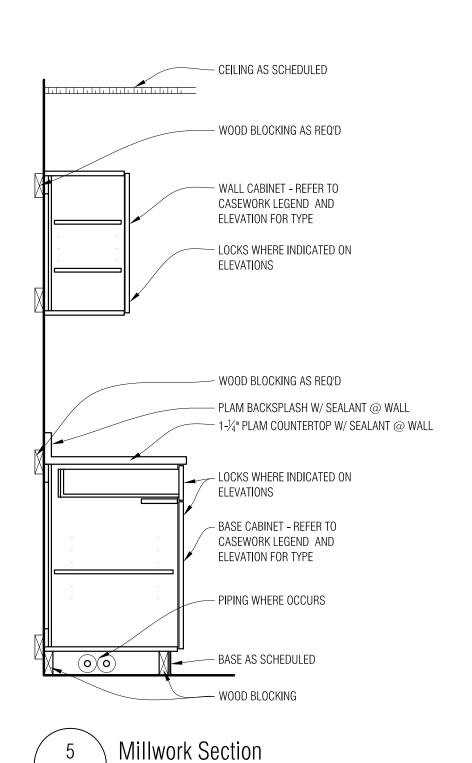
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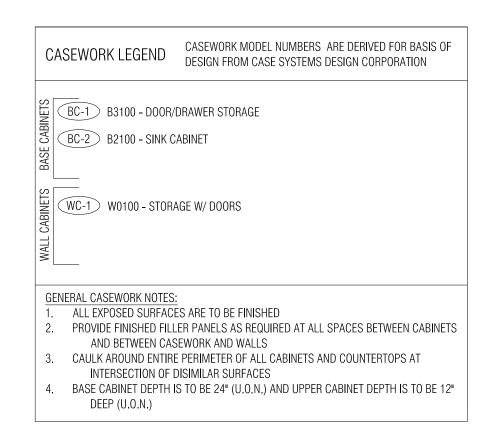
SHEET NAME Roof Plan

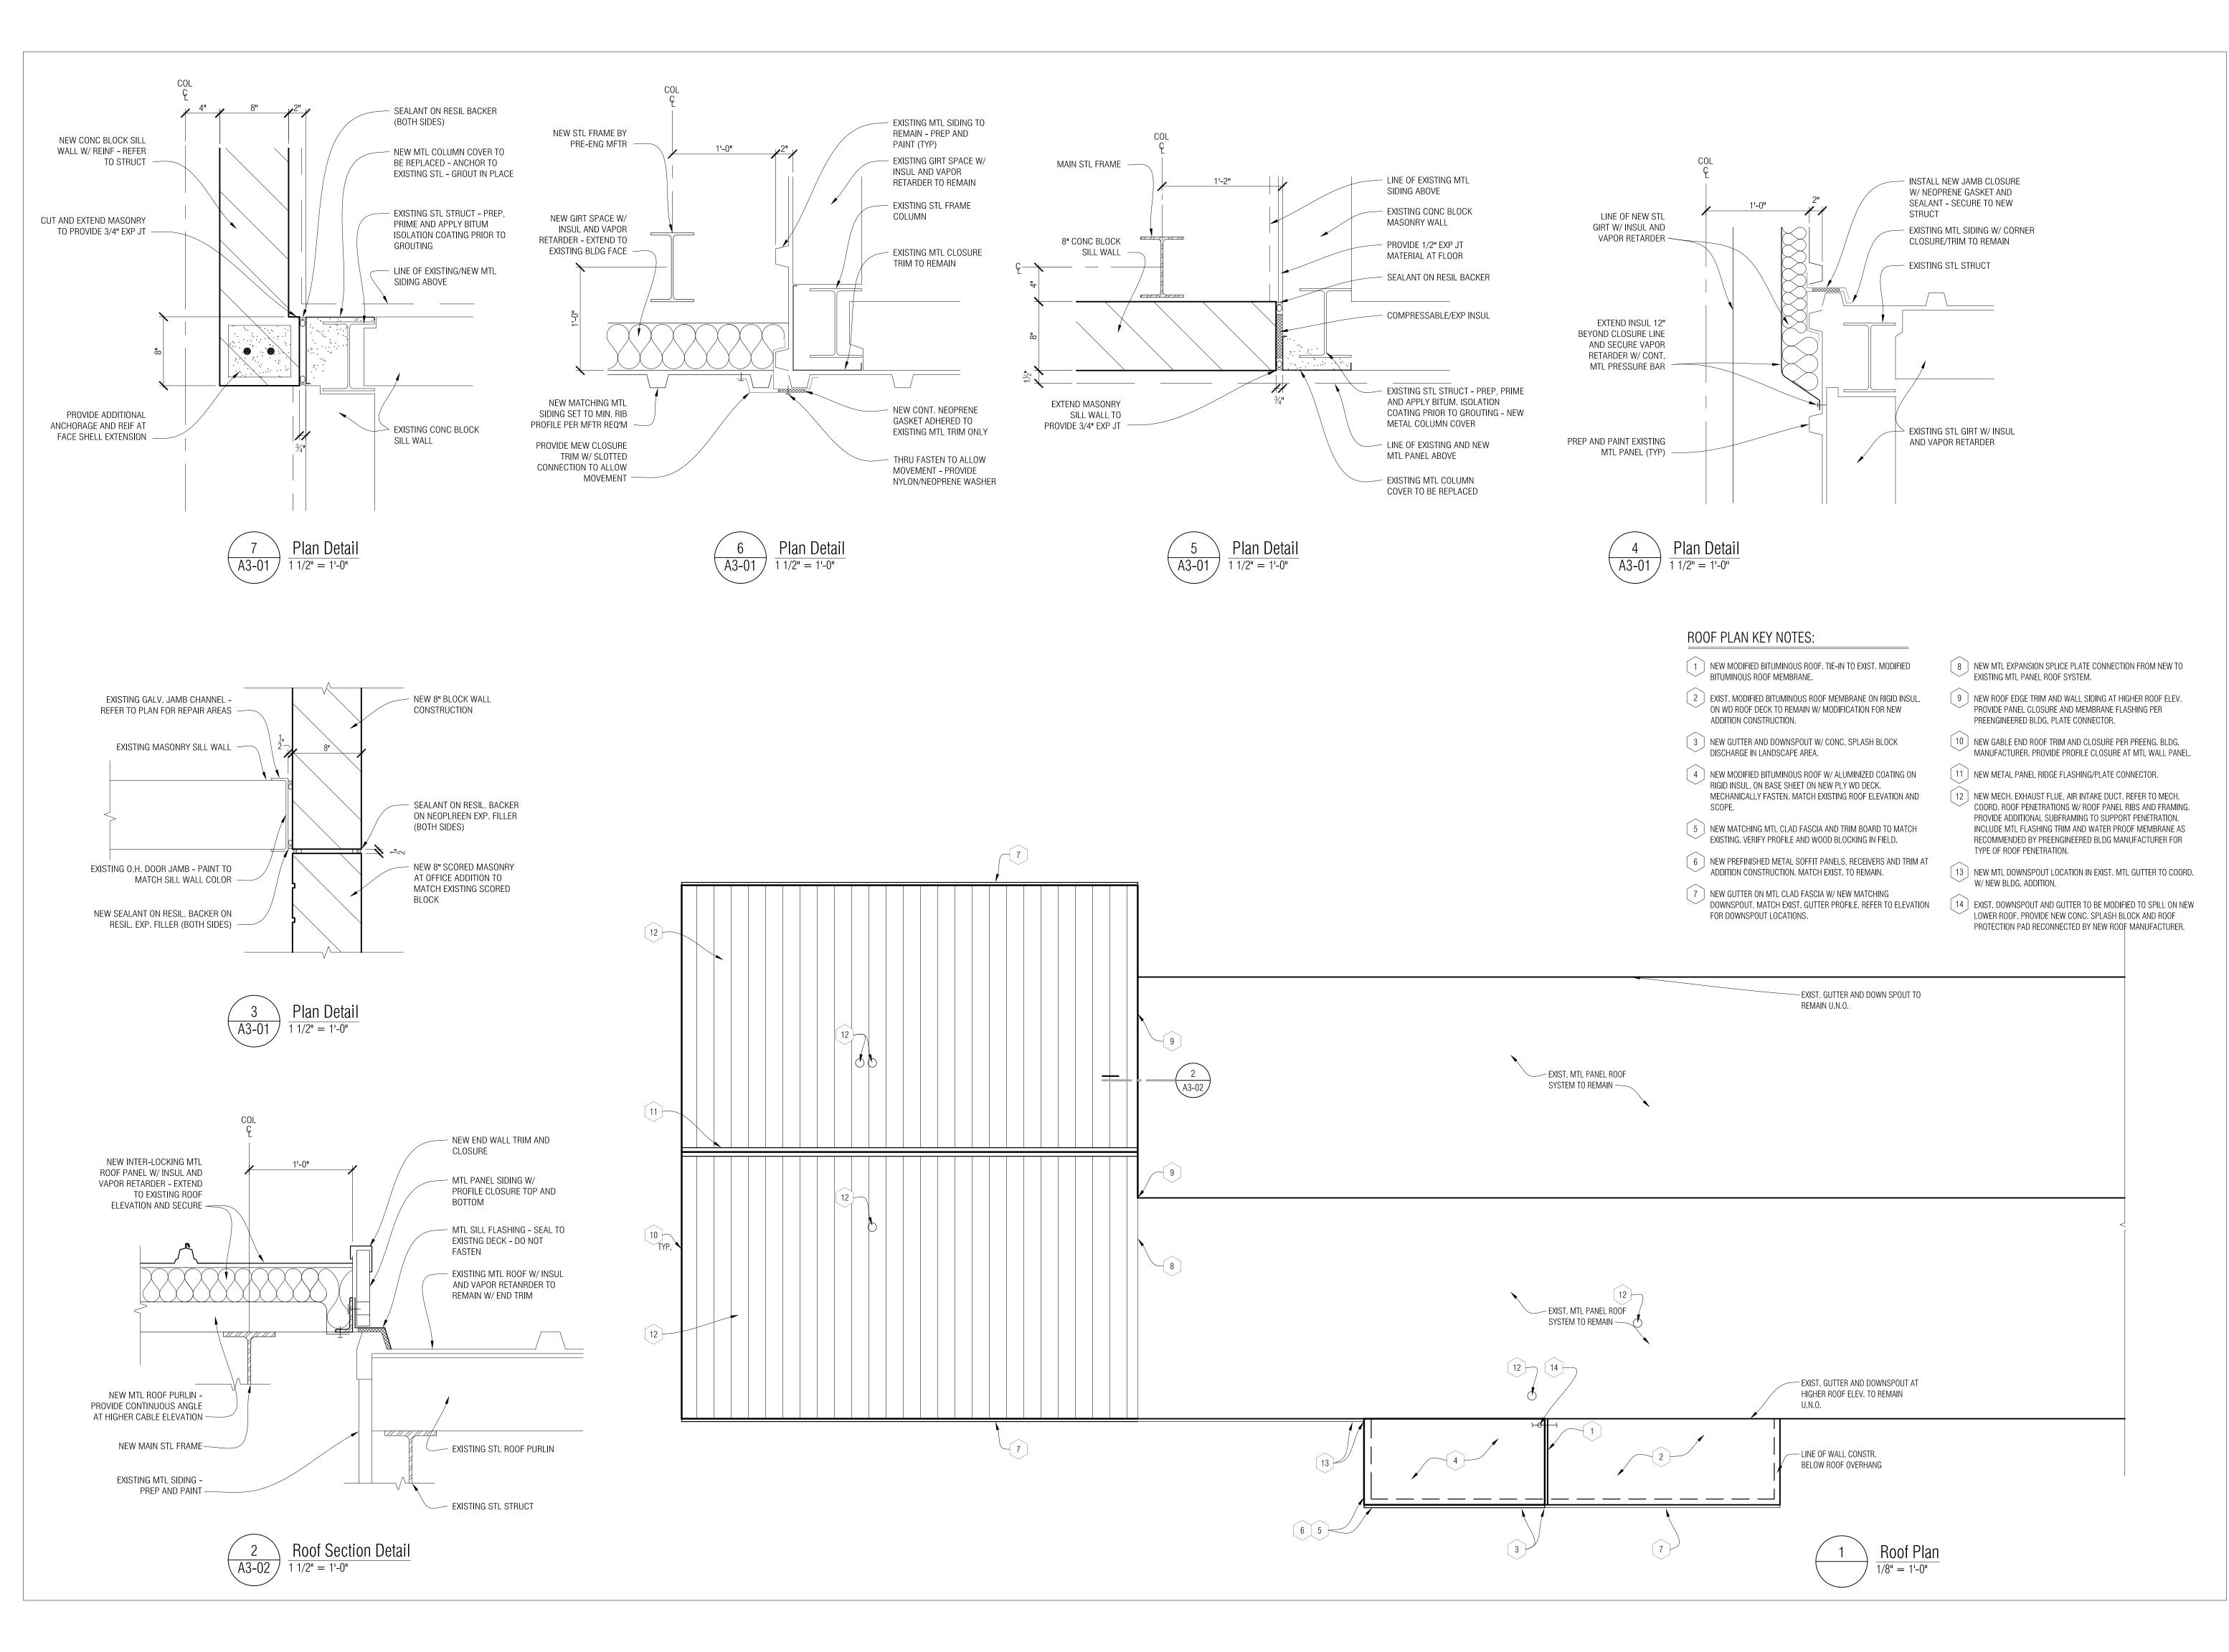
SHEET NO.

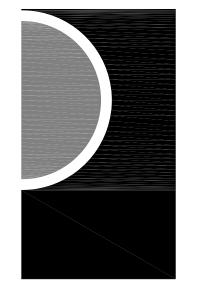A3-02




A4-01 3/4" = 1'-0"



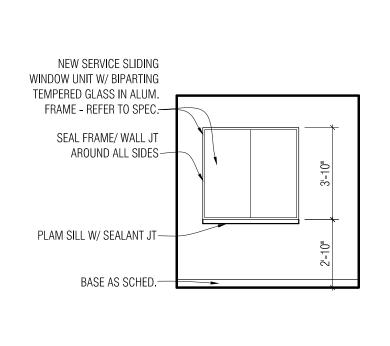


Interior Elevation


A4-01 1/4" = 1'-0"

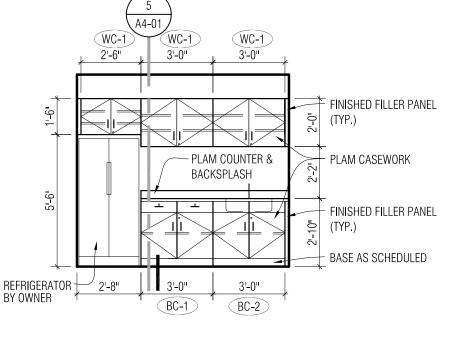

Interior Elevation

1/4" = 1'-0"

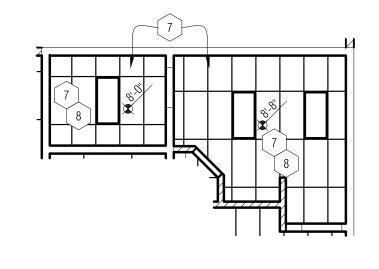

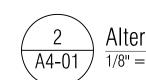

Reflected Ceiling Plan $\frac{1}{8} = 1-0$


Alternate Reflected Ceiling Plan A4-01 $\frac{1}{1/8"} = 1'-0"$

REFLECTED CEILING PLAN GENERAL NOTES:


- A. REFER TO FLOOR PLANS FOR ROOM NAMES, NUMBERS AND ROOM
- B. REFER TO ELECTRICAL FOR LIGHT FIXTURE TYPES AND SPECIFICATIONS
- C. REFER TO MECHANICAL FOR DIFFUSERS, REGISTERS, AND RETURNS
- D. ALL LIGHT FIXTURES ARE TO BE CENTERED WITHIN CEILING TILE AND GYP SOFFIT U.O.N.
- E. CEILING GRID IS TO BE TYPICALLY CENTERED IN ROOM U.O.N.
- F. ACOUSTIC CEILING INSTALLAITON IS TO MATCH REMOVED CEILING ELEVATION U.O.N.

REFLECTED CEILING PLAN KEY NOTES:

- 1 MODIFY EXISTING CEILING GRID AS REQUIRED TO ACCOMODATE NEW CONSTRUCTION.
- [2] EXISTING CEILING GRID TO REMAIN.
- MECHANICAL EQUIPMENT REFER TO MECH.
- 4 MOTOR FOR OVERHEAD DOORS REFER TO ELEC.
- [5] LINE OF O.H. DOOR TRACK. FOLLOW SLOPE OF ROOF FRAMING. PROVIDE ADDITIONAL BRACKETS FOR MOUNTING TO STEEL ROOF
- 6 CENTER LINE OF NEW MAIN STL FRAME. PROVIDE/COORD. INSUL. AND VAPOR RETARDER INSTALLATION AT STL COL. AND FRAME.
- [7] COORD. NEW CEILING GRID HANGERS AND EXIST. MECH.. DUCT RELOCATIONS W/ EXIST. WOOD FRAME DECK.
- 8 RELOCATE EXIST. MECH. AIR SUPPLY AND RETURN REGISTERS INTO NEW CEILING GRID. COORD. W/ MECH.

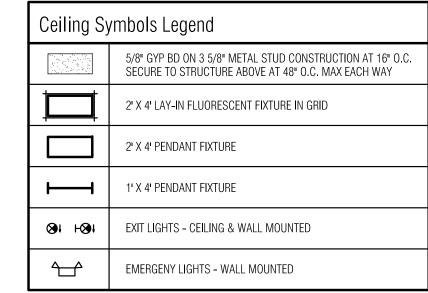

DIMENSIONS

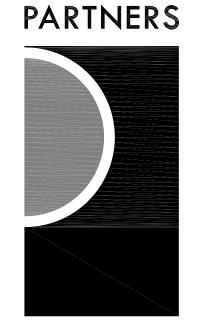

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NEW BALTMORE

PROJECT NAME

Department of Public Service **Building Addition**


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13-107

ISSUES / REVISIONS

OWNER REVIEW BIDS/CONSTRUCTION 5/17/2013




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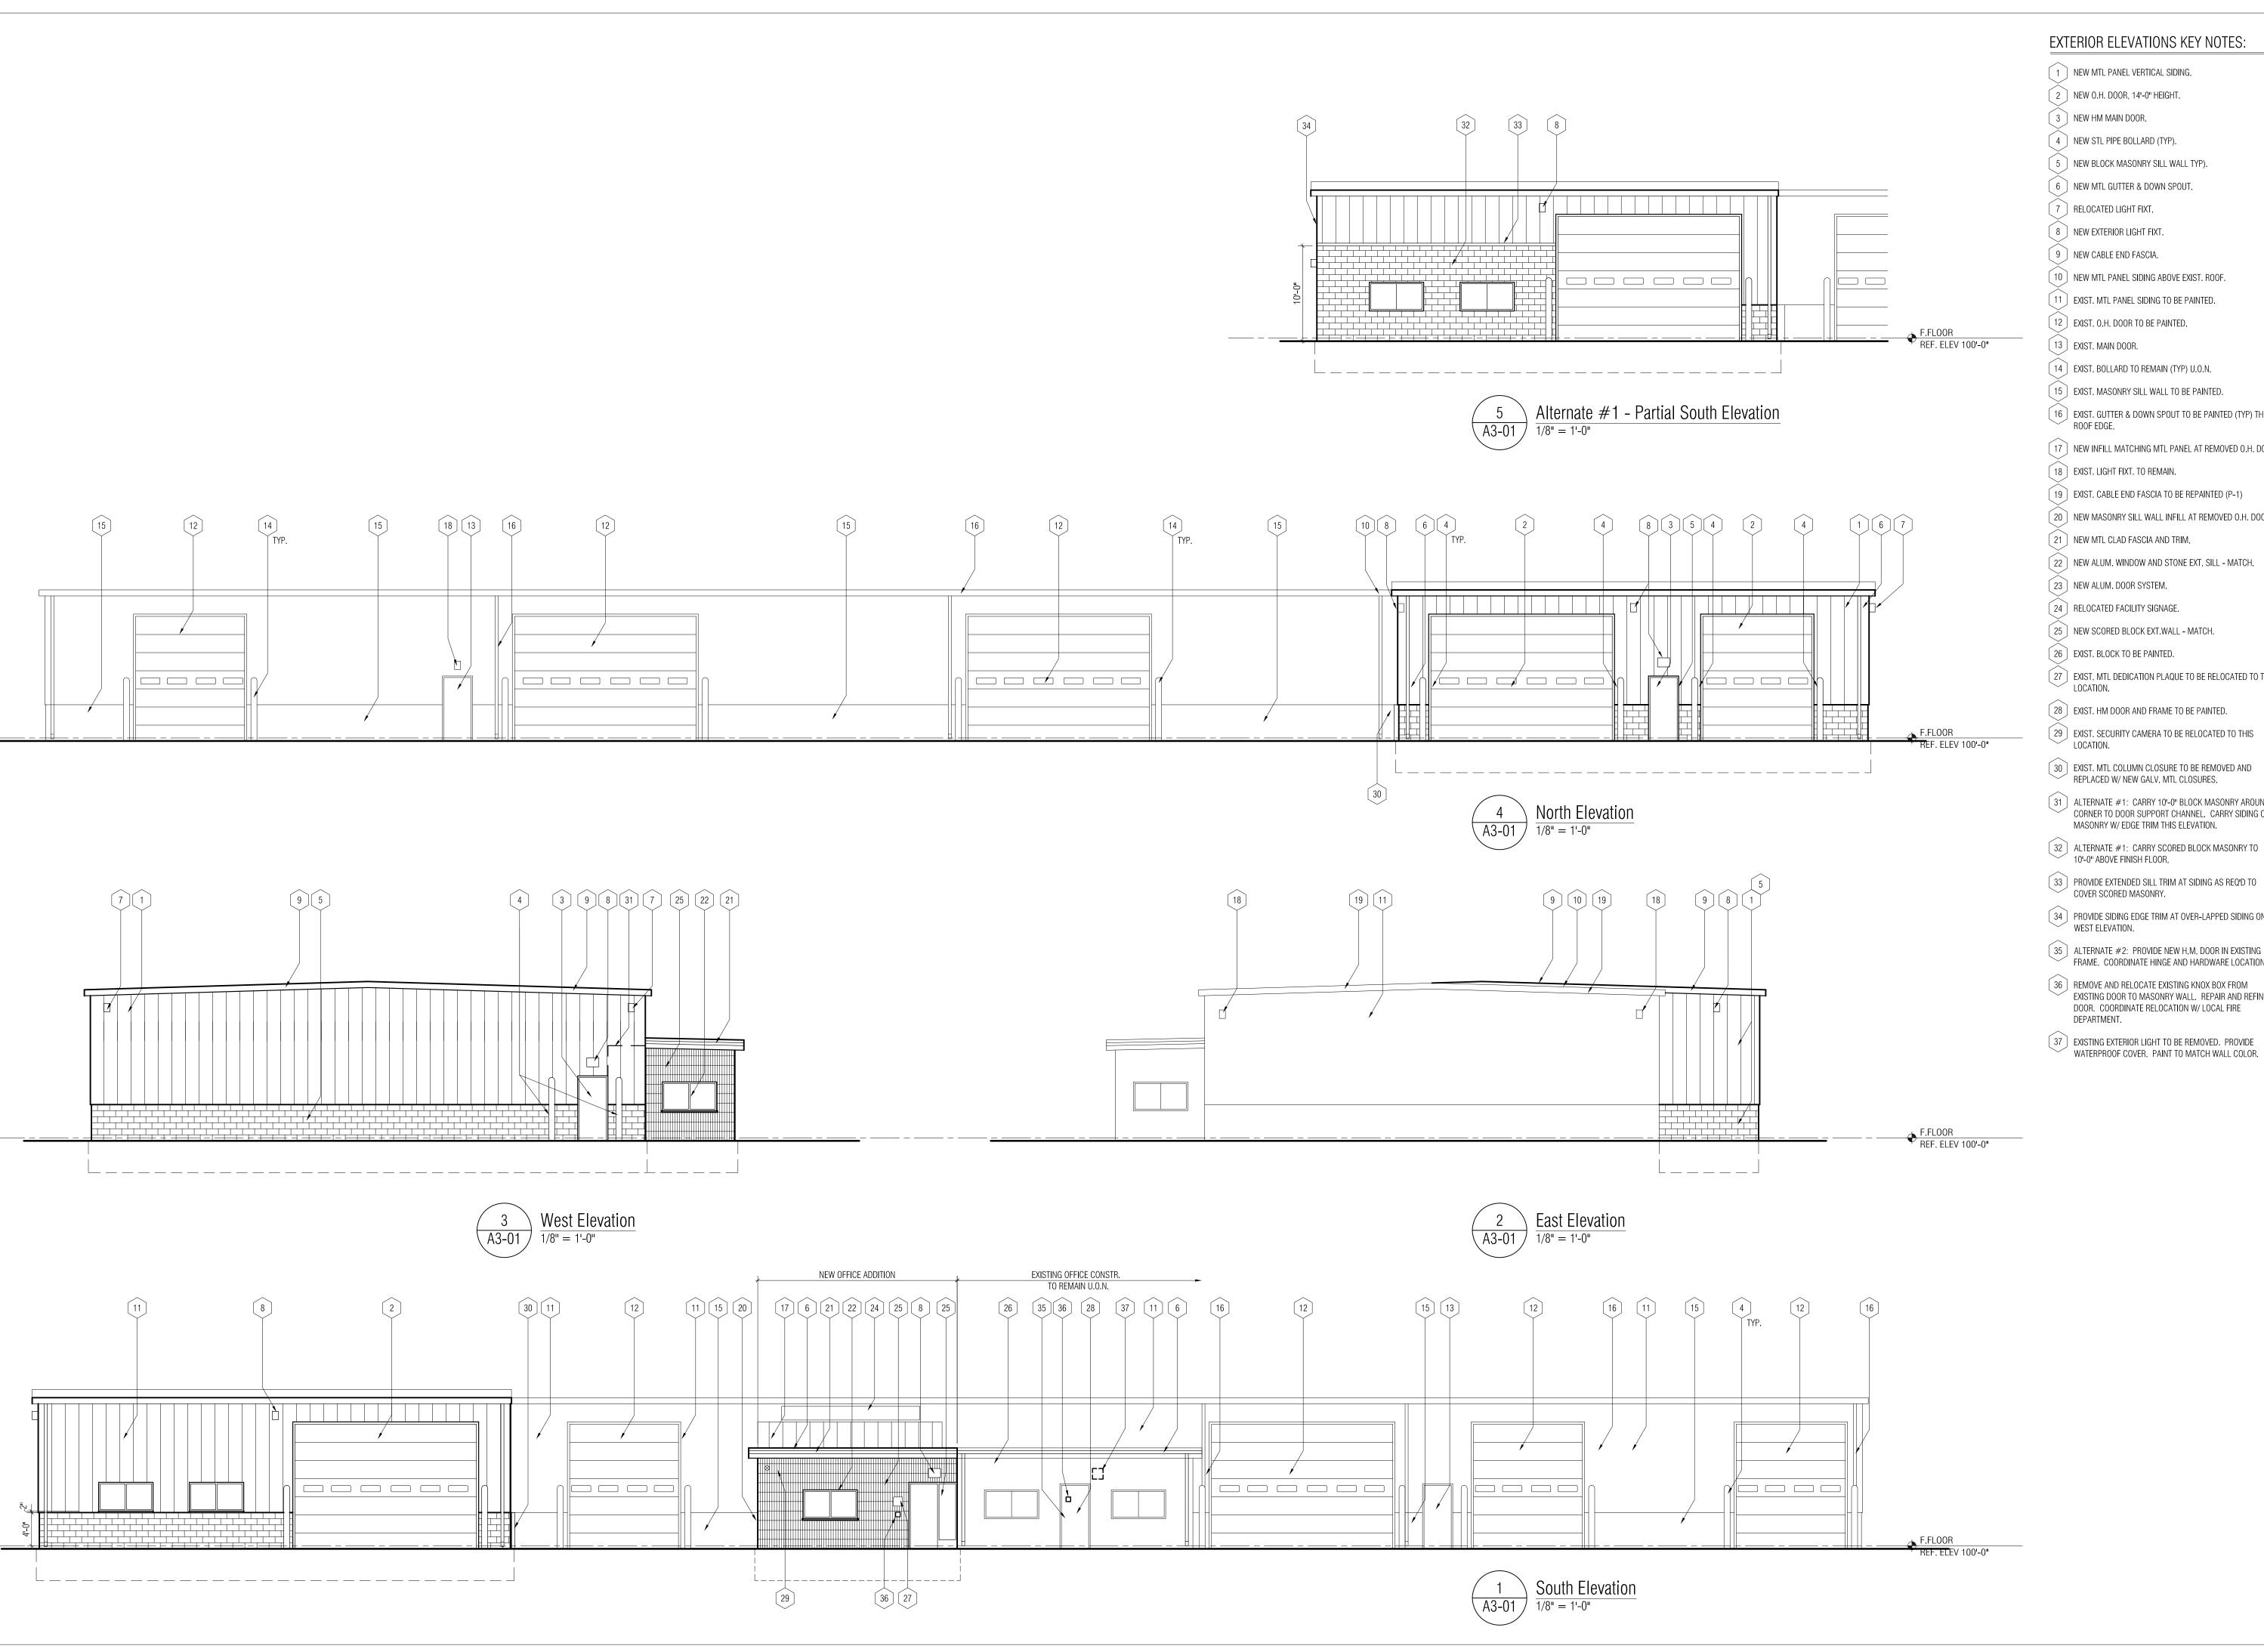
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SHEET NAME REFLECTED CEILING PLAN

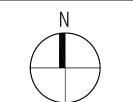SHEET NO. A4-01






EXTERIOR ELEVATIONS KEY NOTES:

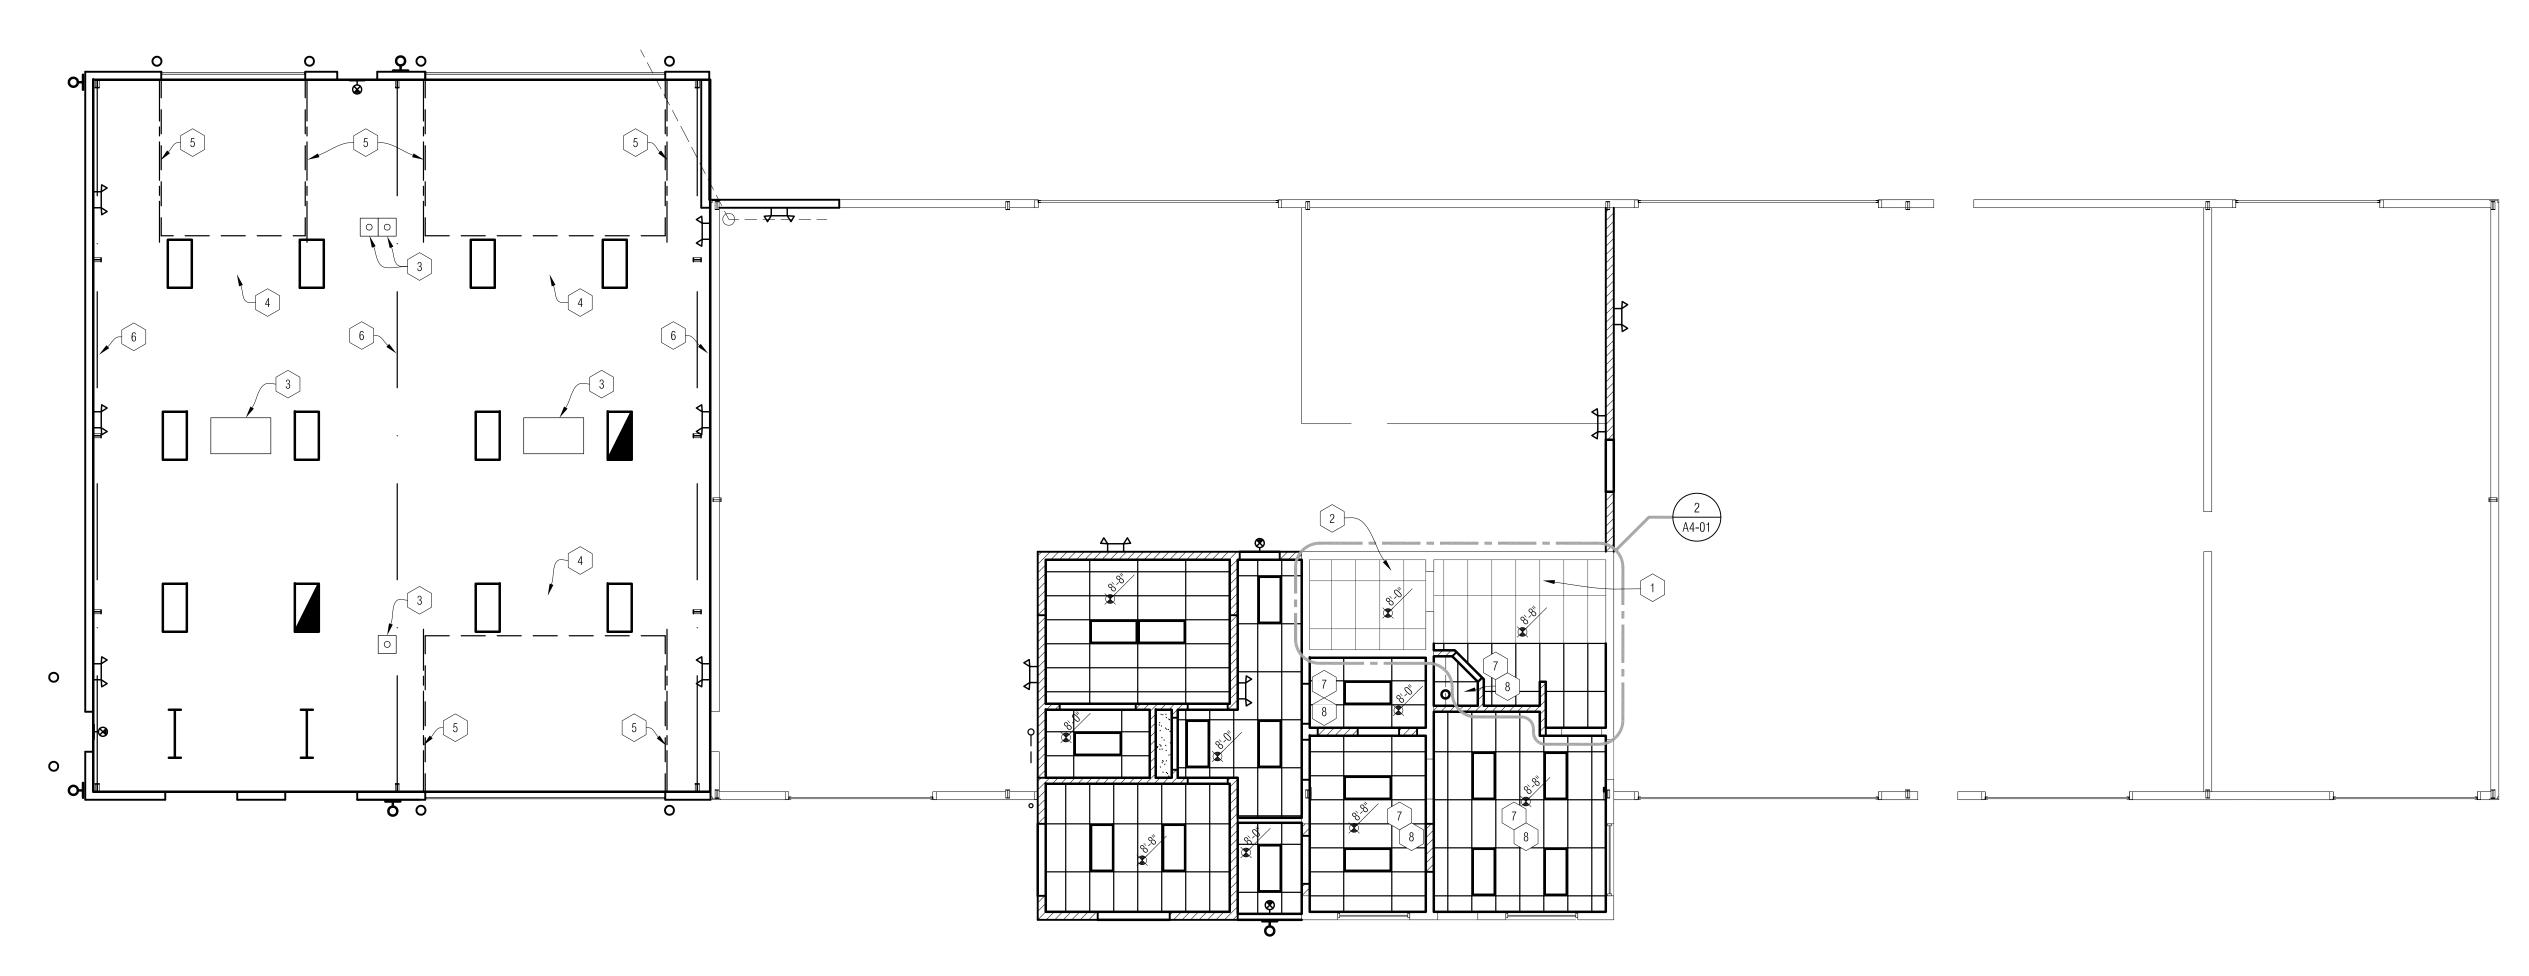- 1 NEW MTL PANEL VERTICAL SIDING.
- 2 NEW O.H. DOOR, 14'-0" HEIGHT.
- 3 NEW HM MAIN DOOR.
- 4 NEW STL PIPE BOLLARD (TYP).
- 5 NEW BLOCK MASONRY SILL WALL TYP).
- 6 NEW MTL GUTTER & DOWN SPOUT.
- 7 RELOCATED LIGHT FIXT.
- 8 NEW EXTERIOR LIGHT FIXT.
- 9 NEW CABLE END FASCIA.
- 10 NEW MTL PANEL SIDING ABOVE EXIST. ROOF.
- 11 EXIST. MTL PANEL SIDING TO BE PAINTED.
- [12] EXIST. O.H. DOOR TO BE PAINTED.
- 13 EXIST. MAIN DOOR.
- [14] EXIST. BOLLARD TO REMAIN (TYP) U.O.N.
- 15 EXIST. MASONRY SILL WALL TO BE PAINTED.
- [16] EXIST. GUTTER & DOWN SPOUT TO BE PAINTED (TYP) THIS
- 17 NEW INFILL MATCHING MTL PANEL AT REMOVED O.H. DOOR.
- 18 EXIST. LIGHT FIXT. TO REMAIN.
- [19] EXIST. CABLE END FASCIA TO BE REPAINTED (P-1)
- 20 NEW MASONRY SILL WALL INFILL AT REMOVED O.H. DOOR.
- 21 NEW MTL CLAD FASCIA AND TRIM.
- 22 NEW ALUM. WINDOW AND STONE EXT. SILL MATCH.

- [27] EXIST. MTL DEDICATION PLAQUE TO BE RELOCATED TO THIS
- LOCATION.
- [28] EXIST. HM DOOR AND FRAME TO BE PAINTED.
- [29] EXIST. SECURITY CAMERA TO BE RELOCATED TO THIS
- 30 EXIST. MTL COLUMN CLOSURE TO BE REMOVED AND REPLACED W/ NEW GALV. MTL CLOSURES.
- [31] ALTERNATE #1: CARRY 10'-0" BLOCK MASONRY AROUND CORNER TO DOOR SUPPORT CHANNEL. CARRY SIDING OVER MASONRY W/ EDGE TRIM THIS ELEVATION.
- 32 ALTERNATE #1: CARRY SCORED BLOCK MASONRY TO 10'-0" ABOVE FINISH FLOOR.
- 33 PROVIDE EXTENDED SILL TRIM AT SIDING AS REQ'D TO COVER SCORED MASONRY.
- 34 PROVIDE SIDING EDGE TRIM AT OVER-LAPPED SIDING ON
- ALTERNATE #2: PROVIDE NEW H.M. DOOR IN EXISTING FRAME. COORDINATE HINGE AND HARDWARE LOCATION. (36) REMOVE AND RELOCATE EXISTING KNOX BOX FROM
- EXISTING DOOR TO MASONRY WALL. REPAIR AND REFINISH DOOR. COORDINATE RELOCATION W/ LOCAL FIRE DEPARTMENT.

PARTNERS

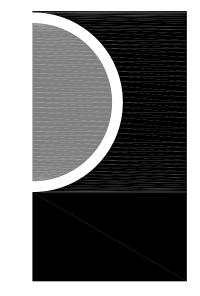

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KEY PLAN

CITY OF NEW BALTMORE

PROJECT NAME

Department of Public Service **Building Addition**


35389 Cricklewood New Baltimore, MI 48047

PROJECT NO.

13-107

ISSUES / REVISIONS

OWNER REVIEW BIDS/CONSTRUCTION 5/17/2013

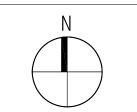

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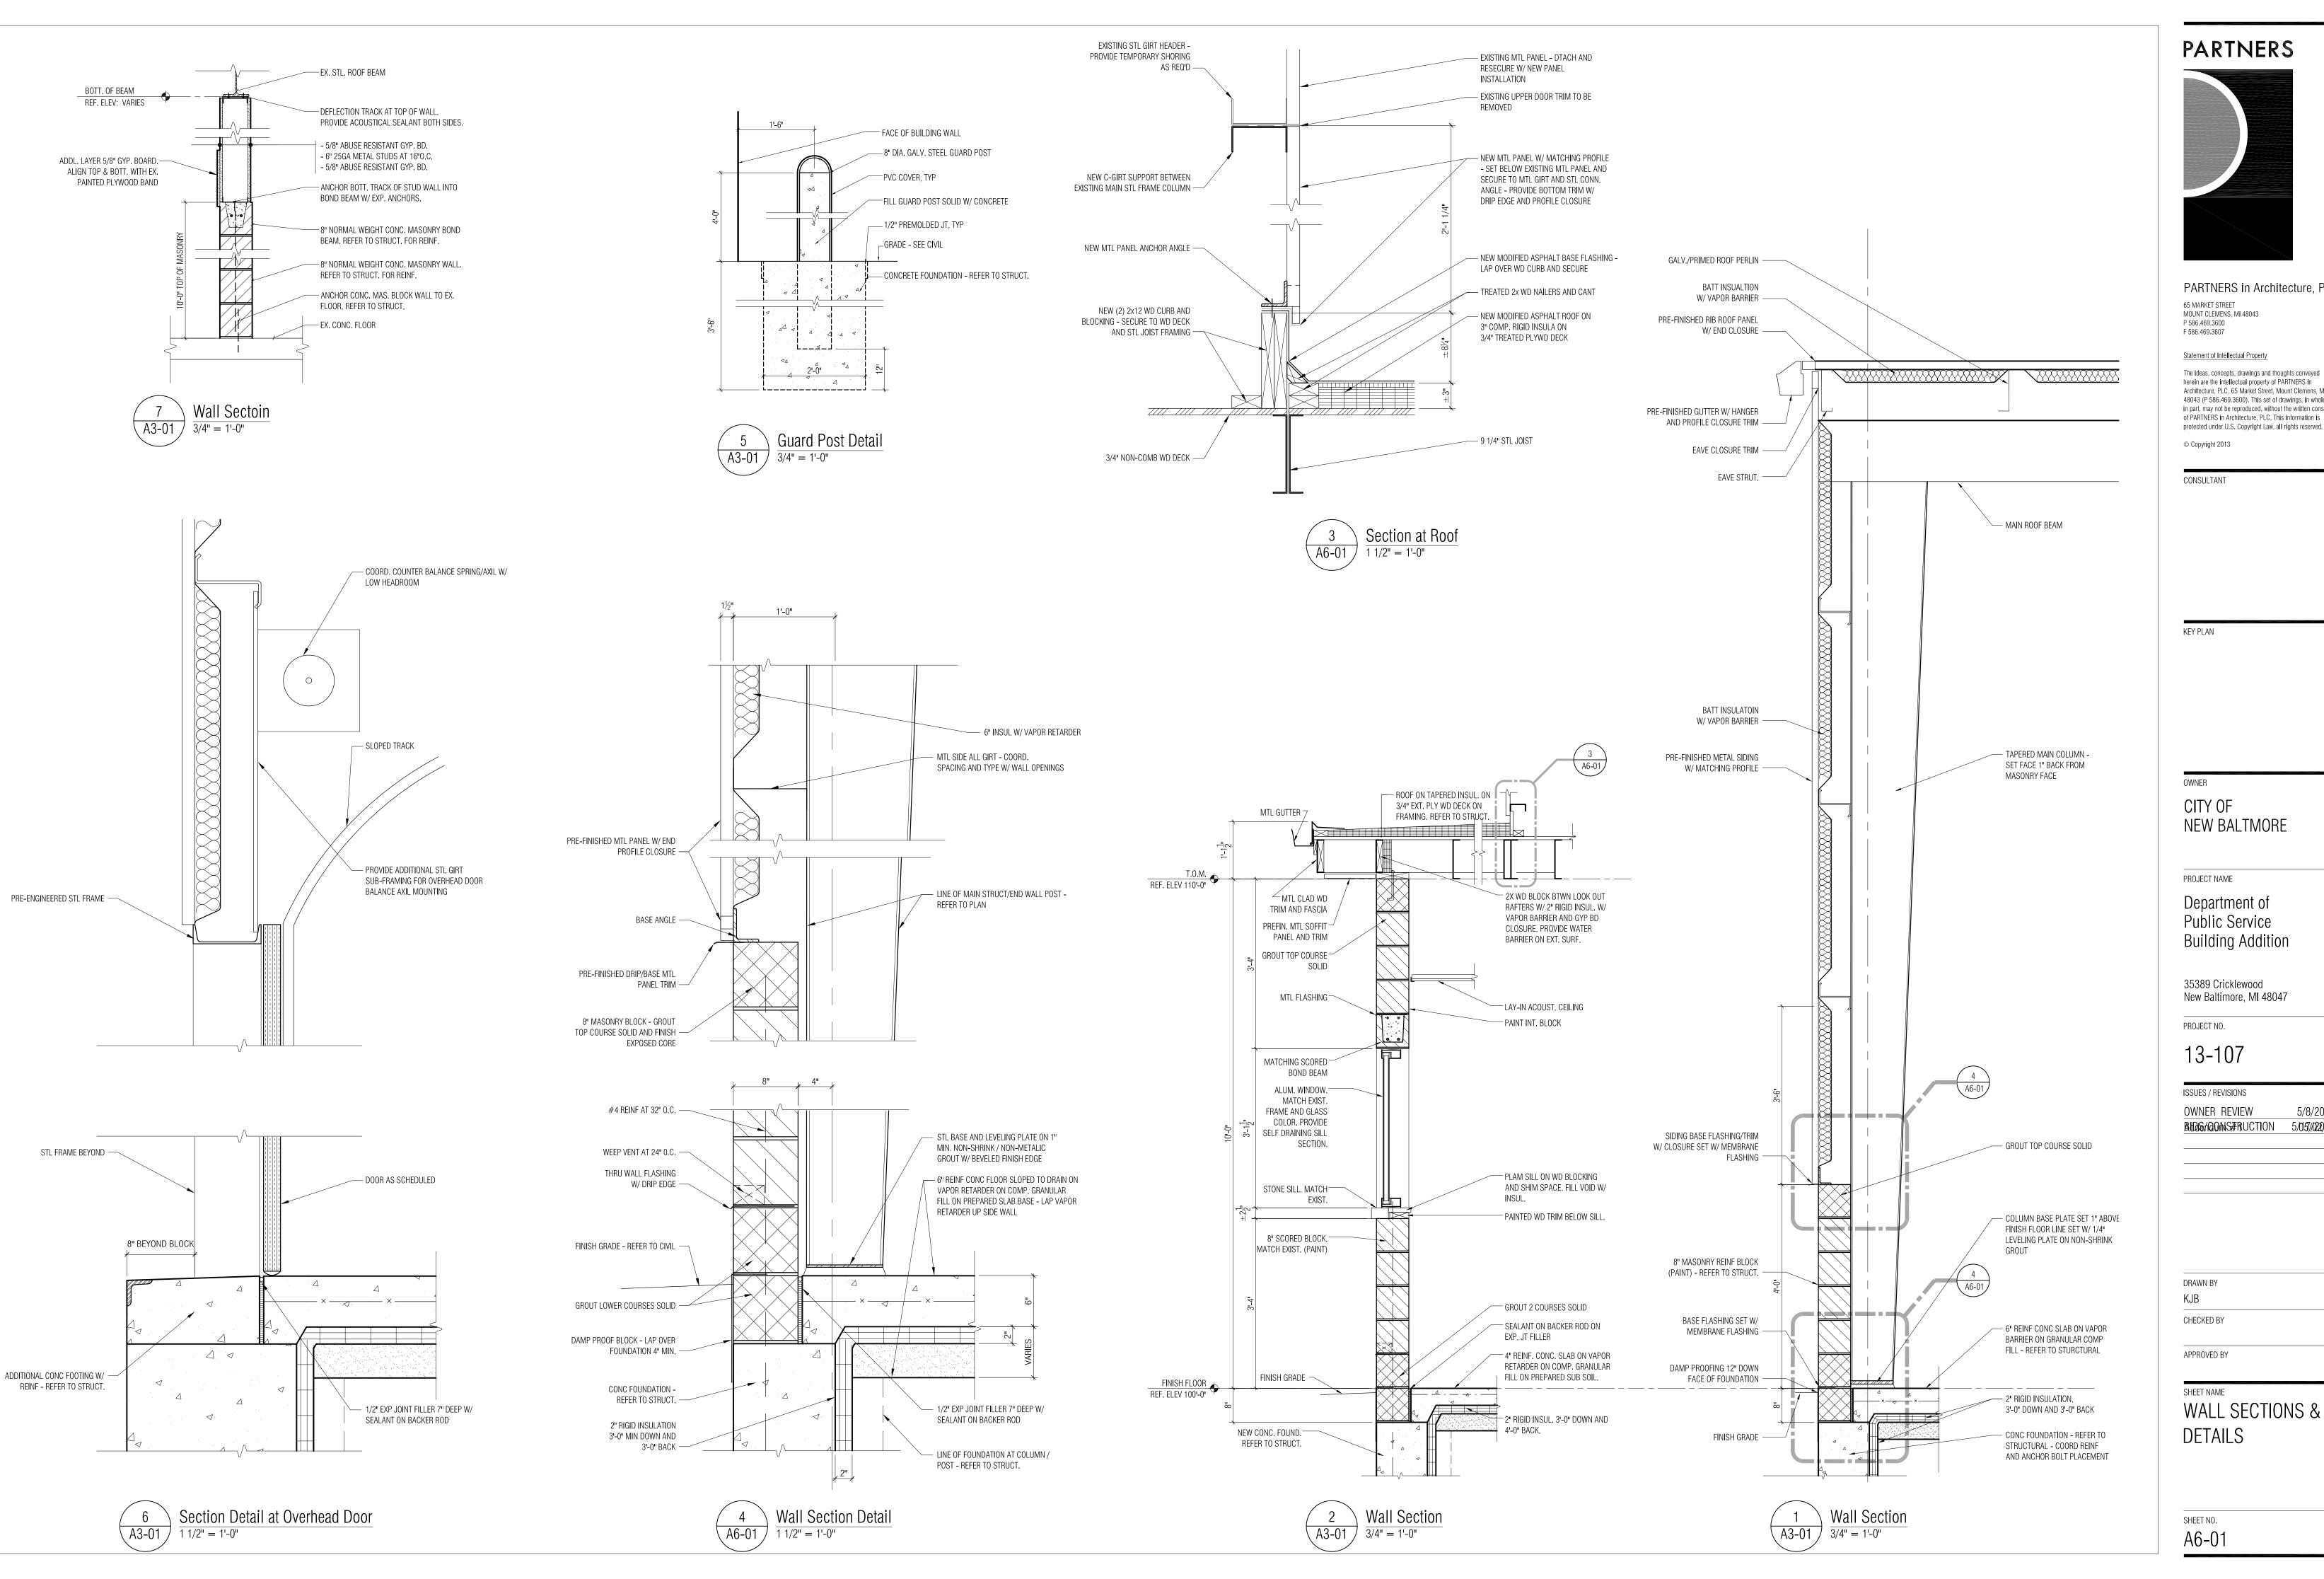
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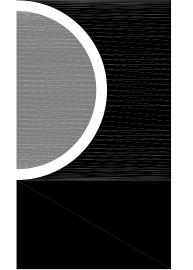
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SHEET NAME **EXTERIOR ELEVATIONS**

SHEET NO.

A5-01





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KEY PLAN

NEW BALTMORE

PROJECT NAME

Department of Public Service **Building Addition**

35389 Cricklewood New Baltimore, MI 48047

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13-107

ISSUES / REVISIONS

OWNER REVIEW BLOS/GONS#RUCTION 5/05/1020/13

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WALL SECTIONS & DETAILS

SHEET NO. A6-01