	LUMINAIRE	SCHEDULE	
FIXTURE MARK	DESCRIPTION	MANUFACTURER(S)	LAMP DESCRIPTION
HA	DECORATIVE TRAPEZOID WALL MOUNTED LIGHT FIXTURE WITH MEDIUM THROW DISTRIBUTION. DARK BRONZE TEXTURED FINISH. UL LISTED FOR WET LOCATIONS. PROVIDE PULSE START ELECTRONIC BALLAST, MVOLT OPERATION, <10%THD. PROVIDE WITH COLD WEATHER BALLAST CAPABLE OF 0° STARTING TEMPERATURE.	1. LITHONIA WST SERIES 2. WIDE-LITE AWS1 SERIES 3. LUMARK IP SERIES 4. GARDCO 101 SERIES	(2) F42TRT/SP35/RS
HAE	SHALL BE SAME AS TYPE 'HA' EXCEPT PROVIDE WITH EMERGENCY BATTERY PACK FOR EMERGENCY OPERATION.		
HB	POLE MOUNT SITE FIXTURE WITH ALUMINUM RECTANGULAR HOUSING AND STANDARD DARK BRONZE FINISH. PROVIDE WITH TYPE IV WIDE FORWARD THROW DISTRIBUTION. PROVIDE WITH MVOLT PULSE START BALLAST. POLE SHALL BE SQUARE 22' IN LENGTH WITH 9" ARM MOUNTING. REFER TO DETAILS FOR CONCRETE POLE BASE DETAILS.	1. LITHONIA KSF2 SERIES	(1) 320W PS MH
(HB3)	SHALL BE SAME AS TYPE 'HB' EXCEPT PROVIDE WITH TYPE III DISTRIBUTION.	1. LITHONIA KSF2 SERIES	(1) 320W PS MH
HC	EXTERIOR CANOPY LUMINAIRE WITH DROP PRISMATIC LENS. DARK BRONZE TEXTURED FINISH. MVOLT OPERATION. UL LISTED FOR WET LOCATIONS. PROVIDE PULSE START ELECTRONIC BALLAST.	1. LITHONIA KACM SERIES	(1) 150W PS MH
X	EXIT LIGHT SHALL BE MOUNT AS REQUIRED TYPE WITH WHITE THERMOPLASTIC HOUSING, HIGH OUTPUT LED DIFFUSE LIGHT PANEL, SINGLE STENCIL WHITE FACE, RED LETTERS AND DIRECTIONAL CHEVRONS TO MATCH EXISTING. FIXTURE SHALL HAVE SELF—DIAGNOSTICS AND BE SUITABLE FOR DUAL VOLTAGE OPERATION. UNIT SHALL BE COMPLETELY SELF—CONTAINED WITH MAINTENANCE FREE NICAD BATTERY CAPABLE OF PROVIDING 90 MINUTE FULL LIGHT OPERATION. PROVIDE LARGER BATTERY FOR EXTERIOR EGRESS LIGHTING IN LOCATIONS AS INDICATED ON PLANS.	1. LITHONIA LQM 2. LIGHTOLIER LL SERIES 3. SURE-LITES LPX SERIES 4. MCPHILBEN VE SERIES	HIGH OUTPUT LED LIGHT PANEL
X2	SHALL BE SAME AS TYPE 'X' EXCEPT WITH DOUBLE FACE	 LITHONIA LQM LIGHTOLIER LL SERIES SURE-LITES LPX SERIES MCPHILBEN VE SERIES 	HIGH OUTPUT LED LIGHT PANEL
XE	REMOTE HEAD FOR EXTERIOR EGRESS LIGHTING. CONNECT TO LOCAL EXIT SIGNAGE AS INDICATED.	1. LITHONIA ELA	PAR 36
EM	REMOTE MOUNT EMERGENCY PAR36 STYLE LAMP HEAD. BATTERY SHALL BE MOUNTED WITHIN CONDITIONED SPACE ABOVE CEILING. UNIT SHALL BE CAPABLE OF FULL LUMEN OUTPUT FOR 90 MINUTES UPON LOSS OF POWER.	1. LITHONIA ELM SERIES 2. LIGHTOLIER E3 SERIES 3. SURE-LITES CC8 SERIES 4. MCPHILBEN VT SERIES	12V 20W HALOGEN

LUMINAIRE SCHEDULE GENERAL NOTES

- 1. REFER TO ELECTRICAL BOOK SPECIFICATIONS FOR MORE INFORMATION. 2. ALL LIGHT FIXTURES SHALL BE UL LABELED.
- 3. FIRST MANUFACTURER LISTED IS BASIS OF DESIGN. OTHER MANUFACTURERS LISTED ARE
- APPROVED MANUFACTURERS. 4. ELECTRICAL TRADES SHALL PROVIDE COMPLETE SUBMITTALS (SHOP DRAWINGS) ON ALL LIGHT FIXTURES, LAMPS, CONTROLS AND ACCESSORIES, ETC. REFER TO SPECIFICATION FOR SUBMITTAL FORMAT AND PROCESS. NO EXCEPTIONS ALLOWED. NON-COMPLETE OR INCORRECT FORMAT WILL RESULT IN BACK CHARGES TO CONTRACTOR AND NOT APPROVED SUBMITTALS.
- 5. ALL LUMINARIES AND CONTROLS SHALL COMPLY WITH THE MICHIGAN UNIFORM ENERGY CODE AND ASHRAE 90.1. REFER TO THE BOOK SPECIFICATIONS AND DRAWINGS FOR MORE INFORMATION ON LIGHTING CONTROLS.

LI	GHTING SYMBOL LIST
SYMBOL	DESCRIPTION
	FLUORESCENT LIGHT FIXTURE
	FLUORESCENT NIGHT LIGHT FIXTURE
	FLUORESCENT EMERGENCY LIGHT FIXTURE
⊢ T ⊣	WALL MOUNTED FLUORESCENT LIGHT FIXTURE
0	DOWNLIGHT
ô	DOWNLIGHT WALL WASH FIXTURE
	WALL SCONCE LIGHT FIXTURE
-	SURFACE MOUNTED LIGHT FIXTURE
오	INTERIOR WALL MOUNTED LIGHT FIXTURE
∇ ∇	TRACK AND TRACK MOUNTED LIGHT FIXTURES
⊗	CEILING MOUNTED EXIT LIGHT — ARROWS AS INDICATED ON PLAN (SHADED AREA INDICATES FACE(S) OF FIXTURE)
9	WALL MOUNTED EXIT LIGHT — ARROWS AS INDICATED ON PLAN (SHADED AREA INDICATES FACE(S) OF FIXTURE)
4	EMERGENCY BATTERY UNIT
4\\ \(\sigma\)	COMBINATION EMERGENCY BATTERY UNIT/EXIT SIGN
•-	EXTERIOR POLE MOUNTED LIGHT FIXTURE
	EXTERIOR WALL MOUNTED LIGHT FIXTURE
M	EXTERIOR POST TOP LIGHT FIXTURE
•	BOLLARD LIGHT FIXTURE
\$	SINGLE POLE SWITCH
\$2	TWO POLE SWITCH
\$3	THREE WAY SWITCH
\$4	FOUR WAY SWITCH
\$к	KEYED SWITCH
\$p	DIMMER SWITCH
\$L	LOW VOLTAGE SWITCH
\$ _P	SWITCH WITH PILOT LIGHT
\$м	MOTOR RATED SWITCH
\$\$	DUAL SWITCH

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LIGH ⁻	LIGHTING CONTROLS LEGEND					
SYMBOL DESCRIPTION						
\$т	TS-400 TIMER SWITCH					
\$ o	WA-200 WALL SENSOR SWITCH					
1	DT-300 DUAL TECHNOLOGY OCCUPANCY SENSOR					
DLS	DAYLIGHT SENSOR					
HP	PHOTOCELL					

1. ALL EQUIPMENT MODEL NUMBERS ARE WATT STOPPER. 2. SIZE SENSORS BASED ON SQUARE FOOTAGES OF AREAS

TO BE COVERED.

FIR	FIRE ALARM SYMBOL LIST				
SYMBOL	DESCRIPTION				
FA	AUDIBLE DEVICE				
Ē⊲	COMBINATION AUDIBLE/VISUAL DEVICE				
Ę	CEILING MOUNTED AUDIBLE/VISUAL DEVICE				
S	VISUAL DEVICE				
Q	CEILING MOUNTED VISUAL DEVICE				
∇FD	FIRE DEPARTMENT COMMUNICATION OUTLET				
F	MANUAL PULL STATION				
\$	SMOKE DETECTOR (ZONED AS INDICATED)				
PHOTOELECTRIC SMOKE DETECTOR (ZONEI INDICATED)					
HEAT DETECTOR (ZONED AS INDICATED)					
TS TAMPER SWITCH					
FS FLOW SWITCH					
	DUCT MOUNTED SMOKE DETECTOR				
FAA	FIRE ALARM ANNUNCIATOR PANEL				
FACP	FIRE ALARM CONTROL PANEL				
ELEC	CTRICAL ABBREVIATIONS				

DESCRIPTION

AVAILABLE INTERRUPTING CURRENT (AMPS)

EXISTING ELECTRICAL EQUIPMENT OR WORK

ABOVE FINISHED FLOOR

CIRCUIT BREAKER

AUTOMATIC TRANSFER SWITCH

ABBREV.

EMT	ELECTRICAL METALLIC TUBING
EWC	ELECTRIC WATER COOLER
FA	FIRE ALARM
FACP	FIRE ALARM CONTROL PANEL
FLA	FULL LOAD AMPS
G/GRD	GROUND
GFI	GROUND FAULT INTERRUPTER
НОА	HAND-OFF-AUTO
IG	ISOLATED GROUND
LP	LIGHTING PANEL
мсв	MAIN CIRCUIT BREAKER
MDP	MAIN DISTRIBUTION PANEL
MLO	MAIN LUG ONLY
NEMA	NATIONAL ELECTRICAL MANUFACTURERS ASSOCIATION
NF	NON-FUSIBLE
NIC	NOT IN CONTRACT
Р	POLE
(R)	RELOCATED EXISTING ELECTRICAL EQUIPMENT
(RR)	REMOVE AND REINSTALL
RMC	RIGID METALLIC CONDUIT
RP	RECEPTACLE PANEL
TBB	TELEPHONE BACKBOARD
TYP.	TYPICAL
WP	WEATHERPROOF
	-

POWER SYMBOL LIST			
SYMBOL	DESCRIPTION		
TC	TIME CLOCK		
С	CONTACTOR		
J	HARD WIRE CONNECTION BY ELECTRICAL CONTRACTOR		
φ	SINGLE RECEPTACLE OUTLET		
Ψ	DUPLEX RECEPTACLE OUTLET		
#	DUPLEX RECEPTACLE OUTLET MOUNTED 6" ABOVE FINISH COUNTER		
φс	CEILING MOUNTED DUPLEX RECEPTACLE OUTLET		
P	EMERGENCY DUPLEX RECEPTACLE OUTLET		
TH TH	DEDICATED DUPLEX RECEPTACLE OUTLET		
	QUAD RECEPTACLE OUTLET		
##	DEDICATED QUAD RECEPTACLE OUTLET		
(FLOOR MOUNTED DUPLEX RECEPTACLE OUTLET		
9	NEMA RECEPTACLE OUTLET (CONFIGURATION AS NOTED)		
	PLUG STRIP		
<u> </u>	JUNCTION BOX (C=CEILING MOUNTED)		
	RECEPTACLE PANEL		
	LIGHTING PANEL		
	DISTRIBUTION/EQUIPMENT POWER PANEL		
Т	TRANSFORMER		
<i>∨</i>	SINGLE PHASE MOTOR		
\ Ø\	THREE PHASE MOTOR		
•	CONDUIT DOWN		
0	CONDUIT UP		
•	GROUNDING ROD		
Ē	GROUND		
т т	GROUNDING BAR		
М	METER		
4	NON-FUSED DISCONNECT SWITCH		
4	FUSED DISCONNECT SWITCH		
42	COMBINATION MAGNETIC MOTOR STARTER		

AUXII	LIARY SYST. SYMBOL LIST					
SYMBOL	1					
∇	TELEPHONE OUTLET					
abla	FLOOR MOUNTED TELEPHONE OUTLET BOX (TYP.)					
₩	TELEPHONE OUTLET MOUNTED 6" ABOVE FINISHED COUNTER					
▼	DATA OUTLET					
A	COMBINATION OUTLET (VOICE, VIDEO, AND/OR DATA)					
•	PUSH BUTTON					
a	BELL					
CR	CARD READER					
DH	MAGNETIC DOOR HOLD					
\vdash	TELEVISION OUTLET					
Ю	WALL CLOCK					
+	DOUBLE SIDED WALL CLOCK					
	COMBINATION WALL CLOCK / SPEAKER					
<u>S</u>	SPEAKER					
	CAMERA					

	DRAWING INDEX
SHT NO	DESCRIPTION
E0.00	ELECTRICAL GENERAL INFORMATION
E0.01h	REDFORD UNION HS ELECTRICAL SITE PLAN
E0.02m	MacGOWAN ELEMENTARY ELECTRICAL SITE PLAN
E0.03s	STUCKEY CENTER ELECTRICAL SITE PLAN
ED1.11h	H.S. MAIN LEVEL ELECTRICAL DEMOLITION PLAN - AREA 'A'
ED1.12h	H.S. MAIN LEVEL ELECTRICAL DEMOLITION PLAN - AREA 'B'
ED1.13h	H.S. MAIN LEVEL ELECTRICAL DEMOLITION PLAN - AREA 'C'
ED1.14h	H.S. MAIN LEVEL ELECTRICAL DEMOLITION PLAN - AREA 'D'
ED1.15h	H.S. MAIN LEVEL ELECTRICAL DEMOLITION PLAN - AREA 'E'
ED1.16h	H.S. MAIN LEVEL ELECTRICAL DEMOLITION PLAN - AREA 'F'
ED1.21h	H.S. UPPER LEVEL ELECTRICAL DEMOLITION PLAN - AREAS 'D' AND 'E'
ED1.22h	H.S. UPPER LEVEL ELECTRICAL DEMOLITION PLAN - AREA 'C'
ED1.23h	H.S. UPPER LEVEL ELECTRICAL DEMOLITION PLAN - AREAS 'C' AND 'F'
ED2.11m	MacGOWAN ELEMENTARY ELECTRICAL DEMOLITION PLAN
ED3.11s	STUCKEY CENTER ELECTRICAL DEMOLITION PLANS — 'A' &'B'
ED3.12s	STUCKEY CENTER ELECTRICAL DEMOLITION PLANS — 'C' &'D'
E1.11h	H.S. MAIN LEVEL ELECTRICAL PLAN — AREA 'A'
E1.12h	H.S. MAIN LEVEL ELECTRICAL PLAN — AREA 'B'
E1.13h	H.S. MAIN LEVEL ELECTRICAL PLAN — AREA 'C'
E1.14h	H.S. MAIN LEVEL ELECTRICAL PLAN — AREA 'D'
E1.15h	H.S. MAIN LEVEL ELECTRICAL PLAN — AREA 'E'
E1.16h	H.S. MAIN LEVEL ELECTRICAL PLAN — AREA 'F'
E1.21h	H.S. UPPER LEVEL ELECTRICAL PLAN — AREAS 'D' AND 'E'
E1.22h	H.S. UPPER LEVEL ELECTRICAL PLAN — AREA 'C'
E1.23h	H.S. UPPER LEVEL ELECTRICAL PLAN — AREAS 'C' AND 'F'
E2.11m	MacGOWAN ELEMENTARY ELECTRICAL PLAN
E3.11s	STUCKEY CENTER ELECTRICAL NEW WORK PLANS - 'A' &'B'
E3.12s	STUCKEY CENTER ELECTRICAL NEW WORK PLANS - 'C' &'D'

l	DRAWING NOTATION					
SYMBOL	DESCRIPTION					
FA	LIGHTING FIXTURE TAG					
1	CONSTRUCTION KEY NOTE NUMBER 1					
1	DEMOLITION KEY NOTE NUMBER 1					
EF 1	EQUIPMENT DESIGNATION, (I.E. EXHAUST FAN NUMBER 1)					
	EXISTING DEVICES OR EQUIPMENT					
	NEW OR MODIFIED DEVICES OR EQUIPMENT					
NEW OR MODIFIED UNDERGROUND WIRING						
\//////	EXISTING SYSTEM COMPONENT TO BE REMOVED					
•	POINT OF NEW CONNECTION.					
SECTION NUMBER 4						
	SHEET E5.2 ON WHICH SECTION IS DRAWN					
	SECTION NO. 6					
6 E5.2	SECTION SCALE: 1/4" = 1' - 0" SHEET E5.2 ON WHICH SECTION IS CUT (ENLARGED PARTIAL PLAN SIMILAR)					



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I hereby certify that this plan, specification or report was prepared by me or under my direct supervision and that I am a duly licensed under the laws of the State of MICHIGAN

Fares Abdallah Registration Number <u>6201049879</u> Date <u>10/31/13</u>

Comm: 124021

ELECTRICAL

GENERAL INFORMATION

E0.00

REDFORD UNION HS ELECTRICAL SITE PLAN

SCALE: 1" = 30'

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SITE PLAN GENERAL NOTES

- FIELD VERIFY LOCATIONS OF EXISTING UNDERGROUND SERVICES TO COORDINATE ALL POLE BASE LOCATIONS AND UNDERGROUND SERVICES BEING INSTALLED UNDER THIS CONTRACT PRIOR TO INSTALLATION OF POLE BASES AND CONDUIT.
- ALL THREE PHASE WIRES, NEUTRAL, AND GROUND SHALL BE RUN TO LAST LIGHTING FIXTURE AND CAPPED FOR FUTURE EXPANSION.
- ANY 120 VOLT BRANCH CIRCUIT FEEDER LONGER THAN 75'-0" TO LAST DEVICE SHALL BE SIZED TO THE NEXT LARGER STANDARD AWG SIZE. E.C. SHALL FIELD VERIFY ALL LENGTHS OF FEEDERS.
- 4. SEE LUMINAIRE SCHEDULE ON ELECTRICAL GENERAL INFORMATION SHEET.5. ALL ELECTRICAL DEVICES ON THIS SHEET SHALL BE NEW UNLESS OTHERWISE
- 6. EXIT LIGHTS AND EMERGENCY BATTERY UNITS SHALL BE UNCONTROLLED AND TIED AHEAD OF LOCAL AREA LIGHTING SWITCH, UNLESS CIRCUITED OTHERWISE.

KEYED NOTES

- REPLACE EXISTING BUILDING MOUNT FIXTURE WITH NEW TYPE 'HA' FIXTURE IN SAME LOCATION. RE-USE EXISTING CIRCUITING.
- NEW FIXTURE LOCATION, CAPTURE AND EXTEND EXISTING CIRCUIT TO NEW LOCATION.
- BELOW GRADE CONDUITS SHALL BE SCHEDULE 40 PVC, ALL CONDUIT IN LIGHTING FIXTURE OR POLE CONCRETE BASE SHALL BE RIGID STEEL. CONDUIT USED INDOORS SHALL BE E.M.T. IN GENERAL, CONDUIT BELOW GRADE SHALL BE INSTALLED IN AN EXCAVATED TRENCH. UTILIZE DIRECTIONAL BORE WHERE APPROPRIATE TO AVOID SURFACE CUTTING AND REPAIR. SEE SPECIFICATIONS FOR ADDITIONAL REQUIREMENTS.

REDFORD UNION MECHANICAL / ELECTRICAL IMPROVEMENTS

REDFORD UNION HIGH SCHOOL 17711 KINLOCH REDFORD, MI 48240

REDFORD UNION SCHOOL

19990 BEECH DALY ROAD REDFORD, MI 48240



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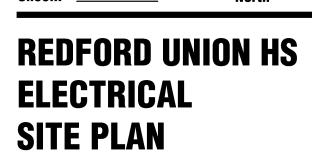
I hereby certify that this plan, specification or report was prepared by me or under my direct supervision and that I am a duly licensed ENGINEER under the laws of the State of MICHIGAN

 Comm:
 124021

 Date:
 4/16/2013

 Drawn:
 DAD

 Check:
 RSA



Cooler # 201

E0.01h

- REFER TO ARCHITECTURAL REFLECTED CEILING PLAN FOR EXACT LOCATION OF ALL LIGHTING FIXTURES UNLESS OTHERWISE NOTED.
- 2. ANY 120 VOLT BRANCH CIRCUIT FEEDER LONGER THAN 75'-0" TO LAST DEVICE
 SHALL BE SIZED TO THE NEXT LARGER STANDARD AWG SIZE F.C. SHALL FIELD
- SHALL BE SIZED TO THE NEXT LARGER STANDARD AWG SIZE. E.C. SHALL FIELD VERIFY ALL LENGTHS OF FEEDERS.
- 3. SEE LUMINAIRE SCHEDULE ON SHEET E0.00
- 4. ALL ELECTRICAL DEVICES ON THIS SHEET SHALL BE NEW UNLESS OTHERWISE NOTED.
- 5. EXIT LIGHTS AND EMERGENCY BATTERY UNITS SHALL BE UNCONTROLLED AND TIED AHEAD OF LOCAL AREA LIGHTING SWITCH, UNLESS CIRCUITED OTHERWISE.
- 6. WHERE MORE THAN ONE LIGHT SWITCH IS INDICATED TO BE INSTALLED AT THE SAME LOCATION, THEY SHALL BE GROUPED UNDER ONE COMMON FACEPLATE.

LIGHTING KEYED NOTES

REMOVE AND REINSTALL LIGHT FIXTURES IN THIS AREA AS NECESSARY TO PERMIT INSTALLATION OF MECHANICAL PIPING. COORDINATE WITH MECHANICAL CONTRACTOR.

NEW TROUBLE LIGHT WITH RETRACTABLE CORD, EXTEND EXISTING 120V CIRCUIT FROM LOCAL LIGHTING CIRCUITING. EXACT SPECIFICATIONS BY OTHERS.

L3 RETROFIT EXISTING LIGHT FIXTURE WITH 1100 LUMEN EMERGENCY BATTERY PACK.

THE TATORE WITH THOSE ESMEN EMERGENCE

GENERAL POWER NOTES

- 1. ALL ELECTRICAL DEVICES SHOWN ON THIS PLAN SHALL BE NEW UNLESS OTHERWISE NOTED.
- 2. ANY 120 VOLT BRANCH CIRCUIT FEEDER LONGER THAN 75'-0" TO LAST DEVICE SHALL BE SIZED TO THE NEXT LARGER STANDARD AWG SIZE. E.C. SHALL FIELD VERIFY ALL LENGTHS OF FEEDERS.
- 3. ALL RECEPTACLES SHALL BE 20A. RATED.
- 4. ALL DISCONNECT SWITCHES SHALL BE HEAVY DUTY TYPE.
- 5. ALL RECEPTACLES WITHIN 6'-0" OF SINK OR OTHER WATER SUPPLY SHALL BE GFCI TYPE RECEPTACLE.
- 6. REFER TO ARCHITECTURAL FLOOR PLAN AND ELEVATIONS FOR EXACT LOCATION OF
- ALL JUNCTION BOXES SERVING BRANCH CIRCUIT WIRING SHALL BE LABELED WITH CIRCUITS SERVED.
- 8. ALL 120 VOLT CIRCUITS SHALL UTILIZE A SEPARATE NEUTRAL.
- 9. ALL CONDUITS SERVING 120 VOLTS OR GREATER SHALL INCLUDE A GROUND WIRE.
- 10. ALL CONDUITS SHALL BE ROUTED CONCEALED UNLESS NOTED OTHERWISE.
- 11. ALL RECEPTACLES INSTALLED IN THE ELEVATOR PIT(S), ELEVATOR MACHINE ROOM(S), CONTROL ROOM(S)/SPACE(S) SHALL BE GROUND FAULT CIRCUIT
- INTERRUPTER TYPE (GFCI). 12. A DEDICATED SINGLE PHASE RECEPTACLE SUPPLYING A ELEVATOR PIT SUMP PUMP
- SHALL NOT BE A GFCI TYPE RECEPTACLE.

 13. ALL ELECTRICAL EQUIPMENT MOUNTED ON THE FLOOR SHALL BE MOUNTED ON A
- 4" CONCRETE HOUSE KEEPING PAD.
- 14. ALL FIRE ALARM DEVICES SHALL BE 15 CANDELA RATED UNLESS NOTED OTHERWISE.

POWER KEYED NOTES

- CONNECT NEW BOILER TO EXISTING PANEL DP-IT1. SEE PARTIAL ELECTRICAL ONE LINE DIAGRAM SHEET E3.00.
- CONNECT PUMP TO EXISTING PANEL DP-7. PROVIDE 20A FUSES IN EXISTING 60A, 3P SWITCH. SEE ELECTRICAL ONE LINE DIAGRAM SHEET E3.00.
- P3 CONNECT TO SPARE BREAKER IN EXISTING PANEL.
- PROVIDE 120V CONNECTION AND ELECTRICAL ROUGH—IN FOR CARD READER. SEE DETAIL SHEET E3.00.
- P5 PROVIDE ROUGH—IN FOR FOR ADA PUSH PADS TO BE MOUNTED ON WALL. PROVIDE DUAL GANG JUNCTION BOXES FOR PUSHBUTTON AND 3/4"C INTERCONNECTING CONDUITS. COORDINATE REQUIREMENTS WITH DOOR HARDWARE CONSULTANT. ELECTRICAL CONTRACTOR TO MAKE FINAL ELECTRICAL CONNECTION.
- PROVIDE 120V CONNECTION TO ADA ACTUATOR. COORDINATE REQUIREMENTS WITH DOOR HARDWARE CONSULTANT. ELECTRICAL CONTRACTOR TO MAKE FINAL ELECTRICAL CONNECTION.
- P7 INSTALL NEW 200A, 120/240V, 1 PH, 3W, 42 CIRCUIT PANELBOARD "Y" IN EXISTING LOCATION. PROVIDE BREAKERS AS NECESSARY TO RE-CONNECT EXISTING
- LOADS PLUS ONE 20A, 1P BREAKER FOR NEW SITE LIGHTING CIRCUIT.

 PROVIDE 30A, 2P LIGHTING CONTACTOR AND ASTRONOMIC TIME CLOCK FOR CONTROL OF NEW SITE LIGHTING.
- P9 INSTALL NEW 200A, 120/240V, 1 PH, 3W, 42 CIRCUIT PANELBOARD "GA" IN EXISTING LOCATION. PROVIDE BREAKERS AS NECESSARY TO RE—CONNECT EXISTING
- INSTALL NEW 100A, 120/240V, 3 PH, 3W, 30 CIRCUIT PANELBOARD "GB" IN EXISTING LOCATION. PROVIDE BREAKERS AS NECESSARY TO RE—CONNECT EXISTING
- LOADS.
- P1) PROVIDE (2) LIGHTING CONTACTORS WITH HOA CONTROL FOR GYM LIGHT CIRCUITS.

 P12 INSTALL NEW 200A, 120/240V, 1 PH, 3W, 30 CIRCUIT PANELBOARD "D" IN

EXISTING LOCATION. PROVIDE BREAKERS AS NECESSARY TO RE-CONNECT EXISTING

- INSTALL NEW 200A, 120/240V, 1 PH, 3W, 30 CIRCUIT PANELBOARD "A" IN EXISTING LOCATION. PROVIDE BREAKERS AS NECESSARY TO RE—CONNECT EXISTING
- CONNECT TO EXISTING 30A, 3P SWITCH IN PANEL 'P4'. SEE ELECTRICAL
- ONE-LINE DIAGRAM SHEET E3.00 FOR MORE INFORMATION.

 CONNECT TO EXISTING CIRCUIT AND WIRING FROM EQUIPMENT PREVIOUSLY REMOVED.
- CONNECT TO SPARE 200A, 3P SWITCH IN EXISITING DISTRIBUTION PANEL DP-4.
 PROVIDE NEW 60A FUSES. SEE ELECTRICAL ONE-LINE DIAGRAM SHEET E3.00 FOR
- MORE INFORMATION.
- PROVIDE FIRE ALARM SYSTEM CONNECTION TO FACTORY INSTALLED SMOKE DETECTOR ON MAKE-UP AIR UNIT MUA-1.
- PROVIDE POWER TO TEMPERATURE CONTROL UNIT TRANSFORMER. CONNECT TO NEAREST 120V RECEPTACLE CIRCUIT.
- NEW FIRE ALARM DEVICE, CONNECT TO EXISTING NAC PANEL. NEW DEVICES SHALL BE COMPATIBLE WITH EXISTING SIMPLEX SYSTEM.
- DISCONNECT AND RE-CONNECT EXISTING MECHANICAL ROOFTOP UNIT. COORDINATE WITH MECHANICAL TRADES.

 P21 INSTALL AND WIRE V.F.D. PROVIDED BY MECHANICAL CONTRACTOR. ELECTRICAL CONTRACTOR SHALL WIRE FROM THE UNIT TO THE REMOTE V.F.D. AND THEN BACK

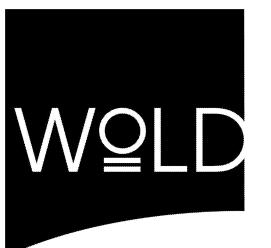
FIXTURE IN SIMILAR LOCATION.

ALL NEW 'EM' AND 'X' TYPE FIXTURES SHALL BE DIRECT REPLACEMENT OF EXISTING REDFORD UNION
MECHANICAL / ELECTRICAL
IMPROVEMENTS

REDFORD UNION HIGH SCHOOL 17711 KINLOCH REDFORD, MI 48240

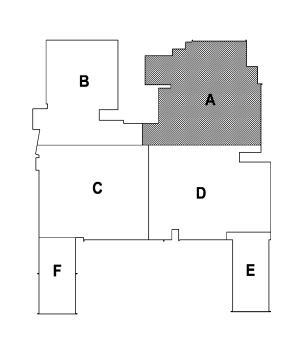
REDFORD UNION SCHOOL DISTRICT

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KEY PLAN

I hereby certify that this plan, specification or report was prepared by me or under my direct supervision and that I am a duly licensed ENGINEER

under the laws of the State of MICHIGAN

Fares Abdallah
Registration Number 6201049879 Date 10/31/13

Revisions
Description Date Num

 Comm:
 124021

 Date:
 4/16/2013

 Drawn:
 DAD

: 4/16/2013 /n: DAD ck: RSA

H.S. MAIN LEVEL ELECTRICAL PLAN - AREA 'A'

Scale:

E1.11h

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GENERAL LIGHTING NOTES

- REFER TO ARCHITECTURAL REFLECTED CEILING PLAN FOR EXACT LOCATION OF ALL
- LIGHTING FIXTURES UNLESS OTHERWISE NOTED.

 2. ANY 120 VOLT BRANCH CIRCUIT FEEDER LONGER THAN 75'-0" TO LAST DEVICE
- SHALL BE SIZED TO THE NEXT LARGER STANDARD AWG SIZE. E.C. SHALL FIELD VERIFY ALL LENGTHS OF FEEDERS.
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- 4. ALL ELECTRICAL DEVICES ON THIS SHEET SHALL BE NEW UNLESS OTHERWISE
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LIGHTING KEYED NOTES

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NEW TROUBLE LIGHT WITH RETRACTABLE CORD, EXTEND EXISTING 120V CIRCUIT FROM LOCAL LIGHTING CIRCUITING. EXACT SPECIFICATIONS BY OTHERS.

(L3) RETROFIT EXISTING LIGHT FIXTURE WITH 1100 LUMEN EMERGENCY BATTERY PACK.

GENERAL POWER NOTES

- 1. ALL ELECTRICAL DEVICES SHOWN ON THIS PLAN SHALL BE NEW UNLESS
- OTHERWISE NOTED.

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- 3. ALL RECEPTACLES SHALL BE 20A. RATED.
- 4. ALL DISCONNECT SWITCHES SHALL BE HEAVY DUTY TYPE.
- 5. ALL RECEPTACLES WITHIN 6'-0" OF SINK OR OTHER WATER SUPPLY SHALL BE GFCI TYPE RECEPTACLE.
- 6. REFER TO ARCHITECTURAL FLOOR PLAN AND ELEVATIONS FOR EXACT LOCATION OF DEVICES.
- 7. ALL JUNCTION BOXES SERVING BRANCH CIRCUIT WIRING SHALL BE LABELED WITH CIRCUITS SERVED.
- 8. ALL 120 VOLT CIRCUITS SHALL UTILIZE A SEPARATE NEUTRAL.
- 9. ALL CONDUITS SERVING 120 VOLTS OR GREATER SHALL INCLUDE A GROUND WIRE.
- 10. ALL CONDUITS SHALL BE ROUTED CONCEALED UNLESS NOTED OTHERWISE.
- 11. ALL RECEPTACLES INSTALLED IN THE ELEVATOR PIT(S), ELEVATOR MACHINE ROOM(S), CONTROL ROOM(S)/SPACE(S) SHALL BE GROUND FAULT CIRCUIT INTERRUPTER TYPE (GFCI).
- 12. A DEDICATED SINGLE PHASE RECEPTACLE SUPPLYING A ELEVATOR PIT SUMP PUMP SHALL NOT BE A GFCI TYPE RECEPTACLE.
- 13. ALL ELECTRICAL EQUIPMENT MOUNTED ON THE FLOOR SHALL BE MOUNTED ON A 4" CONCRETE HOUSE KEEPING PAD.
- 14. ALL FIRE ALARM DEVICES SHALL BE 15 CANDELA RATED UNLESS NOTED

POWER KEYED NOTES

- CONNECT NEW BOILER TO EXISTING PANEL DP-IT1. SEE PARTIAL ELECTRICAL ONE LINE DIAGRAM SHEET E3.00.
- CONNECT PUMP TO EXISTING PANEL DP-7. PROVIDE 20A FUSES IN EXISTING 60A, 3P SWITCH. SEE ELECTRICAL ONE LINE DIAGRAM SHEET E3.00.
- (P3) CONNECT TO SPARE BREAKER IN EXISTING PANEL.

ELECTRICAL CONNECTION.

- PROVIDE 120V CONNECTION AND ELECTRICAL ROUGH—IN FOR CARD READER. SEE DETAIL SHEET E3.00.
- P5 PROVIDE ROUGH—IN FOR FOR ADA PUSH PADS TO BE MOUNTED ON WALL. PROVIDE DUAL GANG JUNCTION BOXES FOR PUSHBUTTON AND 3/4"C INTERCONNECTING CONDUITS. COORDINATE REQUIREMENTS WITH DOOR HARDWARE CONSULTANT.
- P6 PROVIDE 120V CONNECTION TO ADA ACTUATOR. COORDINATE REQUIREMENTS WITH DOOR HARDWARE CONSULTANT. ELECTRICAL CONTRACTOR TO MAKE FINAL

ELECTRICAL CONTRACTOR TO MAKE FINAL ELECTRICAL CONNECTION.

- P7 INSTALL NEW 200A, 120/240V, 1 PH, 3W, 42 CIRCUIT PANELBOARD "Y" IN EXISTING LOCATION. PROVIDE BREAKERS AS NECESSARY TO RE—CONNECT EXISTING LOADS PLUS ONE 20A, 1P BREAKER FOR NEW SITE LIGHTING CIRCUIT.
- P8 PROVIDE 30A, 2P LIGHTING CONTACTOR AND ASTRONOMIC TIME CLOCK FOR CONTROL OF NEW SITE LIGHTING.
- P9 INSTALL NEW 200A, 120/240V, 1 PH, 3W, 42 CIRCUIT PANELBOARD "GA" IN EXISTING LOCATION. PROVIDE BREAKERS AS NECESSARY TO RE—CONNECT EXISTING
- INSTALL NEW 100A, 120/240V, 3 PH, 3W, 30 CIRCUIT PANELBOARD "GB" IN EXISTING LOCATION. PROVIDE BREAKERS AS NECESSARY TO RE-CONNECT EXISTING
- LOADS.

 PROVIDE (2) LIGHTING CONTACTORS WITH HOA CONTROL FOR GYM LIGHT CIRCUITS.
- INSTALL NEW 200A, 120/240V, 1 PH, 3W, 30 CIRCUIT PANELBOARD "D" IN EXISTING LOCATION. PROVIDE BREAKERS AS NECESSARY TO RE-CONNECT EXISTING LOADS.
- INSTALL NEW 200A, 120/240V, 1 PH, 3W, 30 CIRCUIT PANELBOARD "A" IN EXISTING LOCATION. PROVIDE BREAKERS AS NECESSARY TO RE-CONNECT EXISTING
- CONNECT TO EXISTING 30A, 3P SWITCH IN PANEL 'P4'. SEE ELECTRICAL ONE-LINE DIAGRAM SHEET E3.00 FOR MORE INFORMATION.
- CONNECT TO EXISTING CIRCUIT AND WIRING FROM EQUIPMENT PREVIOUSLY REMOVED.
- CONNECT TO SPARE 200A, 3P SWITCH IN EXISITING DISTRIBUTION PANEL DP-4.
 PROVIDE NEW 60A FUSES. SEE ELECTRICAL ONE-LINE DIAGRAM SHEET E3.00 FOR MORE INFORMATION.
- PROVIDE FIRE ALARM SYSTEM CONNECTION TO FACTORY INSTALLED SMOKE DETECTOR ON MAKE-UP AIR UNIT MUA-1.
- PROVIDE POWER TO TEMPERATURE CONTROL UNIT TRANSFORMER. CONNECT TO NEAREST 120V RECEPTACLE CIRCUIT.
- NEAREST 120V RECEPTACLE CIRCUIT.
- NEW FIRE ALARM DEVICE, CONNECT TO EXISTING NAC PANEL. NEW DEVICES SHALL BE COMPATIBLE WITH EXISTING SIMPLEX SYSTEM.
- DISCONNECT AND RE-CONNECT EXISTING MECHANICAL ROOFTOP UNIT. COORDINATE WITH MECHANICAL TRADES.
- P2) INSTALL AND WIRE V.F.D. PROVIDED BY MECHANICAL CONTRACTOR. ELECTRICAL CONTRACTOR SHALL WIRE FROM THE UNIT TO THE REMOTE V.F.D. AND THEN BACK TO THE UNIT.

ALL NEW 'EM' AND 'X' TYPE
FIXTURES SHALL BE DIRECT
REPLACEMENT OF EXISTING
FIXTURE IN SIMILAR LOCATION.

REDFORD UNION
MECHANICAL / ELECTRICAL
IMPROVEMENTS

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REDFORD UNION SCHOOL

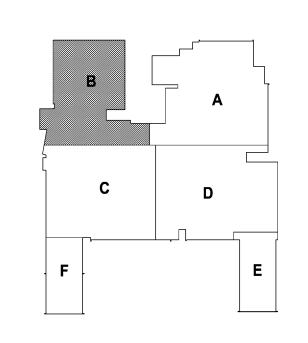
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Royal Oak, MI 48067 mail@woldae.com



KEY PLAN

I hereby certify that this plan, specification or report was prepared by me or under my direct supervision and that I am a duly licensed ENGINEER

under the laws of the State of MICHIGAN

Fares Abdallah

Registration Number 6201049879 Date 10/31/13

Revisions

Description Date Num

Comm: 124021

Date: 4/16/2013

Drawn: DAD

Check: P6A

H.S. MAIN LEVEL

ELECTRICAL PLAN -AREA 'B'

Scale:

E1.12h

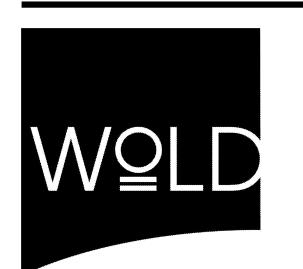
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REDFORD UNION SCHOOL **DISTRICT**

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KEY PLAN

I hereby certify that this plan, specification or report was prepared by me or under my direct supervision and that I am a duly licensed under the laws of the State of MICHIGAN

Fares Abdallah Registration Number <u>6201049879</u> Date <u>10/31/13</u> Date

Comm: 124021

 Date:
 4/16/2013

 Drawn:
 DAD

H.S. MAIN LEVEL **ELECTRICAL PLAN -**AREA 'C'

E1.13h

- 1. REFER TO ARCHITECTURAL REFLECTED CEILING PLAN FOR EXACT LOCATION OF ALL
- 2. ANY 120 VOLT BRANCH CIRCUIT FEEDER LONGER THAN 75'-0" TO LAST DEVICE
 - SHALL BE SIZED TO THE NEXT LARGER STANDARD AWG SIZE. E.C. SHALL FIELD VERIFY ALL LENGTHS OF FEEDERS.
- 3. SEE LUMINAIRE SCHEDULE ON SHEET E0.00
- 4. ALL ELECTRICAL DEVICES ON THIS SHEET SHALL BE NEW UNLESS OTHERWISE
- 5. EXIT LIGHTS AND EMERGENCY BATTERY UNITS SHALL BE UNCONTROLLED AND TIED AHEAD OF LOCAL AREA LIGHTING SWITCH, UNLESS CIRCUITED OTHERWISE.
- 6. WHERE MORE THAN ONE LIGHT SWITCH IS INDICATED TO BE INSTALLED AT THE SAME LOCATION, THEY SHALL BE GROUPED UNDER ONE COMMON FACEPLATE.

LIGHTING KEYED NOTES

REMOVE AND REINSTALL LIGHT FIXTURES IN THIS AREA AS NECESSARY TO PERMIT INSTALLATION OF MECHANICAL PIPING. COORDINATE WITH MECHANICAL CONTRACTOR. NEW TROUBLE LIGHT WITH RETRACTABLE CORD, EXTEND EXISTING 120V CIRCUIT FROM LOCAL LIGHTING CIRCUITING. EXACT SPECIFICATIONS BY OTHERS.

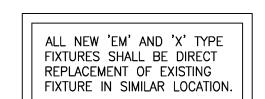
(L3) RETROFIT EXISTING LIGHT FIXTURE WITH 1100 LUMEN EMERGENCY BATTERY PACK.

GENERAL POWER NOTES

- 1. ALL ELECTRICAL DEVICES SHOWN ON THIS PLAN SHALL BE NEW UNLESS
- 2. ANY 120 VOLT BRANCH CIRCUIT FEEDER LONGER THAN 75'-0" TO LAST DEVICE SHALL BE SIZED TO THE NEXT LARGER STANDARD AWG SIZE. E.C. SHALL FIELD
- 3. ALL RECEPTACLES SHALL BE 20A. RATED.
- 4. ALL DISCONNECT SWITCHES SHALL BE HEAVY DUTY TYPE.
- 5. ALL RECEPTACLES WITHIN 6'-0" OF SINK OR OTHER WATER SUPPLY SHALL BE GFCI TYPE RECEPTACLE.
- 6. REFER TO ARCHITECTURAL FLOOR PLAN AND ELEVATIONS FOR EXACT LOCATION OF
- 7. ALL JUNCTION BOXES SERVING BRANCH CIRCUIT WIRING SHALL BE LABELED WITH
- 8. ALL 120 VOLT CIRCUITS SHALL UTILIZE A SEPARATE NEUTRAL.
- 9. ALL CONDUITS SERVING 120 VOLTS OR GREATER SHALL INCLUDE A GROUND WIRE.
- 10. ALL CONDUITS SHALL BE ROUTED CONCEALED UNLESS NOTED OTHERWISE. 11. ALL RECEPTACLES INSTALLED IN THE ELEVATOR PIT(S), ELEVATOR MACHINE
- ROOM(S), CONTROL ROOM(S)/SPACE(S) SHALL BE GROUND FAULT CIRCUIT INTERRUPTER TYPE (GFCI).
- 12. A DEDICATED SINGLE PHASE RECEPTACLE SUPPLYING A ELEVATOR PIT SUMP PUMP SHALL NOT BE A GFCI TYPE RECEPTACLE.
- 13. ALL ELECTRICAL EQUIPMENT MOUNTED ON THE FLOOR SHALL BE MOUNTED ON A 4" CONCRETE HOUSE KEEPING PAD.
- 14. ALL FIRE ALARM DEVICES SHALL BE 15 CANDELA RATED UNLESS NOTED

POWER KEYED NOTES

- CONNECT NEW BOILER TO EXISTING PANEL DP-IT1. SEE PARTIAL ELECTRICAL ONE LINE DIAGRAM SHEET E3.00.
- CONNECT PUMP TO EXISTING PANEL DP-7. PROVIDE 20A FUSES IN EXISTING 60A, 3P SWITCH. SEE ELECTRICAL ONE LINE DIAGRAM SHEET E3.00.
- P3 CONNECT TO SPARE BREAKER IN EXISTING PANEL.
- PA PROVIDE 120V CONNECTION AND ELECTRICAL ROUGH—IN FOR CARD READER. SEE DETAIL SHEET E3.00.
- P5 PROVIDE ROUGH-IN FOR FOR ADA PUSH PADS TO BE MOUNTED ON WALL. PROVIDE DUAL GANG JUNCTION BOXES FOR PUSHBUTTON AND 3/4"C INTERCONNECTING CONDUITS. COORDINATE REQUIREMENTS WITH DOOR HARDWARE CONSULTANT.
- PFOVIDE 120V CONNECTION TO ADA ACTUATOR. COORDINATE REQUIREMENTS WITH DOOR HARDWARE CONSULTANT. ELECTRICAL CONTRACTOR TO MAKE FINAL ELECTRICAL CONNECTION.
- P7 INSTALL NEW 200A, 120/240V, 1 PH, 3W, 42 CIRCUIT PANELBOARD "Y" IN EXISTING LOCATION. PROVIDE BREAKERS AS NECESSARY TO RE-CONNECT EXISTING
- LOADS PLUS ONE 20A, 1P BREAKER FOR NEW SITE LIGHTING CIRCUIT.
- PROVIDE 30A, 2P LIGHTING CONTACTOR AND ASTRONOMIC TIME CLOCK FOR CONTROL OF NEW SITE LIGHTING. P9 INSTALL NEW 200A, 120/240V, 1 PH, 3W, 42 CIRCUIT PANELBOARD "GA" IN EXISTING LOCATION. PROVIDE BREAKERS AS NECESSARY TO RE-CONNECT EXISTING
- P10 INSTALL NEW 100A, 120/240V, 3 PH, 3W, 30 CIRCUIT PANELBOARD "GB" IN
- EXISTING LOCATION. PROVIDE BREAKERS AS NECESSARY TO RE-CONNECT EXISTING
- P1) PROVIDE (2) LIGHTING CONTACTORS WITH HOA CONTROL FOR GYM LIGHT CIRCUITS. INSTALL NEW 200A, 120/240V, 1 PH, 3W, 30 CIRCUIT PANELBOARD "D" IN EXISTING LOCATION. PROVIDE BREAKERS AS NECESSARY TO RE-CONNECT EXISTING
- install new 200a, 120/240v, 1 ph, 3w, 30 circuit panelboard "a" in existing location. Provide Breakers as necessary to re-connect existing
- CONNECT TO EXISTING 30A, 3P SWITCH IN PANEL 'P4'. SEE ELECTRICAL ONE-LINE DIAGRAM SHEET E3.00 FOR MORE INFORMATION.
- CONNECT TO EXISTING CIRCUIT AND WIRING FROM EQUIPMENT PREVIOUSLY REMOVED.
- MORE INFORMATION.
- PROVIDE FIRE ALARM SYSTEM CONNECTION TO FACTORY INSTALLED SMOKE DETECTOR ON MAKE-UP AIR UNIT MUA-1.
- PROVIDE POWER TO TEMPERATURE CONTROL UNIT TRANSFORMER. CONNECT TO NEAREST 120V RECEPTACLE CIRCUIT.
- NEW FIRE ALARM DEVICE, CONNECT TO EXISTING NAC PANEL. NEW DEVICES SHALL BE COMPATIBLE WITH EXISTING SIMPLEX SYSTEM.
- DISCONNECT AND RE-CONNECT EXISTING MECHANICAL ROOFTOP UNIT. COORDINATE WITH MECHANICAL TRADES.
- P2) INSTALL AND WIRE V.F.D. PROVIDED BY MECHANICAL CONTRACTOR. ELECTRICAL CONTRACTOR SHALL WIRE FROM THE UNIT TO THE REMOTE V.F.D. AND THEN BACK



REDFORD UNION MECHANICAL / ELECTRICAL IMPROVEMENTS

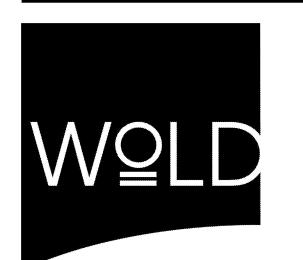
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REDFORD UNION SCHOOL DISTRICT

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REDFORD, MI 48240

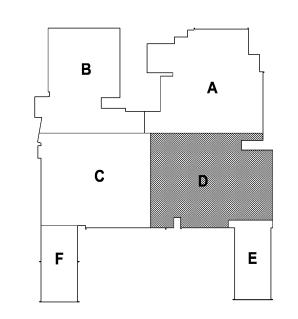
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KEY PLAN

I hereby certify that this plan, specification or report was prepared by me or under my direct supervision and that I am a duly licensed

under the laws of the State of MICHIGAN Registration Number <u>6201049879</u> Date <u>10/31/13</u>

Comm: <u>124021</u> Drawn: DAD

H.S. MAIN LEVEL

ELECTRICAL PLAN -AREA 'D'

E1.14h

MAIN LEVEL ELECTRICAL PLAN - AREA 'E'

• •

- GENERAL LIGHTING NOTES 1. REFER TO ARCHITECTURAL REFLECTED CEILING PLAN FOR EXACT LOCATION OF ALL
- LIGHTING FIXTURES UNLESS OTHERWISE NOTED. 2. ANY 120 VOLT BRANCH CIRCUIT FEEDER LONGER THAN 75'-0" TO LAST DEVICE
- SHALL BE SIZED TO THE NEXT LARGER STANDARD AWG SIZE. E.C. SHALL FIELD VERIFY ALL LENGTHS OF FEEDERS.
- 3. SEE LUMINAIRE SCHEDULE ON SHEET E0.00

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- 4. ALL ELECTRICAL DEVICES ON THIS SHEET SHALL BE NEW UNLESS OTHERWISE
- 5. EXIT LIGHTS AND EMERGENCY BATTERY UNITS SHALL BE UNCONTROLLED AND TIED AHEAD OF LOCAL AREA LIGHTING SWITCH, UNLESS CIRCUITED OTHERWISE.
- 6. WHERE MORE THAN ONE LIGHT SWITCH IS INDICATED TO BE INSTALLED AT THE SAME LOCATION, THEY SHALL BE GROUPED UNDER ONE COMMON FACEPLATE.

LIGHTING KEYED NOTES

REMOVE AND REINSTALL LIGHT FIXTURES IN THIS AREA AS NECESSARY TO PERMIT INSTALLATION OF MECHANICAL PIPING. COORDINATE WITH MECHANICAL CONTRACTOR.

NEW TROUBLE LIGHT WITH RETRACTABLE CORD, EXTEND EXISTING 120V CIRCUIT FROM LOCAL LIGHTING CIRCUITING. EXACT SPECIFICATIONS BY OTHERS. L3 RETROFIT EXISTING LIGHT FIXTURE WITH 1100 LUMEN EMERGENCY BATTERY PACK.

GENERAL POWER NOTES

- 1. ALL ELECTRICAL DEVICES SHOWN ON THIS PLAN SHALL BE NEW UNLESS OTHERWISE NOTED.
- 2. ANY 120 VOLT BRANCH CIRCUIT FEEDER LONGER THAN 75'-0" TO LAST DEVICE SHALL BE SIZED TO THE NEXT LARGER STANDARD AWG SIZE. E.C. SHALL FIELD VERIFY ALL LENGTHS OF FEEDERS.
- 3. ALL RECEPTACLES SHALL BE 20A. RATED.
- 4. ALL DISCONNECT SWITCHES SHALL BE HEAVY DUTY TYPE.
- 5. ALL RECEPTACLES WITHIN 6'-0" OF SINK OR OTHER WATER SUPPLY SHALL BE GFCI TYPE RECEPTACLE.
- 6. REFER TO ARCHITECTURAL FLOOR PLAN AND ELEVATIONS FOR EXACT LOCATION OF
- 7. ALL JUNCTION BOXES SERVING BRANCH CIRCUIT WIRING SHALL BE LABELED WITH CIRCUITS SERVED.
- 8. ALL 120 VOLT CIRCUITS SHALL UTILIZE A SEPARATE NEUTRAL.
- 9. ALL CONDUITS SERVING 120 VOLTS OR GREATER SHALL INCLUDE A GROUND WIRE.
- 10. ALL CONDUITS SHALL BE ROUTED CONCEALED UNLESS NOTED OTHERWISE.
- 11. ALL RECEPTACLES INSTALLED IN THE ELEVATOR PIT(S), ELEVATOR MACHINE ROOM(S), CONTROL ROOM(S)/SPACE(S) SHALL BE GROUND FAULT CIRCUIT INTERRUPTER TYPE (GFCI).
- 12. A DEDICATED SINGLE PHASE RECEPTACLE SUPPLYING A ELEVATOR PIT SUMP PUMP SHALL NOT BE A GFCI TYPE RECEPTACLE.
- 13. ALL ELECTRICAL EQUIPMENT MOUNTED ON THE FLOOR SHALL BE MOUNTED ON A 4" CONCRETE HOUSE KEEPING PAD.
- 14. ALL FIRE ALARM DEVICES SHALL BE 15 CANDELA RATED UNLESS NOTED

POWER KEYED NOTES

- CONNECT NEW BOILER TO EXISTING PANEL DP-IT1. SEE PARTIAL ELECTRICAL ONE LINE DIAGRAM SHEET E3.00.
- CONNECT PUMP TO EXISTING PANEL DP-7. PROVIDE 20A FUSES IN EXISTING 60A, 3P SWITCH. SEE ELECTRICAL ONE LINE DIAGRAM SHEET E3.00.
- (P3) CONNECT TO SPARE BREAKER IN EXISTING PANEL.
- PA PROVIDE 120V CONNECTION AND ELECTRICAL ROUGH—IN FOR CARD READER. SEE DETAIL SHEET E3.00.
- P5 PROVIDE ROUGH—IN FOR FOR ADA PUSH PADS TO BE MOUNTED ON WALL. PROVIDE DUAL GANG JUNCTION BOXES FOR PUSHBUTTON AND 3/4"C INTERCONNECTING CONDUITS. COORDINATE REQUIREMENTS WITH DOOR HARDWARE CONSULTANT. ELECTRICAL CONTRACTOR TO MAKE FINAL ELECTRICAL CONNECTION.
- P6 PROVIDE 120V CONNECTION TO ADA ACTUATOR. COORDINATE REQUIREMENTS WITH DOOR HARDWARE CONSULTANT. ELECTRICAL CONTRACTOR TO MAKE FINAL ELECTRICAL CONNECTION.
- P7 INSTALL NEW 200A, 120/240V, 1 PH, 3W, 42 CIRCUIT PANELBOARD "Y" IN EXISTING LOCATION. PROVIDE BREAKERS AS NECESSARY TO RE-CONNECT EXISTING LOADS PLUS ONE 20A, 1P BREAKER FOR NEW SITE LIGHTING CIRCUIT.
- P8 PROVIDE 30A, 2P LIGHTING CONTACTOR AND ASTRONOMIC TIME CLOCK FOR CONTROL OF NEW SITE LIGHTING.
- P9 INSTALL NEW 200A, 120/240V, 1 PH, 3W, 42 CIRCUIT PANELBOARD "GA" IN EXISTING LOCATION. PROVIDE BREAKERS AS NECESSARY TO RE-CONNECT EXISTING
- INSTALL NEW 100A, 120/240V, 3 PH, 3W, 30 CIRCUIT PANELBOARD "GB" IN EXISTING LOCATION. PROVIDE BREAKERS AS NECESSARY TO RE-CONNECT EXISTING
- P1) PROVIDE (2) LIGHTING CONTACTORS WITH HOA CONTROL FOR GYM LIGHT CIRCUITS.
- (P12) INSTALL NEW 200A, 120/240V, 1 PH, 3W, 30 CIRCUIT PANELBOARD "D" IN EXISTING LOCATION. PROVIDE BREAKERS AS NECESSARY TO RE-CONNECT EXISTING

install new 200A, 120/240V, 1 PH, 3W, 30 CIRCUIT PANELBOARD "A" IN EXISTING LOCATION. PROVIDE BREAKERS AS NECESSARY TO RE-CONNECT EXISTING

- CONNECT TO EXISTING 30A, 3P SWITCH IN PANEL 'P4'. SEE ELECTRICAL ONE-LINE DIAGRAM SHEET E3.00 FOR MORE INFORMATION.
- CONNECT TO EXISTING CIRCUIT AND WIRING FROM EQUIPMENT PREVIOUSLY REMOVED.
- CONNECT TO SPARE 200A, 3P SWITCH IN EXISITING DISTRIBUTION PANEL DP-4.
 PROVIDE NEW 60A FUSES. SEE ELECTRICAL ONE-LINE DIAGRAM SHEET E3.00 FOR
- PROVIDE FIRE ALARM SYSTEM CONNECTION TO FACTORY INSTALLED SMOKE DETECTOR ON MAKE-UP AIR UNIT MUA-1.
- PROVIDE POWER TO TEMPERATURE CONTROL UNIT TRANSFORMER. CONNECT TO NEAREST 120V RECEPTACLE CIRCUIT.
- P19 NEW FIRE ALARM DEVICE, CONNECT TO EXISTING NAC PANEL. NEW DEVICES SHALL BE COMPATIBLE WITH EXISTING SIMPLEX SYSTEM.
- DISCONNECT AND RE-CONNECT EXISTING MECHANICAL ROOFTOP UNIT. COORDINATE WITH MECHANICAL TRADES.
- P21 INSTALL AND WIRE V.F.D. PROVIDED BY MECHANICAL CONTRACTOR. ELECTRICAL CONTRACTOR SHALL WIRE FROM THE UNIT TO THE REMOTE V.F.D. AND THEN BACK TO THE UNIT.

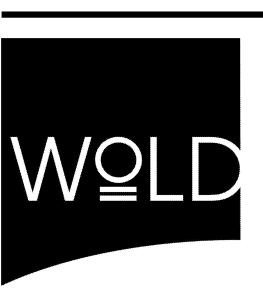
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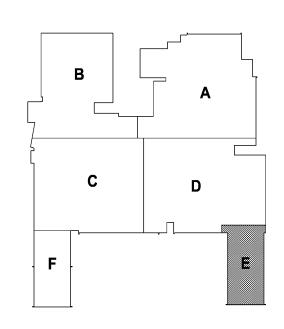


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KEY PLAN

I hereby certify that this plan, specification or report was prepared by me or under my direct supervision and that I am a duly licensed

under the laws of the Stat	te of _	MIC	HIGAN	
Fa Registration Number		bdallah 1049879	Date 10	/31/13
	Revi	sions		
Description		Dat	е	Num

Date: 4/16/2013 Drawn: DAD

H.S. MAIN LEVEL **ELECTRICAL PLAN -**AREA 'E'

• •

MAIN LEVEL ELECTRICAL PLAN - AREA 'F'

• •

• •

GENERAL LIGHTING NOTES

- 1. REFER TO ARCHITECTURAL REFLECTED CEILING PLAN FOR EXACT LOCATION OF ALL LIGHTING FIXTURES UNLESS OTHERWISE NOTED.
- 2. ANY 120 VOLT BRANCH CIRCUIT FEEDER LONGER THAN 75'-0" TO LAST DEVICE SHALL BE SIZED TO THE NEXT LARGER STANDARD AWG SIZE. E.C. SHALL FIELD
- VERIFY ALL LENGTHS OF FEEDERS.
- 3. SEE LUMINAIRE SCHEDULE ON SHEET E0.00
- 4. ALL ELECTRICAL DEVICES ON THIS SHEET SHALL BE NEW UNLESS OTHERWISE
- 5. EXIT LIGHTS AND EMERGENCY BATTERY UNITS SHALL BE UNCONTROLLED AND TIED AHEAD OF LOCAL AREA LIGHTING SWITCH, UNLESS CIRCUITED OTHERWISE.
- 6. WHERE MORE THAN ONE LIGHT SWITCH IS INDICATED TO BE INSTALLED AT THE SAME LOCATION, THEY SHALL BE GROUPED UNDER ONE COMMON FACEPLATE.

LIGHTING KEYED NOTES

- REMOVE AND REINSTALL LIGHT FIXTURES IN THIS AREA AS NECESSARY TO PERMIT INSTALLATION OF MECHANICAL PIPING. COORDINATE WITH MECHANICAL CONTRACTOR.
- NEW TROUBLE LIGHT WITH RETRACTABLE CORD, EXTEND EXISTING 120V CIRCUIT FROM LOCAL LIGHTING CIRCUITING. EXACT SPECIFICATIONS BY OTHERS. L3 RETROFIT EXISTING LIGHT FIXTURE WITH 1100 LUMEN EMERGENCY BATTERY PACK.

GENERAL POWER NOTES

- 1. ALL ELECTRICAL DEVICES SHOWN ON THIS PLAN SHALL BE NEW UNLESS OTHERWISE NOTED.
- 2. ANY 120 VOLT BRANCH CIRCUIT FEEDER LONGER THAN 75'-0" TO LAST DEVICE SHALL BE SIZED TO THE NEXT LARGER STANDARD AWG SIZE. E.C. SHALL FIELD VERIFY ALL LENGTHS OF FEEDERS.
- 3. ALL RECEPTACLES SHALL BE 20A. RATED.

CIRCUITS SERVED.

- 4. ALL DISCONNECT SWITCHES SHALL BE HEAVY DUTY TYPE.
- 5. ALL RECEPTACLES WITHIN 6'-0" OF SINK OR OTHER WATER SUPPLY SHALL BE GFCI TYPE RECEPTACLE.
- 6. REFER TO ARCHITECTURAL FLOOR PLAN AND ELEVATIONS FOR EXACT LOCATION OF
- DEVICES. 7. ALL JUNCTION BOXES SERVING BRANCH CIRCUIT WIRING SHALL BE LABELED WITH
- 8. ALL 120 VOLT CIRCUITS SHALL UTILIZE A SEPARATE NEUTRAL.
- 9. ALL CONDUITS SERVING 120 VOLTS OR GREATER SHALL INCLUDE A GROUND WIRE.
- 10. ALL CONDUITS SHALL BE ROUTED CONCEALED UNLESS NOTED OTHERWISE.
- 11. ALL RECEPTACLES INSTALLED IN THE ELEVATOR PIT(S), ELEVATOR MACHINE ROOM(S), CONTROL ROOM(S)/SPACE(S) SHALL BE GROUND FAULT CIRCUIT
- INTERRUPTER TYPE (GFCI). 12. A DEDICATED SINGLE PHASE RECEPTACLE SUPPLYING A ELEVATOR PIT SUMP PUMP
- 13. ALL ELECTRICAL EQUIPMENT MOUNTED ON THE FLOOR SHALL BE MOUNTED ON A 4" CONCRETE HOUSE KEEPING PAD.
- 14. ALL FIRE ALARM DEVICES SHALL BE 15 CANDELA RATED UNLESS NOTED

POWER KEYED NOTES

- CONNECT NEW BOILER TO EXISTING PANEL DP-IT1. SEE PARTIAL ELECTRICAL ONE LINE DIAGRAM SHEET E3.00.
- CONNECT PUMP TO EXISTING PANEL DP-7. PROVIDE 20A FUSES IN EXISTING 60A, 3P SWITCH. SEE ELECTRICAL ONE LINE DIAGRAM SHEET E3.00.
- P3 CONNECT TO SPARE BREAKER IN EXISTING PANEL.

SHALL NOT BE A GFCI TYPE RECEPTACLE.

- P4 PROVIDE 120V CONNECTION AND ELECTRICAL ROUGH—IN FOR CARD READER. SEE DETAIL SHEET E3.00.
- P5 PROVIDE ROUGH—IN FOR FOR ADA PUSH PADS TO BE MOUNTED ON WALL. PROVIDE DUAL GANG JUNCTION BOXES FOR PUSHBUTTON AND 3/4"C INTERCONNECTING CONDUITS. COORDINATE REQUIREMENTS WITH DOOR HARDWARE CONSULTANT. ELECTRICAL CONTRACTOR TO MAKE FINAL ELECTRICAL CONNECTION.
- P6 PROVIDE 120V CONNECTION TO ADA ACTUATOR. COORDINATE REQUIREMENTS WITH DOOR HARDWARE CONSULTANT. ELECTRICAL CONTRACTOR TO MAKE FINAL ELECTRICAL CONNECTION.
- P7 INSTALL NEW 200A, 120/240V, 1 PH, 3W, 42 CIRCUIT PANELBOARD "Y" IN EXISTING LOCATION. PROVIDE BREAKERS AS NECESSARY TO RE-CONNECT EXISTING LOADS PLUS ONE 20A, 1P BREAKER FOR NEW SITE LIGHTING CIRCUIT.
- P8 PROVIDE 30A, 2P LIGHTING CONTACTOR AND ASTRONOMIC TIME CLOCK FOR CONTROL OF NEW SITE LIGHTING.
- P9 INSTALL NEW 200A, 120/240V, 1 PH, 3W, 42 CIRCUIT PANELBOARD "GA" IN EXISTING LOCATION. PROVIDE BREAKERS AS NECESSARY TO RE-CONNECT EXISTING INSTALL NEW 100A, 120/240V, 3 PH, 3W, 30 CIRCUIT PANELBOARD "GB" IN EXISTING LOCATION. PROVIDE BREAKERS AS NECESSARY TO RE-CONNECT EXISTING
- P1) PROVIDE (2) LIGHTING CONTACTORS WITH HOA CONTROL FOR GYM LIGHT CIRCUITS.
- INSTALL NEW 200A, 120/240V, 1 PH, 3W, 30 CIRCUIT PANELBOARD "D" IN EXISTING LOCATION. PROVIDE BREAKERS AS NECESSARY TO RE-CONNECT EXISTING
- INSTALL NEW 200A, 120/240V, 1 PH, 3W, 30 CIRCUIT PANELBOARD "A" IN EXISTING LOCATION. PROVIDE BREAKERS AS NECESSARY TO RE-CONNECT EXISTING
- CONNECT TO EXISTING 30A, 3P SWITCH IN PANEL 'P4'. SEE ELECTRICAL ONE—LINE DIAGRAM SHEET E3.00 FOR MORE INFORMATION.
- CONNECT TO EXISTING CIRCUIT AND WIRING FROM EQUIPMENT PREVIOUSLY REMOVED.
- CONNECT TO SPARE 200A, 3P SWITCH IN EXISITING DISTRIBUTION PANEL DP-4. PROVIDE NEW 60A FUSES. SEE ELECTRICAL ONE-LINE DIAGRAM SHEET E3.00 FOR MORE INFORMATION.
- PROVIDE FIRE ALARM SYSTEM CONNECTION TO FACTORY INSTALLED SMOKE DETECTOR ON MAKE-UP AIR UNIT MUA-1.
- PROVIDE POWER TO TEMPERATURE CONTROL UNIT TRANSFORMER. CONNECT TO NEAREST 120V RECEPTACLE CIRCUIT.
- P19 NEW FIRE ALARM DEVICE, CONNECT TO EXISTING NAC PANEL. NEW DEVICES SHALL BE COMPATIBLE WITH EXISTING SIMPLEX SYSTEM.
- DISCONNECT AND RE-CONNECT EXISTING MECHANICAL ROOFTOP UNIT. COORDINATE WITH MECHANICAL TRADES.
- (P21) INSTALL AND WIRE V.F.D. PROVIDED BY MECHANICAL CONTRACTOR. ELECTRICAL CONTRACTOR SHALL WIRE FROM THE UNIT TO THE REMOTE V.F.D. AND THEN BACK

ALL NEW 'EM' AND 'X' TYPE FIXTURES SHALL BE DIRECT REPLACEMENT OF EXISTING FIXTURE IN SIMILAR LOCATION.

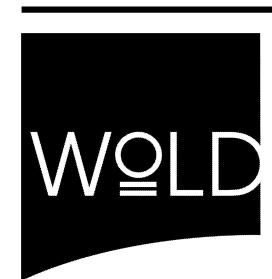
TO THE UNIT.

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REDFORD UNION SCHOOL **DISTRICT**

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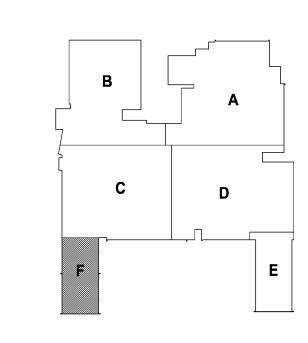


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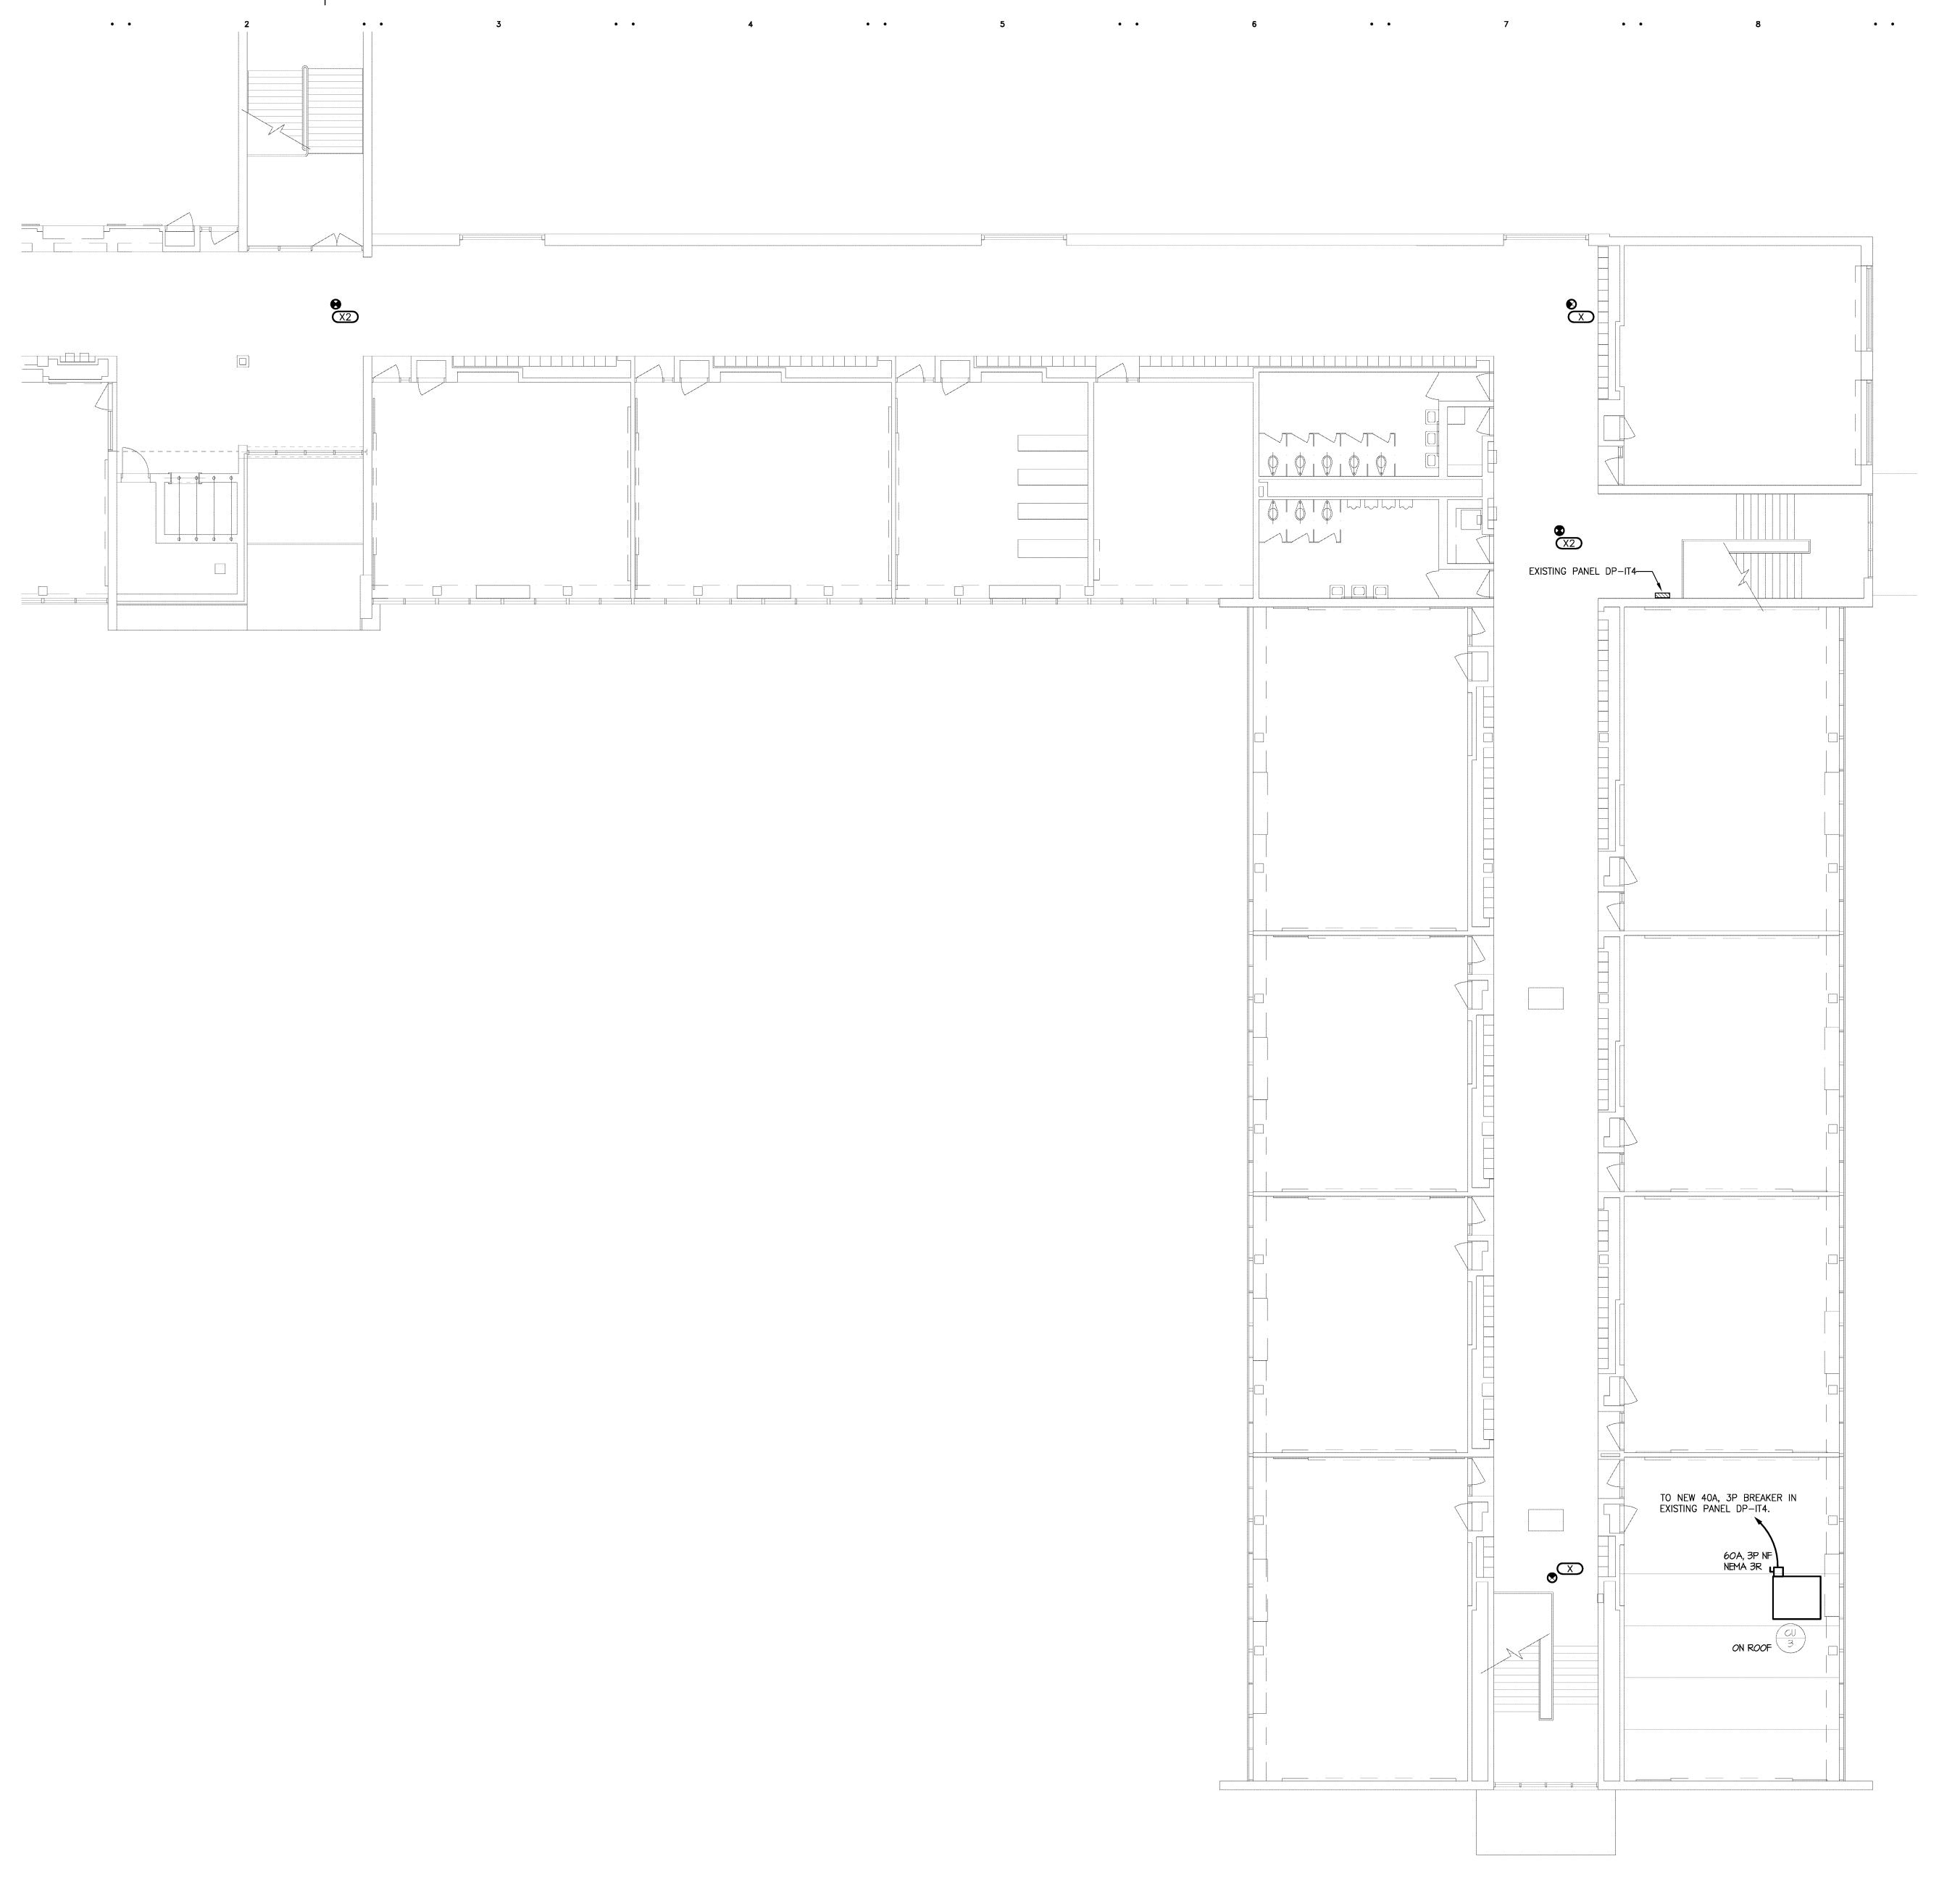
KEY PLAN

I hereby certify that this plan, specification or report was prepared by me or under my direct supervision and that I am a duly licensed under the laws of the State of MICHIGAN

Registration Number <u>6201049879</u> Date <u>10/31/13</u>					
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	6201	Revisions Date	6201049879 Date 10/3		

Comm: <u>124021</u>

H.S. MAIN LEVEL **ELECTRICAL PLAN -**AREA 'F'



- 1. REFER TO ARCHITECTURAL REFLECTED CEILING PLAN FOR EXACT LOCATION OF ALL LIGHTING FIXTURES UNLESS OTHERWISE NOTED.
- 2. ANY 120 VOLT BRANCH CIRCUIT FEEDER LONGER THAN 75'-0" TO LAST DEVICE SHALL BE SIZED TO THE NEXT LARGER STANDARD AWG SIZE. E.C. SHALL FIELD VERIFY ALL LENGTHS OF FEEDERS.
- 3. SEE LUMINAIRE SCHEDULE ON SHEET E0.00
- 4. ALL ELECTRICAL DEVICES ON THIS SHEET SHALL BE NEW UNLESS OTHERWISE
- 5. EXIT LIGHTS AND EMERGENCY BATTERY UNITS SHALL BE UNCONTROLLED AND TIED
- AHEAD OF LOCAL AREA LIGHTING SWITCH, UNLESS CIRCUITED OTHERWISE.

6. WHERE MORE THAN ONE LIGHT SWITCH IS INDICATED TO BE INSTALLED AT THE

SAME LOCATION, THEY SHALL BE GROUPED UNDER ONE COMMON FACEPLATE.

LIGHTING KEYED NOTES

- REMOVE AND REPLACE LIGHT FIXTURES IN THIS AREA AS NECESSARY TO PERMIT INSTALLATION OF MECHANICAL PIPING. COORDINATE WITH MECHANICAL CONTRACTOR.
- NEW TROUBLE LIGHT WITH RETRACTABLE CORD, EXTEND EXISTING 120V CIRCUIT FROM LOCAL LIGHTING CIRCUITING. EXACT SPECIFICATIONS BY OTHERS.
- RETROFIT EXISTING LIGHT FIXTURE WITH 1100 LUMEN EMERGENCY BATTERY PACK

GENERAL POWER NOTES

- 1. ALL ELECTRICAL DEVICES SHOWN ON THIS PLAN SHALL BE NEW UNLESS OTHERWISE NOTED.
- 2. ANY 120 VOLT BRANCH CIRCUIT FEEDER LONGER THAN 75'-0" TO LAST DEVICE
- SHALL BE SIZED TO THE NEXT LARGER STANDARD AWG SIZE. E.C. SHALL FIELD VERIFY ALL LENGTHS OF FEEDERS.
- 3. ALL RECEPTACLES SHALL BE 20A. RATED.

INTERRUPTER TYPE (GFCI).

4" CONCRETE HOUSE KEEPING PAD.

- 4. ALL DISCONNECT SWITCHES SHALL BE HEAVY DUTY TYPE.
- 5. ALL RECEPTACLES WITHIN 6'-0" OF SINK OR OTHER WATER SUPPLY SHALL BE
- GFCI TYPE RECEPTACLE. 6. REFER TO ARCHITECTURAL FLOOR PLAN AND ELEVATIONS FOR EXACT LOCATION OF
- 7. ALL JUNCTION BOXES SERVING BRANCH CIRCUIT WIRING SHALL BE LABELED WITH CIRCUITS SERVED.
- 8. ALL 120 VOLT CIRCUITS SHALL UTILIZE A SEPARATE NEUTRAL.
- 9. ALL CONDUITS SERVING 120 VOLTS OR GREATER SHALL INCLUDE A GROUND WIRE.
- 10. ALL CONDUITS SHALL BE ROUTED CONCEALED UNLESS NOTED OTHERWISE. 11. ALL RECEPTACLES INSTALLED IN THE ELEVATOR PIT(S), ELEVATOR MACHINE ROOM(S), CONTROL ROOM(S)/SPACE(S) SHALL BE GROUND FAULT CIRCUIT
- 12. A DEDICATED SINGLE PHASE RECEPTACLE SUPPLYING A ELEVATOR PIT SUMP PUMP
- SHALL NOT BE A GFCI TYPE RECEPTACLE. 13. ALL ELECTRICAL EQUIPMENT MOUNTED ON THE FLOOR SHALL BE MOUNTED ON A
- 14. ALL FIRE ALARM DEVICES SHALL BE 15 CANDELA RATED UNLESS NOTED

POWER KEYED NOTES

- CONNECT NEW BOILER TO EXISTING PANEL DP-IT1. SEE PARTIAL ELECTRICAL ONE LINE DIAGRAM SHEET E3.00.
- CONNECT PUMP TO EXISTING PANEL DP-7. PROVIDE 20A FUSES IN EXISTING 60A, 3P SWITCH. SEE ELECTRICAL ONE LINE DIAGRAM SHEET E3.00.
- (P3) CONNECT TO SPARE BREAKER IN EXISTING PANEL.
- PROVIDE 120V CONNECTION AND ELECTRICAL ROUGH—IN FOR CARD READER. SEE DETAIL SHEET E3.00.
- PS PROVIDE ROUGH—IN FOR FOR ADA PUSH PADS TO BE MOUNTED ON WALL. PROVIDE DUAL GANG JUNCTION BOXES FOR PUSHBUTTON AND 3/4"C INTERCONNECTING CONDUITS. COORDINATE REQUIREMENTS WITH DOOR HARDWARE CONSULTANT. ELECTRICAL CONTRACTOR TO MAKE FINAL ELECTRICAL CONNECTION.
- P6 PROVIDE 120V CONNECTION TO ADA ACTUATOR. COORDINATE REQUIREMENTS WITH DOOR HARDWARE CONSULTANT. ELECTRICAL CONTRACTOR TO MAKE FINAL
- ELECTRICAL CONNECTION. P7 INSTALL NEW 200A, 120/240V, 1 PH, 3W, 42 CIRCUIT PANELBOARD "Y" IN EXISTING LOCATION. PROVIDE BREAKERS AS NECESSARY TO RE-CONNECT EXISTING

LOADS PLUS ONE 20A, 1P BREAKER FOR NEW SITE LIGHTING CIRCUIT.

- P8 PROVIDE 30A, 2P LIGHTING CONTACTOR AND ASTRONOMIC TIME CLOCK FOR CONTROL OF NEW SITE LIGHTING.
- P9 INSTALL NEW 200A, 120/240V, 1 PH, 3W, 42 CIRCUIT PANELBOARD "GA" IN EXISTING LOCATION. PROVIDE BREAKERS AS NECESSARY TO RE-CONNECT EXISTING
- P10 INSTALL NEW 100A, 120/240V, 3 PH, 3W, 30 CIRCUIT PANELBOARD "GB" IN EXISTING LOCATION. PROVIDE BREAKERS AS NECESSARY TO RE-CONNECT EXISTING
- P1 NOT USED.
- INSTALL NEW 200A, 120/240V, 1 PH, 3W, 30 CIRCUIT PANELBOARD "D" IN EXISTING LOCATION. PROVIDE BREAKERS AS NECESSARY TO RE-CONNECT EXISTING
- INSTALL NEW 200A, 120/240V, 1 PH, 3W, 30 CIRCUIT PANELBOARD "A" IN EXISTING LOCATION. PROVIDE BREAKERS AS NECESSARY TO RE-CONNECT EXISTING
- CONNECT TO EXISTING 30A, 3P SWITCH IN PANEL 'P4'. SEE ELECTRICAL ONE—LINE DIAGRAM SHEET E3.00 FOR MORE INFORMATION.
- CONNECT TO EXISTING CIRCUIT AND WIRING FROM EQUIPMENT PREVIOUSLY REMOVED.
- CONNECT TO SPARE 200A, 3P SWITCH IN EXISITING DISTRIBUTION PANEL DP-4.
 PROVIDE NEW 60A FUSES. SEE ELECTRICAL ONE-LINE DIAGRAM SHEET E3.00 FOR MORE INFORMATION.
- PROVIDE FIRE ALARM SYSTEM CONNECTION TO FACTORY INSTALLED SMOKE DETECTOR ON MAKE-UP AIR UNIT MUA-1.
- PROVIDE POWER TO TEMPERATURE CONTROL UNIT TRANSFORMER. CONNECT TO NEAREST 120V RECEPTACLE CIRCUIT.

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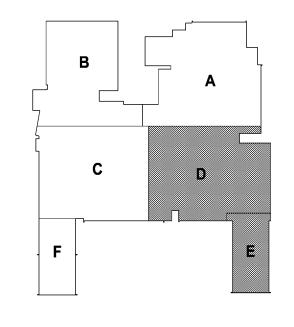
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KEY PLAN

I hereby certify that this plan, specification or report was prepared by me or under my direct supervision and that I am a duly licensed ENGINEER under the laws of the State of MICHIGAN

Fares Abdallah Registration Number 6201049879 Date 10/31/13 Description

Comm: 124021

UPPER LEVEL

LIGHTING AND POWER PLAN - AREAS 'D' AND 'E'

E1.21h

- 1. REFER TO ARCHITECTURAL REFLECTED CEILING PLAN FOR EXACT LOCATION OF ALL LIGHTING FIXTURES UNLESS OTHERWISE NOTED.
- 2. ANY 120 VOLT BRANCH CIRCUIT FEEDER LONGER THAN 75'-0" TO LAST DEVICE SHALL BE SIZED TO THE NEXT LARGER STANDARD AWG SIZE. E.C. SHALL FIELD VERIFY ALL LENGTHS OF FEEDERS.
- 3. SEE LUMINAIRE SCHEDULE ON SHEET E0.00
- 4. ALL ELECTRICAL DEVICES ON THIS SHEET SHALL BE NEW UNLESS OTHERWISE
- 5. EXIT LIGHTS AND EMERGENCY BATTERY UNITS SHALL BE UNCONTROLLED AND TIED
- AHEAD OF LOCAL AREA LIGHTING SWITCH, UNLESS CIRCUITED OTHERWISE. 6. WHERE MORE THAN ONE LIGHT SWITCH IS INDICATED TO BE INSTALLED AT THE

SAME LOCATION, THEY SHALL BE GROUPED UNDER ONE COMMON FACEPLATE.

LIGHTING KEYED NOTES

- REMOVE AND REPLACE LIGHT FIXTURES IN THIS AREA AS NECESSARY TO PERMIT INSTALLATION OF MECHANICAL PIPING. COORDINATE WITH MECHANICAL CONTRACTOR.
- NEW TROUBLE LIGHT WITH RETRACTABLE CORD, EXTEND EXISTING 120V CIRCUIT FROM LOCAL LIGHTING CIRCUITING. EXACT SPECIFICATIONS BY OTHERS.
- RETROFIT EXISTING LIGHT FIXTURE WITH 1100 LUMEN EMERGENCY BATTERY PACK.

GENERAL POWER NOTES

- 1. ALL ELECTRICAL DEVICES SHOWN ON THIS PLAN SHALL BE NEW UNLESS
- OTHERWISE NOTED.
- 2. ANY 120 VOLT BRANCH CIRCUIT FEEDER LONGER THAN 75'-0" TO LAST DEVICE SHALL BE SIZED TO THE NEXT LARGER STANDARD AWG SIZE. E.C. SHALL FIELD VERIFY ALL LENGTHS OF FEEDERS.
- 3. ALL RECEPTACLES SHALL BE 20A. RATED.

INTERRUPTER TYPE (GFCI).

- 4. ALL DISCONNECT SWITCHES SHALL BE HEAVY DUTY TYPE.
- 5. ALL RECEPTACLES WITHIN 6'-0" OF SINK OR OTHER WATER SUPPLY SHALL BE GFCI TYPE RECEPTACLE.
- 6. REFER TO ARCHITECTURAL FLOOR PLAN AND ELEVATIONS FOR EXACT LOCATION OF
- 7. ALL JUNCTION BOXES SERVING BRANCH CIRCUIT WIRING SHALL BE LABELED WITH CIRCUITS SERVED.
- 8. ALL 120 VOLT CIRCUITS SHALL UTILIZE A SEPARATE NEUTRAL.
- 9. ALL CONDUITS SERVING 120 VOLTS OR GREATER SHALL INCLUDE A GROUND WIRE.
- 10. ALL CONDUITS SHALL BE ROUTED CONCEALED UNLESS NOTED OTHERWISE. 11. ALL RECEPTACLES INSTALLED IN THE ELEVATOR PIT(S), ELEVATOR MACHINE ROOM(S), CONTROL ROOM(S)/SPACE(S) SHALL BE GROUND FAULT CIRCUIT
- 12. A DEDICATED SINGLE PHASE RECEPTACLE SUPPLYING A ELEVATOR PIT SUMP PUMP SHALL NOT BE A GFCI TYPE RECEPTACLE.
- 13. ALL ELECTRICAL EQUIPMENT MOUNTED ON THE FLOOR SHALL BE MOUNTED ON A 4" CONCRETE HOUSE KEEPING PAD.
- 14. ALL FIRE ALARM DEVICES SHALL BE 15 CANDELA RATED UNLESS NOTED OTHERWISE.

POWER KEYED NOTES

- CONNECT NEW BOILER TO EXISTING PANEL DP-IT1. SEE PARTIAL ELECTRICAL ONE LINE DIAGRAM SHEET E3.00.
- CONNECT PUMP TO EXISTING PANEL DP-7. PROVIDE 20A FUSES IN EXISTING 60A, 3P SWITCH. SEE ELECTRICAL ONE LINE DIAGRAM SHEET E3.00.
- P3 CONNECT TO SPARE BREAKER IN EXISTING PANEL.
- PROVIDE 120V CONNECTION AND ELECTRICAL ROUGH—IN FOR CARD READER. SEE DETAIL SHEET E3.00.
- P5 PROVIDE ROUGH—IN FOR FOR ADA PUSH PADS TO BE MOUNTED ON WALL. PROVIDE DUAL GANG JUNCTION BOXES FOR PUSHBUTTON AND 3/4"C INTERCONNECTING CONDUITS. COORDINATE REQUIREMENTS WITH DOOR HARDWARE CONSULTANT. ELECTRICAL CONTRACTOR TO MAKE FINAL ELECTRICAL CONNECTION.
- P6 PROVIDE 120V CONNECTION TO ADA ACTUATOR. COORDINATE REQUIREMENTS WITH DOOR HARDWARE CONSULTANT. ELECTRICAL CONTRACTOR TO MAKE FINAL
- P7 INSTALL NEW 200A, 120/240V, 1 PH, 3W, 42 CIRCUIT PANELBOARD "Y" IN EXISTING LOCATION. PROVIDE BREAKERS AS NECESSARY TO RE-CONNECT EXISTING LOADS PLUS ONE 20A, 1P BREAKER FOR NEW SITE LIGHTING CIRCUIT.
- PROVIDE 30A, 2P LIGHTING CONTACTOR AND ASTRONOMIC TIME CLOCK FOR CONTROL OF NEW SITE LIGHTING.
- P9 INSTALL NEW 200A, 120/240V, 1 PH, 3W, 42 CIRCUIT PANELBOARD "GA" IN EXISTING LOCATION. PROVIDE BREAKERS AS NECESSARY TO RE—CONNECT EXISTING
- INSTALL NEW 100A, 120/240V, 3 PH, 3W, 30 CIRCUIT PANELBOARD "GB" IN

EXISTING LOCATION. PROVIDE BREAKERS AS NECESSARY TO RE-CONNECT EXISTING

(P1) NOT USED.

ELECTRICAL CONNECTION.

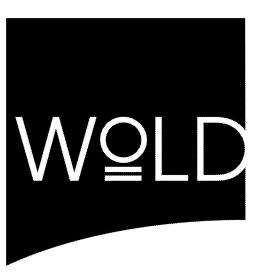
- INSTALL NEW 200A, 120/240V, 1 PH, 3W, 30 CIRCUIT PANELBOARD "D" IN EXISTING LOCATION. PROVIDE BREAKERS AS NECESSARY TO RE—CONNECT EXISTING
- INSTALL NEW 200A, 120/240V, 1 PH, 3W, 30 CIRCUIT PANELBOARD "A" IN EXISTING LOCATION. PROVIDE BREAKERS AS NECESSARY TO RE—CONNECT EXISTING
- CONNECT TO EXISTING 30A, 3P SWITCH IN PANEL 'P4'. SEE ELECTRICAL ONE-LINE DIAGRAM SHEET E3.00 FOR MORE INFORMATION.
- CONNECT TO EXISTING CIRCUIT AND WIRING FROM EQUIPMENT PREVIOUSLY REMOVED.
- CONNECT TO SPARE 200A, 3P SWITCH IN EXISITING DISTRIBUTION PANEL DP-4. PROVIDE NEW 60A FUSES. SEE ELECTRICAL ONE-LINE DIAGRAM SHEET E3.00 FOR MORE INFORMATION.
- PROVIDE FIRE ALARM SYSTEM CONNECTION TO FACTORY INSTALLED SMOKE DETECTOR ON MAKE-UP AIR UNIT MUA-1.
- PROVIDE POWER TO TEMPERATURE CONTROL UNIT TRANSFORMER. CONNECT TO NEAREST 120V RECEPTACLE CIRCUIT.

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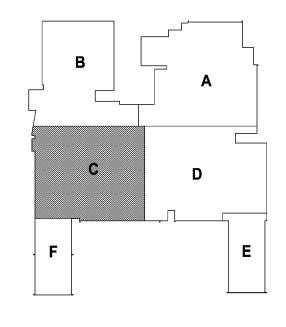
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KEY PLAN

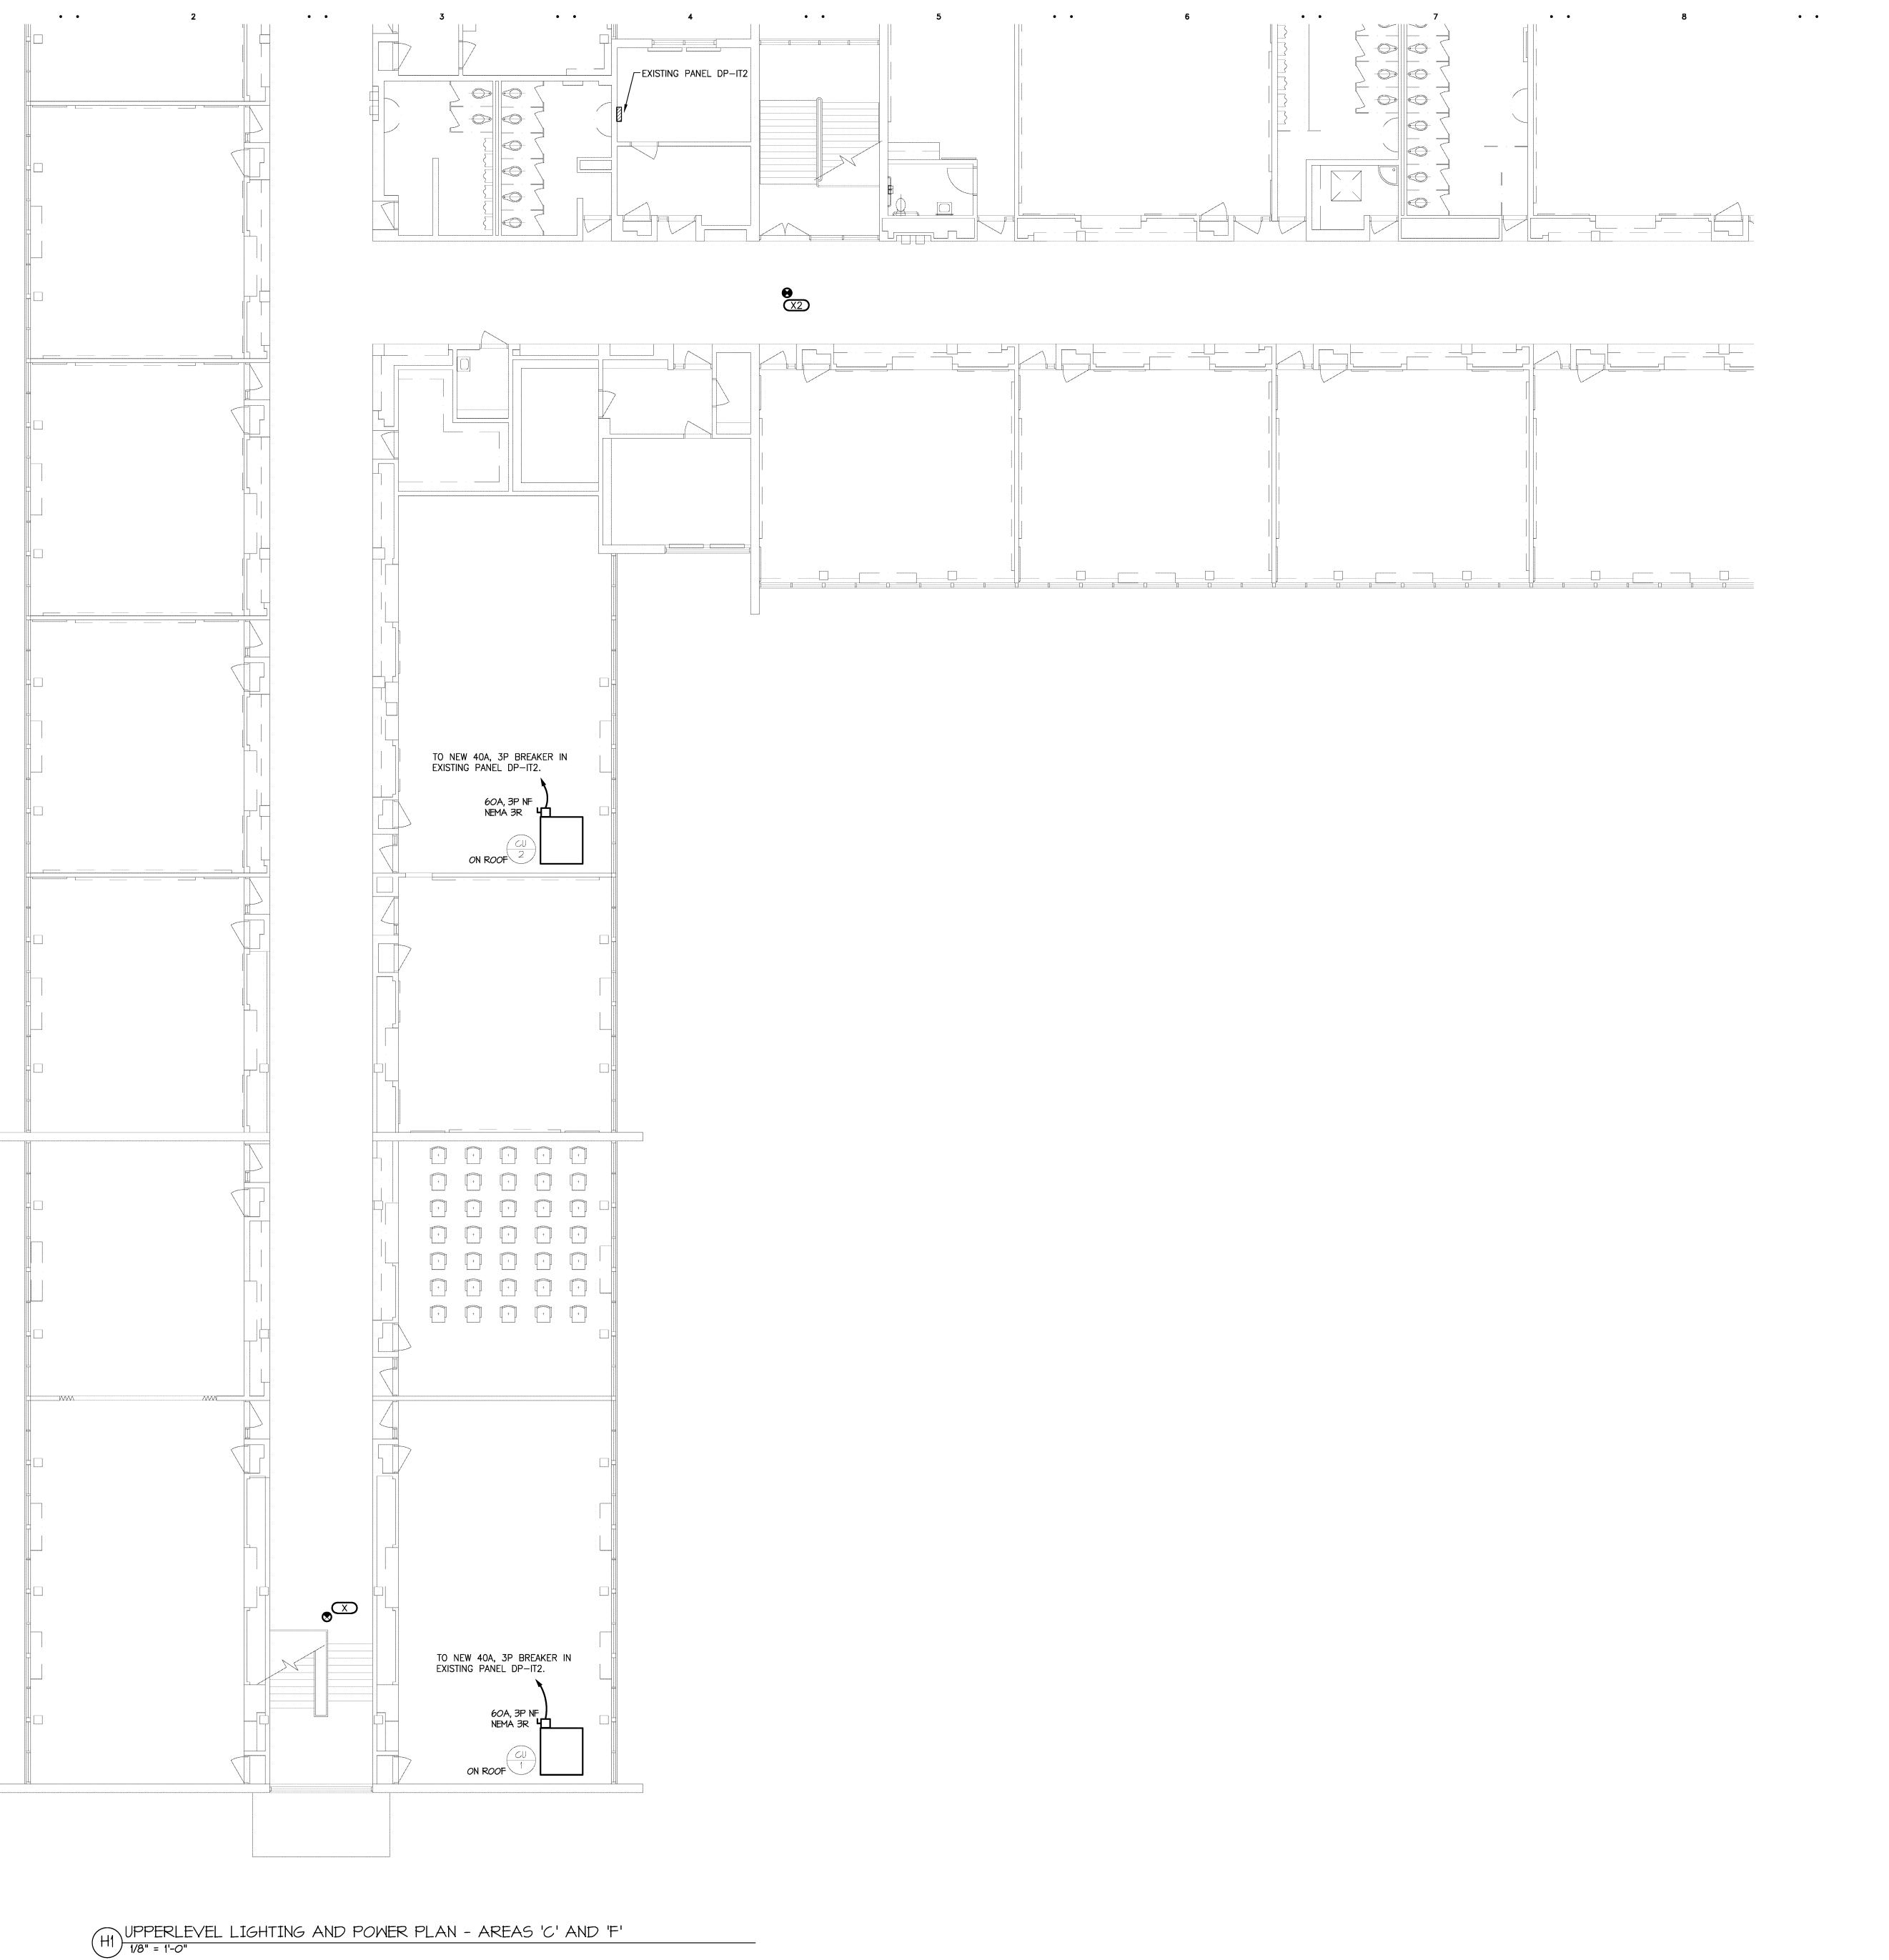
I hereby certify that this plan, specification or report was prepared by me or under my direct supervision and that I am a duly licensed under the laws of the State of MICHIGAN

Registration Number <u>6201049879</u> Date <u>10/31/13</u> Description

Comm: <u>124021</u>

UPPER LEVEL LIGHTING AND POWER PLAN - AREA 'C'

E1.22h



GENERAL LIGHTING NOTES

- 1. REFER TO ARCHITECTURAL REFLECTED CEILING PLAN FOR EXACT LOCATION OF ALL LIGHTING FIXTURES UNLESS OTHERWISE NOTED.
- 2. ANY 120 VOLT BRANCH CIRCUIT FEEDER LONGER THAN 75'-0" TO LAST DEVICE SHALL BE SIZED TO THE NEXT LARGER STANDARD AWG SIZE. E.C. SHALL FIELD
- VERIFY ALL LENGTHS OF FEEDERS.
- 3. SEE LUMINAIRE SCHEDULE ON SHEET E0.00
- 4. ALL ELECTRICAL DEVICES ON THIS SHEET SHALL BE NEW UNLESS OTHERWISE
- 5. EXIT LIGHTS AND EMERGENCY BATTERY UNITS SHALL BE UNCONTROLLED AND TIED AHEAD OF LOCAL AREA LIGHTING SWITCH, UNLESS CIRCUITED OTHERWISE.
- 6. WHERE MORE THAN ONE LIGHT SWITCH IS INDICATED TO BE INSTALLED AT THE SAME LOCATION, THEY SHALL BE GROUPED UNDER ONE COMMON FACEPLATE.

LIGHTING KEYED NOTES

- REMOVE AND REPLACE LIGHT FIXTURES IN THIS AREA AS NECESSARY TO PERMIT INSTALLATION OF MECHANICAL PIPING. COORDINATE WITH MECHANICAL CONTRACTOR.
- NEW TROUBLE LIGHT WITH RETRACTABLE CORD, EXTEND EXISTING 120V CIRCUIT FROM LOCAL LIGHTING CIRCUITING. EXACT SPECIFICATIONS BY OTHERS.
- RETROFIT EXISTING LIGHT FIXTURE WITH 1100 LUMEN EMERGENCY BATTERY PACK.

GENERAL POWER NOTES

- 1. ALL ELECTRICAL DEVICES SHOWN ON THIS PLAN SHALL BE NEW UNLESS OTHERWISE NOTED.
- 2. ANY 120 VOLT BRANCH CIRCUIT FEEDER LONGER THAN 75'-0" TO LAST DEVICE SHALL BE SIZED TO THE NEXT LARGER STANDARD AWG SIZE. E.C. SHALL FIELD VERIFY ALL LENGTHS OF FEEDERS.
- 3. ALL RECEPTACLES SHALL BE 20A. RATED.
- 4. ALL DISCONNECT SWITCHES SHALL BE HEAVY DUTY TYPE.
- 5. ALL RECEPTACLES WITHIN 6'-0" OF SINK OR OTHER WATER SUPPLY SHALL BE GFCI TYPE RECEPTACLE.
- 6. REFER TO ARCHITECTURAL FLOOR PLAN AND ELEVATIONS FOR EXACT LOCATION OF
- 7. ALL JUNCTION BOXES SERVING BRANCH CIRCUIT WIRING SHALL BE LABELED WITH CIRCUITS SERVED.
- 8. ALL 120 VOLT CIRCUITS SHALL UTILIZE A SEPARATE NEUTRAL.
- 9. ALL CONDUITS SERVING 120 VOLTS OR GREATER SHALL INCLUDE A GROUND WIRE.
- 10. ALL CONDUITS SHALL BE ROUTED CONCEALED UNLESS NOTED OTHERWISE. 11. ALL RECEPTACLES INSTALLED IN THE ELEVATOR PIT(S), ELEVATOR MACHINE
- ROOM(S), CONTROL ROOM(S)/SPACE(S) SHALL BE GROUND FAULT CIRCUIT INTERRUPTER TYPE (GFCI).
- 12. A DEDICATED SINGLE PHASE RECEPTACLE SUPPLYING A ELEVATOR PIT SUMP PUMP SHALL NOT BE A GFCI TYPE RECEPTACLE.
- 13. ALL ELECTRICAL EQUIPMENT MOUNTED ON THE FLOOR SHALL BE MOUNTED ON A 4" CONCRETE HOUSE KEEPING PAD.
- 14. ALL FIRE ALARM DEVICES SHALL BE 15 CANDELA RATED UNLESS NOTED OTHERWISE.

POWER KEYED NOTES

- CONNECT NEW BOILER TO EXISTING PANEL DP-IT1. SEE PARTIAL ELECTRICAL ONE LINE DIAGRAM SHEET E3.00.
- CONNECT PUMP TO EXISTING PANEL DP-7. PROVIDE 20A FUSES IN EXISTING 60A, 3P SWITCH. SEE ELECTRICAL ONE LINE DIAGRAM SHEET E3.00.
- (P3) CONNECT TO SPARE BREAKER IN EXISTING PANEL.
- PROVIDE 120V CONNECTION AND ELECTRICAL ROUGH—IN FOR CARD READER. SEE DETAIL SHEET E3.00.
- P5 PROVIDE ROUGH—IN FOR FOR ADA PUSH PADS TO BE MOUNTED ON WALL. PROVIDE DUAL GANG JUNCTION BOXES FOR PUSHBUTTON AND 3/4"C INTERCONNECTING CONDUITS. COORDINATE REQUIREMENTS WITH DOOR HARDWARE CONSULTANT.
- ELECTRICAL CONTRACTOR TO MAKE FINAL ELECTRICAL CONNECTION. P6 PROVIDE 120V CONNECTION TO ADA ACTUATOR. COORDINATE REQUIREMENTS WITH
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- P8 PROVIDE 30A, 2P LIGHTING CONTACTOR AND ASTRONOMIC TIME CLOCK FOR CONTROL OF NEW SITE LIGHTING.
- P9 INSTALL NEW 200A, 120/240V, 1 PH, 3W, 42 CIRCUIT PANELBOARD "GA" IN EXISTING LOCATION. PROVIDE BREAKERS AS NECESSARY TO RE-CONNECT EXISTING
- INSTALL NEW 100A, 120/240V, 3 PH, 3W, 30 CIRCUIT PANELBOARD "GB" IN EXISTING LOCATION. PROVIDE BREAKERS AS NECESSARY TO RE-CONNECT EXISTING
- P1 NOT USED. install new 200A, 120/240V, 1 PH, 3W, 30 CIRCUIT PANELBOARD "D" IN EXISTING LOCATION. PROVIDE BREAKERS AS NECESSARY TO RE-CONNECT EXISTING
- INSTALL NEW 200A, 120/240V, 1 PH, 3W, 30 CIRCUIT PANELBOARD "A" IN EXISTING LOCATION. PROVIDE BREAKERS AS NECESSARY TO RE-CONNECT EXISTING
- CONNECT TO EXISTING 30A, 3P SWITCH IN PANEL 'P4'. SEE ELECTRICAL
- ONE-LINE DIAGRAM SHEET E3.00 FOR MORE INFORMATION. CONNECT TO EXISTING CIRCUIT AND WIRING FROM EQUIPMENT PREVIOUSLY REMOVED.
- CONNECT TO SPARE 200A, 3P SWITCH IN EXISITING DISTRIBUTION PANEL DP-4. PROVIDE NEW 60A FUSES. SEE ELECTRICAL ONE-LINE DIAGRAM SHEET E3.00 FOR MORE INFORMATION.
- PROVIDE FIRE ALARM SYSTEM CONNECTION TO FACTORY INSTALLED SMOKE DETECTOR ON MAKE-UP AIR UNIT MUA-1.
- PROVIDE POWER TO TEMPERATURE CONTROL UNIT TRANSFORMER. CONNECT TO NEAREST 120V RECEPTACLE CIRCUIT.

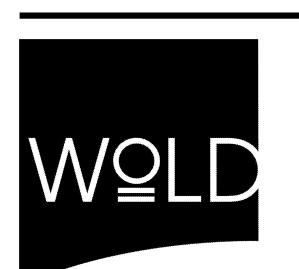
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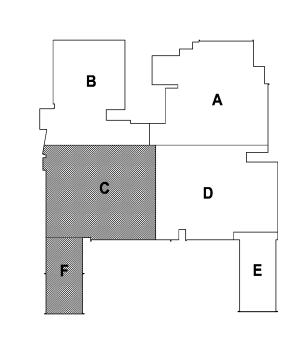
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KEY PLAN

I hereby certify that this plan, specification or report was prepared by me or under my direct supervision and that I am a duly licensed under the laws of the State of MICHIGAN

Fares Abdallah Registration Number <u>6201049879</u> Date <u>10/31/13</u> Description Date

Comm: 124021 Drawn: DAD

UPPER LEVEL LIGHTING AND POWER PLAN

- AREAS 'C' AND 'F'

E1.23h

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GENERAL DEMOLITION NOTES

- 1. VISIT THE SITE PRIOR TO SUBMISSION OF BID TO EXAMINE THE EXISTING CONDITIONS AND THE EXTENT OF DEMOLITION WORK.
- 2. EXAMINE THE DRAWINGS OF OTHER TRADES, BE FAMILIAR WITH THE DEMOLITION REQUIRED BY OTHER TRADES. PERFORM ALL INCIDENTAL ELECTRICAL DEMOLITION AND/OR RELOCATION OF DEVICES AND EQUIPMENT REQUIRED TO FACILITATE THE DEMOLITION WORK OF OTHER TRADES.
- 3. REMOVE LIGHTING FIXTURES AND ELECTRICAL DEVICES AS INDICATED ON PLAN. DEMOLITION SHALL INCLUDE, BUT NOT BE LIMITED TO THOSE DEVICES SHOWN.
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- 6. COORDINATE THE SHUT DOWN OF ELECTRICAL EQUIPMENT WITH THE OWNERS' REPRESENTATIVE A MINIMUM OF 72 HOURS PRIOR TO SHUT DOWN.
- 7. REMOVE ALL CONDUIT AND WIRE BACK TO NEAREST UPSTREAM DEVICE REMAINING IN SERVICE.
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- 14. REFER TO NEW WORK SHEETS FOR LIGHTING AND POWER CIRCUIT
- 15. EXTEND EXISTING CONDUIT AND WIRE AS REQUIRED FOR ALL RELOCATED
- 16. REPLACE EXIT SIGNS AND EMERGENCY BATTERY UNITS THAT ARE SHOWN HATCHED, REFER TO NEW WORK PLANS AND SCHEDULES FOR INFORMATION.

DEMOLITION KEYED NOTES

REMOVE EXISTING EXIT SIGN OR EMERGENCY LIGHT, REPLACE WITH NEW PER NEW WORK PLANS. DISCONNECT AND REMOVE EXISTING BUILDING MOUNTED EXTERIOR LIGHTING. PROTECT EXISTING CIRCUITING FOR INSTALLATION OF NEW FIXTURES AT SAME

LOCATION. SEE NEW WORK PLANS FOR ADDITIONAL INFORMATION.

REMOVE AND REINSTALL LIGHT FIXTURES IN THIS AREA AS NECESSARY TO PERMIT INSTALLATION OF MECHANICAL PIPING. COORDINATE WITH MECHANICAL

DISCONNECT EXISTING BOILER AND REMOVE DISCONNECT, CONDUIT AND WIRE COMPLETE BACK TO SOURCE.

DISCONNECT EXISTING CIRC. PUMPS AND REMOVE DISCONNECT, CONDUIT AND WIRE COMPLETE BACK TO THE SOURCE. DISCONNECT AND RECONNECT MECHANICAL ROOFTOP UNIT, COORDINATE WITH MECHANICAL TRADES.

REPLACE PANELBOARD "Y" IN EXISTING LOCATION. REFER TO NEW WORK PLANS

REPLACE PANELBOARD "GA" IN EXISTING LOCATION. REFER TO NEW WORK PLANS FOR DETAILS. REPLACE PANELBOARD "GB" IN EXISTING LOCATION. REFER TO NEW WORK PLANS FOR DETAILS.

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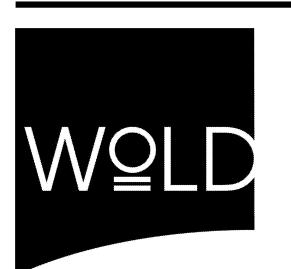
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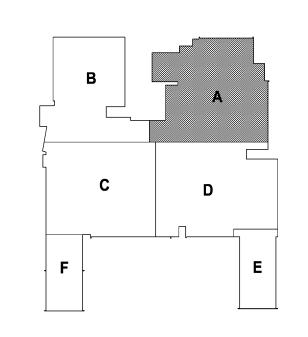
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Registration Number <u>6201049879</u> Date <u>10/31/13</u>

 Comm:
 124021

 Date:
 4/16/2013

 Drawn:
 DAD

H.S. MAIN LEVEL

ELECTRICAL DEMOLITION PLAN - AREA 'A'

ED1.11h

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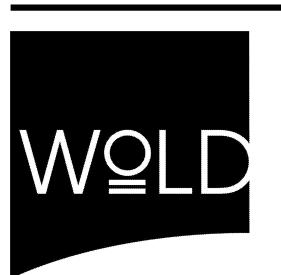
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REDFORD UNION SCHOOL

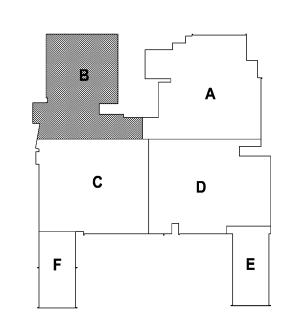
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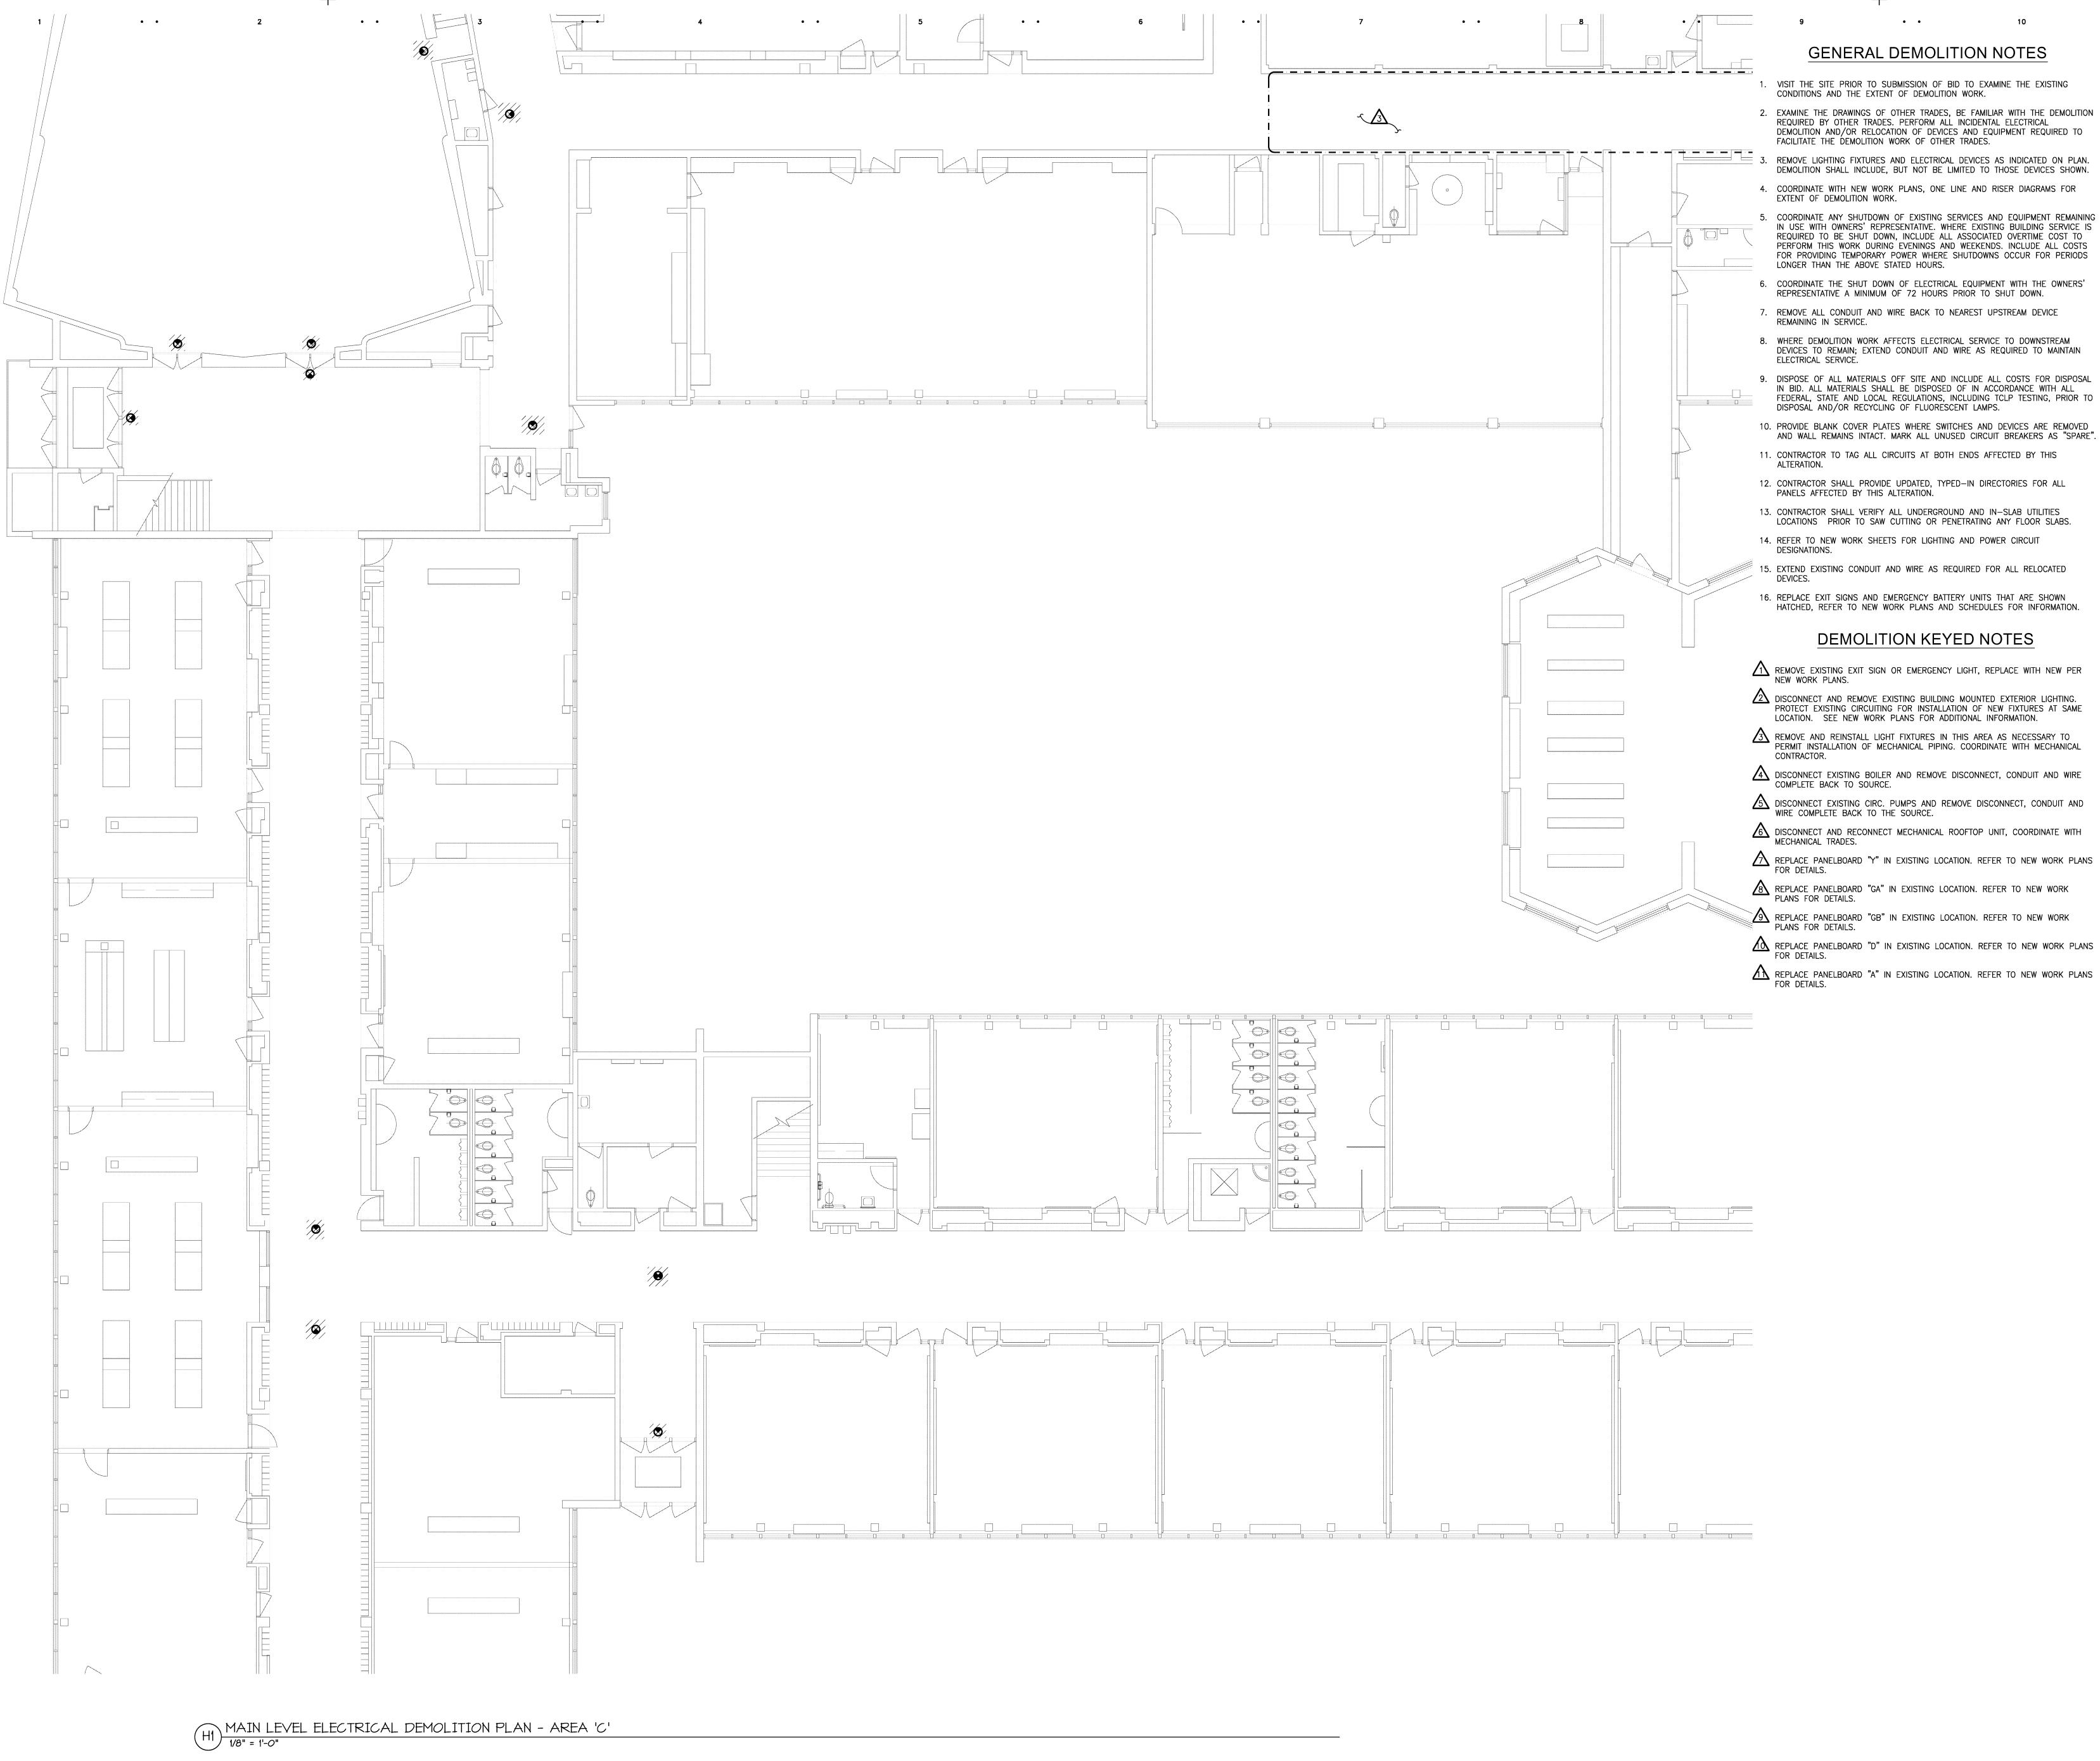
 Drawn:
 DAD

 Check:
 RSA

H.S. MAIN LEVEL ELECTRICAL PLAN -AREA 'B'

Scale:

ED1.12h

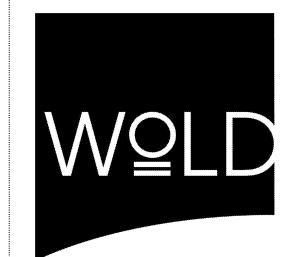


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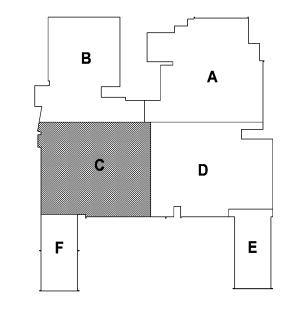
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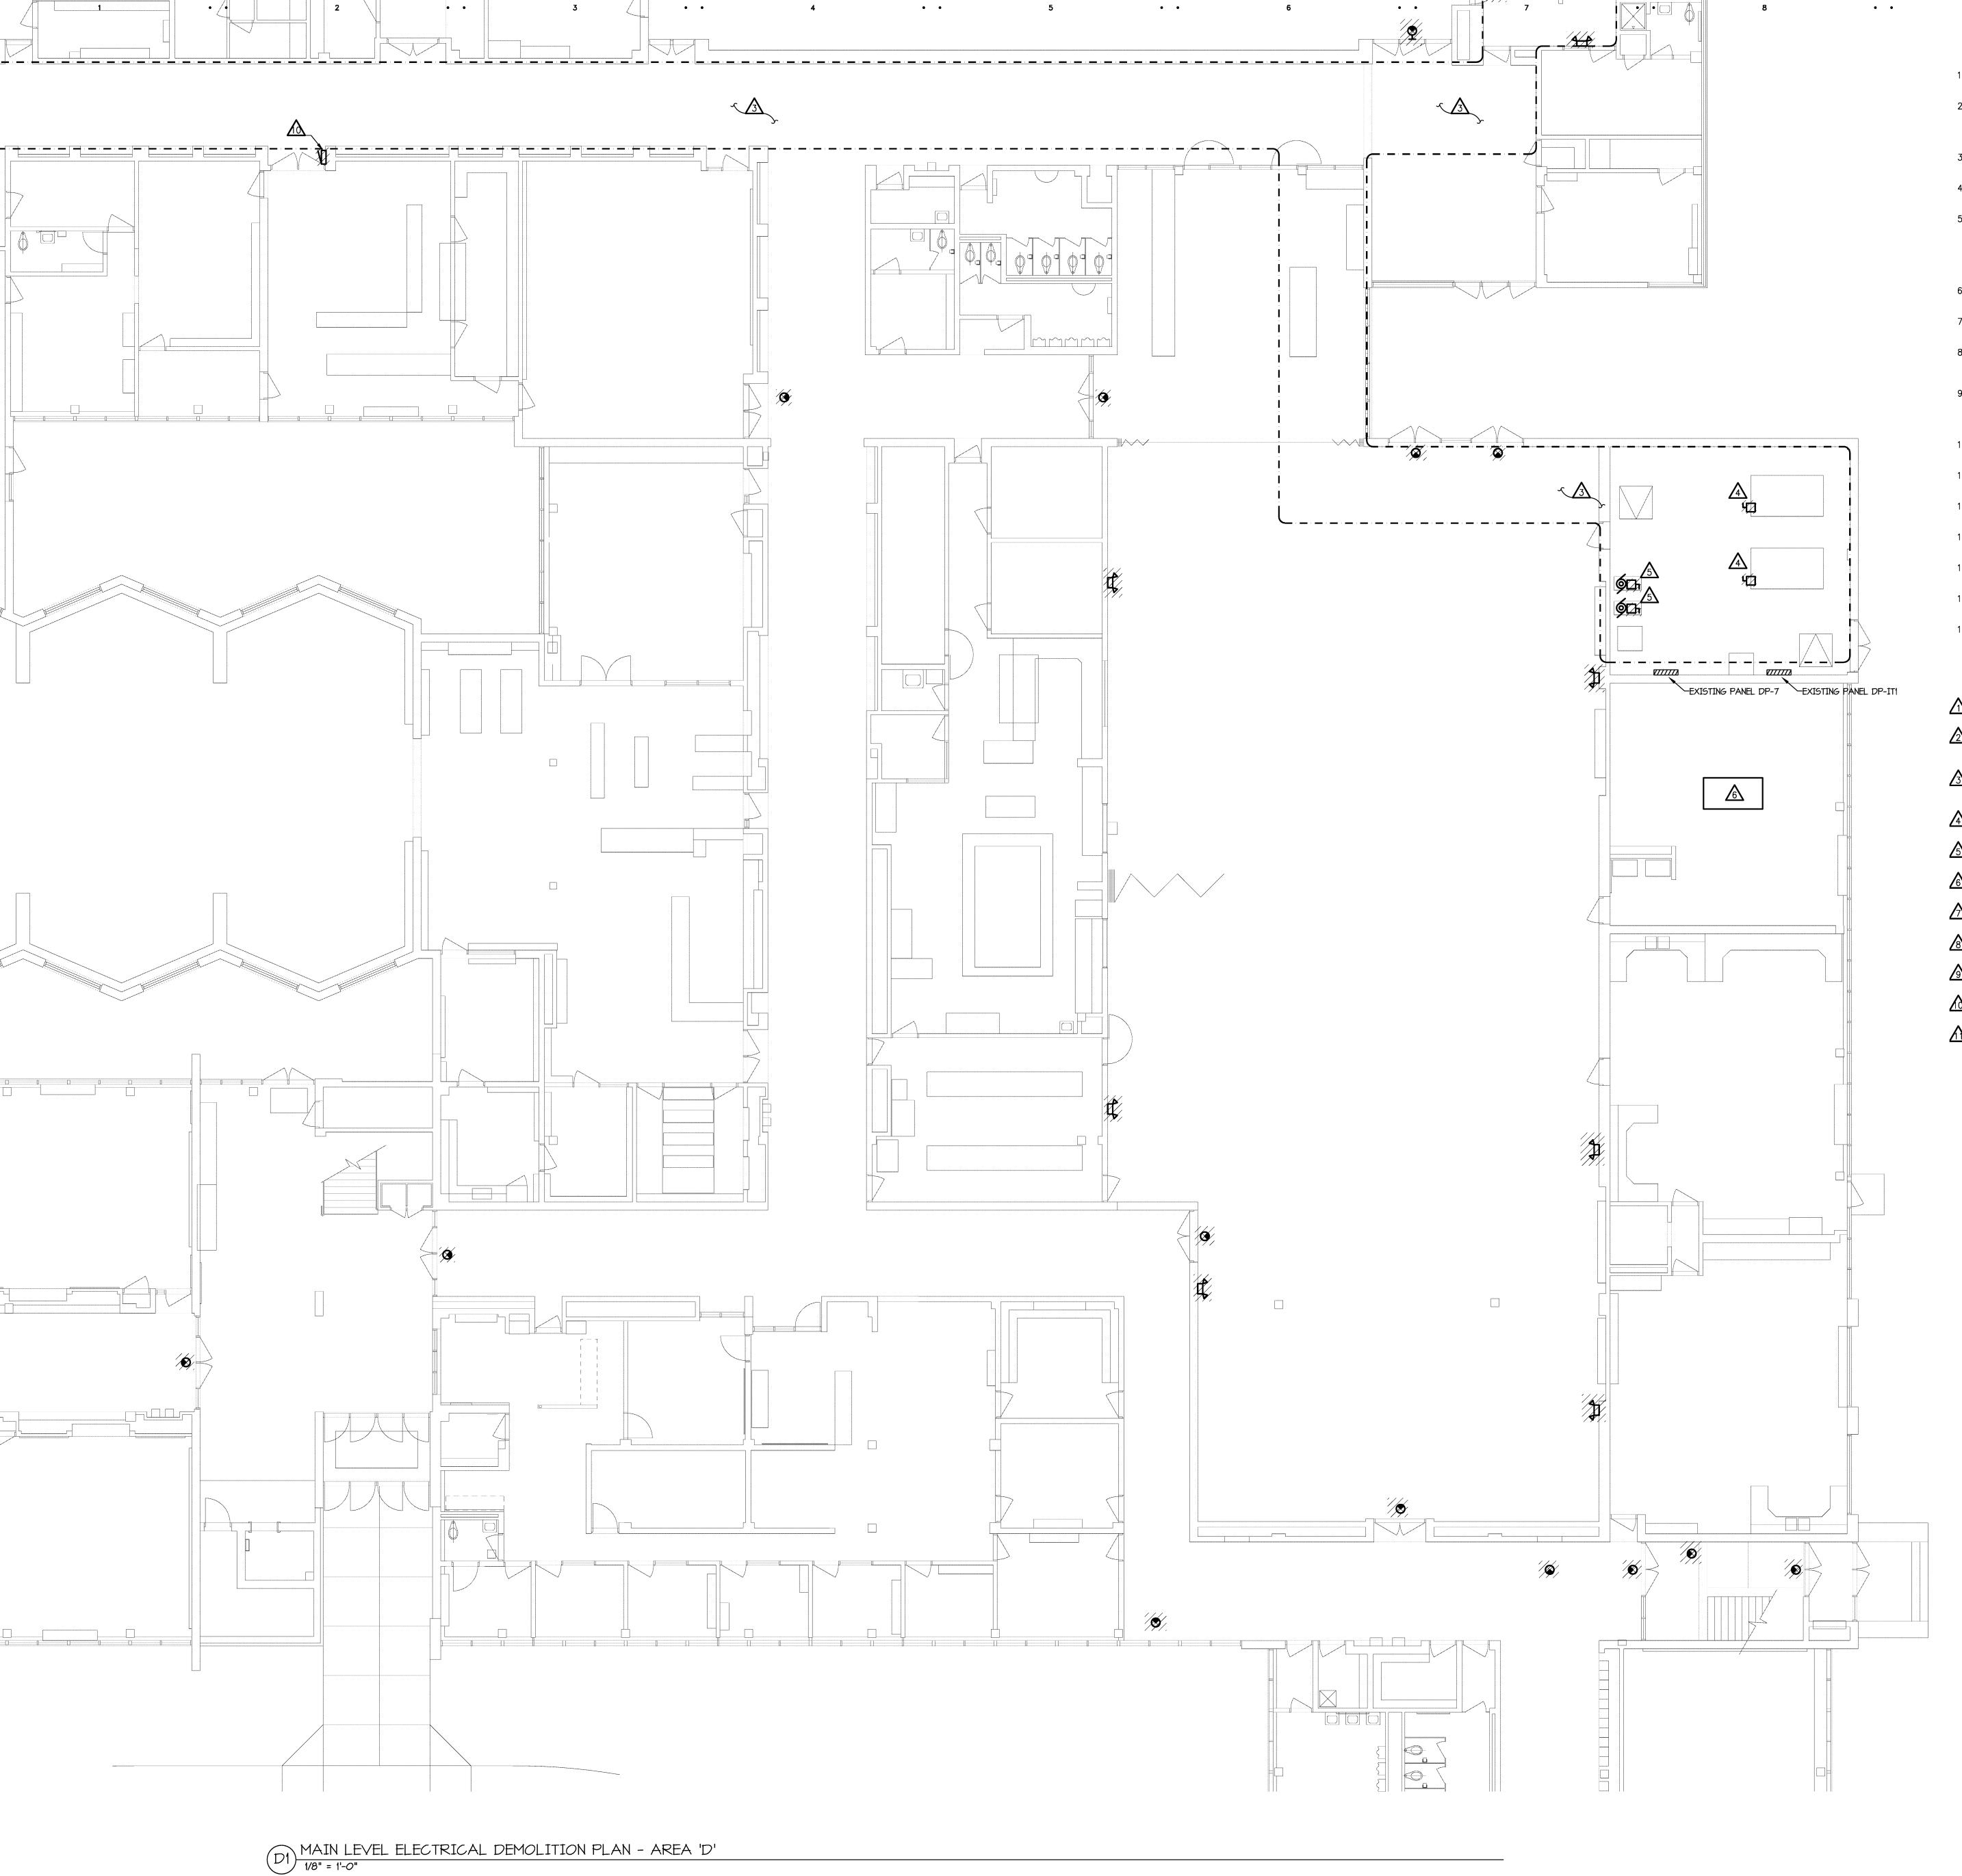
Registration Number <u>6201049879</u> Date <u>10/31/13</u>

Comm: <u>124021</u>

H.S. MAIN LEVEL

ELECTRICAL PLAN -AREA 'C'

ED1.13h



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DISCONNECT AND RECONNECT MECHANICAL ROOFTOP UNIT, COORDINATE WITH MECHANICAL TRADES.

REPLACE PANELBOARD "Y" IN EXISTING LOCATION REFER TO NEW WORK PLANS

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REPLACE PANELBOARD "A" IN EXISTING LOCATION. REFER TO NEW WORK PLANS FOR DETAILS.

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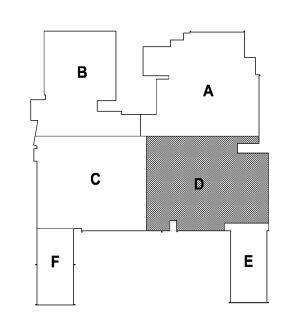
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Royal Oak, MI 48067

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mail@woldae.com



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KEY PLAN

Fares Abdallah
Registration Number 6201049879 Date 10/31/13

Revisions
Description Date Num

Comm: 124021

Date: 4/16/2013

Drawn: DAD

Drawn: DAD
Check: RSA

North

H.S. MAIN LEVEL

ELECTRICAL

DEMOLITION PLAN
AREA 'D'

Scale:

ED1.14h

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MAIN LEVEL ELECTRICAL DEMOLITION PLAN - AREA 'E'

GENERAL DEMOLITION NOTES

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PROTECT EXISTING CIRCUITING FOR INSTALLATION OF NEW FIXTURES AT SAME

REMOVE EXISTING EXIT SIGN OR EMERGENCY LIGHT, REPLACE WITH NEW PER NEW WORK PLANS.

DISCONNECT AND REMOVE EXISTING BUILDING MOUNTED EXTERIOR LIGHTING.

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CONTRACTOR.

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REPLACE PANELBOARD "Y" IN EXISTING LOCATION. REFER TO NEW WORK PLANS FOR DETAILS.

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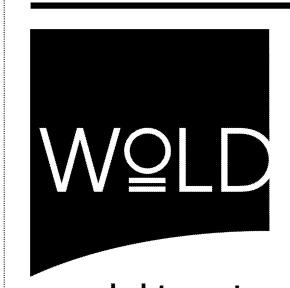
REPLACE PANELBOARD "A" IN EXISTING LOCATION. REFER TO NEW WORK PLANS FOR DETAILS.

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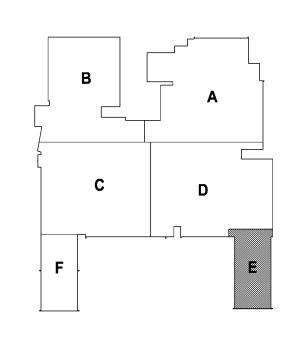
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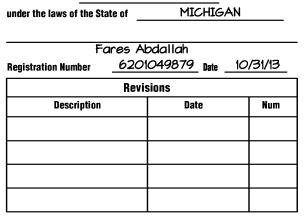




KEY PLAN

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under the laws of the State of MICHIGAN



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 4/16/2013

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 DAD

 Check:
 RSA

H.S. MAIN LEVEL ELECTRICAL DEMOLITION PLAN -AREA 'E'

Scale:

ED1.15h

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MAIN LEVEL ELECTRICAL DEMOLITION PLAN - AREA 'F'

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GENERAL DEMOLITION NOTES

VISIT THE SITE PRIOR TO SUBMISSION OF BID TO EXAMINE THE EXISTING CONDITIONS AND THE EXTENT OF DEMOLITION WORK.

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- 2. EXAMINE THE DRAWINGS OF OTHER TRADES, BE FAMILIAR WITH THE DEMOLITION REQUIRED BY OTHER TRADES. PERFORM ALL INCIDENTAL ELECTRICAL DEMOLITION AND/OR RELOCATION OF DEVICES AND EQUIPMENT REQUIRED TO FACILITATE THE DEMOLITION WORK OF OTHER TRADES.
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REMOVE AND REINSTALL LIGHT FIXTURES IN THIS AREA AS NECESSARY TO PERMIT INSTALLATION OF MECHANICAL PIPING. COORDINATE WITH MECHANICAL CONTRACTOR.

DISCONNECT EXISTING BOILER AND REMOVE DISCONNECT, CONDUIT AND WIRE COMPLETE BACK TO SOURCE.

DISCONNECT EXISTING CIRC. PUMPS AND REMOVE DISCONNECT, CONDUIT AND WIRE COMPLETE BACK TO THE SOURCE.

DISCONNECT AND RECONNECT MECHANICAL ROOFTOP UNIT, COORDINATE WITH MECHANICAL TRADES.

REPLACE PANELBOARD "Y" IN EXISTING LOCATION. REFER TO NEW WORK PLANS FOR DETAILS.

REPLACE PANELBOARD "GA" IN EXISTING LOCATION. REFER TO NEW WORK PLANS FOR DETAILS.

REPLACE PANELBOARD "GB" IN EXISTING LOCATION. REFER TO NEW WORK PLANS FOR DETAILS.

REPLACE PANELBOARD "D" IN EXISTING LOCATION. REFER TO NEW WORK PLANS FOR DETAILS.

REPLACE PANELBOARD "A" IN EXISTING LOCATION. REFER TO NEW WORK PLANS FOR DETAILS.

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REDFORD UNION SCHOOL

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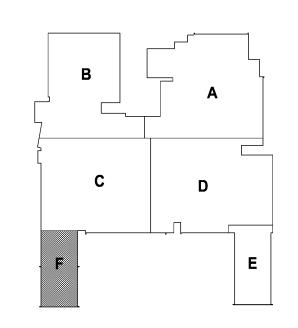


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333 West Seventh Street **tel** 248 284 0611 Suite 320 **fax** 248 284 0615



SES



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ENGINEER

under the laws of the State of MICHIGAN

Fares Abdallah
Registration Number 6201049879 Date 10/31/13

Revisions

Description Date Num

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 124021

 Date:
 4/16/2013

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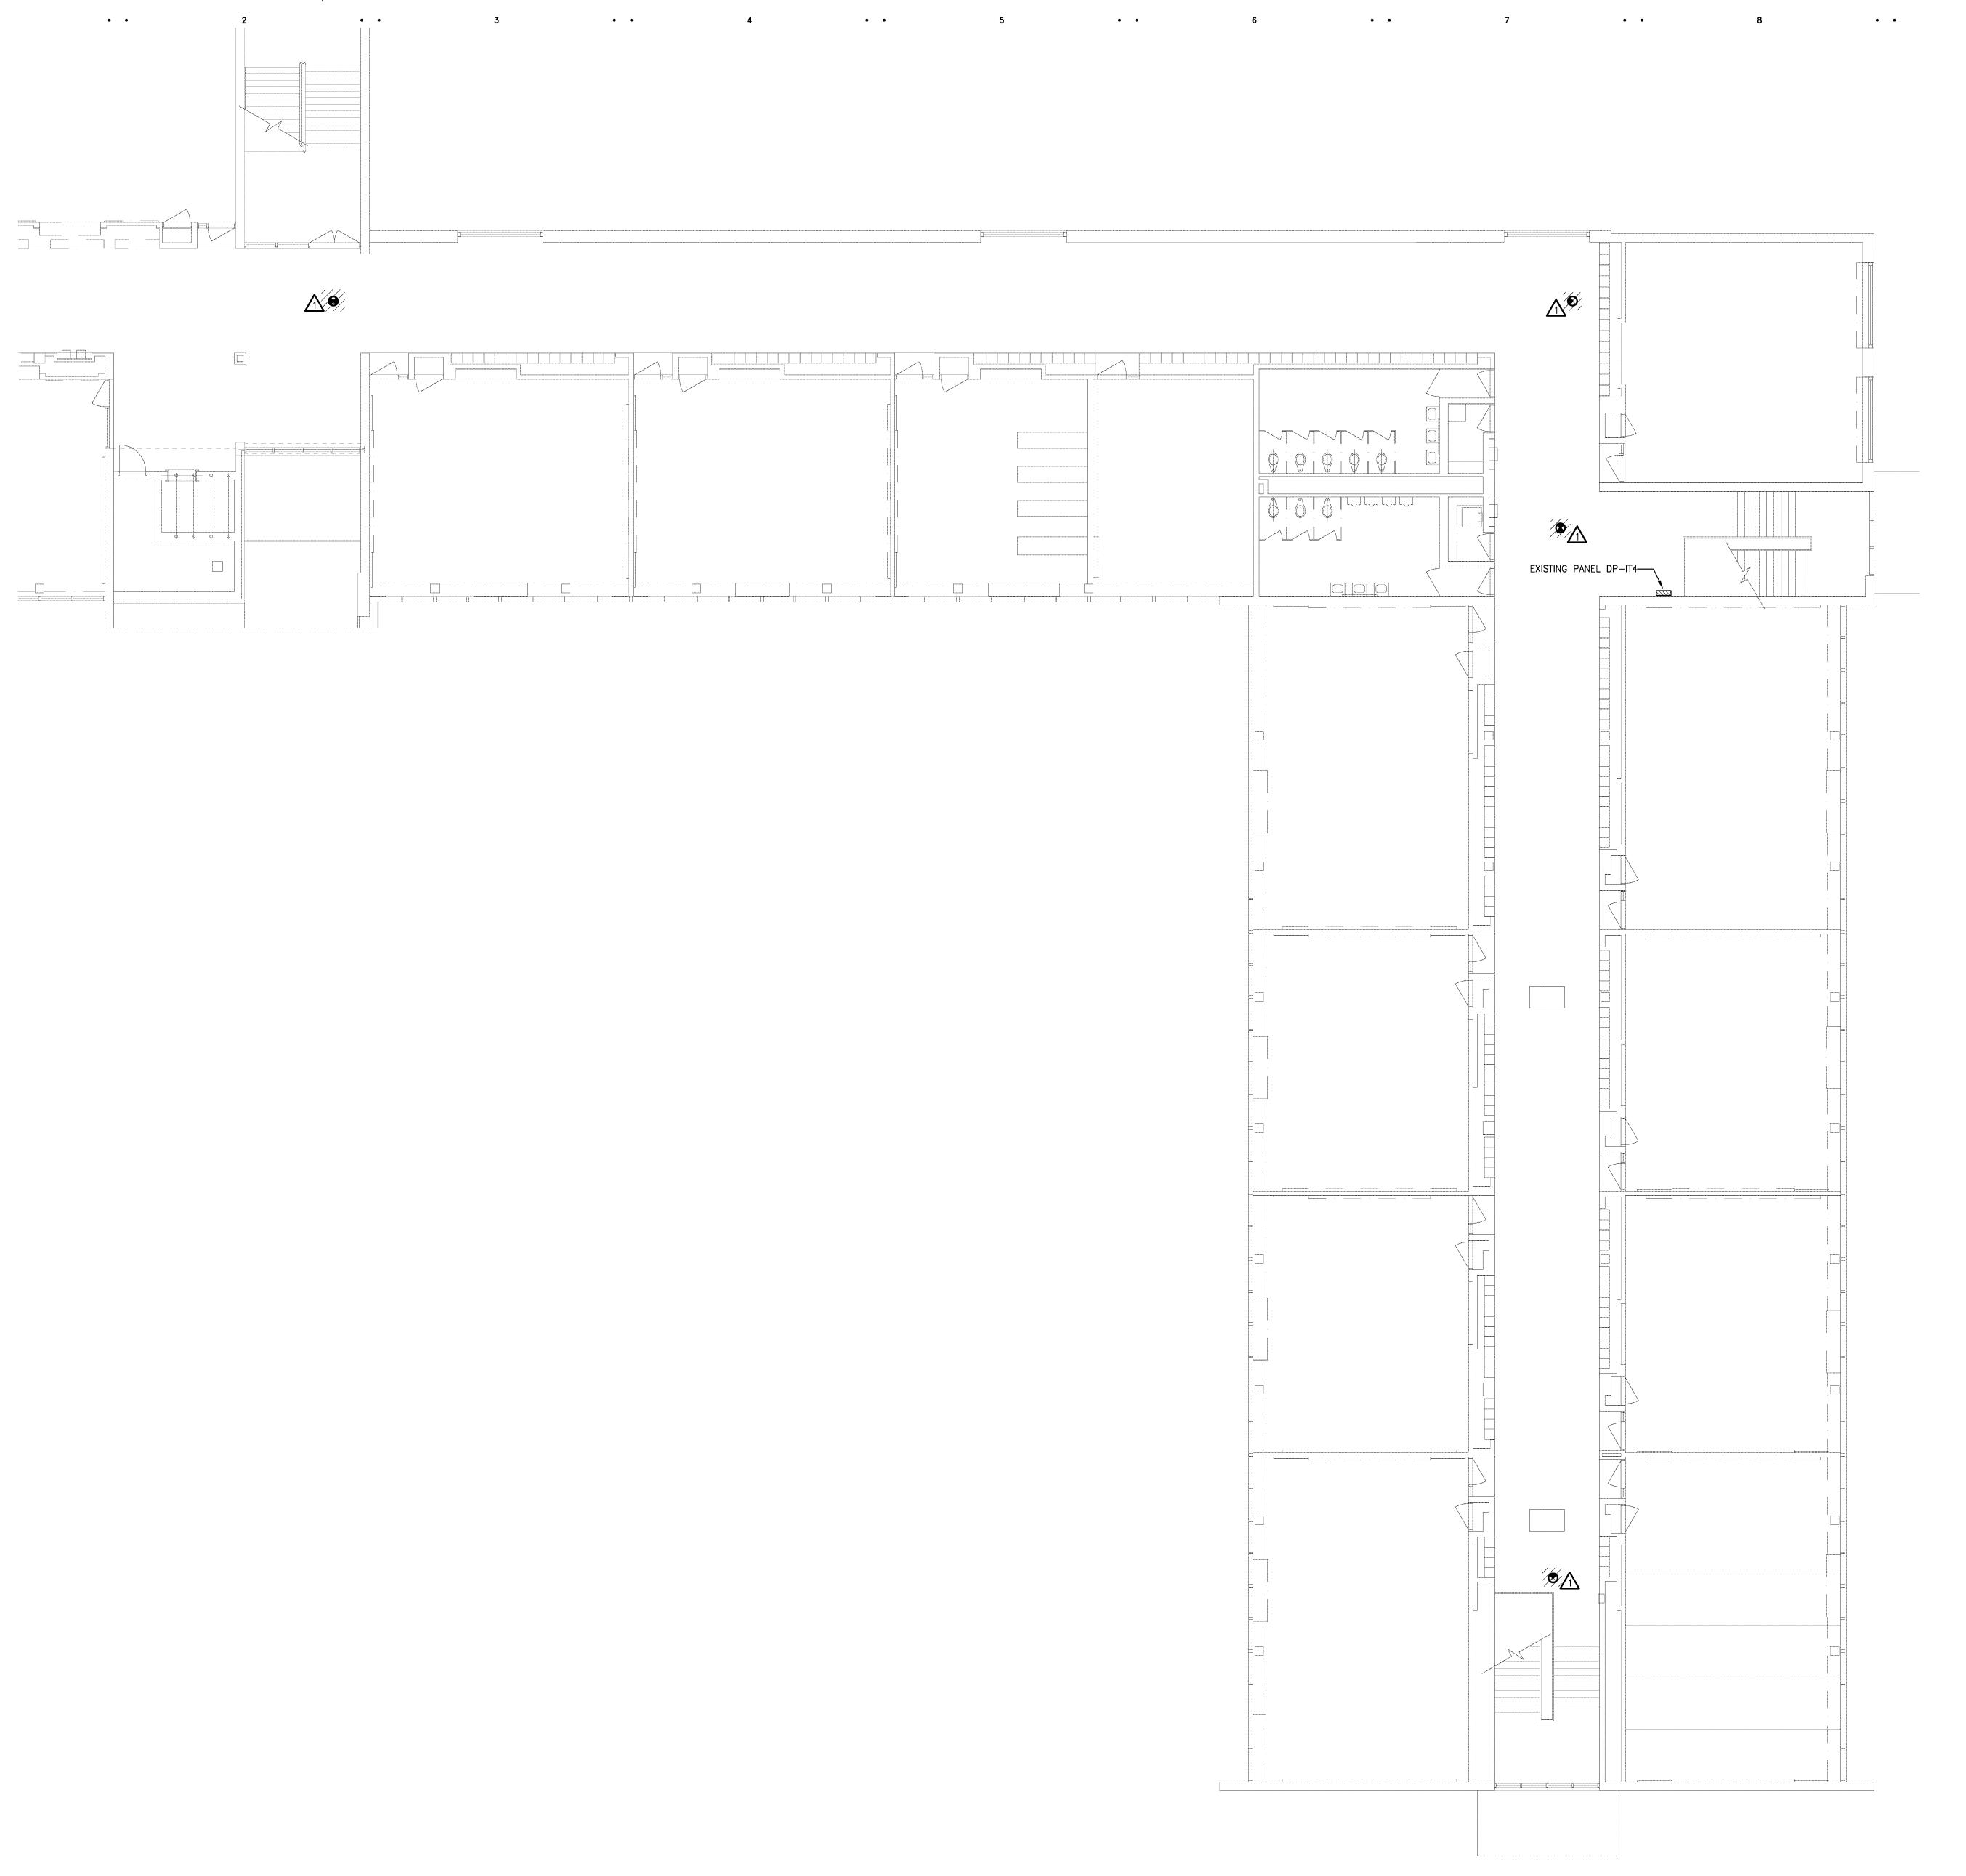
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AREA 'F'

H.S. MAIN LEVEL ELECTRICAL DEMOLITION PLAN -

Scale:

ED1.16h



- 1. VISIT THE SITE PRIOR TO SUBMISSION OF BID TO EXAMINE THE EXISTING CONDITIONS AND THE EXTENT OF DEMOLITION WORK.
- 2. EXAMINE THE DRAWINGS OF OTHER TRADES, BE FAMILIAR WITH THE DEMOLITION REQUIRED BY OTHER TRADES. PERFORM ALL INCIDENTAL ELECTRICAL DEMOLITION AND/OR RELOCATION OF DEVICES AND EQUIPMENT REQUIRED TO FACILITATE THE DEMOLITION WORK OF OTHER TRADES.
- 3. REMOVE LIGHTING FIXTURES AND ELECTRICAL DEVICES AS INDICATED ON PLAN. DEMOLITION SHALL INCLUDE, BUT NOT BE LIMITED TO THOSE DEVICES SHOWN.
- 4. COORDINATE WITH NEW WORK PLANS, ONE LINE AND RISER DIAGRAMS FOR EXTENT OF DEMOLITION WORK.
- 5. COORDINATE ANY SHUTDOWN OF EXISTING SERVICES AND EQUIPMENT REMAINING IN USE WITH OWNERS' REPRESENTATIVE. WHERE EXISTING BUILDING SERVICE IS REQUIRED TO BE SHUT DOWN, INCLUDE ALL ASSOCIATED OVERTIME COST TO PERFORM THIS WORK DURING EVENINGS AND WEEKENDS. INCLUDE ALL COSTS FOR PROVIDING TEMPORARY POWER WHERE SHUTDOWNS OCCUR FOR PERIODS LONGER THAN THE ABOVE STATED HOURS.
- 6. COORDINATE THE SHUT DOWN OF ELECTRICAL EQUIPMENT WITH THE OWNERS' REPRESENTATIVE A MINIMUM OF 72 HOURS PRIOR TO SHUT DOWN.
- 7. REMOVE ALL CONDUIT AND WIRE BACK TO NEAREST UPSTREAM DEVICE REMAINING IN SERVICE.
- 8. WHERE DEMOLITION WORK AFFECTS ELECTRICAL SERVICE TO DOWNSTREAM DEVICES TO REMAIN; EXTEND CONDUIT AND WIRE AS REQUIRED TO MAINTAIN ELECTRICAL SERVICE.
- 9. DISPOSE OF ALL MATERIALS OFF SITE AND INCLUDE ALL COSTS FOR DISPOSAL IN BID. ALL MATERIALS SHALL BE DISPOSED OF IN ACCORDANCE WITH ALL FEDERAL, STATE AND LOCAL REGULATIONS, INCLUDING TCLP TESTING, PRIOR TO DISPOSAL AND/OR RECYCLING OF FLUORESCENT LAMPS.
- 10. PROVIDE BLANK COVER PLATES WHERE SWITCHES AND DEVICES ARE REMOVED AND WALL REMAINS INTACT. MARK ALL UNUSED CIRCUIT BREAKERS AS "SPARE". 11. CONTRACTOR TO TAG ALL CIRCUITS AT BOTH ENDS AFFECTED BY THIS

ALTERATION.

- 12. CONTRACTOR SHALL PROVIDE UPDATED, TYPED-IN DIRECTORIES FOR ALL PANELS AFFECTED BY THIS ALTERATION.
- 13. CONTRACTOR SHALL VERIFY ALL UNDERGROUND AND IN-SLAB UTILITIES LOCATIONS PRIOR TO SAW CUTTING OR PENETRATING ANY FLOOR SLABS.
- 14. REFER TO NEW WORK SHEETS FOR LIGHTING AND POWER CIRCUIT DESIGNATIONS.
- 15. EXTEND EXISTING CONDUIT AND WIRE AS REQUIRED FOR ALL RELOCATED
- 16. REPLACE EXIT SIGNS AND EMERGENCY BATTERY UNITS THAT ARE SHOWN HATCHED, REFER TO NEW WORK PLANS AND SCHEDULES FOR INFORMATION.

DEMOLITION KEYED NOTES

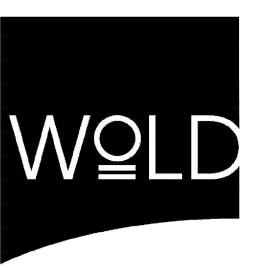
REMOVE EXISTING EXIT SIGN OR EMERGENCY LIGHT, REPLACE WITH NEW PER NEW WORK PLANS.

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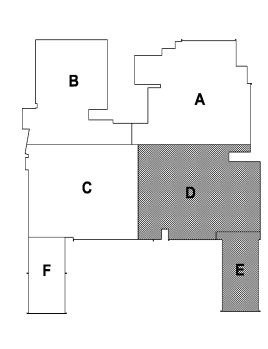
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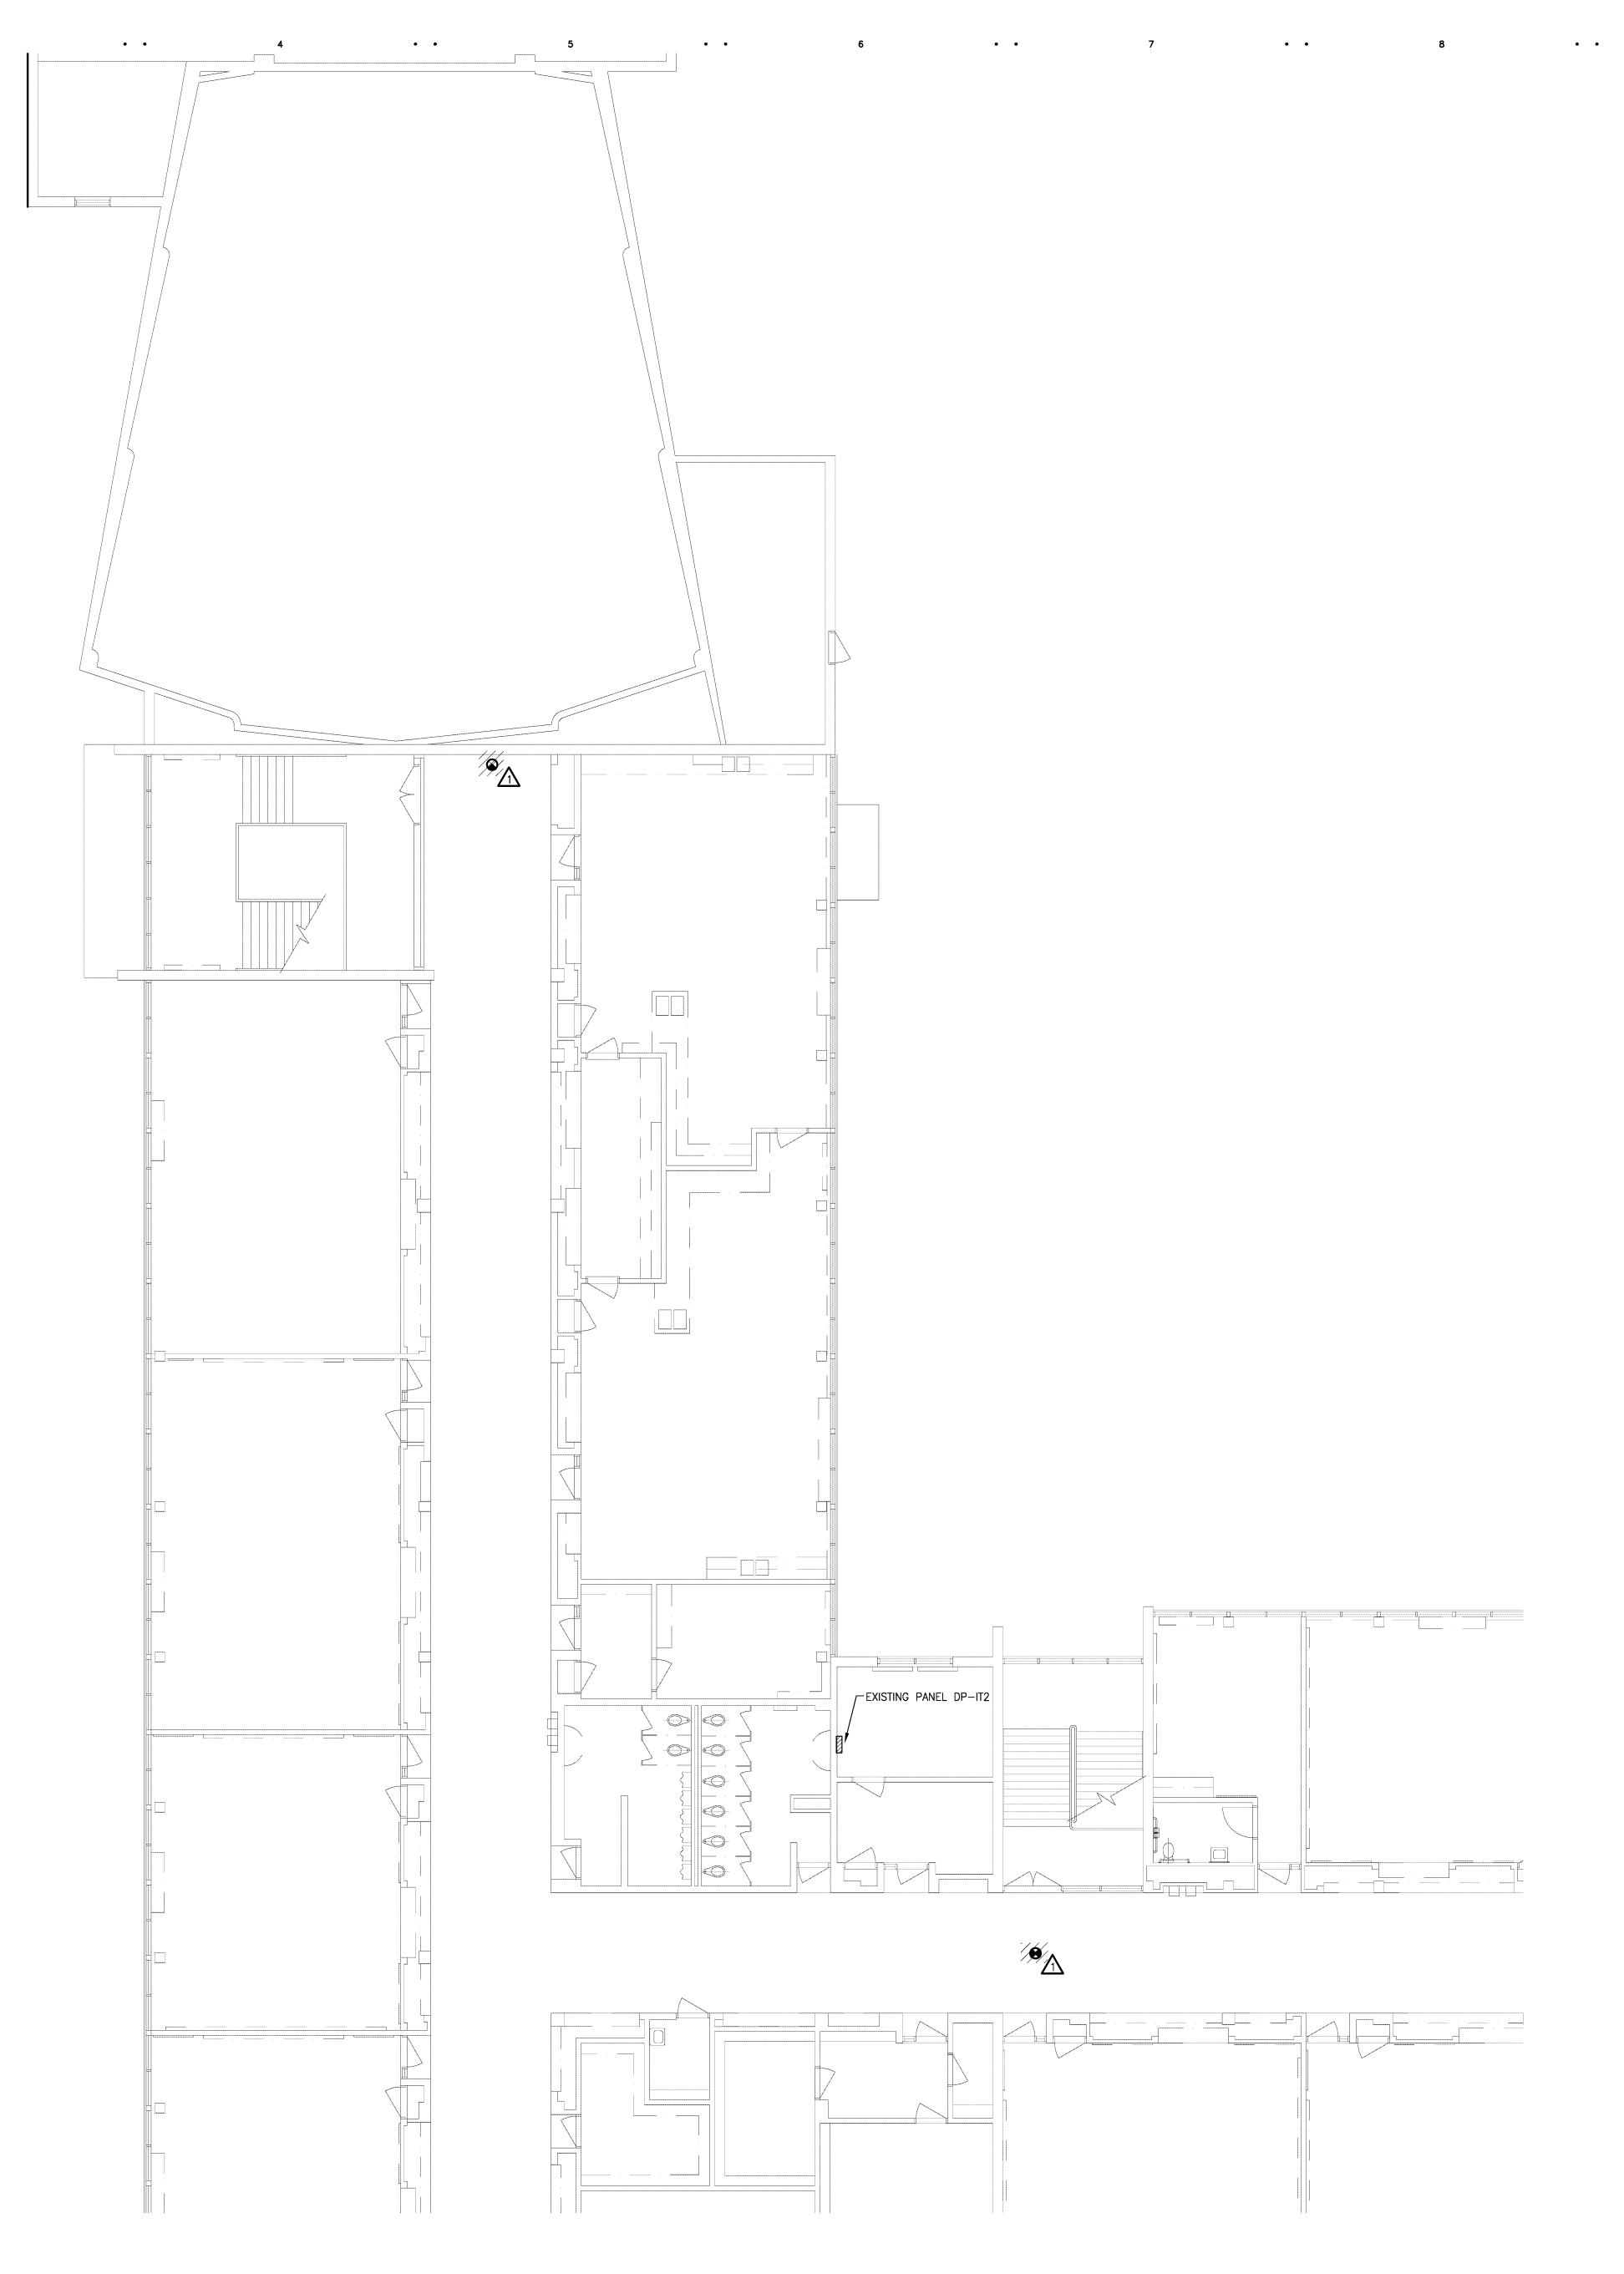
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UPPER LEVEL

ELECTRICAL DEMOLITION PLAN - AREAS 'D' AND 'E'

ED1.21h



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- VISIT THE SITE PRIOR TO SUBMISSION OF BID TO EXAMINE THE EXISTING CONDITIONS AND THE EXTENT OF DEMOLITION WORK.
- 2. EXAMINE THE DRAWINGS OF OTHER TRADES, BE FAMILIAR WITH THE DEMOLITION REQUIRED BY OTHER TRADES. PERFORM ALL INCIDENTAL ELECTRICAL DEMOLITION AND/OR RELOCATION OF DEVICES AND EQUIPMENT REQUIRED TO FACILITATE THE DEMOLITION WORK OF OTHER TRADES.
- REMOVE LIGHTING FIXTURES AND ELECTRICAL DEVICES AS INDICATED ON PLAN.
 DEMOLITION SHALL INCLUDE, BUT NOT BE LIMITED TO THOSE DEVICES SHOWN.
- COORDINATE WITH NEW WORK PLANS, ONE LINE AND RISER DIAGRAMS FOR EXTENT OF DEMOLITION WORK.
- 5. COORDINATE ANY SHUTDOWN OF EXISTING SERVICES AND EQUIPMENT REMAINING IN USE WITH OWNERS' REPRESENTATIVE. WHERE EXISTING BUILDING SERVICE IS REQUIRED TO BE SHUT DOWN, INCLUDE ALL ASSOCIATED OVERTIME COST TO PERFORM THIS WORK DURING EVENINGS AND WEEKENDS. INCLUDE ALL COSTS FOR PROVIDING TEMPORARY POWER WHERE SHUTDOWNS OCCUR FOR PERIODS LONGER THAN THE ABOVE STATED HOURS.
- 6. COORDINATE THE SHUT DOWN OF ELECTRICAL EQUIPMENT WITH THE OWNERS' REPRESENTATIVE A MINIMUM OF 72 HOURS PRIOR TO SHUT DOWN.
- 7. REMOVE ALL CONDUIT AND WIRE BACK TO NEAREST UPSTREAM DEVICE REMAINING IN SERVICE.
- 8. WHERE DEMOLITION WORK AFFECTS ELECTRICAL SERVICE TO DOWNSTREAM DEVICES TO REMAIN; EXTEND CONDUIT AND WIRE AS REQUIRED TO MAINTAIN ELECTRICAL SERVICE.
- 9. DISPOSE OF ALL MATERIALS OFF SITE AND INCLUDE ALL COSTS FOR DISPOSAL IN BID. ALL MATERIALS SHALL BE DISPOSED OF IN ACCORDANCE WITH ALL FEDERAL, STATE AND LOCAL REGULATIONS, INCLUDING TCLP TESTING, PRIOR TO DISPOSAL AND/OR RECYCLING OF FLUORESCENT LAMPS.
- 10. PROVIDE BLANK COVER PLATES WHERE SWITCHES AND DEVICES ARE REMOVED AND WALL REMAINS INTACT. MARK ALL UNUSED CIRCUIT BREAKERS AS "SPARE".
- CONTRACTOR TO TAG ALL CIRCUITS AT BOTH ENDS AFFECTED BY THIS ALTERATION.
- 12. CONTRACTOR SHALL PROVIDE UPDATED, TYPED—IN DIRECTORIES FOR ALL PANELS AFFECTED BY THIS ALTERATION.
- 13. CONTRACTOR SHALL VERIFY ALL UNDERGROUND AND IN-SLAB UTILITIES
- LOCATIONS PRIOR TO SAW CUTTING OR PENETRATING ANY FLOOR SLABS.

 14. REFER TO NEW WORK SHEETS FOR LIGHTING AND POWER CIRCUIT
- DESIGNATIONS.

 15. EXTEND EXISTING CONDUIT AND WIRE AS REQUIRED FOR ALL RELOCATED

DEVICES.

16. REPLACE EXIT SIGNS AND EMERGENCY BATTERY UNITS THAT ARE SHOWN HATCHED, REFER TO NEW WORK PLANS AND SCHEDULES FOR INFORMATION.

DEMOLITION KEYED NOTES

REMOVE EXISTING EXIT SIGN OR EMERGENCY LIGHT, REPLACE WITH NEW PER NEW WORK PLANS.

REDFORD UNION
MECHANICAL / ELECTRICAL
IMPROVEMENTS

IMPROVEMENTS

REDFORD UNION HIGH SCHOOL

REDFORD, MI 48240 REDFORD UNION SCHOOL

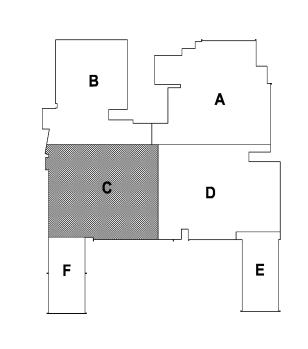
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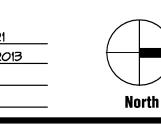
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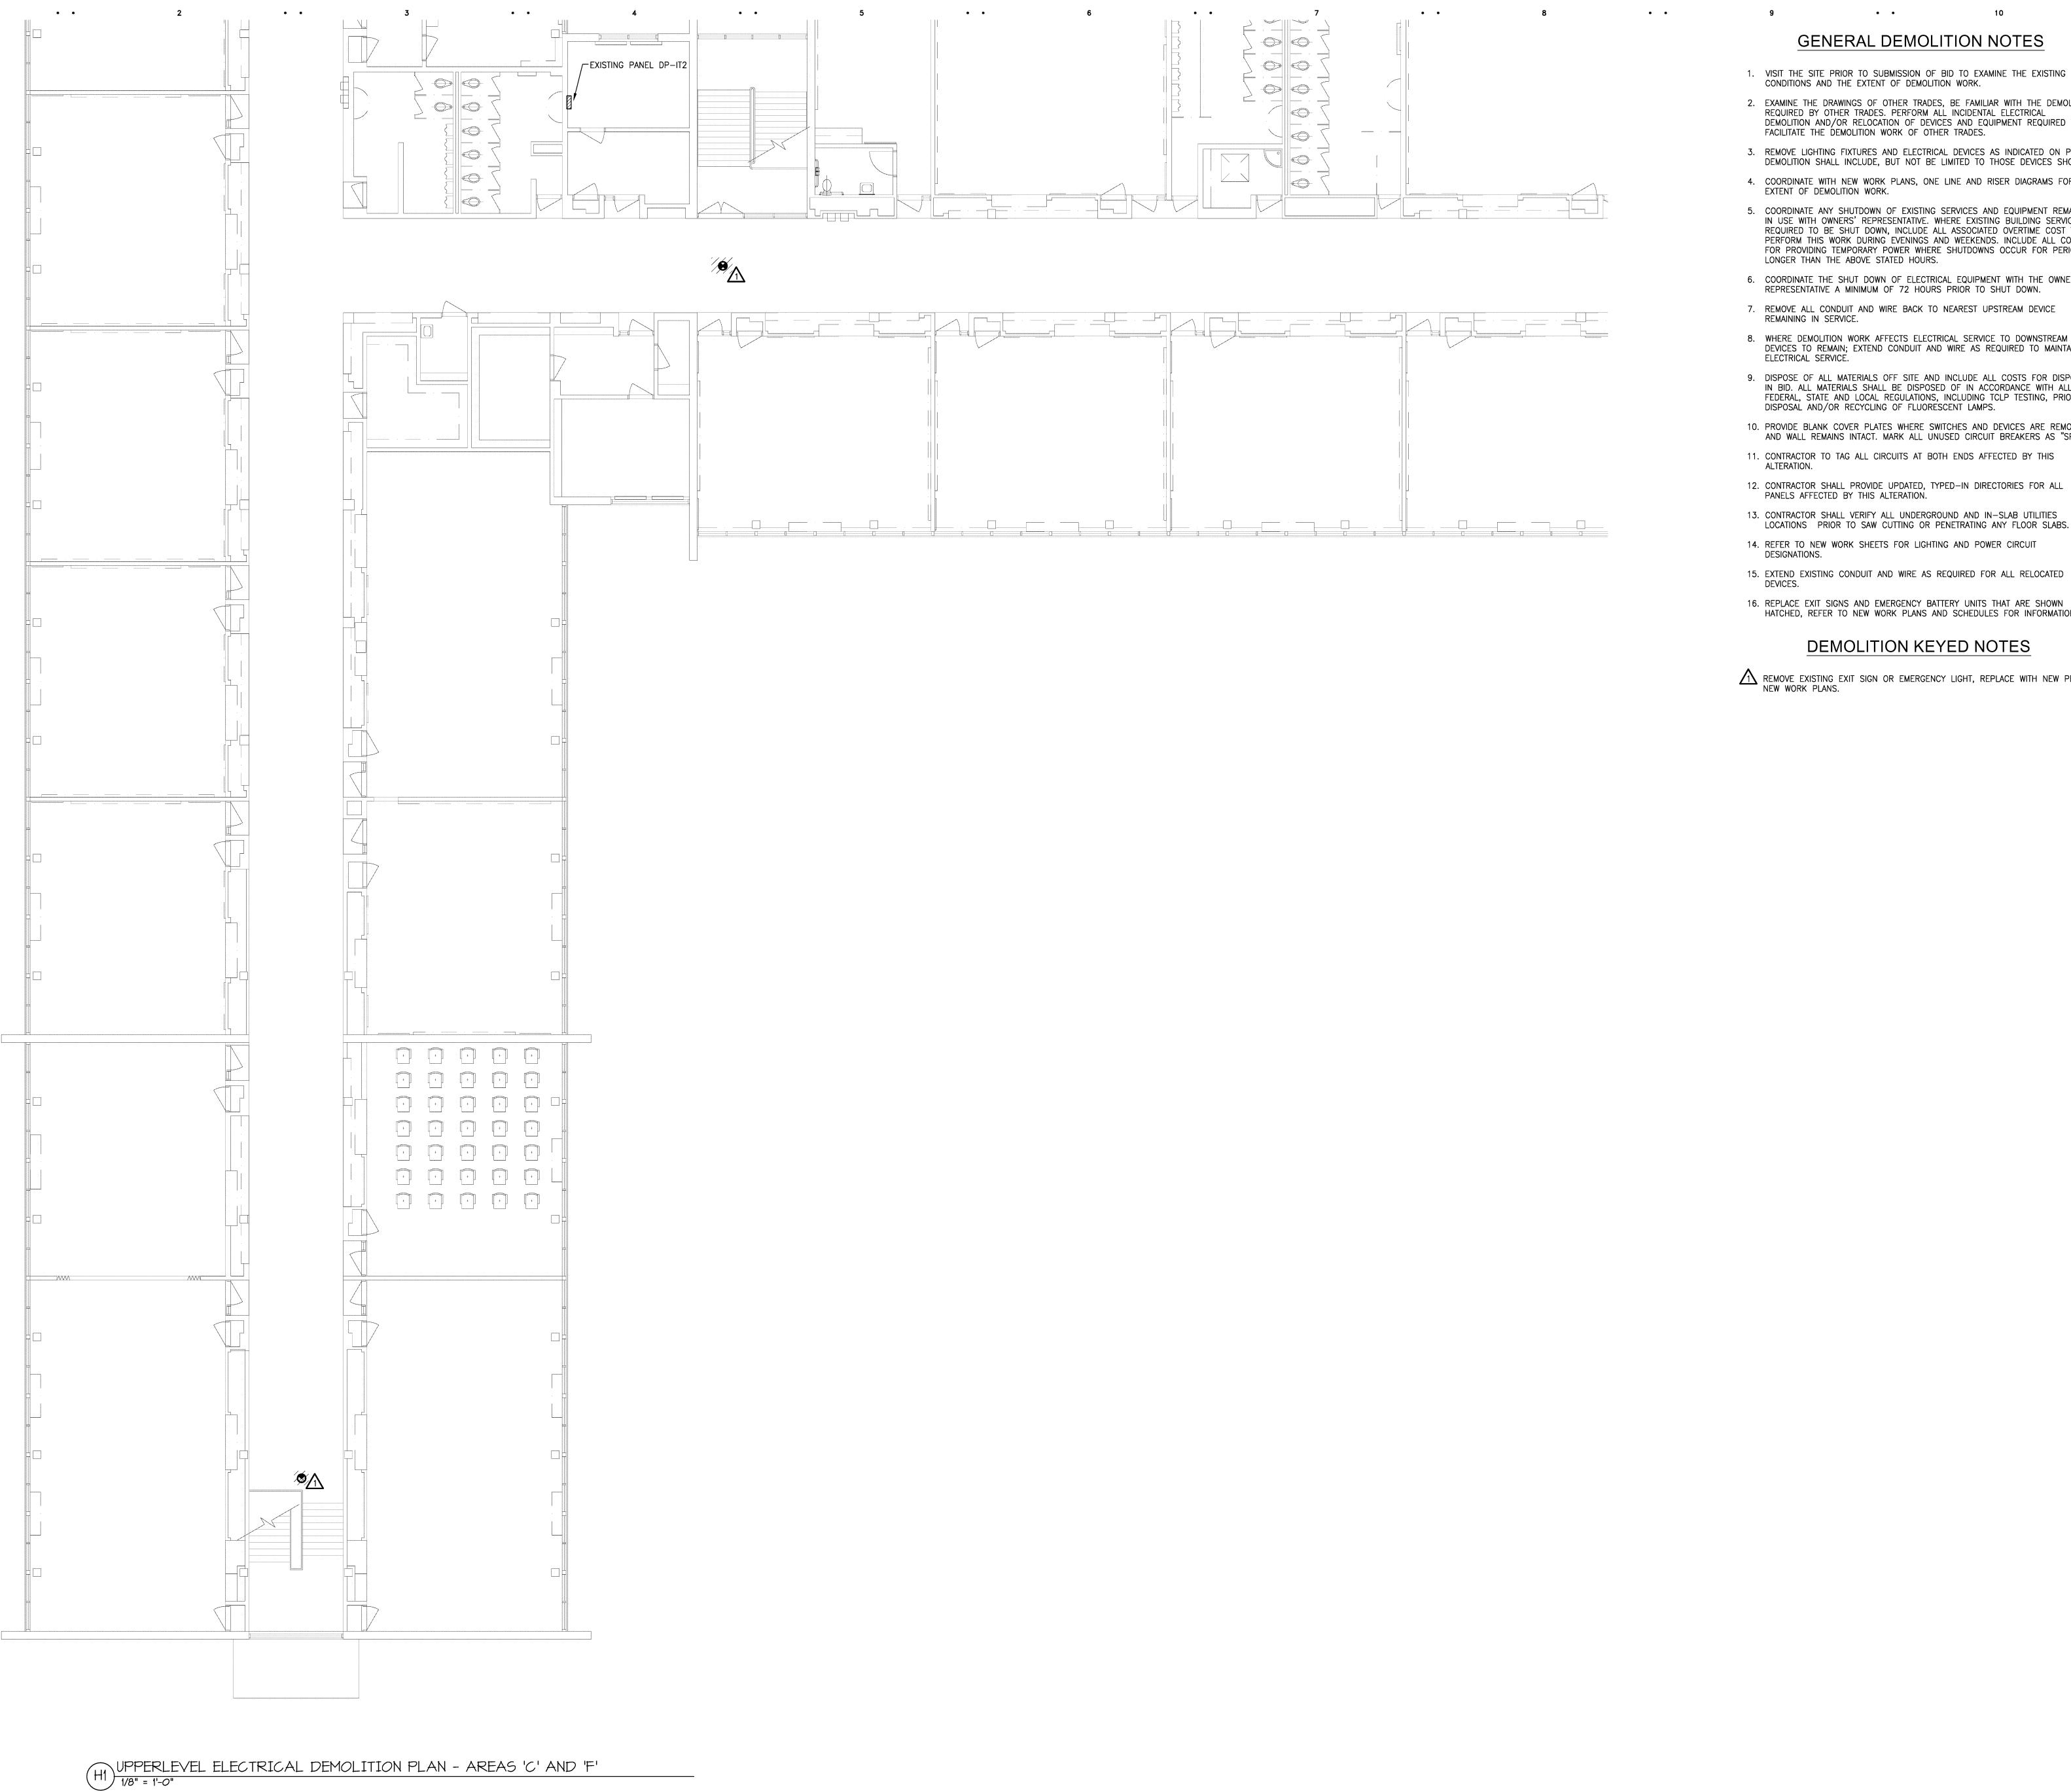


UPPER LEVEL
ELECTRICAL
DEMOLITION PLANAREA 'C'

Scale

ED1.22h

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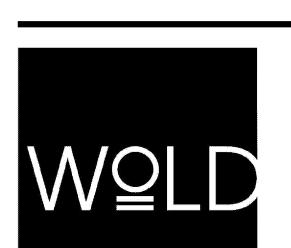
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REDFORD UNION SCHOOL DISTRICT

REDFORD, MI 48240

19990 BEECH DALY ROAD

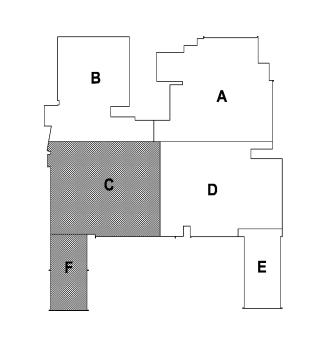


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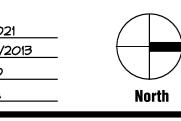


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UPPER LEVEL ELECTRICAL DEMOLITION PLAN - AREAS 'C' AND 'F'

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